

The Republic of Uganda **MINISTRY OF WATER AND ENVIRONMENT**

Directorate of Water Development Rural Water and Sanitation Department



Bid For

ALA - ORA WATER SUPPLY & SANITATION SYSTEM

LOAN No.: ______ PROJECT ID No.: ______

LOT 1: CONSTRUCTION OF NYAGAK WATER SUPPLY AND SANITATION SYSTEM

MWE/WRKS/22-23/.....

BIDDING DOCUMENTS

VOLUME 4 – BOOK OF DRAWINGS

ISSUED ON: JANUARY 2023

CONSTRUCTION OF NYAGAK WATER SUPPLY AND SANITATION SCHEME - LOT 1 BOOK OF DRAWINGS CONTENT

ITEM	DESCRIPTION	DWG. NO.	SHEETS			<u>STRUCTU</u>
	Nyagak Project General Layout	NYA-GL-001	2		Raw Water Works	Intake Weir
	Intake Structure	NYAINT-001	3			Intake Chamber
Dow Water Works	Intake Chamber	NYA-INT-002	3			
Raw Water Works	Intake Guard House	NYA-INT-003	5			Inlet Structure
	Toilet (Intake)	NYA-INT-004	3		1	Alum Dozing H
	Raw Water Main	NYA-RWM-001	13			Flocculator
	Raw Water Main- Nodes	NYA-RWM-ND-001	1]	Sedimentation
	Treatment Plant Site Layout	NYA-WTP-001A	1		Treatment Plant	Rapid Sand Filte
	Treatment Plant Hydraulic Profile	NYA-WTP-001B	1			Chlorine Dosir
						Clear water Tan
	Inlet Structure	NYA-WTP-002	1		1	Pump House
	Alum Dosing House	NYA-WTP-003	6			50m ³ Backwash
	Flocculator	NYA-WTP-004	2]	Sludge Drying
	Drop Chamber	NYA-WTP-004B	1			
	Sedimentation Reservoir	NYA-WTP-005	2			84m ³ Reservo
	Rapid Sand Filters	NYA-WTP-006	3		Reservoirs	296m ³ Reservoi
	Chlorine Dosing House	NYA-WTP-007	6	I	1	
Treatment Plant	Clear Water Reservoir	NYA-WTP-008	3	STAND	ARD DRAWINGS	
	Pump house	NYA-WTP-009	11	ITEM		DESCRIPTION
	Backwash Reservoir	NYA-WTP-010	2	0	General Notes	
	Sludge Drying Beds	NYA-WTP-011	3	1	Sign Board	
	Sand Storage Shade	NYA-WTP-012	1	2	Gate Valve & Surface	Box
	Administration Building and Laboratory	NYA-WTP-013	5	3	Fire Hydrant Chamber	& Pipework
	Superintendent's Quarters	NYA-WTP-014	5	4	Air Valve Chamber & F	
	Attendant's House	NYA-WTP-015	5	5	Wash Out Details, Cha	•
	Guard's Quarters Post	NYA-WTP-016	3	6	Anchor Block Details	
	Chemical Store	NYA-WTP-017	5	7	Trenching, Road Cross	sing ,Backfilling, F
				8	Reinforcement Details	
Gravity Transmission Main 1	To Ndiriba Reservoir Reservoir Offaka Tee Ch 0+000 to 8+050	NYA-GTM-001	17	9	Step Iron & Flexible Pi	
	NDIIRIBA SUPPLY AREA			10	Precast Chamber Cov	
Gravity Transmission Main 1	Offaka Tee Ch 8+050 to Ndiriba Reservoir		20	11	Marker Post & Pipe Su	
Ndiriba Reservoir	296m ³ Ndiriba Reservoir Site Layout, Plan, Sections and Fittings Schedule	NYA-RES-NDB-001	3	12	Fence Details	
				13	Road Works	
Gravity Transmission Main 2	Ch. 8+050 (Offaka Tee) to Anyiribu Tee (15+370)	NYA-GTM-002	15	14	Yard Tap	
•	Ch. 15+370 to Anyiribu Reservoir	NYA-GTM-002	1	15	Stand Post	
Gravity Transmission Main 2	ANYIRIBU SUPPLY AREA			16	Water Office - Type 1	
Anyiribu Reservoir	84m ³ Anyiribu Reservoir Site Layout, Plan, Sections and Fittings Schedule	NYA-RES-ANY-002	3	18	Septic Tank	
				19	Manhole Details & Soa	ık pit details
	NYAGAK WTP COMMUNITY SUPPLY AREA	1		20	Lightning Conductor	
Nyagak Community Reservoir	84m ³ Reservoir Site Layout, Plan, Sections and Fittings Schedule	NYA-RES-NYA-008	3	21	Pipe Bridge ≤ 10m	
		1		22	Pipe Bridge ≤ 15m	
Scheme Nodes	Nodes	NYA-ND-001	1	23	Pipe Bridge ≤ 20m	
				24	Pipe Bridge ≤ 35m	

SANIT/	SANITATION FACILITIES			
1	Public Waterborne Toilet			
2	Institutional VIP for Gents			
3	Institutional VIP for Ladies			
4	Incinerator Details			
5	Elevated Water Tank			
6	Septic Tank			
7	Soak Pit Details			

CTURAL DRAWIN	<u>NGS</u>	
eir	AR/WSASS/NY/STR/001	4
mber	AR/WSASS/NY/STR/002	2
ture	AR/WSASS/NY/STR/003	1
ing House	AR/WSASS/NY/STR/004	2
	AR/WSASS/NY/STR/005	4
ation Tank	AR/WSASS/NY/STR/007	5
Filters	AR/WSASS/NY/STR/008	4
Dosing House	AR/WSASS/NY/STR/009	3
r Tank	AR/WSASS/NY/STR/010	4
lse	AR/WSASS/NY/STR/011	3
wash Tank	AR/WSASS/NY/STR/012	2
ying Beds	AR/WSASS/NY/STR/013	3
	1	1
ervoir	AR/WSASS/NY/STR/017	2
ervoir	AR/WSASS/NY/STR/019	2
	I	1
		SHEETS
TION	DWG. NO.	
	ALA-ORA-SD-000	1
	ALA-ORA-SD-001	1
	ALA-ORA-SD-002	1
	ALA-ORA-SD-003	1
	ALA-ORA-SD-004	1
all Structure	ALA-ORA-SD-005	1
	ALA-ORA-SD-006	3
ng, Pipe	ALA-ORA-SD-007	2
/ Valve Chamber.	ALA-ORA-SD-008	1
ils	ALA-ORA-SD-009	1
Section	ALA-ORA-SD-010	1
	ALA-ORA-SD-011	2
	ALA-ORA-SD-012	2
	ALA-ORA-SD-013	1
	ALA-ORA-SD-014	1
	ALA-ORA-SD-015	1
	ALA-ORA-SD-016A	5
	ALA-ORA-SD-017	1
	ALA-ORA-SD-018	1
	ALA-ORA-SD-019	1
	ALA-ORA-SD-020	3
	ALA-ORA-SD-021	3
	ALA-ORA-SD-022	3
	ALA-ORA-SD-023	3
	ALA-ORA-SAN-001	5
	ALA-ORA-SAN-002	3
	ALA-ORA-SAN-003	3

ALA-ORA-SAN-004

ALA-ORA-SAN-005

ALA-ORA-SAN-006


ALA-ORA-SAN-007

1


1

1


1

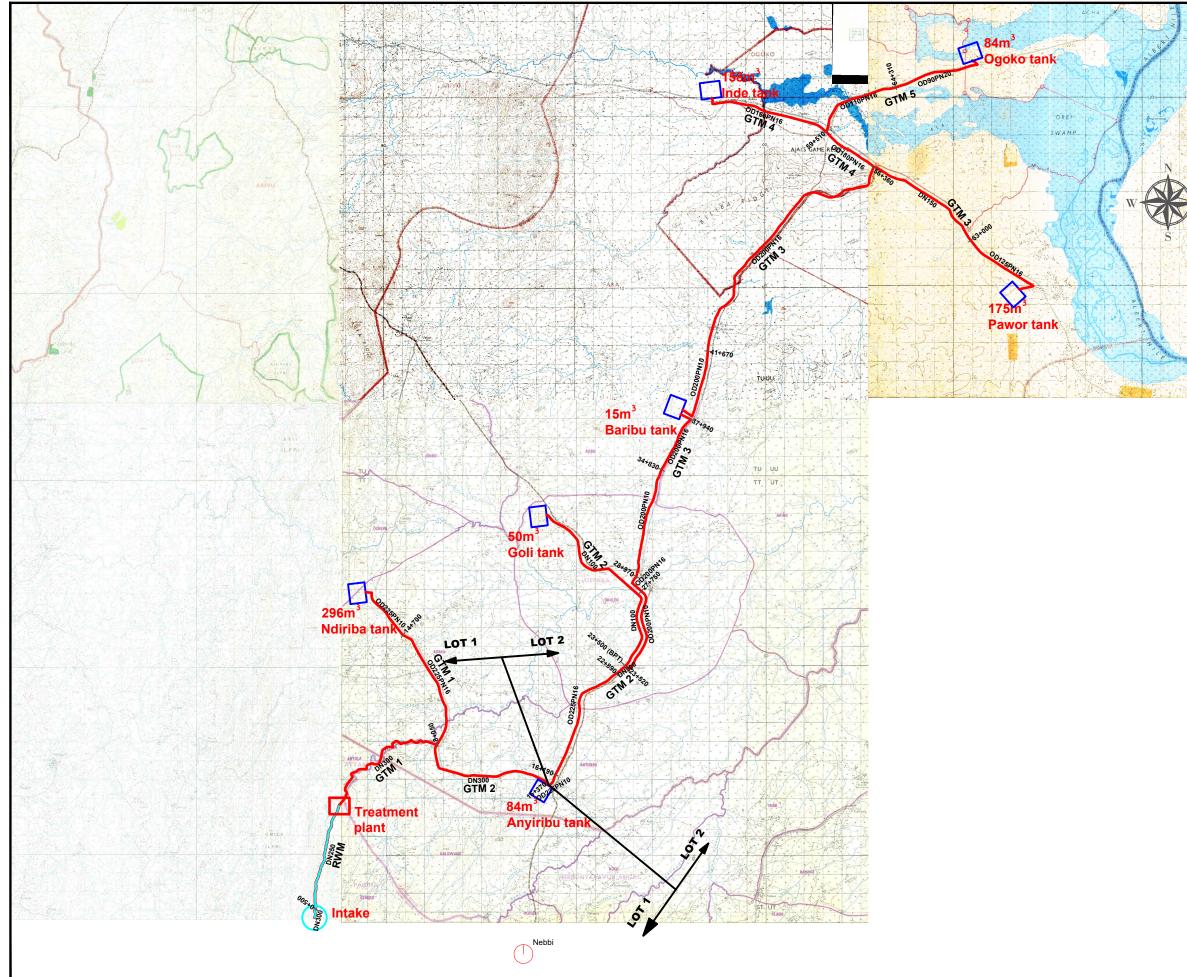



Was T) + At		LEGEND
- I - A A A A		Raw water main
Contraction Rev		Gravity transmission Main
		Pumped transmission main
		Distribution Main
	\circ	Intake
A Contraction		
E		Water Treatment Plant
- login		Reservoirs
	\bigcirc	District boundary
	\bigcirc	Subcounty boundary
Charles I.		
1 Standart	CLIENT :	X
	MINIETOV	THE REPUBLIC OF UGANDA OF WATER AND ENVIRONMENT
	CO-FINANCED E	
		\checkmark
	CONSULTANT :	Alliance Consultants Itd
	CONSULTANT :	
	CONSULTANT :	Alliance Consultants Itd
	Ŕ	Alliance Consultants Itd
	PROJECT :	Alliance Consultants Itd In Association with
	PROJECT : ALA-O	Alliance Consultants Itd
	PROJECT : ALA-C S NYAG	Alliance Consultants Itd In Association with
	PROJECT : ALA-C S NYAG S	Alliance Consultants Itd In Association with Infre-Consult Ltd ORA WATER SUPPLY AND GANITATION PROJECT
	PROJECT : ALA-C S NYAG S REVISIONS :	Alliance Consultants Itd In Association with Infre-Consult Ltd ORA WATER SUPPLY AND GANITATION PROJECT
	PROJECT : ALA-C S NYAG S REVISIONS :	Alliance Consultants Itd In Association with Infre-Consult Ltd ORA WATER SUPPLY AND SANITATION PROJECT SAK WATER SUPPLY AND SANITATION SYSTEM
	PROJECT : ALA-C S NYAG S REVISIONS :	Alliance Consultants Itd In Association with Infre-Consult Ltd ORA WATER SUPPLY AND SANITATION PROJECT SAK WATER SUPPLY AND SANITATION SYSTEM
		Alliance Consultants Itd In Association with Infra-Consult Ltd ORA WATER SUPPLY AND ANITATION PROJECT AK WATER SUPPLY AND ANITATION SYSTEM Date Description
		Alliance Consultants Itd In Association with Infra-Consult Ltd ORA WATER SUPPLY AND ANITATION PROJECT AK WATER SUPPLY AND ANITATION SYSTEM Date Description Date Description E: E: EENERAL SCHEME LAYOUT
	PROJECT : ALA-C S NYAG S REVISIONS : No DRAWING TITLE G Surveyed by: R.K Drawn by: J.B	Alliance Consultants Itd In Association with Infra-Consult Ltd ORA WATER SUPPLY AND SANITATION PROJECT AK WATER SUPPLY AND SANITATION SYSTEM Date Description E: E: EENERAL SCHEME LAYOUT
	PROJECT : ALA-(S NYAG S REVISIONS : No DRAWING TITLE G Surveyed by: R.K Drawn by: J.B Designed by: W.C	Alliance Consultants Itd In Association with Infra-Consult Ltd ORA WATER SUPPLY AND SANITATION PROJECT AK WATER SUPPLY AND SANITATION SYSTEM Date Description E: E: EENERAL SCHEME LAYOUT
	PROJECT : ALA-(S NYAG S REVISIONS : No DRAWING TITLE G Surveyed by: R.K Drawn by: J.B Designed by: W.C Checked by: J.K. Date:	Alliance Consultants Itd In Association with Infra-Consult Ltd ORA WATER SUPPLY AND ANITATION PROJECT AK WATER SUPPLY AND ANITATION SYSTEM Date Description Date Description Consult Ltd
	PROJECT : ALA-C S NYAG S REVISIONS : No DRAWING TITLE G Surveyed by: R.K Drawn by: J.B Designed by: W.C Checked by: J.K Date: JAN	Alliance Consultants Itd In Association with Infra-Consult Ltd ORA WATER SUPPLY AND SANITATION PROJECT AK WATER SUPPLY AND SANITATION SYSTEM Date Description Date Description
	PROJECT : ALA-(S NYAG S REVISIONS : No DRAWING TITLE G Surveyed by: R.K Drawn by: J.B Designed by: W.C Checked by: J.K. Date: JAN	Alliance Consultants Itd In Association with Infra-Consult Ltd ORA WATER SUPPLY AND ANITATION PROJECT AK WATER SUPPLY AND ANITATION SYSTEM Date Description Date Description Consult Ltd

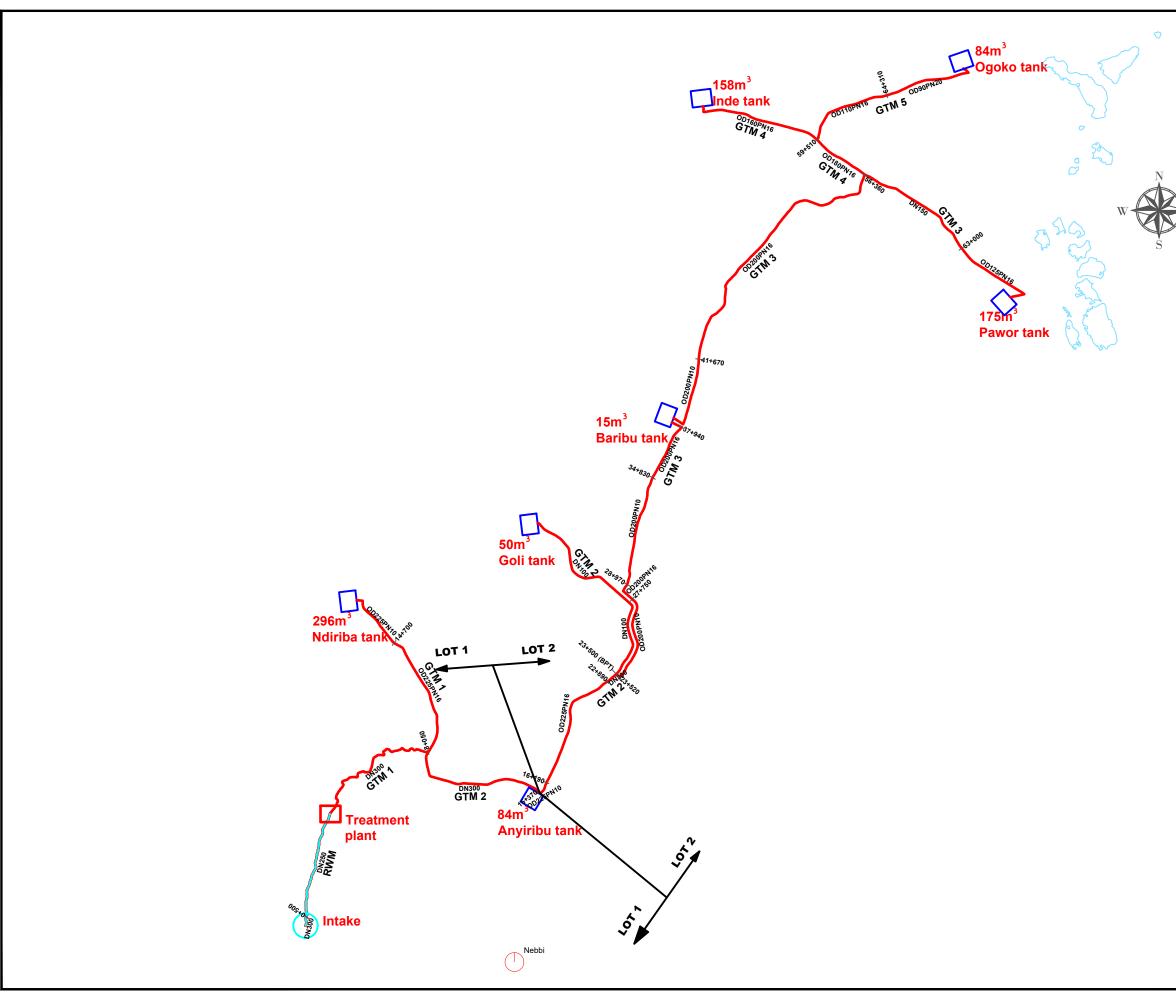



	LEGE			
	 Raw wa 	ter main		
	 Gravity 	transmission Main		
	Pumpeo	transmission main		
	Distribut	tion Main		
0	Intake			
	Water T	reatment Plant		
	Reservo	pirs		
\bigcirc	District I	boundary		
\bigcirc	Subcou	nty boundary		
CLIENT :	*			
		IC OF UGANDA R AND ENVIRONMENT		
CO-FINANCED BY:	WATE			
6				
		I		
CONSULTANT :				
CONSULTANT :	Alliance	e Consultants Itd		
CONSULTANT :		e Consultants Itd		
CONSULTANT :	In A			
A	In A	ssociation with		
PROJECT :	in A	ssociation with Consult Ltd		
PROJECT : ALA-OF		ssociation with		
PROJECT : ALA-OF SA		ER SUPPLY AND		
PROJECT : ALA-OF SA		SSOCIATION WITH Consult Ltd ER SUPPLY AND		
PROJECT : ALA-OF SA		ER SUPPLY AND N PROJECT		
PROJECT : ALA-OF SA NYAGA SA	A WATE	ER SUPPLY AND N PROJECT		
PROJECT : ALA-OF SAI NYAGA SA	A WATE	ER SUPPLY AND N PROJECT R SUPPLY AND SYSTEM		
PROJECT : ALA-OF SAI NYAGA SA	A WATE	ER SUPPLY AND N PROJECT R SUPPLY AND SYSTEM		
		ER SUPPLY AND N PROJECT R SUPPLY AND SYSTEM		
PROJECT : ALA-OF SAU NYAGA SA REVISIONS : No Dat DRAWING TITLE : GET		ER SUPPLY AND N PROJECT ER SUPPLY AND N SYSTEM		
		ER SUPPLY AND N PROJECT ER SUPPLY AND N SYSTEM		
PROJECT : ALA-OF SA NYAGA SA REVISIONS : No Dat DRAWING TITLE : GEI Surveyed by: R.K Drawn by: J.B Designed by: W.G.M		ER SUPPLY AND N PROJECT ER SUPPLY AND N SYSTEM		
PROJECT : ALA-OF SA NYAGA NYAGA REVISIONS : No Dat DRAWING TITLE : GEI Surveyed by: R.K Drawn by: J.B Designed by: W.G.M Checked by: J.K.K		ER SUPPLY AND N PROJECT ER SUPPLY AND N SYSTEM		
PROJECT : ALA-OF SA NYAGA SA NYAGA SA NYAGA Checked by: URAWING TITLE : GEI Surveyed by: R.K Drawn by: J.B Designed by: W.G.M Checked by: J.K.K DRG. No :		SSOCIATION WITH Consult Ltd ER SUPPLY AND IN PROJECT ER SUPPLY AND Description Description CHEME LAYOUT		
PROJECT : ALA-OF SAI NYAGA SA NYAGA SA NO Dat DRAWING TITLE : GEI Surveyed by: R.K Drawn by: J.B Designed by: W.G.M Checked by: J.K.K Date: JANU/ DRG. No.: NY		SSOCIATION WITH Consult Ltd ER SUPPLY AND IN PROJECT ER SUPPLY AND Description Description CHEME LAYOUT		

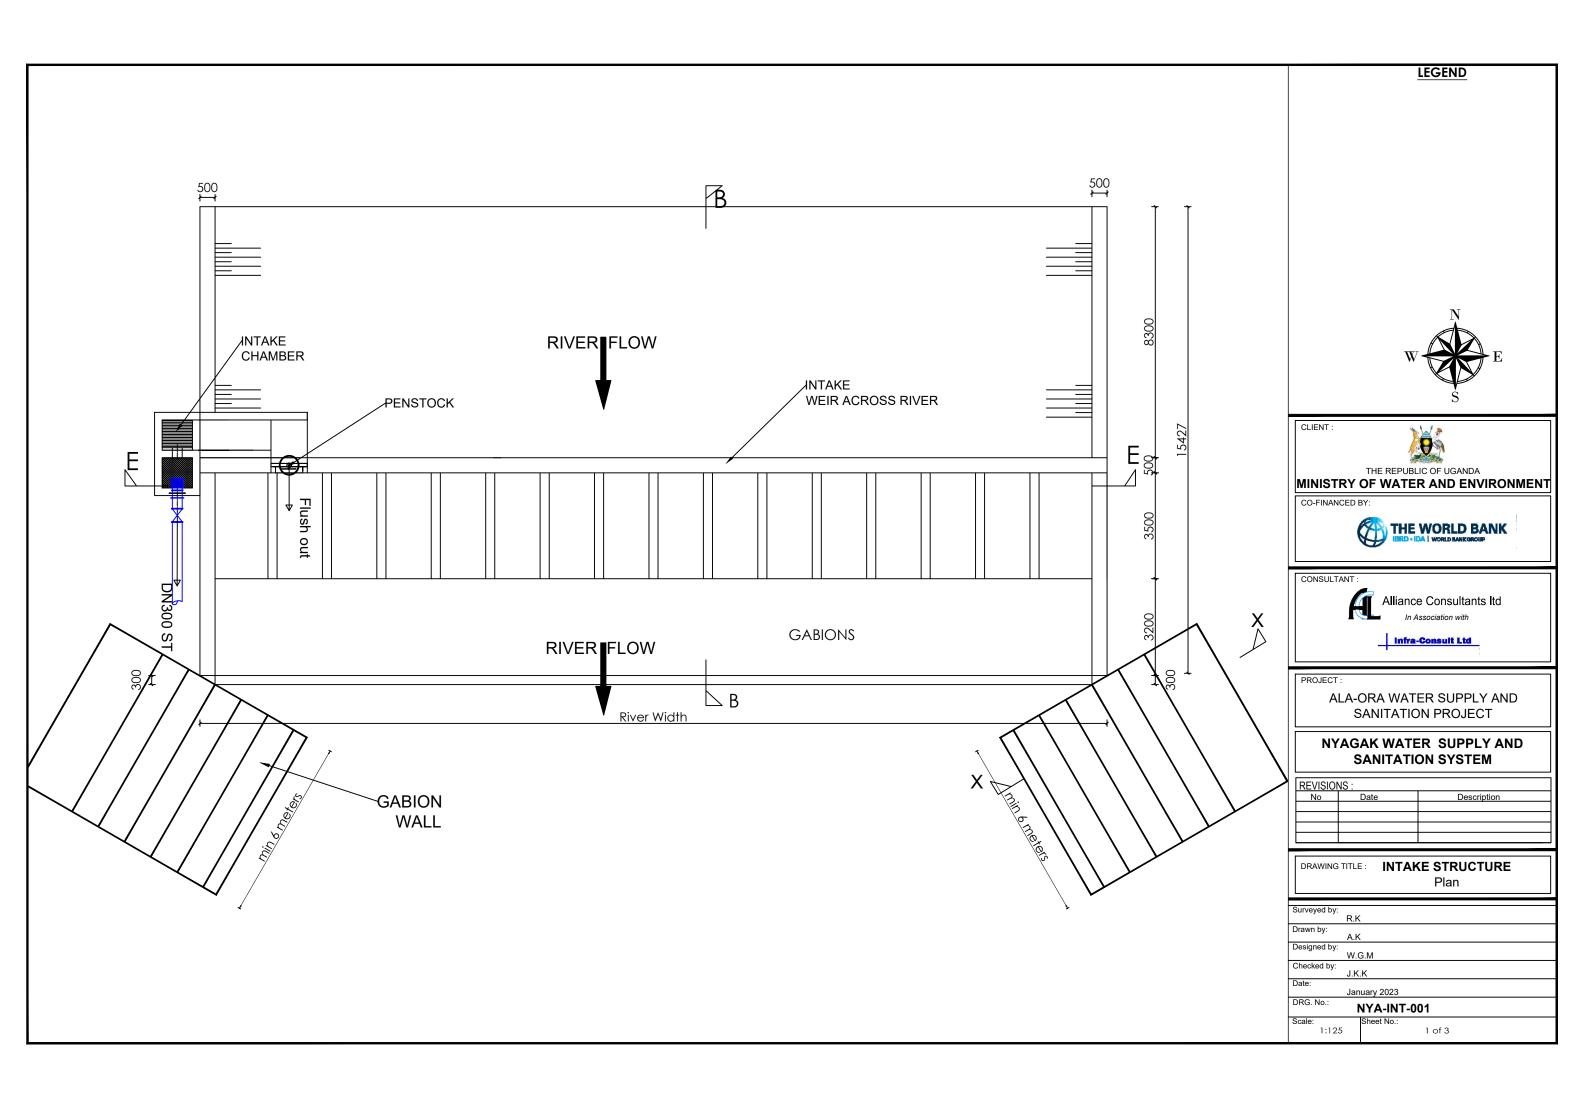


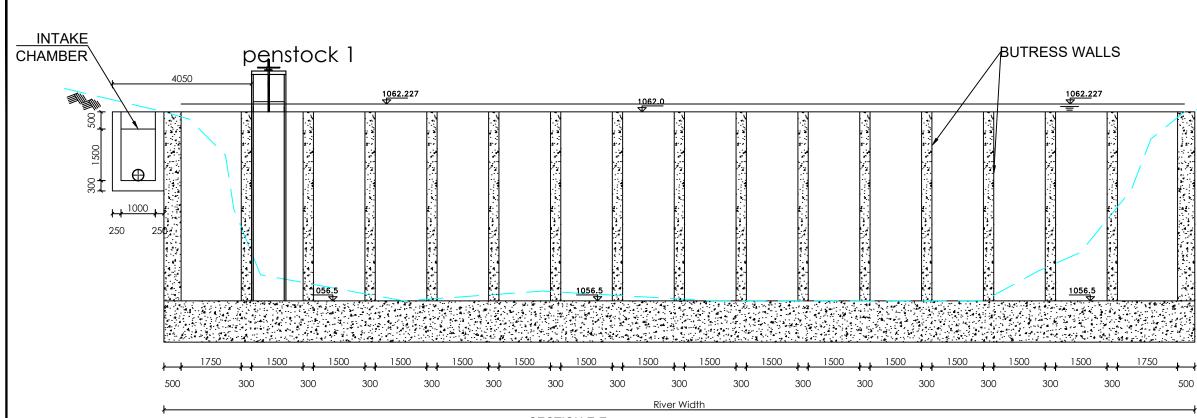


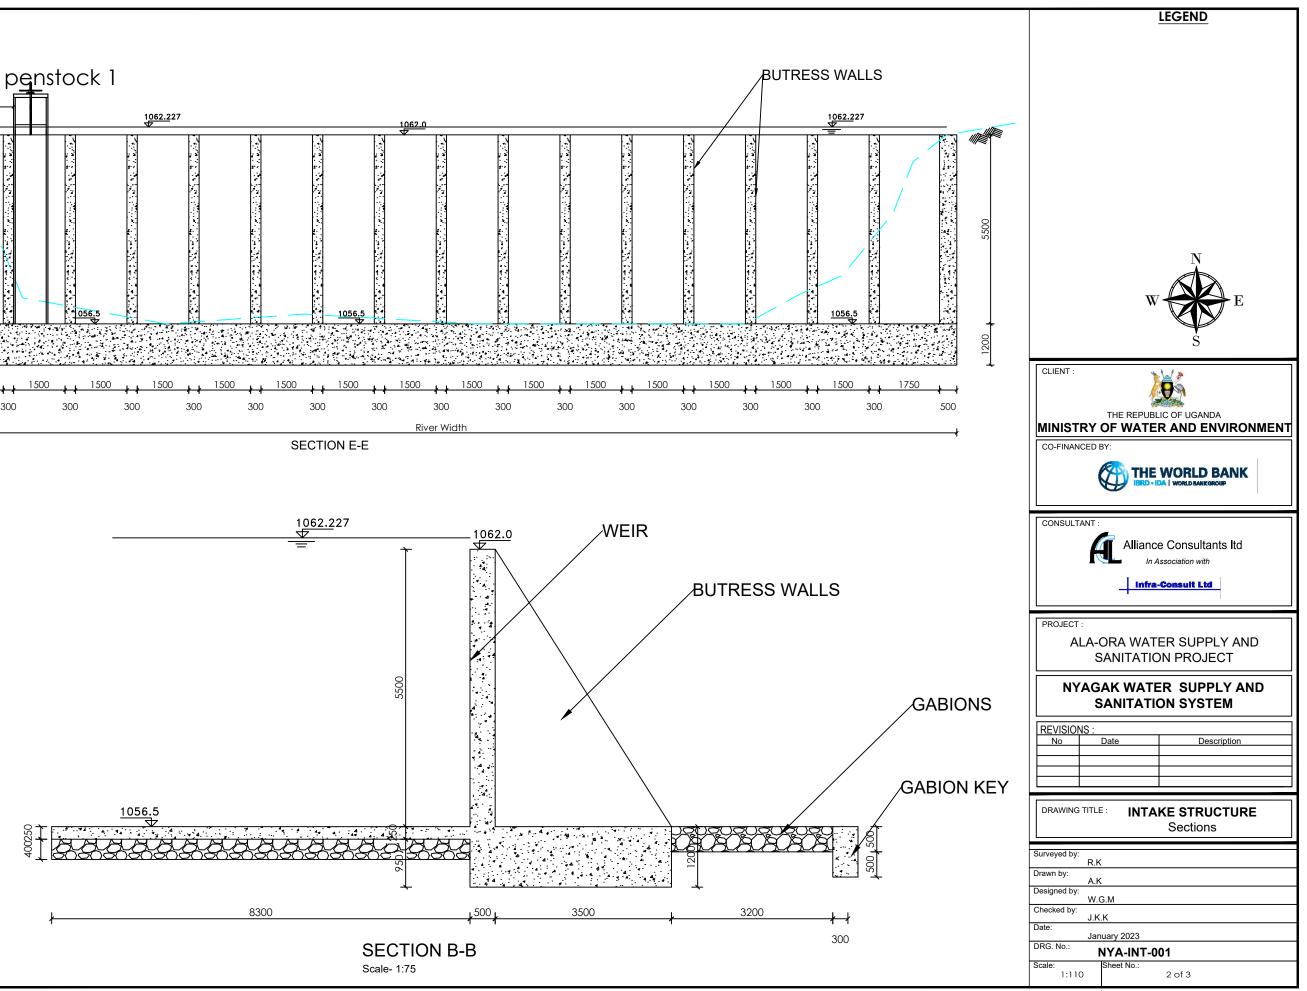


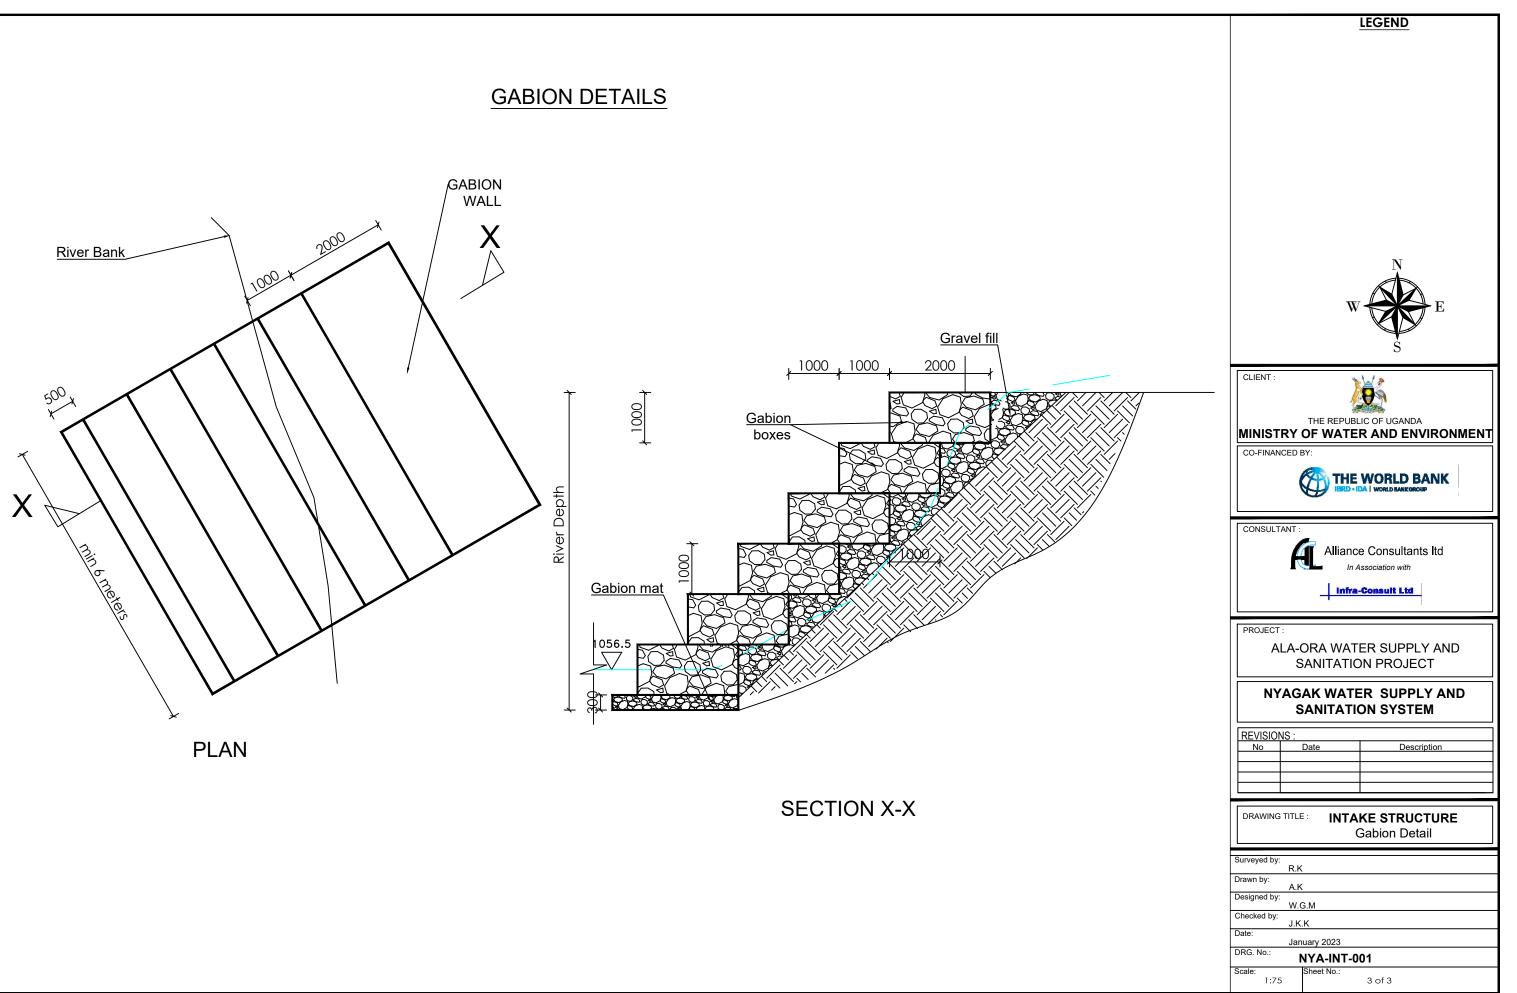

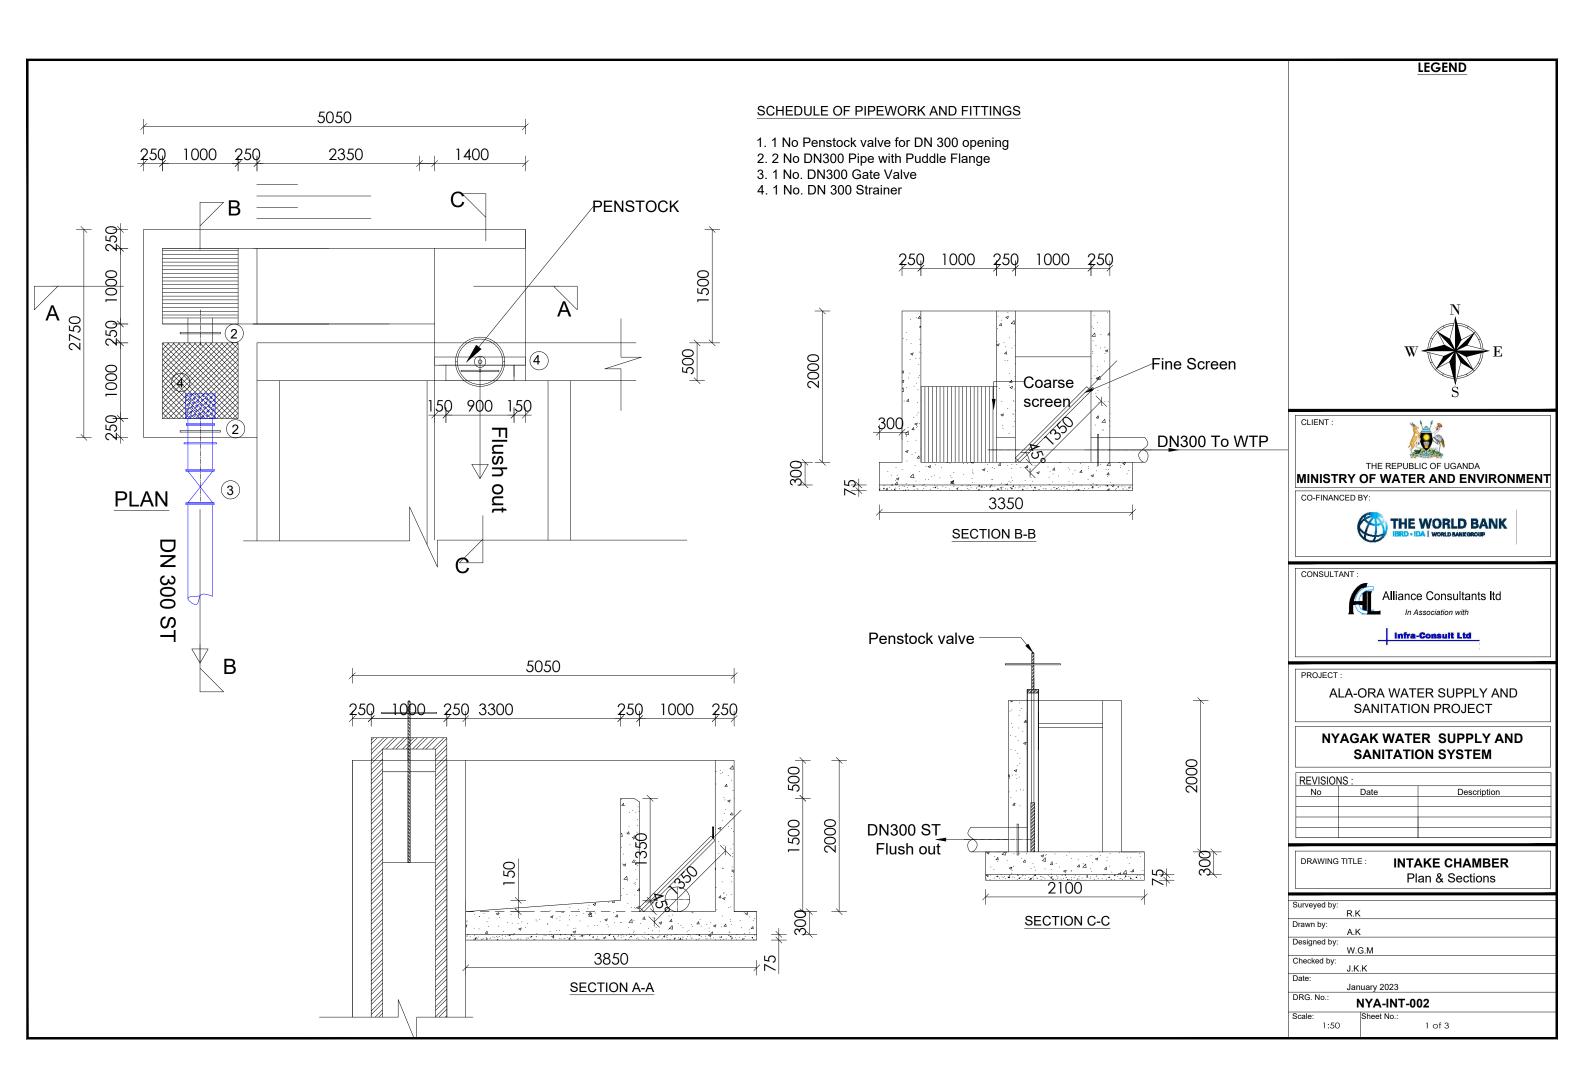

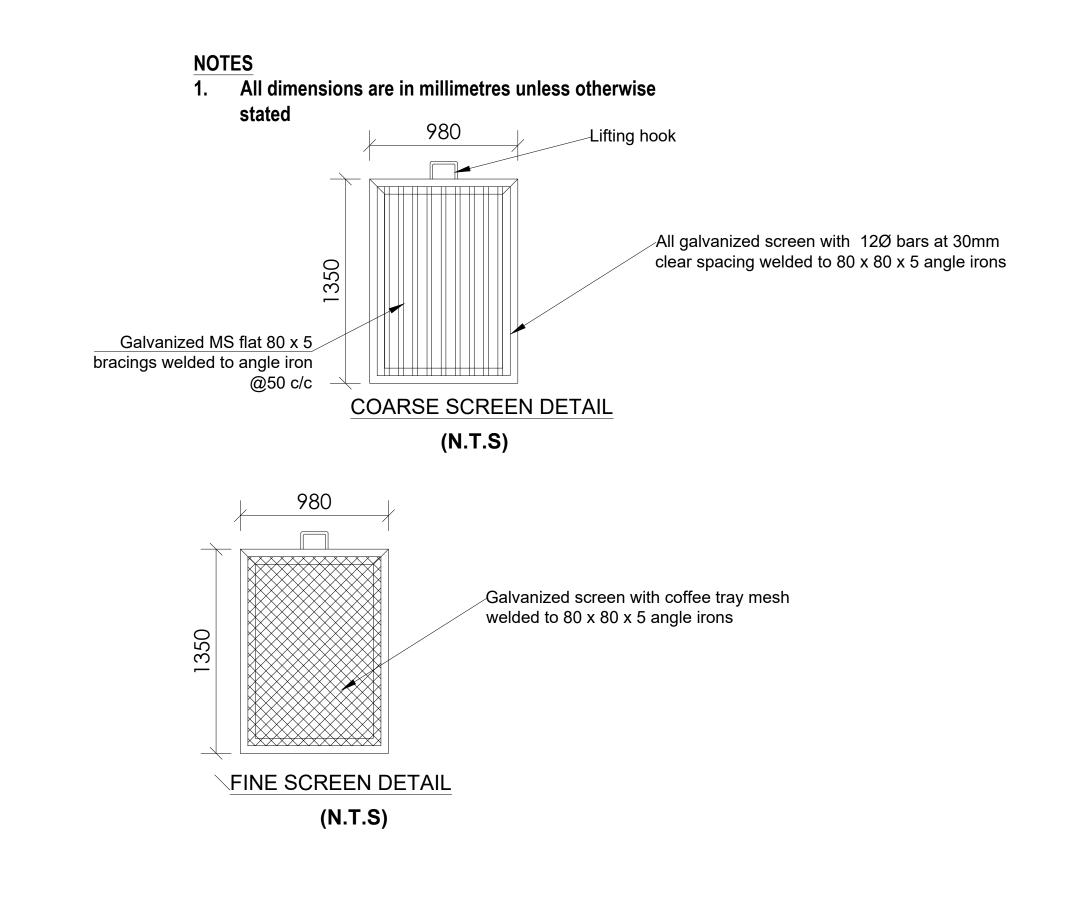

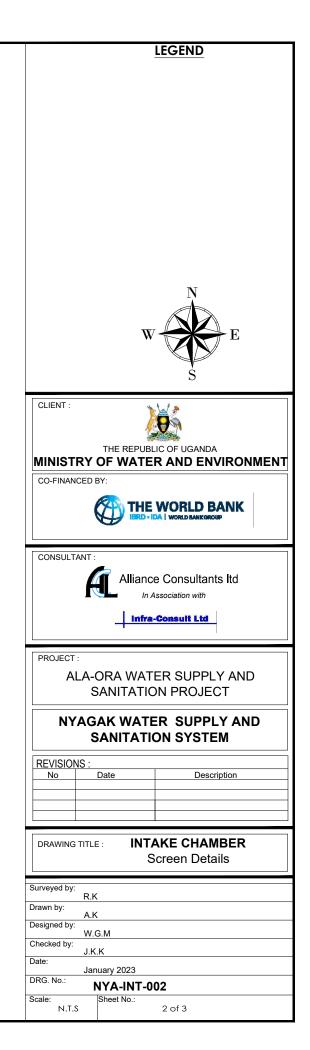

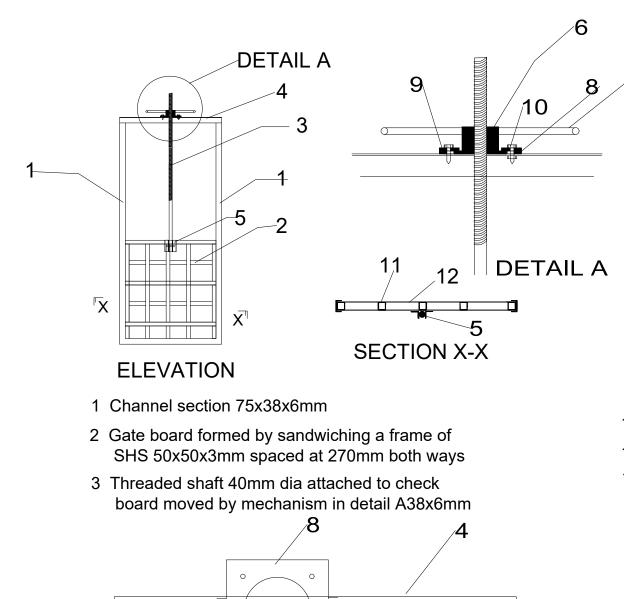


()

Detail of plate 8

4 Channel section 75x38x6mm

- 5 Angle brackets 50X50x6mm fixing the shaft to the board with a pin that can shear on excessive turning of closing wheel 75x38x6mm
- 6 Metal piece with female thread to move the gate shaft
- 7 Wheel welded to part 6 above
- 8 Spacer plate 270x270x12mm with central hole 178mm dia and 4 No holes 12mm dia for bolts (see detail) It is welded all round to item 4
- 9 Steel plate 270x270x12mm with central hole 140mm dia and 4 No holes 12mm dia for bolts (see detail)
- 10 Bolts 10mm dia with necessary washers and nut
- 11 frame of SHS 50x50x3mm spaced at 270mm both ways
- 12 Steel Plate 1200x600x6mm covering each of the sides of steel sections

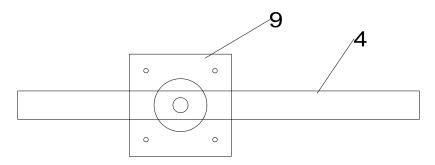



Detail of plate 9


DETAILS OF PENSTOCKS

weld all


round

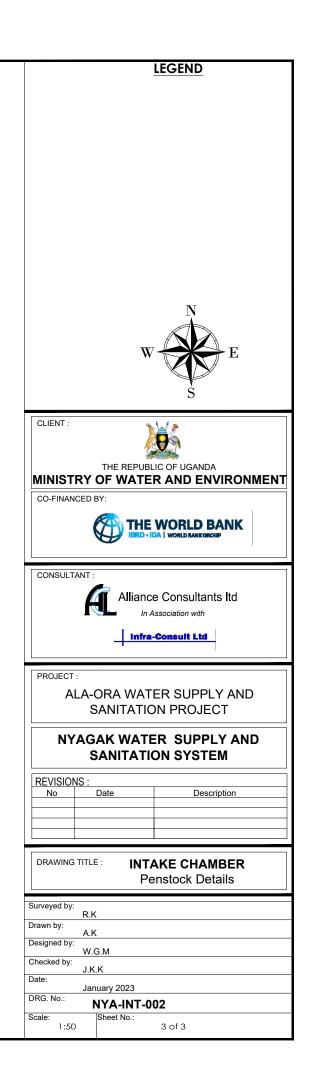


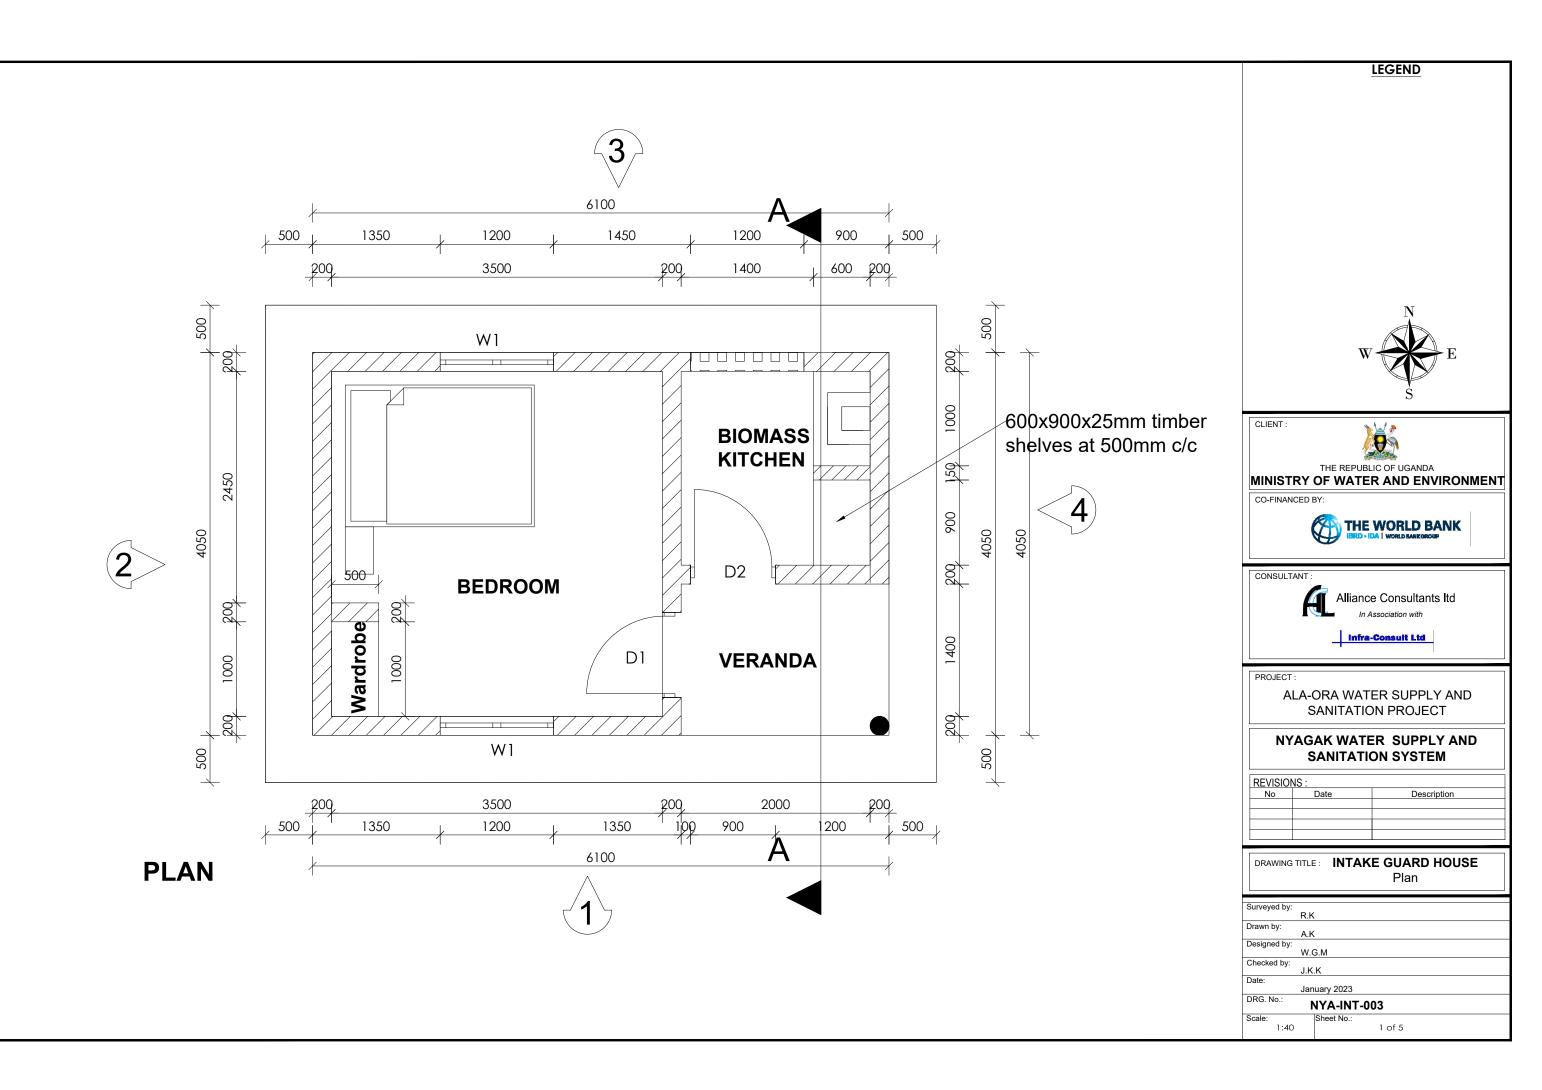

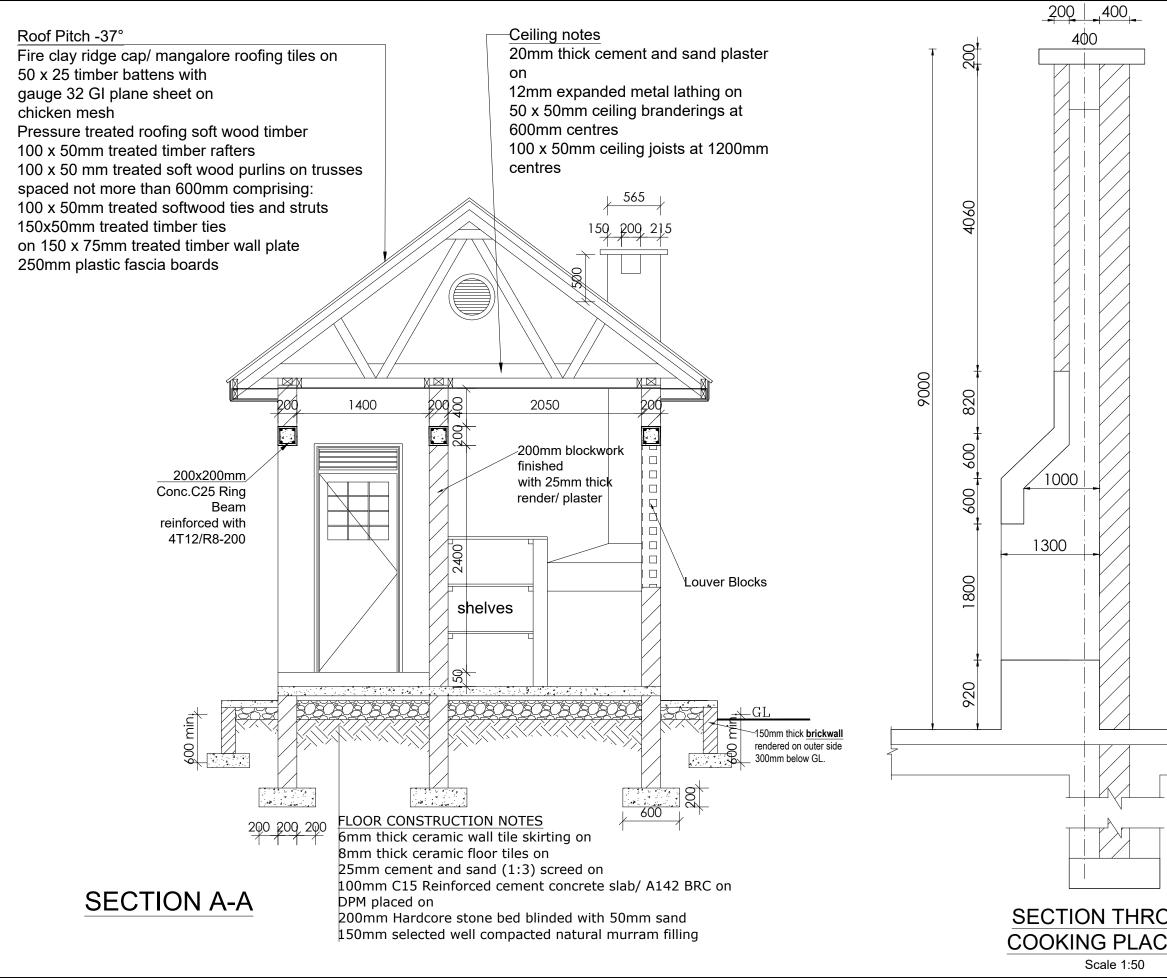



		-	LEGEND
			Ŋ
		W	E
	CLIENT :	Ì	B
	MINISTRY		IC OF UGANDA R AND ENVIRONMENT
	CO-FINANCED	BY:	
	CONSULTANT :		e Consultants Itd
			Consult Ltd
	PROJECT :		ER SUPPLY AND
			N PROJECT
			R SUPPLY AND
	REVISIONS :	Data	Description
	No	Date	Description
	DRAWING TITLE	E: INTAK	E GUARD HOUSE Section
	Surveyed by:		
	R.K Drawn by:		
	A.k Designed by:		
	W.0 Checked by:	G.M	
DUGH	J.K Date:		
E B-B	DPG No :	uary 2023 NYA-INT-00	13
	Scale:	Sheet No.:	
	1:40		2 of 5

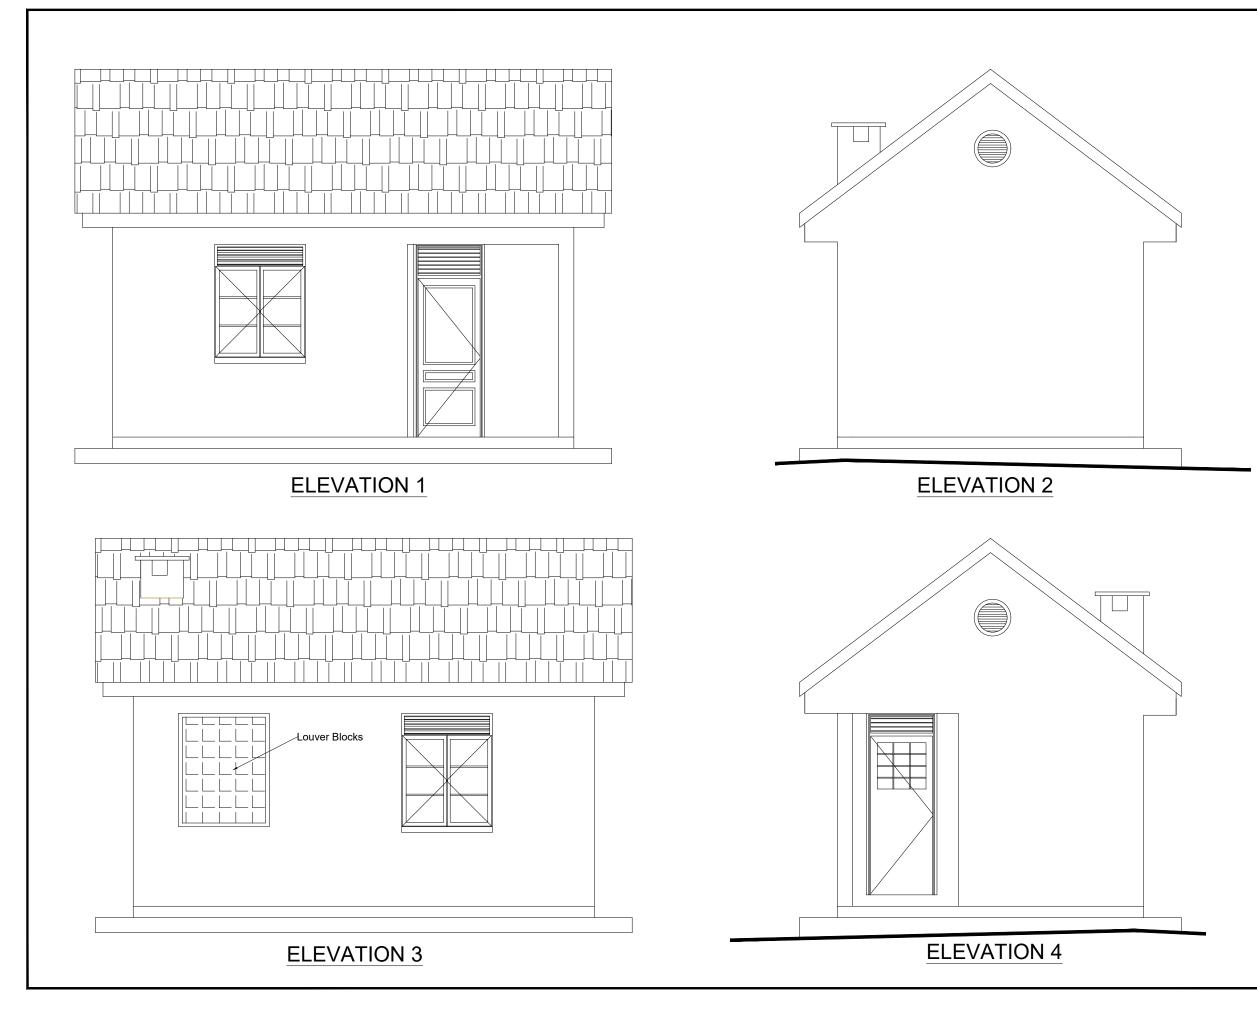


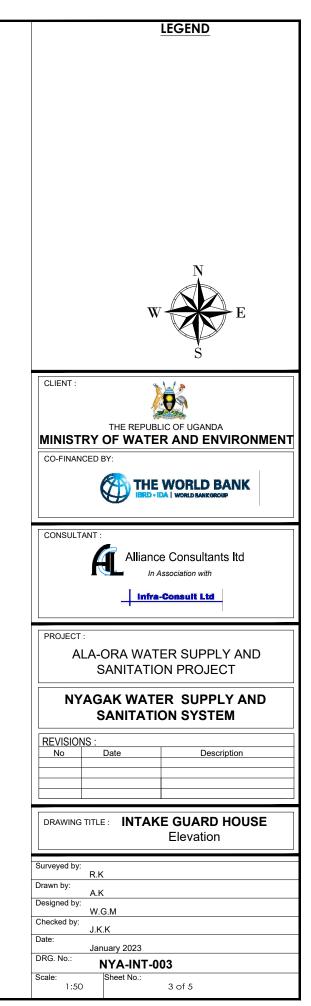



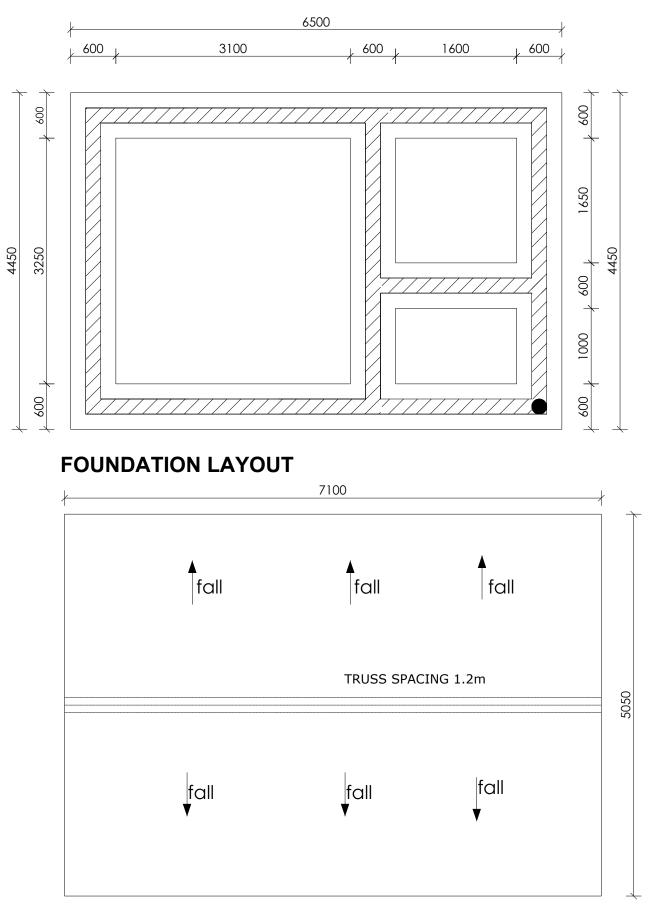

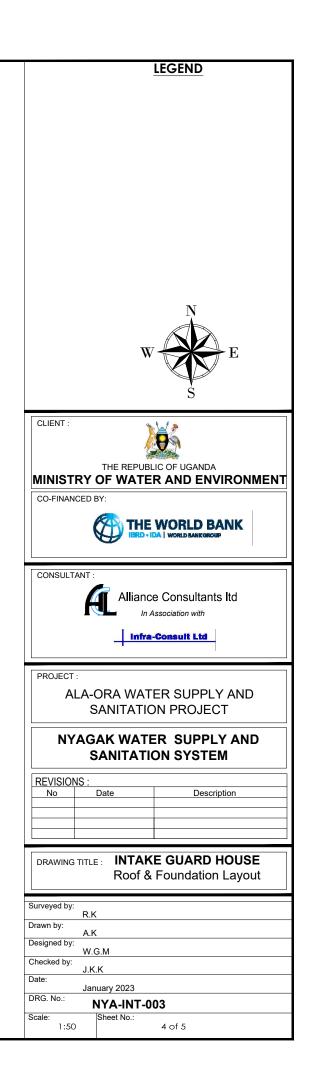

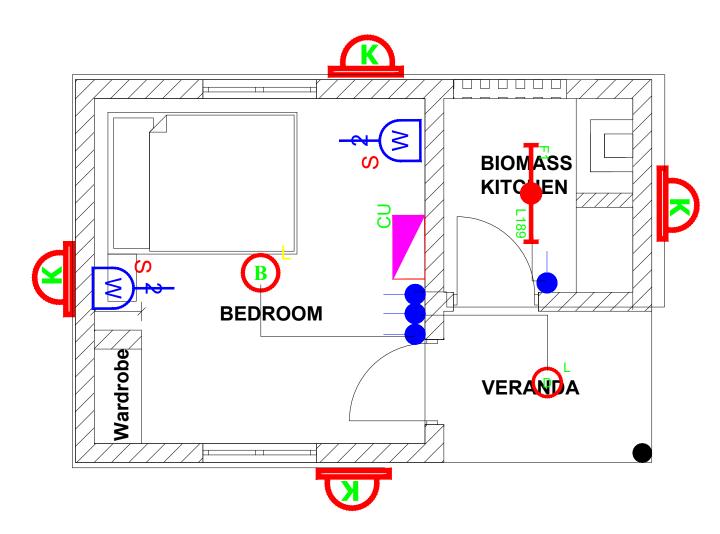

1). ALL WALL BRACKETS SHALL BE MOUNTED 1800mm ABOVE FINISHED FLOOR LEVEL

2). TELEPHONE, SOCKETS, T.V AND COMPUTER OUTLETS SHALL BE MOUNTED 300mm ABOVE FINISHED FLOOR LEVEL EXCEPT WHERE THEIR IS A WORKTOP.

3). WHERE THEIR IS A WORKTOP, TELEPHONE, SOCKETS, T.V AND COMPUTER OUTLETS SHALL BE MOUNTED 150mm ABOVE WORKTOPS.

4). CONSUMER UNITS SHALL BE 1800mm ABOVE FINISHED FLOOR LEVEL


5). ALL SWITCHES SHALL BE 1400mm ABOVE FINISHED FLOOR LEVEL


6). ALL OUTSIDE SOCKETS SHOULD BE WEATHER PROOF


7). ALL SHAVER SOCKETS SHOULD BE ON THE RIGHT HAND SIDE OF THE WASH HAND BASIN


8). ALL CABLES MUST BE STRANDED


SYMBOL	DESCRIPTION
F1	1200mm 18W LED batten with a removable LED engine. IP As Thorn PopPack LED. or equal approved. (Light Type F1
O	Pedant lighting fitting comprising ceiling Rose 300mm 3x1 flexible copper cable lamp holder and 6W LED Lamp
Ø	Pedant lighting fitting comprising ceiling Rose 300mm 3x1.5n flexible copper cable lamp holder and 6WLED Lamp
₿	Pedant lighting fitting comprising ceiling Rose 300mm 3x1. flexible copper cable lamp holder and 6W LED Lamp
	Decorative Bed side lamp complete with flexible spot light arm as LEDS-C4 BALI (05-3217-19-82 + PAN-157-BY) to client's approval.
<u>a</u>	wall mounted light
	Socket outlet on Wall
CU	Consumer's Unit
¥	One Gang 2way Switch
~~	Two Gang 2way Switch
	Three Gang 2way Switch
•	One Gang 1way Switch
*	Two Gang 1way Switch
666	Three Gang 1way Switch
Ó	Intermediate Switch
PC	Photo - Cell

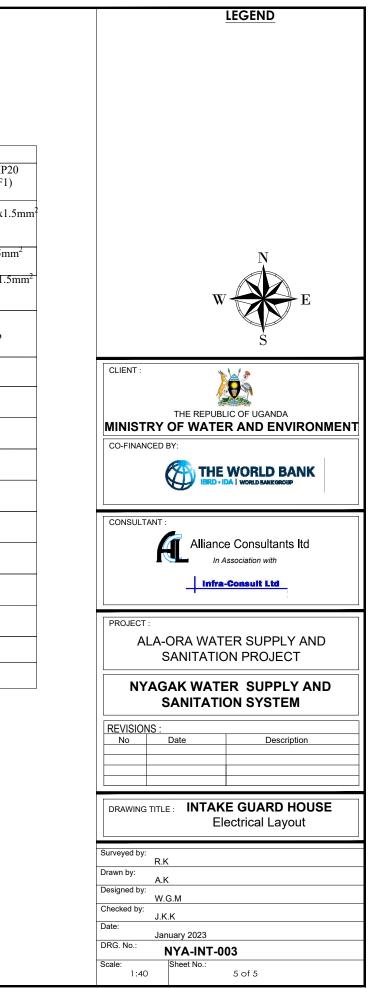

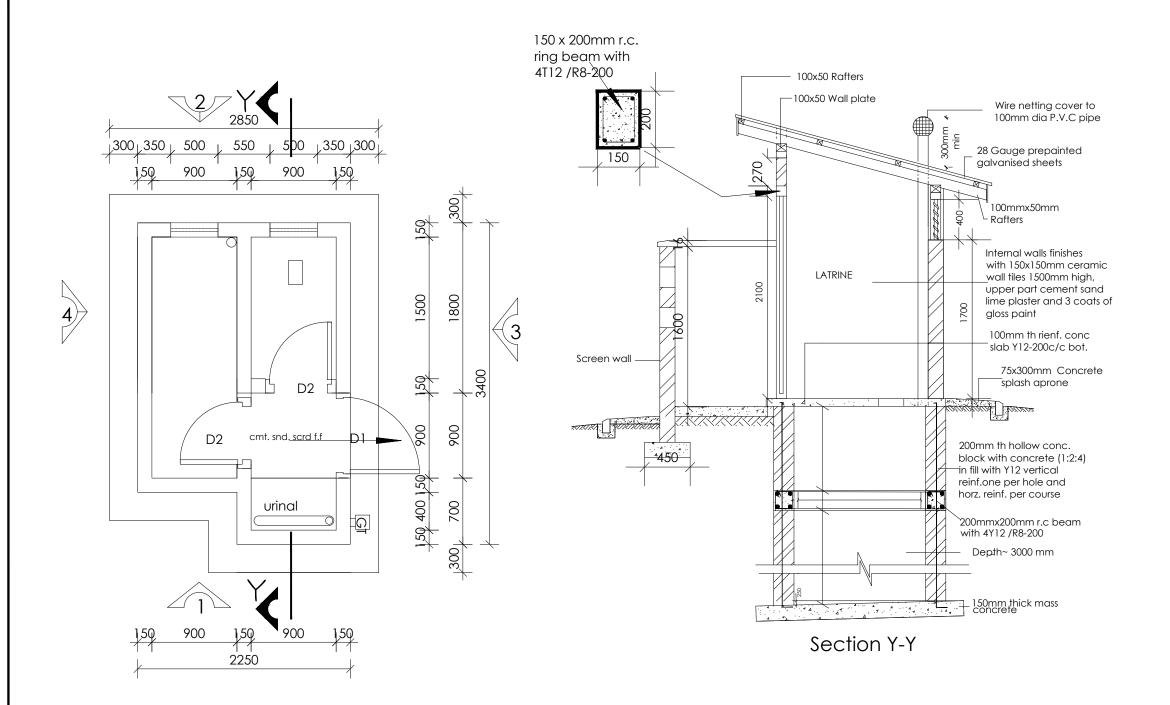


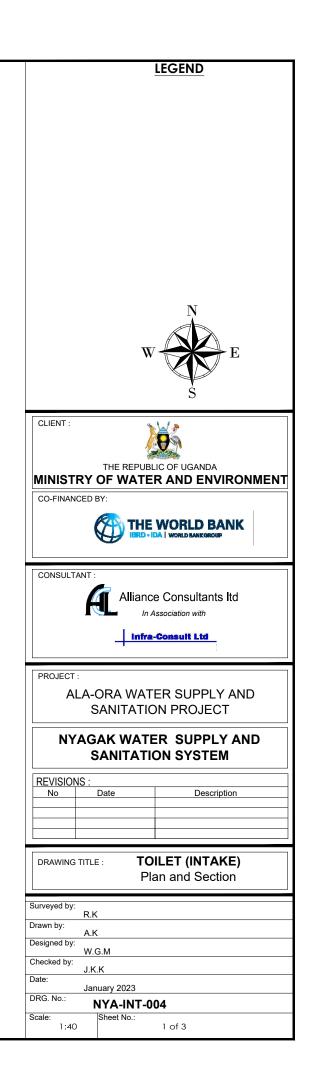


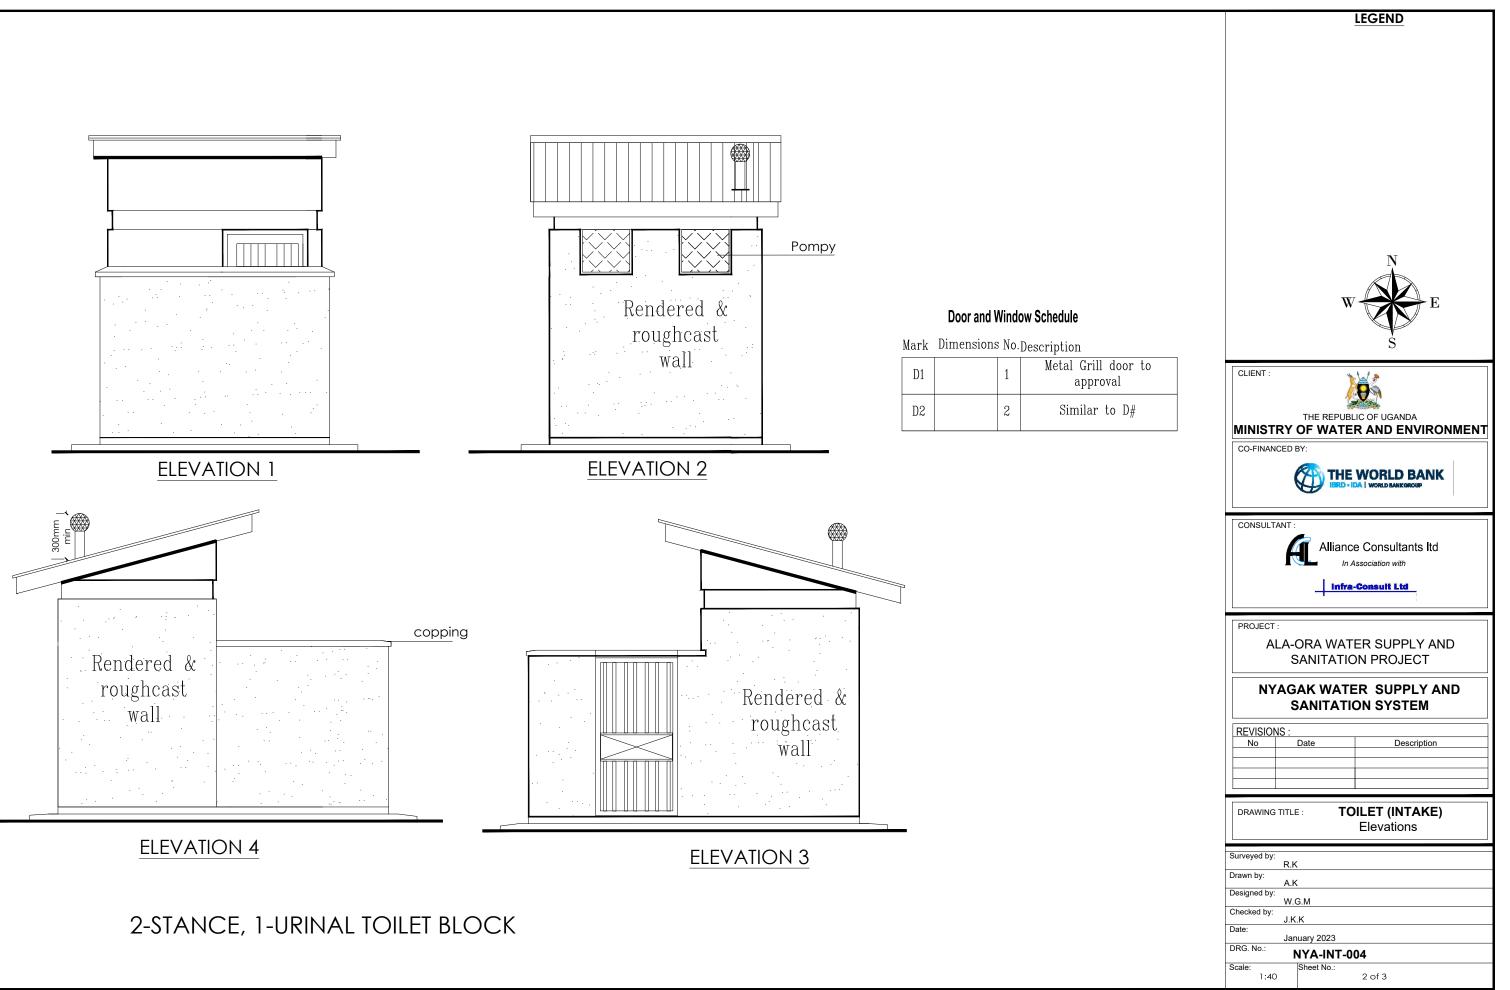


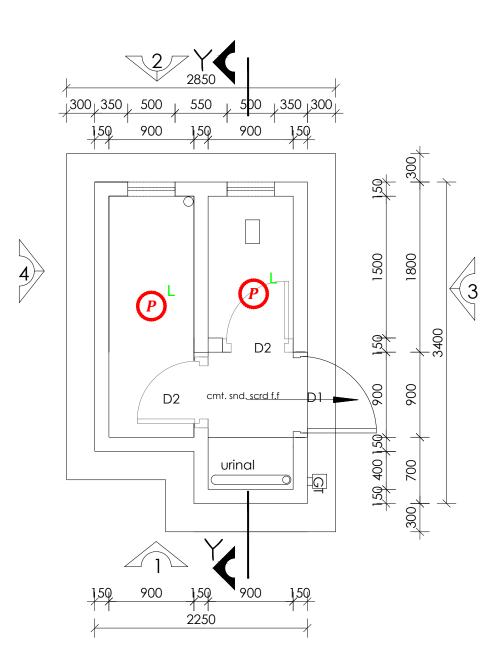


SYMBOL	DESCRIPTION
F1	1200mm 18W LED batten with a removable LED engine. IP20 As Thorn PopPack LED. or equal approved. (Light Type F1)
O ^L	Pedant lighting fitting comprising ceiling Rose 300mm 3x1.5mm ² flexible copper cable lamp holder and 6W LED Lamp
	Pedant lighting fitting comprising ceiling Rose 300mm 3x1.5mm ² flexible copper cable lamp holder and 6WLED Lamp
B	Pedant lighting fitting comprising ceiling Rose 300mm 3x1.5mm ² flexible copper cable lamp holder and 6W LED Lamp
K	Decorative Bed side lamp complete with flexible spot light arm as LEDS-C4 BALI (05-3217-19-82 + PAN-157-BY) to client's approval.
	wall mounted light

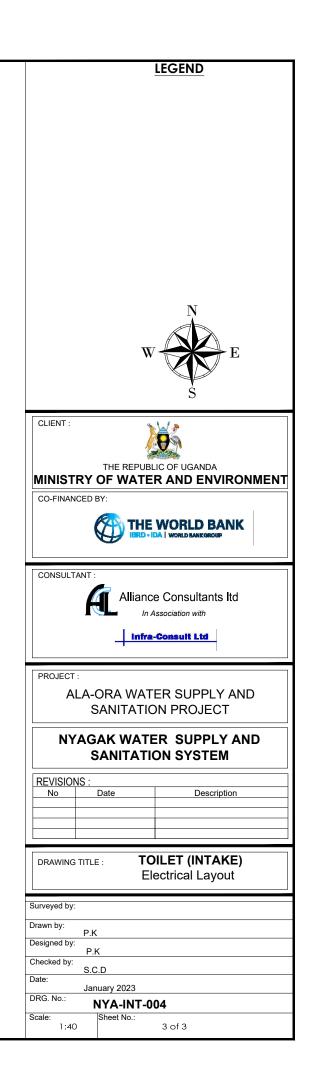

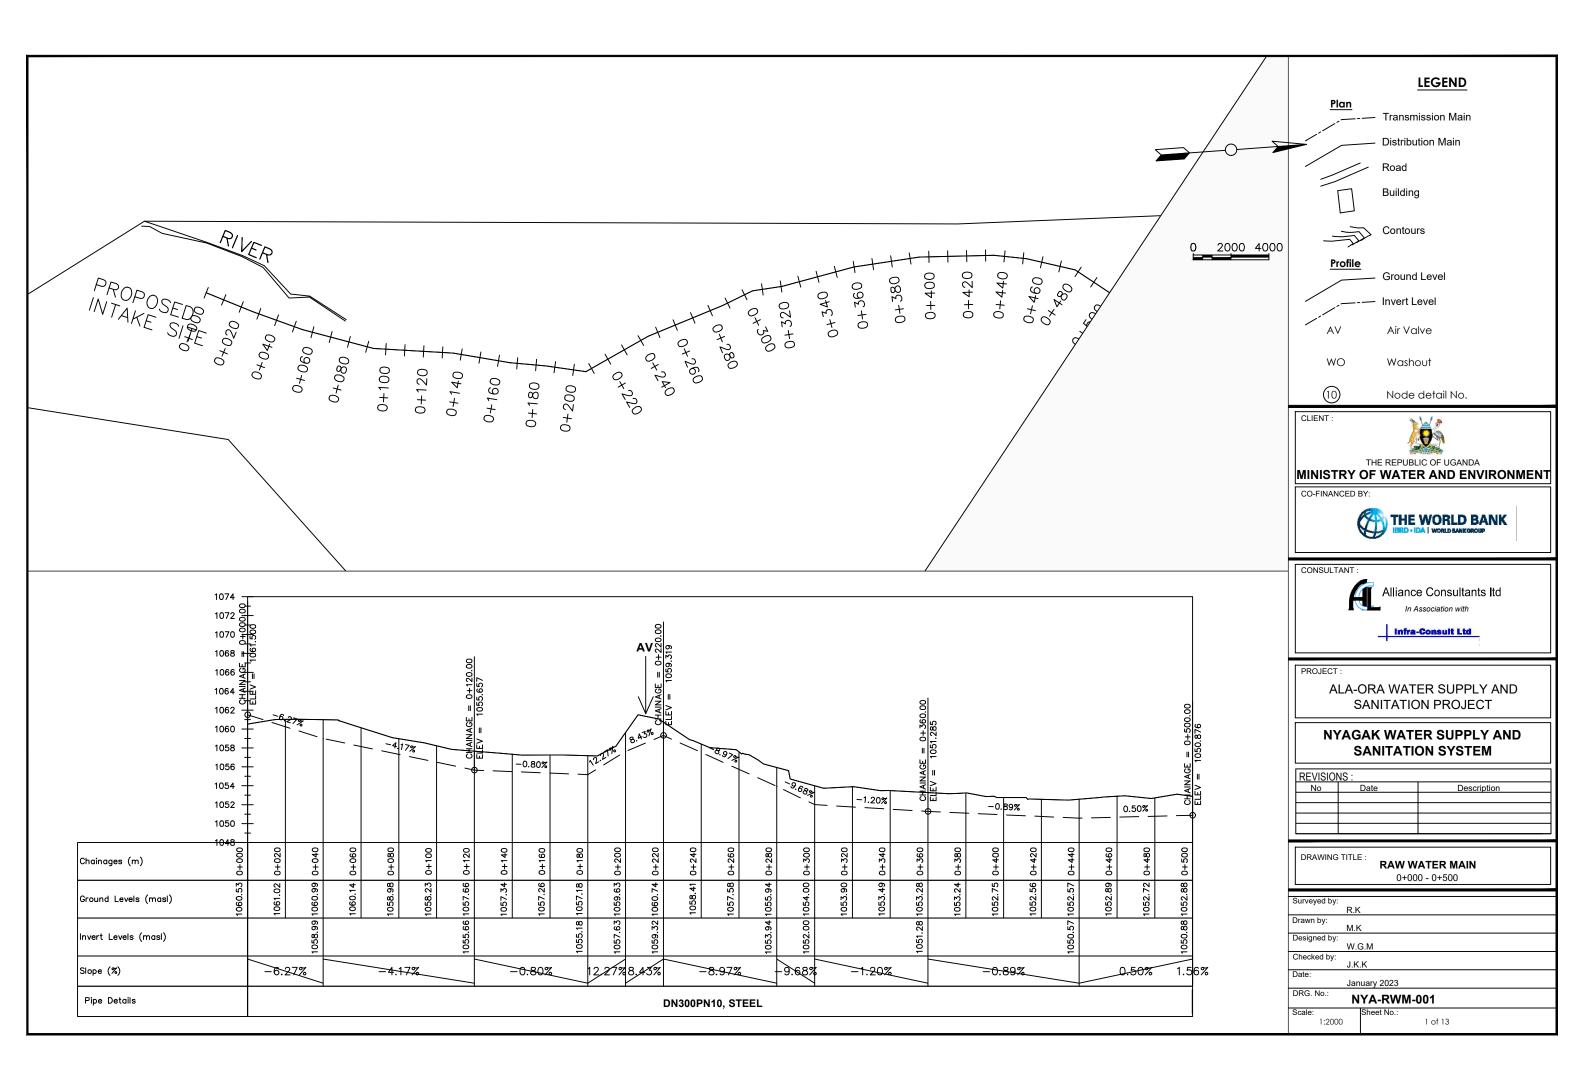


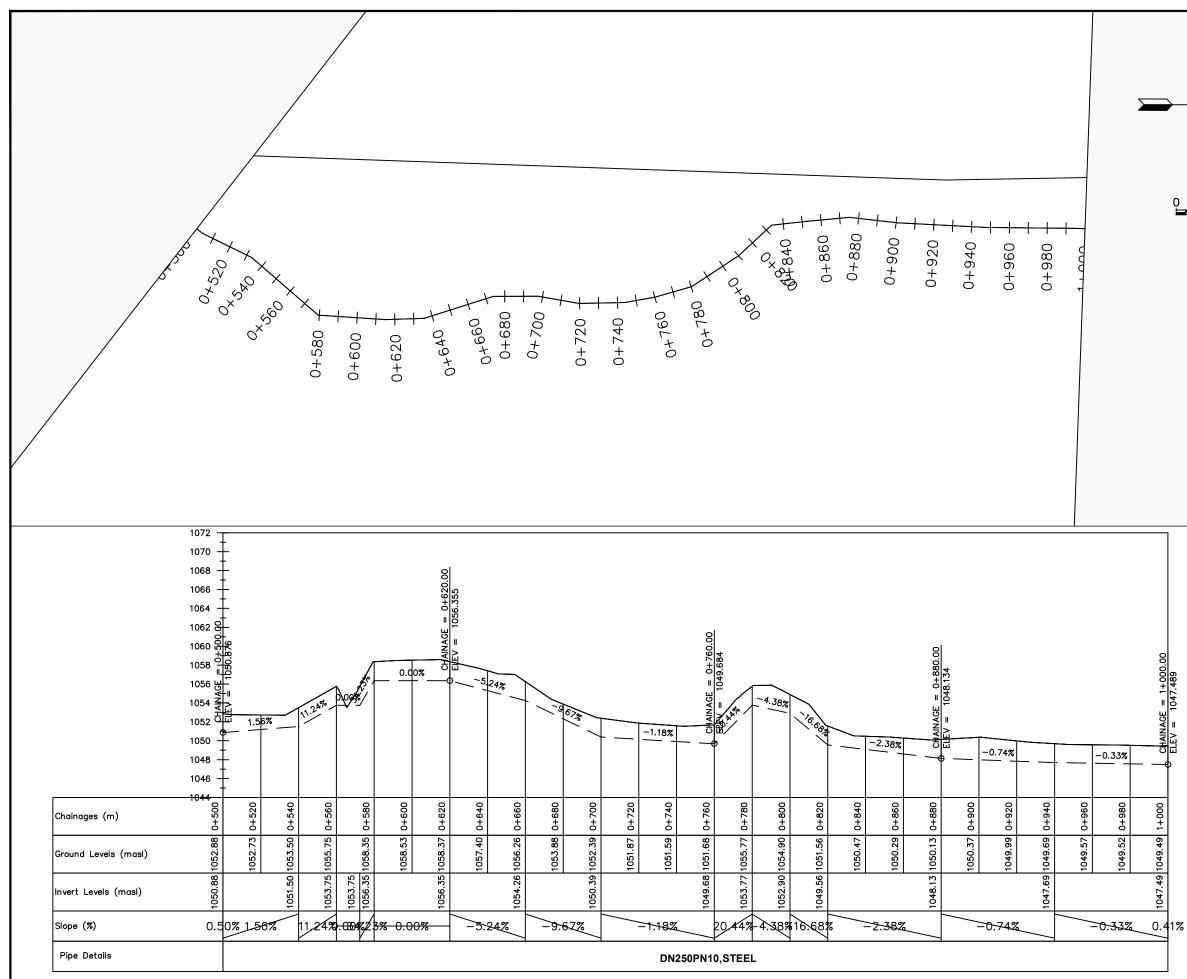


		LEGEND
	<u>Plan</u>	
		Transmission Main
-	>	 Distribution Main
		Road
		Building
2000 4000	T	Contours
	<u>Profile</u>	
		 Ground Level Invert Level
	AV	Air Valve
	WO	Washout
	(10)	Node detail No.
	CLIENT :	Xe s
	CO-FINANCED BY	
	Ć	THE WORLD BANK
	CONSULTANT :	
		Alliance Consultants Itd
		Infra-Consult Ltd
	PROJECT : ALA-O	RA WATER SUPPLY AND
	SA	ANITATION PROJECT
		AK WATER SUPPLY AND ANITATION SYSTEM
	REVISIONS :	ate Description
	DRAWING TITLE :	RAW WATER MAIN 0+500 - 1+000
	Surveyed by: R.K	
	Drawn by: M.K Designed by:	
	W.G. Checked by: J.K.K	
	Date:	ary 2023
	Scale: S	A-RWM-001
	1:2000	2 of 13

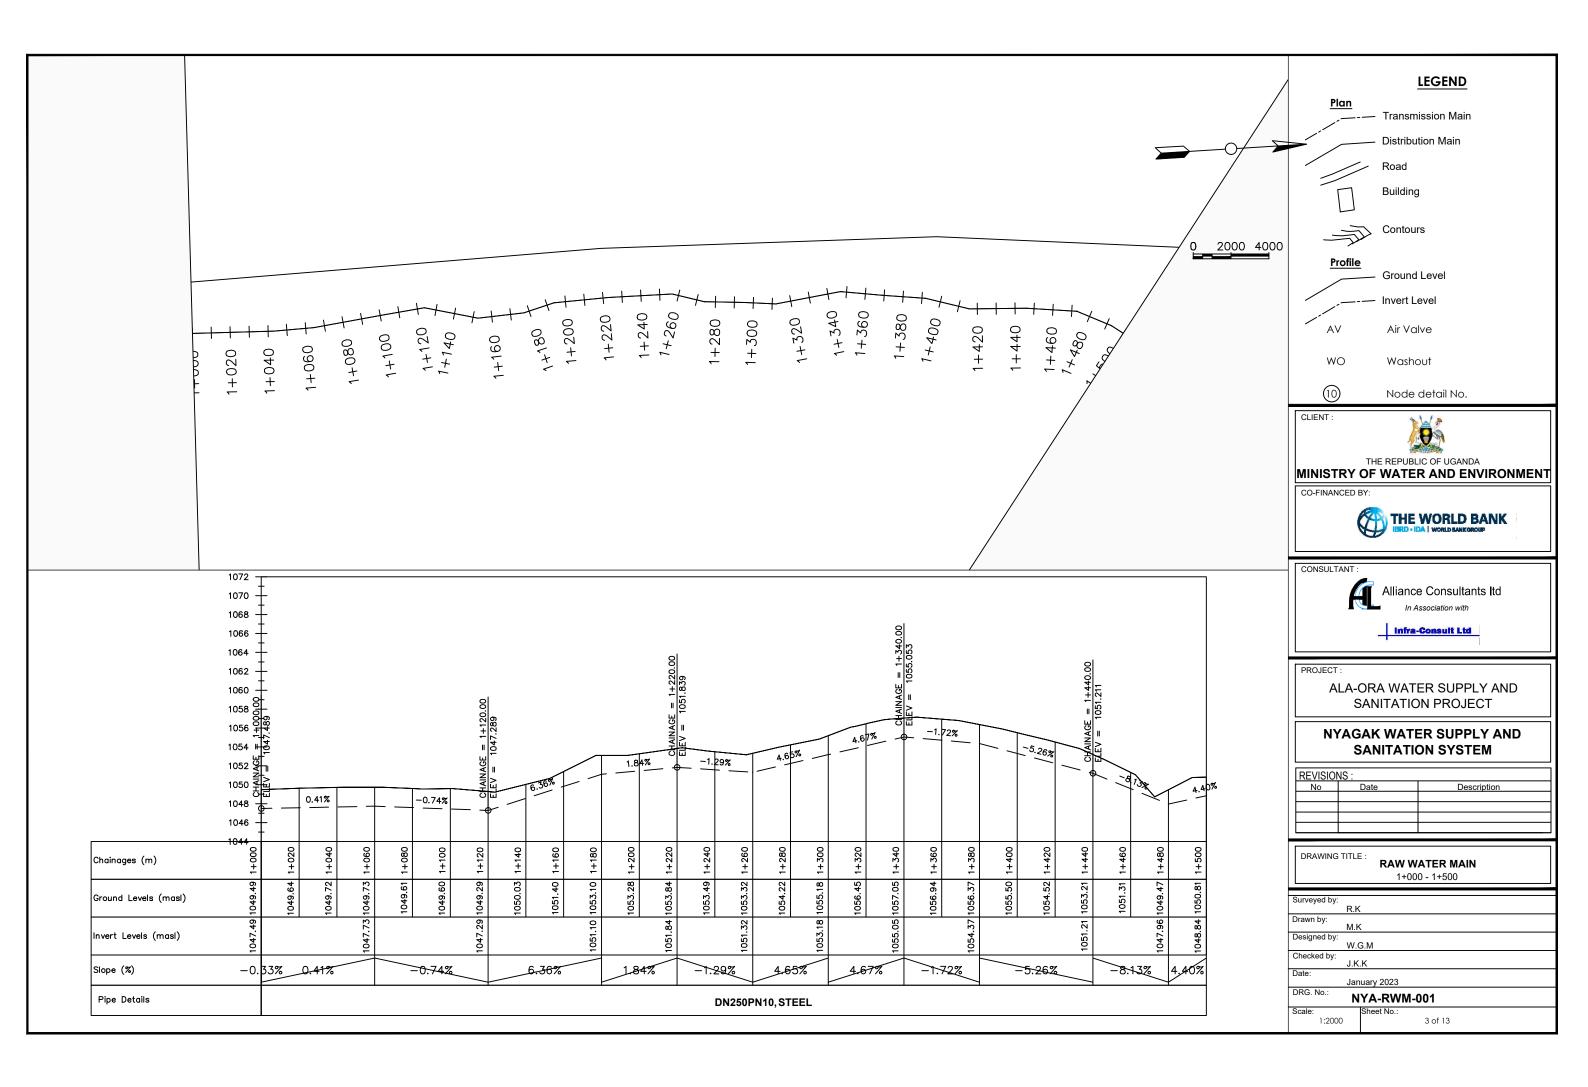



	$ \begin{array}{c} 1+560 \\ 1+580 \\ 1+580 \\ 1+620 \\ 1+620 \\ 1+620 \\ 1+720 \\ 1+720 \\ 1+720 \\ 1+720 \\ 1+780 \\ 1+780 \\ 1+840 \\ 1+880 \\ 1+880 \\ 1+880 \\ 1+900 $
1066 1064 1062 1060 1058 1056 1054 1052 10504 1052 10504 1048 1044 1044 1042 1040 1038 1038 Chainages (m) 1038 Chainages (m) 1038 Slope (%) 1040 Pipe Details 1040	OOODE-1

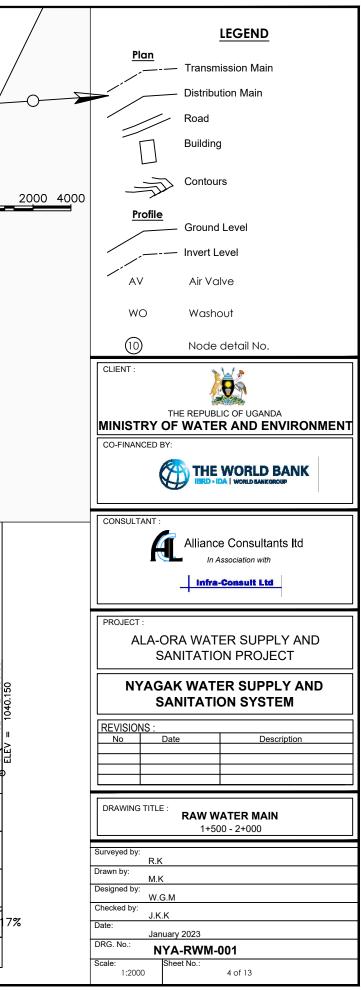


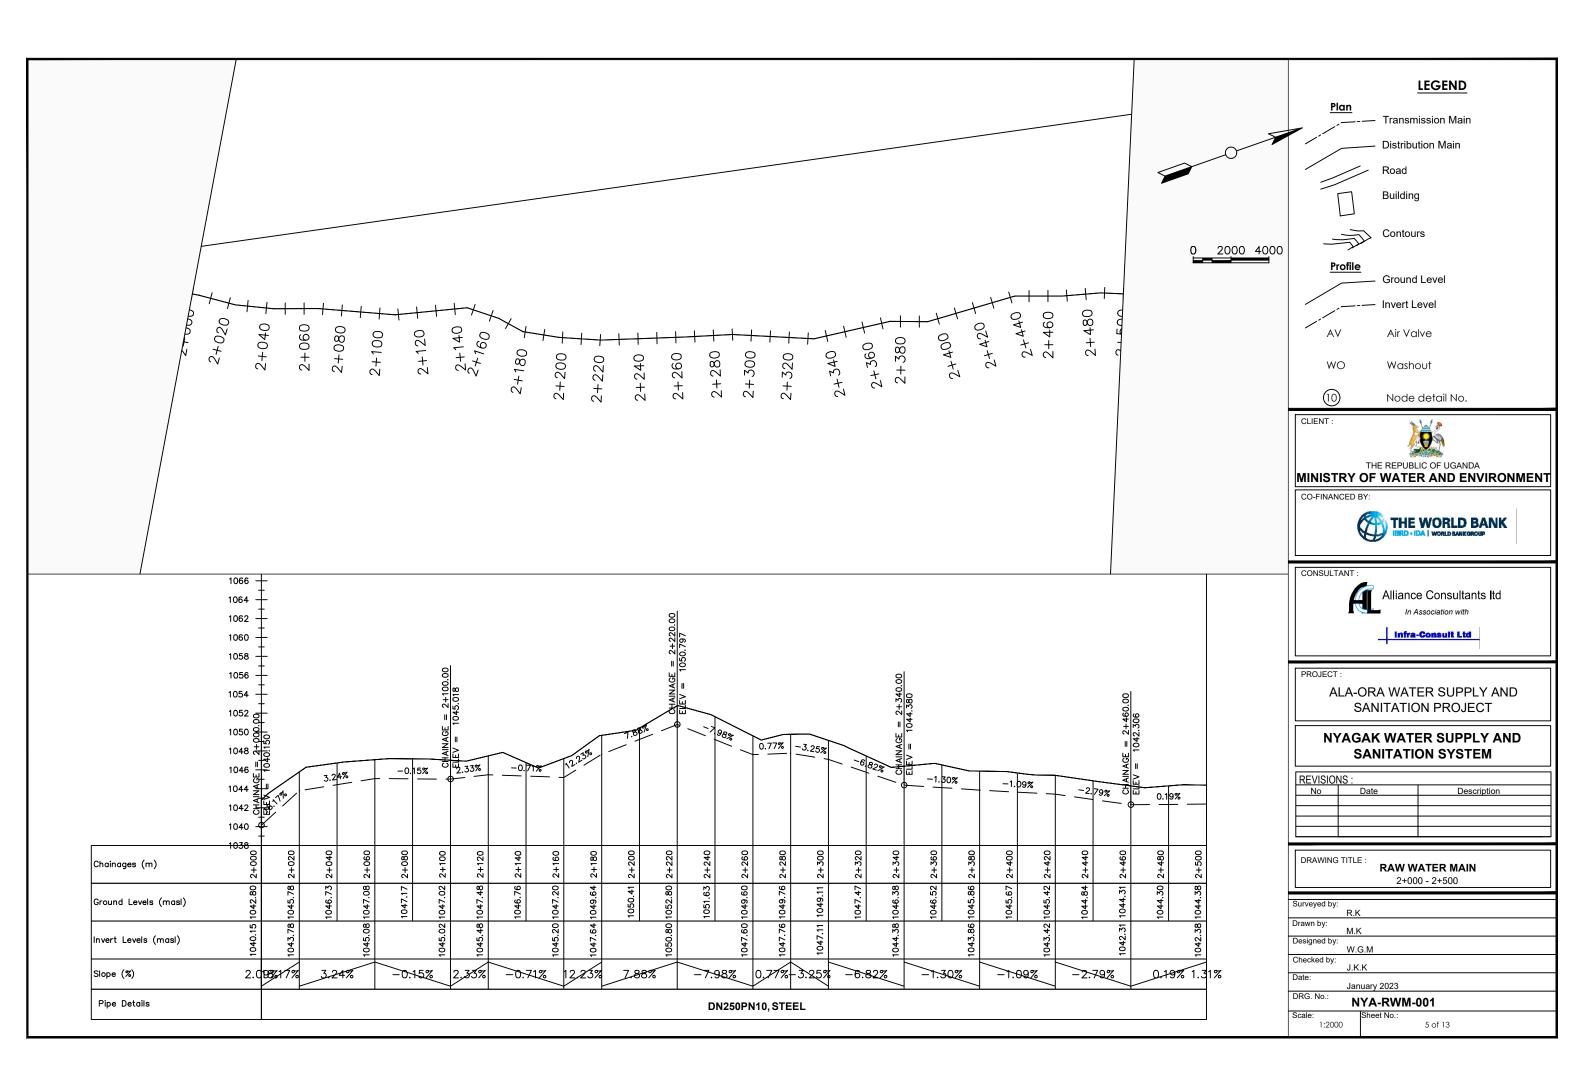


$ \begin{array}{c ccccccccccccccccccccccccccccccccccc$	(m)
1066 + + + + + + + + + + + + + + + + + +	1066 1064 1064 1065 1056 1057 1057 1056 1056 1056 1056 1056 1056 1057 1056 1056 1056 1057
$ \begin{vmatrix} m & m & m & m & m & m & m & m & m & m$	

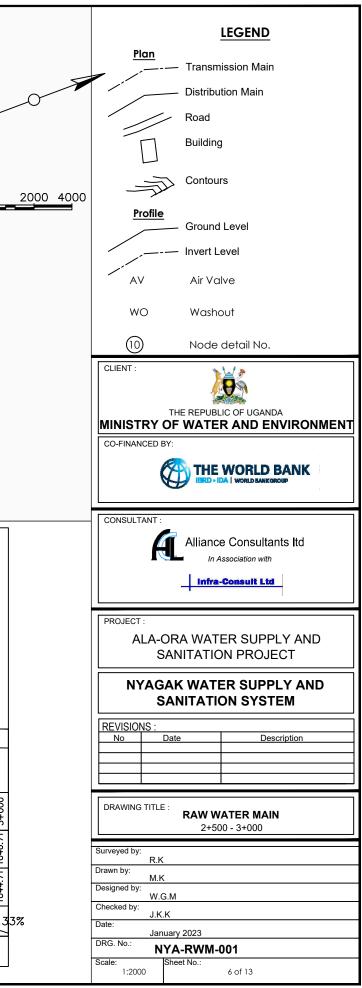


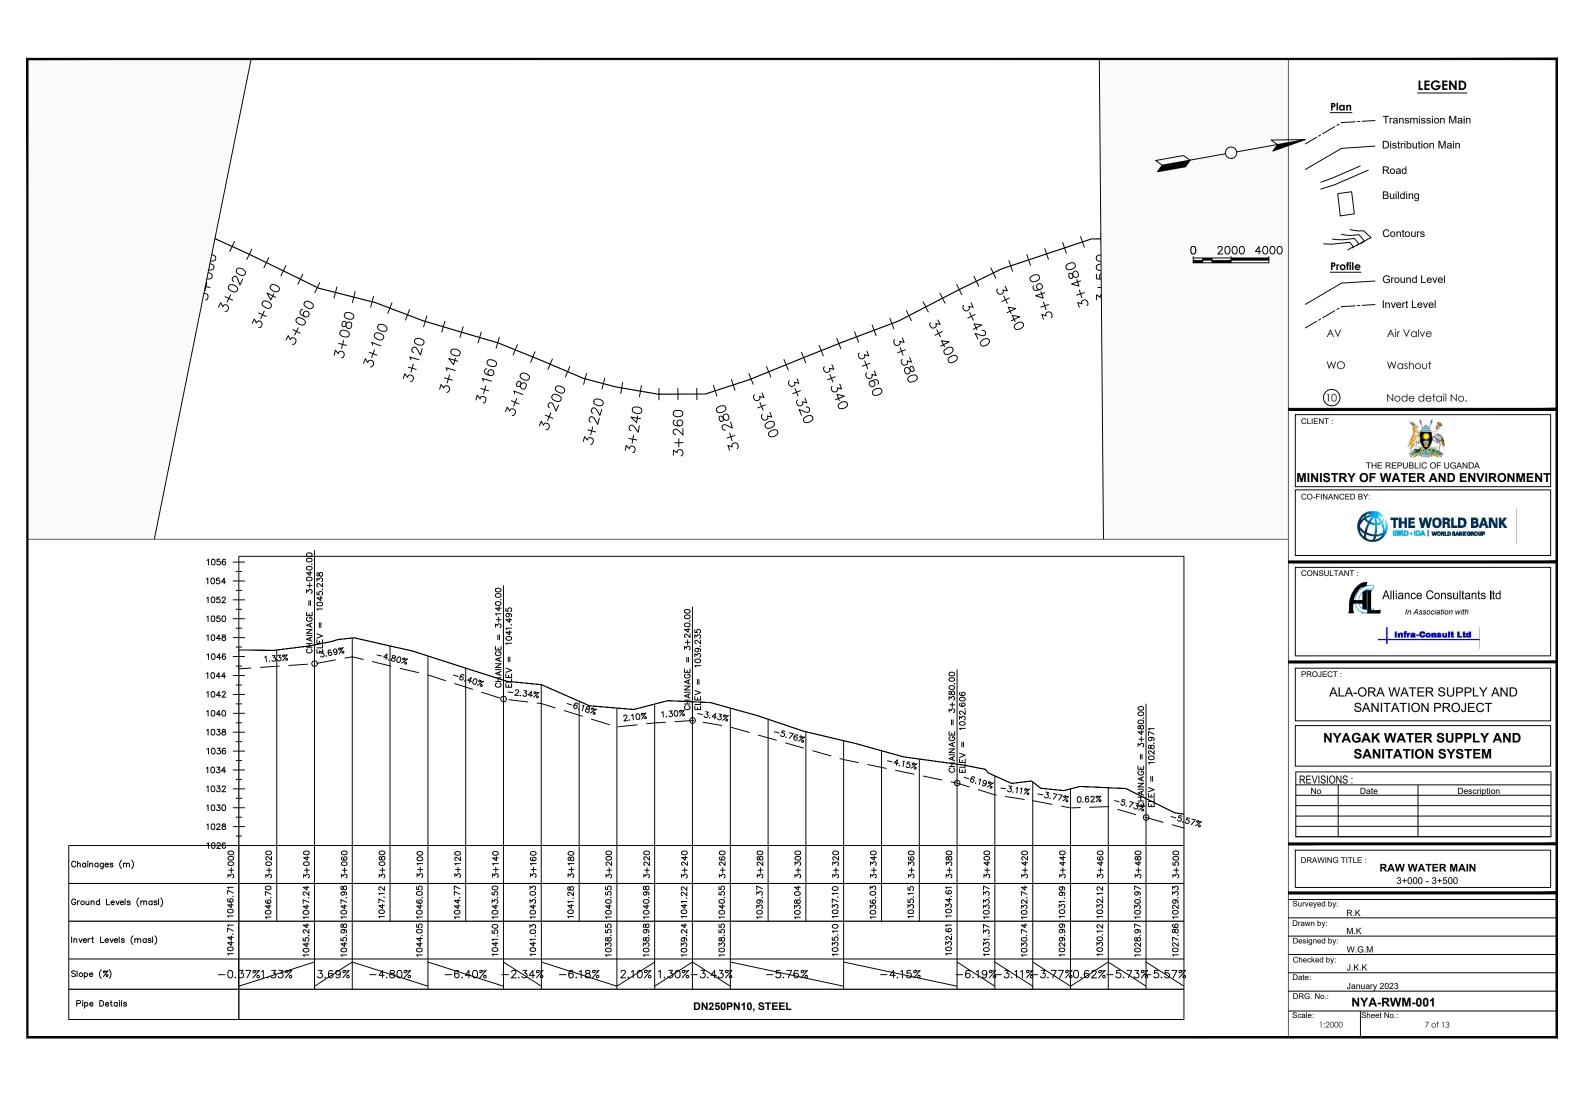


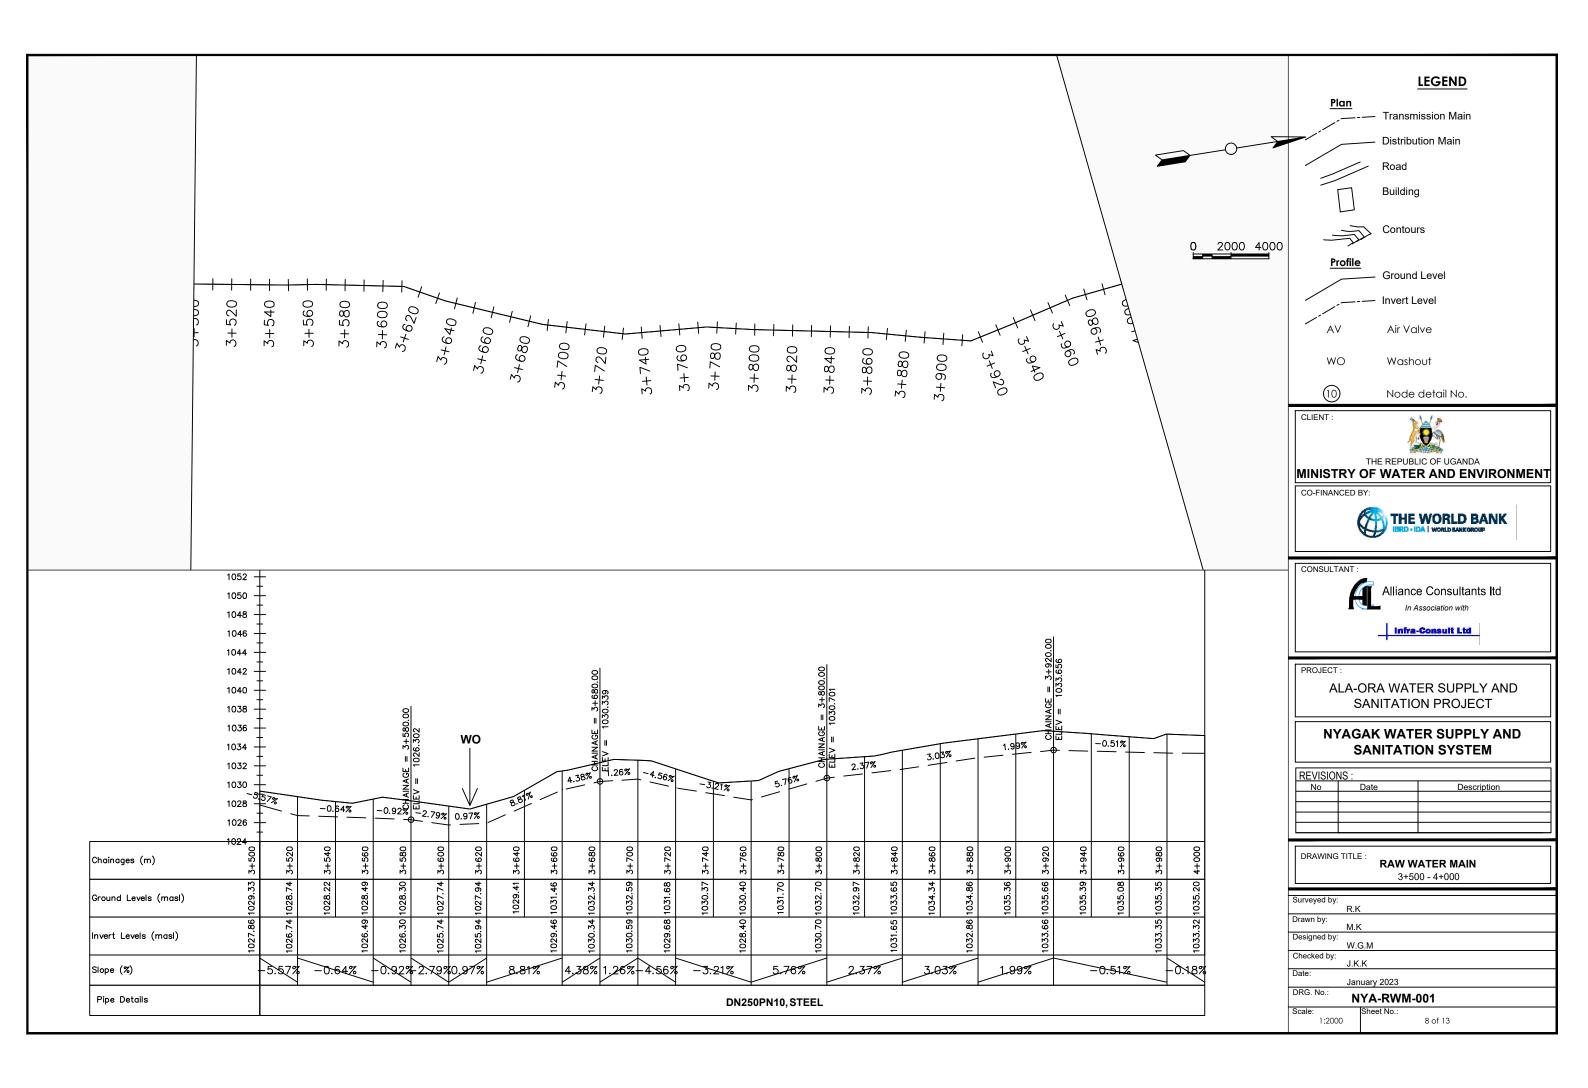


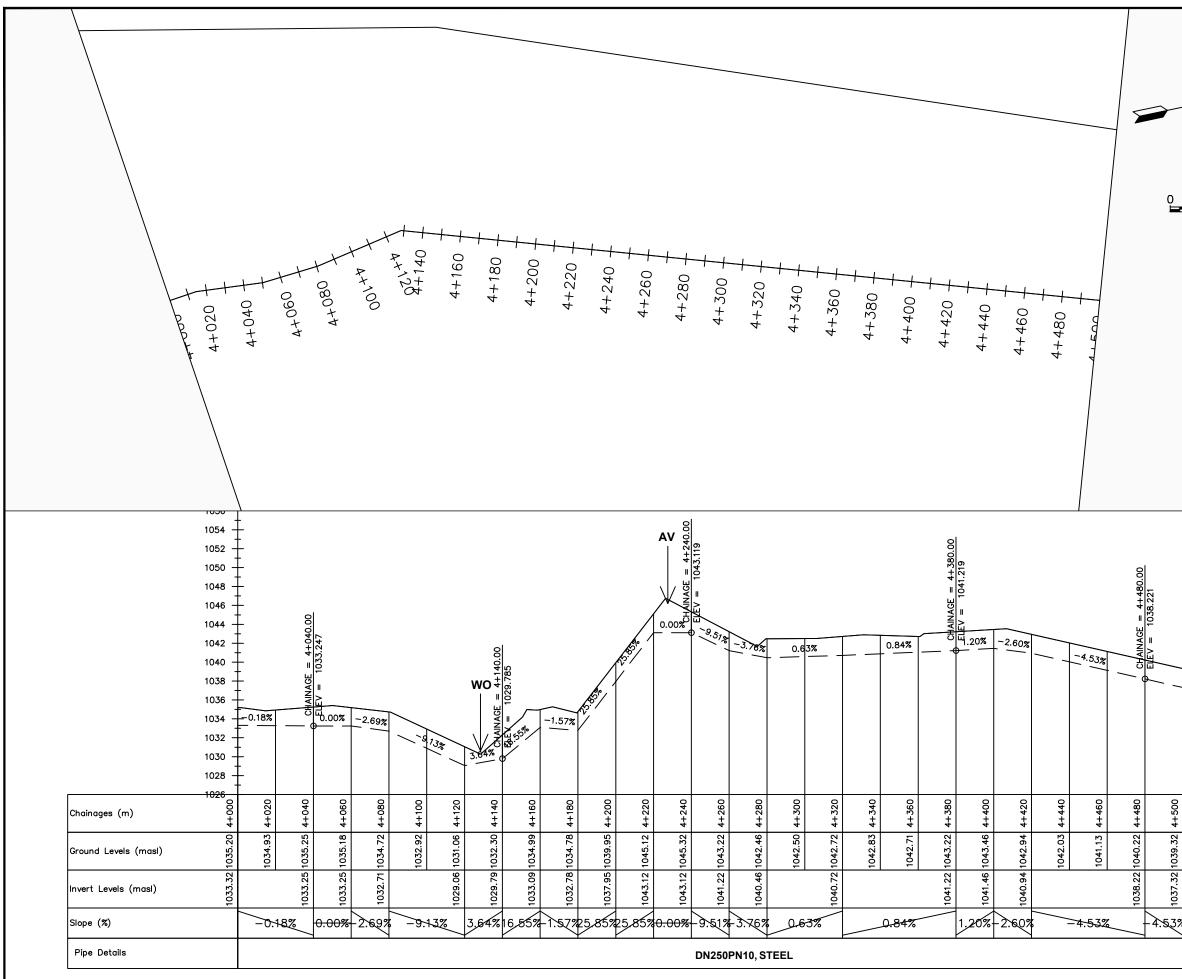


		LEGEND
	<u>Plan</u>	
	· · · · · · · · · · · · · · · · · · ·	— Transmission Main
		Distribution Main
		 Road
		Building
2000 4000	T	> Contours
	Profile	— Ground Level
		— Invert Level
	AV	Air Valve
	WO	Washout
	10	Node detail No.
	CLIENT :	
	CO-FINANCED B	
	1	THE WORLD BANK
		IBRD + IDA WORLD BANKOROUP
	CONSULTANT :	
		Alliance Consultants Itd
		Infra-Consult Ltd
		-
	PROJECT :	ORA WATER SUPPLY AND
		ANITATION PROJECT
	-	AK WATER SUPPLY AND ANITATION SYSTEM
	REVISIONS :	
		Date Description
	DRAWING TITLE	:
		RAW WATER MAIN 4+000 - 4+500
	Surveyed by: R.K	
	Drawn by: M.K Designed by:	
	Checked by: J.K.I	
%	Date: Janu	Jary 2023
		YA-RWM-001 Sheet No.:
	1:2000	9 of 13

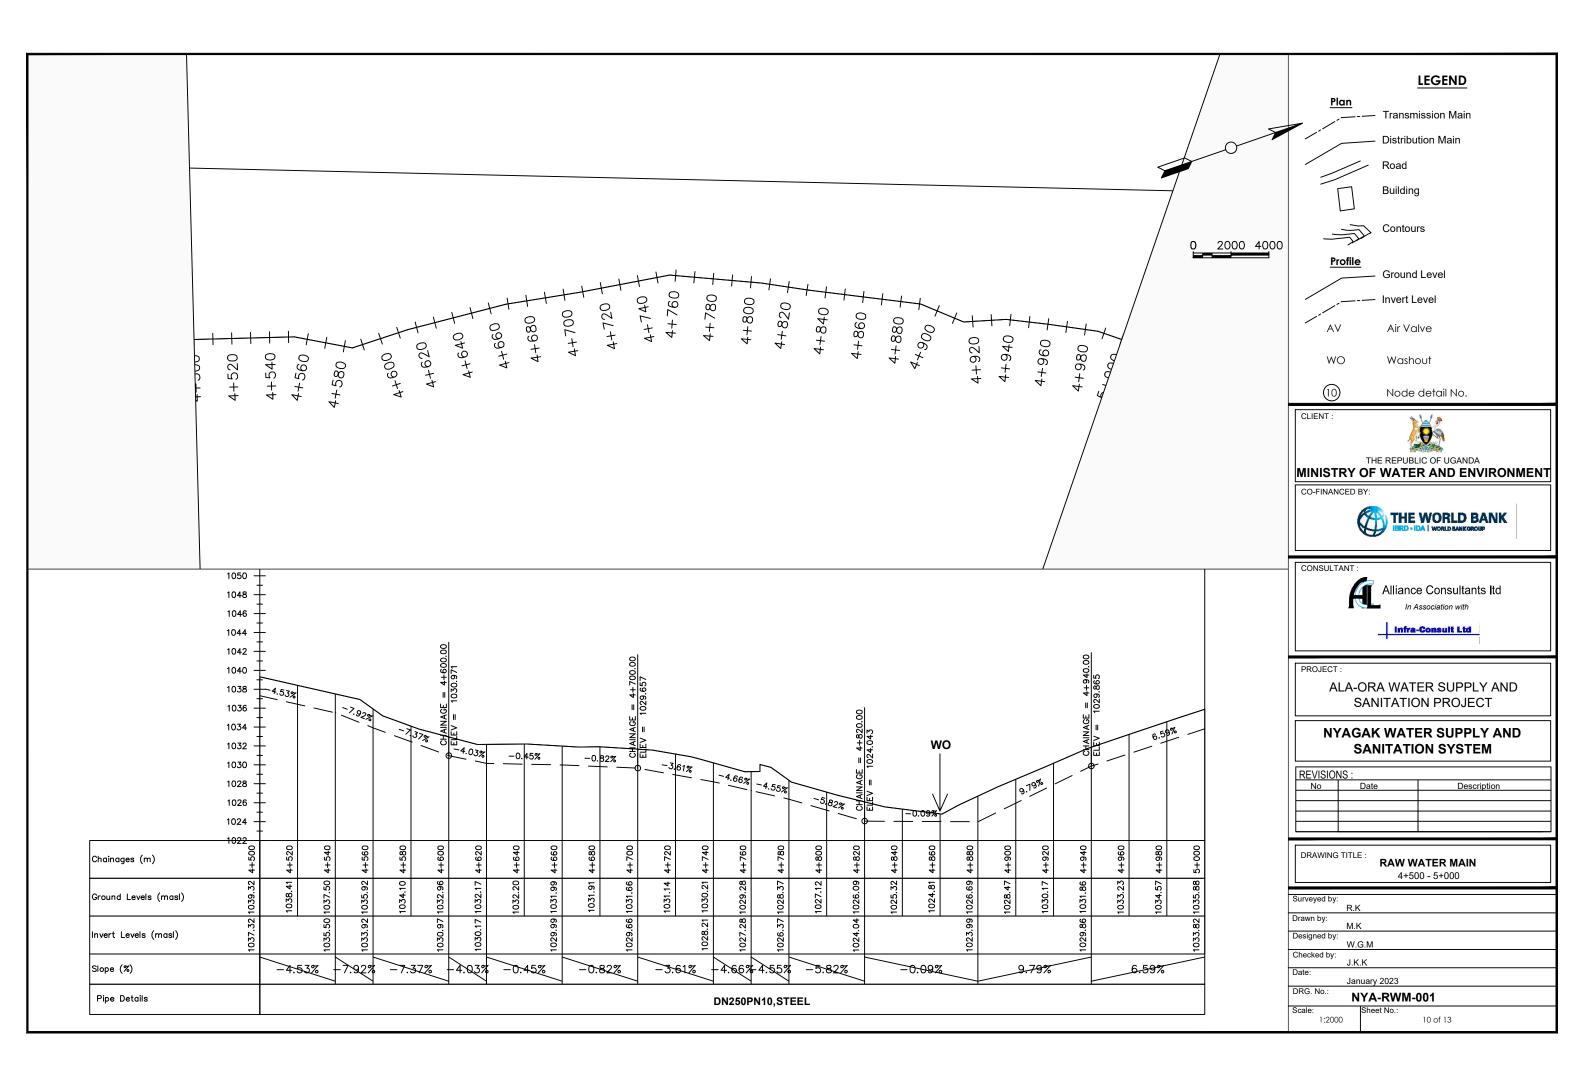

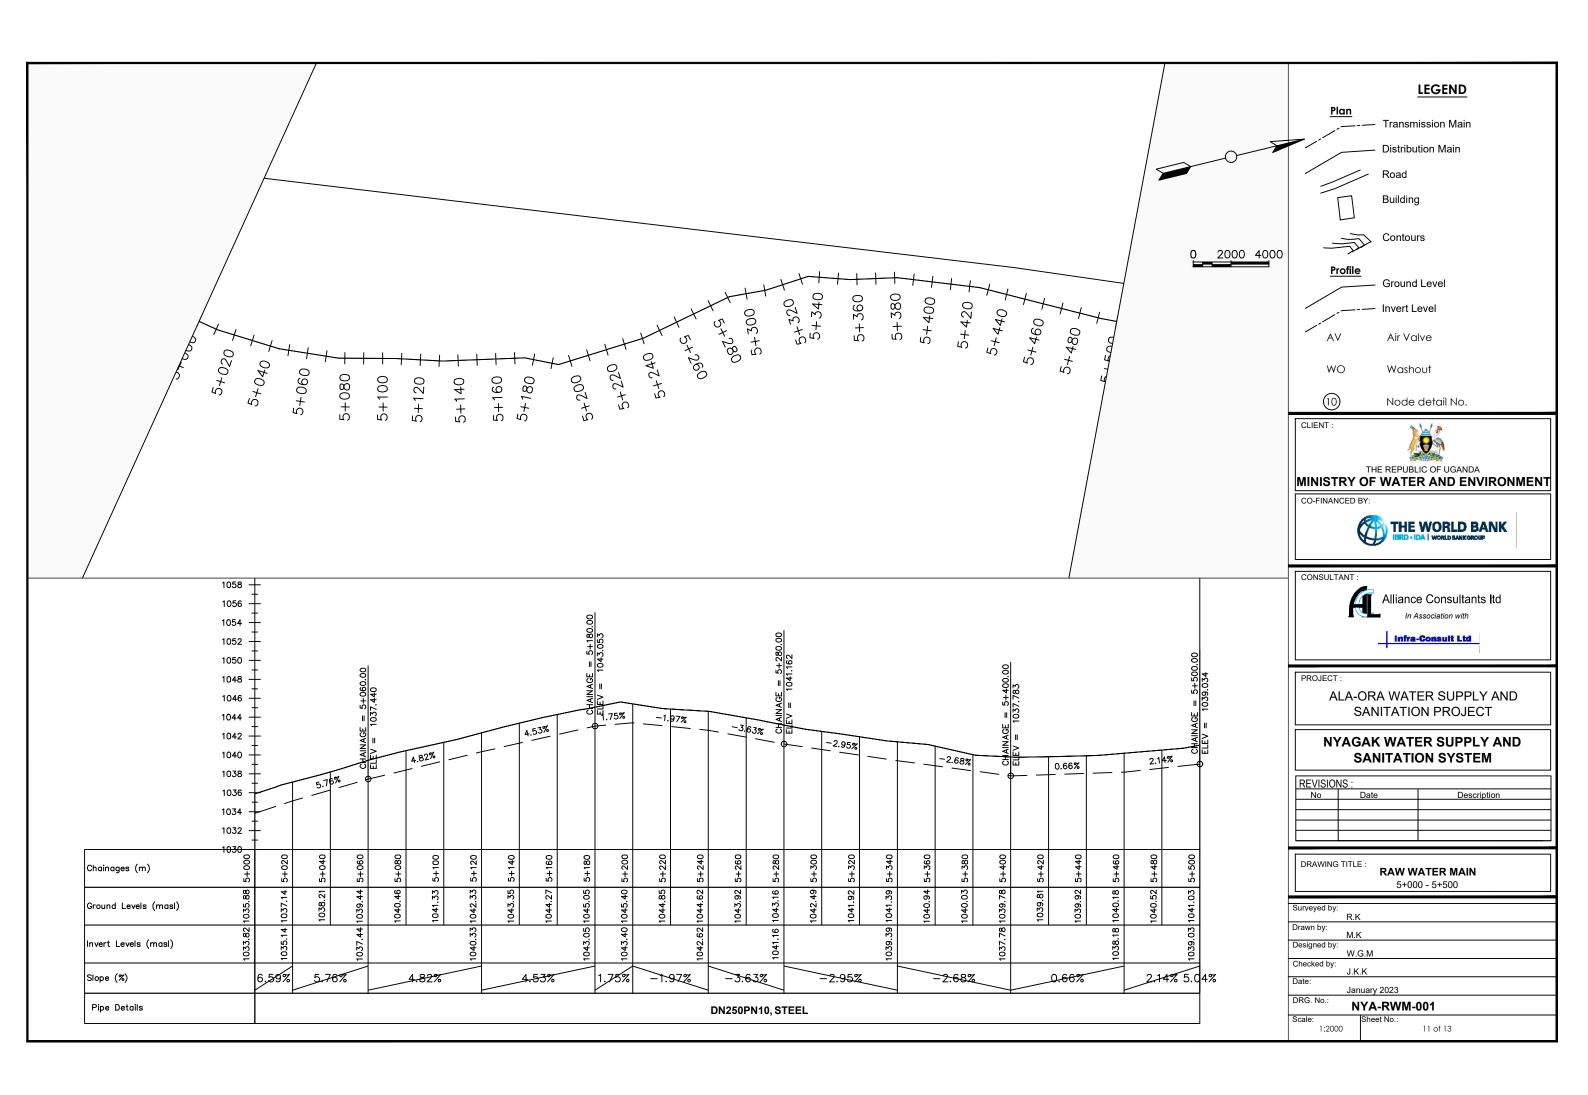

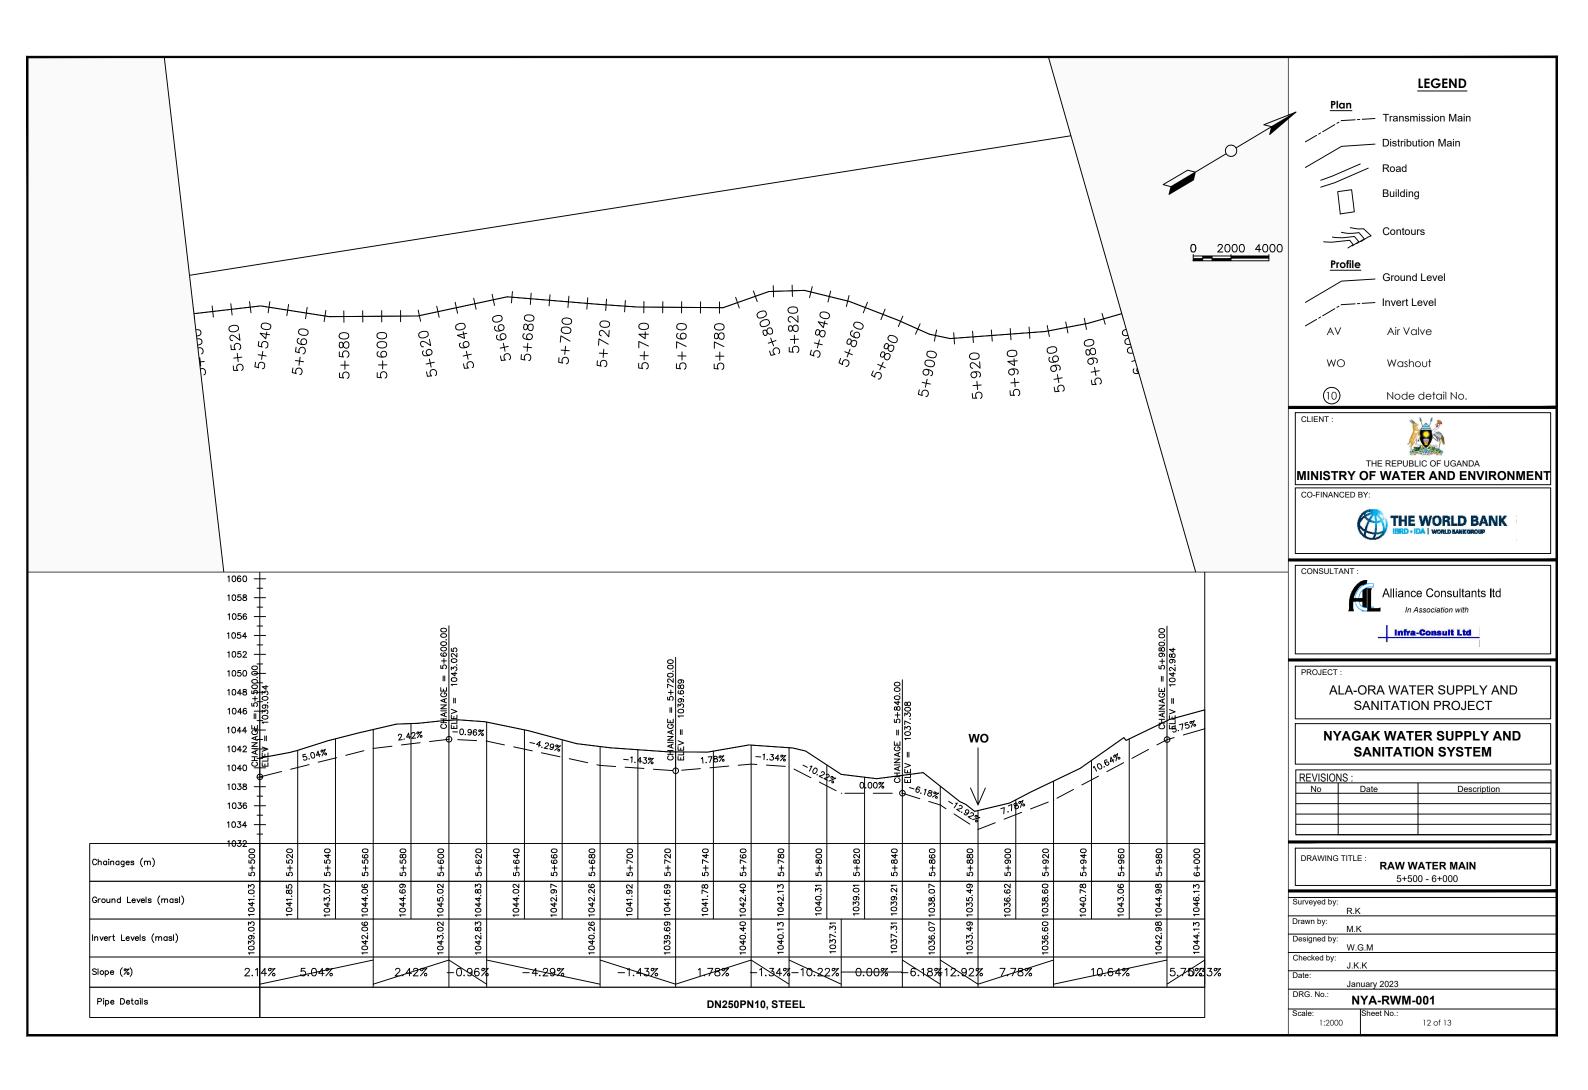


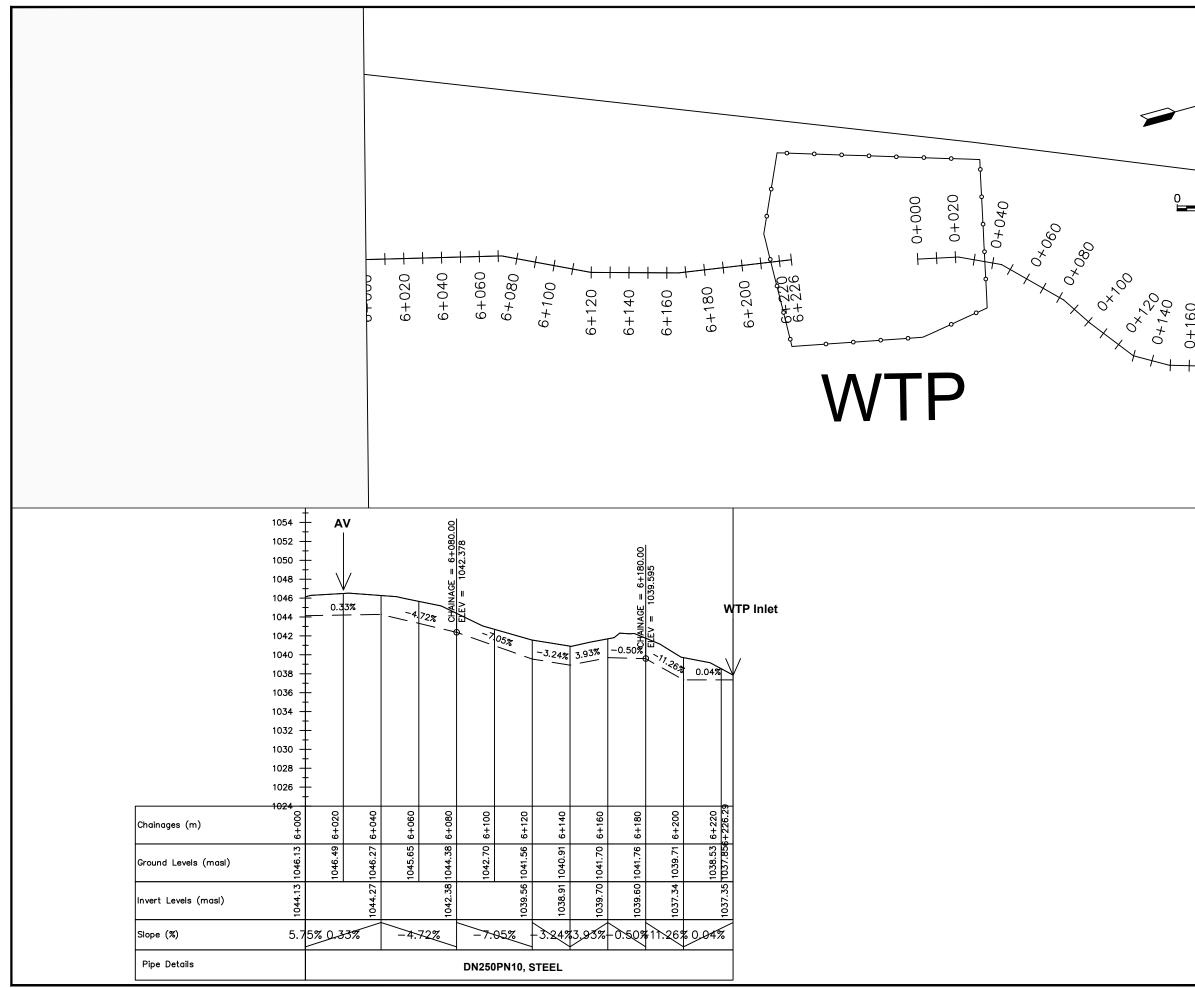

	LEGEND				
	<u>Plan</u>	— Transmission Main			
		— Distribution Main			
_0		- Road			
		Building			
2000 4000	1/h	Contours			
	Profile	Ground Level			
		- Invert Level			
	AV	Air Valve			
0	AV				
0+160 * <i>1</i> 80	WO	Washout			
- 0+16 0+780	(10)	Node detail No.			
++++0	CLIENT :				
		THE REPUBLIC OF UGANDA			
		OF WATER AND ENVIRONMENT			
	CO-FINANCED BY:				
	CONSULTANT :				
	Alliance Consultants Itd				
		In Association with			
	PROJECT : ALA-ORA WATER SUPPLY AND SANITATION PROJECT				
		AK WATER SUPPLY AND			
	-	AR WATER SUPPLY AND ANITATION SYSTEM			
	REVISIONS :	Date Description			
		Date Description			
	DRAWING TITLE				
		6+000 - 6+226.29			
	Surveyed by: R.K Drawn by:				
	Designed by: W.C				
	Checked by: J.K Date:				
	Jan DRG No	uary 2023 YA-RWM-001			
	Scale: 1:2000	Sheet No.: 13 of 13			


RAW WATER - WTP	DWG No CHAINAGE					
1	NYA-RWM-001 - CH 0+500					
	DUPVC PN10 - PN10 - DN250UPVC PN10	SCHEDULE OF PIPEWORK & FITTINGS				
DNSOC		ITEM	DESCRIPTION	SIZE	QTY.	PN
		1	DI FLANGED ADAPTOR (MAXI TYPE OR SIMILAR)	300	1	10
		2	FLANGED TAPER	300/250	1	10
		3	DI FLANGED ADAPTOR (MAXI TYPE OR SIMILAR)	250	1	10


	LEGEND
CLIENT :	
	LIC OF UGANDA
	R AND ENVIRONMENT
CO-FINANCED BY:	
MAN THE	WORLD BANK
CONSULTANT :	
Allianc	e Consultants Itd
100	Association with
1	
	-Consult Ltd
PROJECT :	
11	ER SUPPLY AND
SANITATIO	ON PROJECT
	ER SUPPLY AND
	ON SYSTEM
REVISIONS :	Description
No Date	Description
DRAWING TITLE :	
	AIN NODES DETAILS
Surveyed by:	
R.K Drawn by:	
Drawn by: A.K Designed by:	
Drawn by: A.K Designed by: W.G.M	
Drawn by: A.K Designed by:	
Drawn by: Designed by: W.G.M Checked by: J.K.K Date: January 2023	
Drawn by: Designed by: W.G.M Checked by: J.K.K Date:	D-001

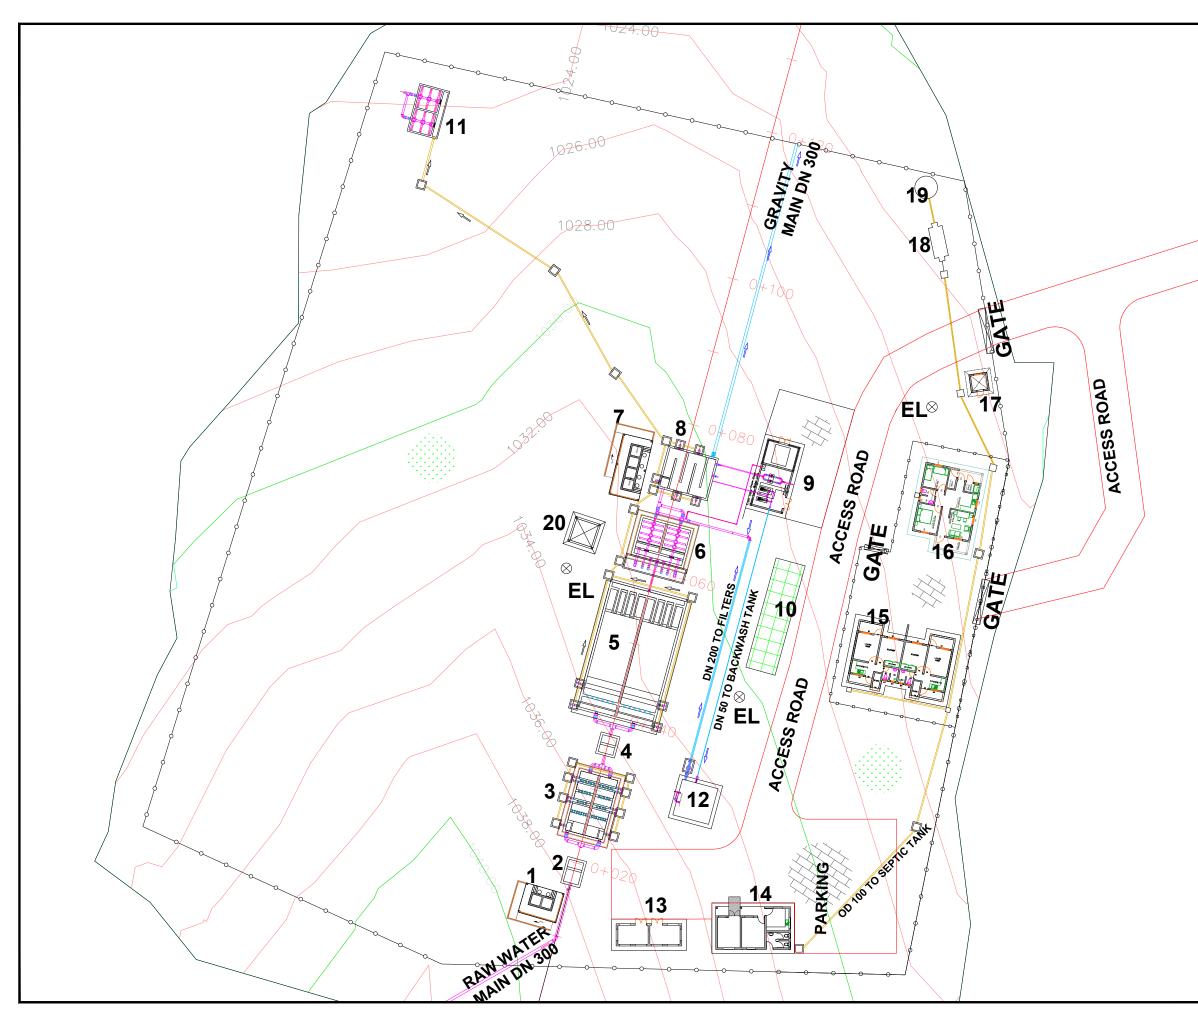



1- ALUM DOSING HOU 2- INLET CHAMBER 3- FLOCCULATOR 4-DROP CHAMBER 5- SEDIMENTATION TAI 6- RAPID SAND FILTERS 7- CHLORINE DOSING 8-CLEAR WATER TANK 9- PUMP HOUSE 10- SOLAR ARRAY 11- SLUDGE DRYING B 12- BACK WASH TANK 13- CHEMICAL STORE 14- ADMINISTRATION E 15-ATTENDANTS' HOUS 16- SUPERINTENDENT'S 17- GUARD STATION 18- SEPTIC TANK 19- SOAK PIT 20- SAND STORAGE EL- ELECTRIC LAMP	NK S HOUSE EDS BUILDING SES				
CLIENT : THE REPUBLIC MINISTRY OF WATER DIRECTORATE OF WA	AND ENVIRONMENT				
CONSULTANT :					
ALLIANCE CONSULTANTS LTD CONSULTING ENGINEERS In Association with Infra-Consult Ltd P.O.BOX 33975 KAMPALA Email: allianceconsultants/td@gmail.com					
PROJECT : CONSTRUCTION OF ALA-ORA WATER SUPPLY AND SANITATION SYSTEM					
NYAGAK W	ATER SCHEME				
REVISIONS : No Date	Description				
DRAWING TITLE : TREATMENT PLANT GENERAL LAYOUT					
Surveyed by: R.K Drawn by: J.B Designed by: W.G.M					
Checked by: J.K.K					
Date: January	2023				
DRG. No.: NYA/WTP-001A					
NYA/WIP-00	01A				
DRG. No.: NYA/WTP-00 Scale: Sheet No.: 2:1	01A 1 of 1				



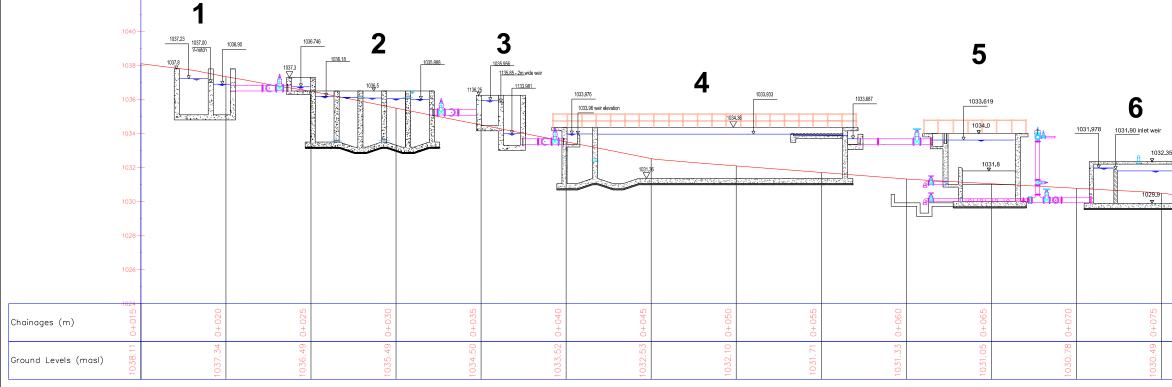


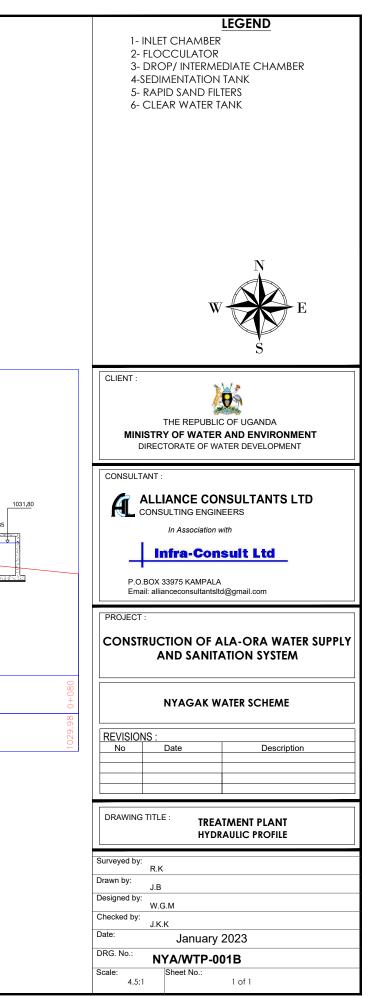


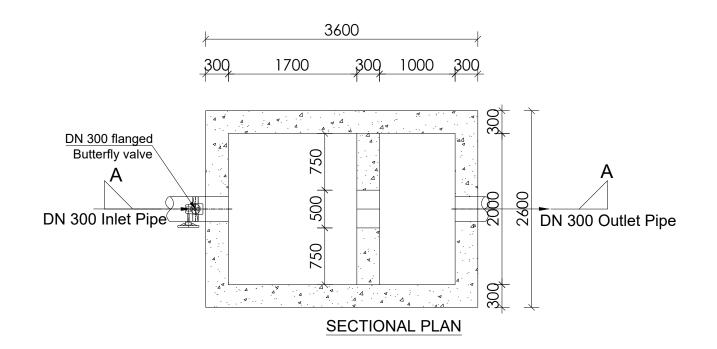


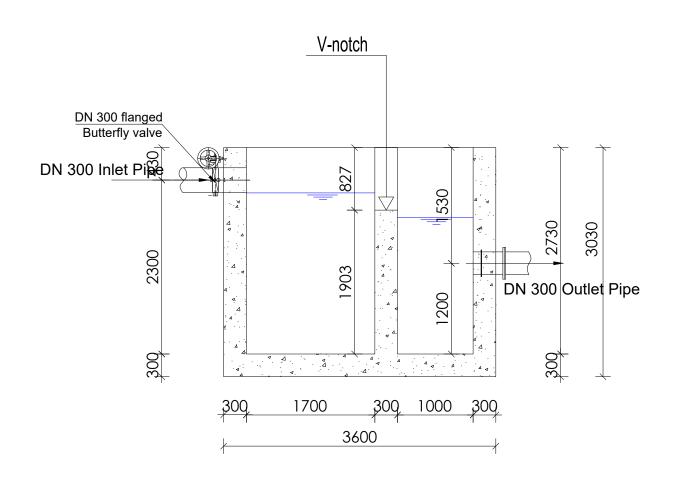



LEGEND	
W E	
CLIENT : THE REPUBLIC OF UGANDA MINISTRY OF WATER AND ENVIRONMEN CO-FINANCED BY: THE WORLD BANK IERD-IDA WORLD BANK IERD-IDA WORLD BANK	11
CONSULTANT : Alliance Consultants Itd In Association with	
PROJECT : ALA-ORA WATER SUPPLY AND SANITATION PROJECT	
NYAGAK WATER SUPPLY AND SANITATION SYSTEM	
No Date Description	
DRAWING TITLE : INLET STRUCTURE	
Surveyed by: R.K Drawn by: A.K Designed by: W.G.M Checked by: V.G.M	
Checked by: J.K.K Date: January 2023 DRG. No.: NYA-WTP-002 Scale: Sheet No.: 1:50 1 of 1	

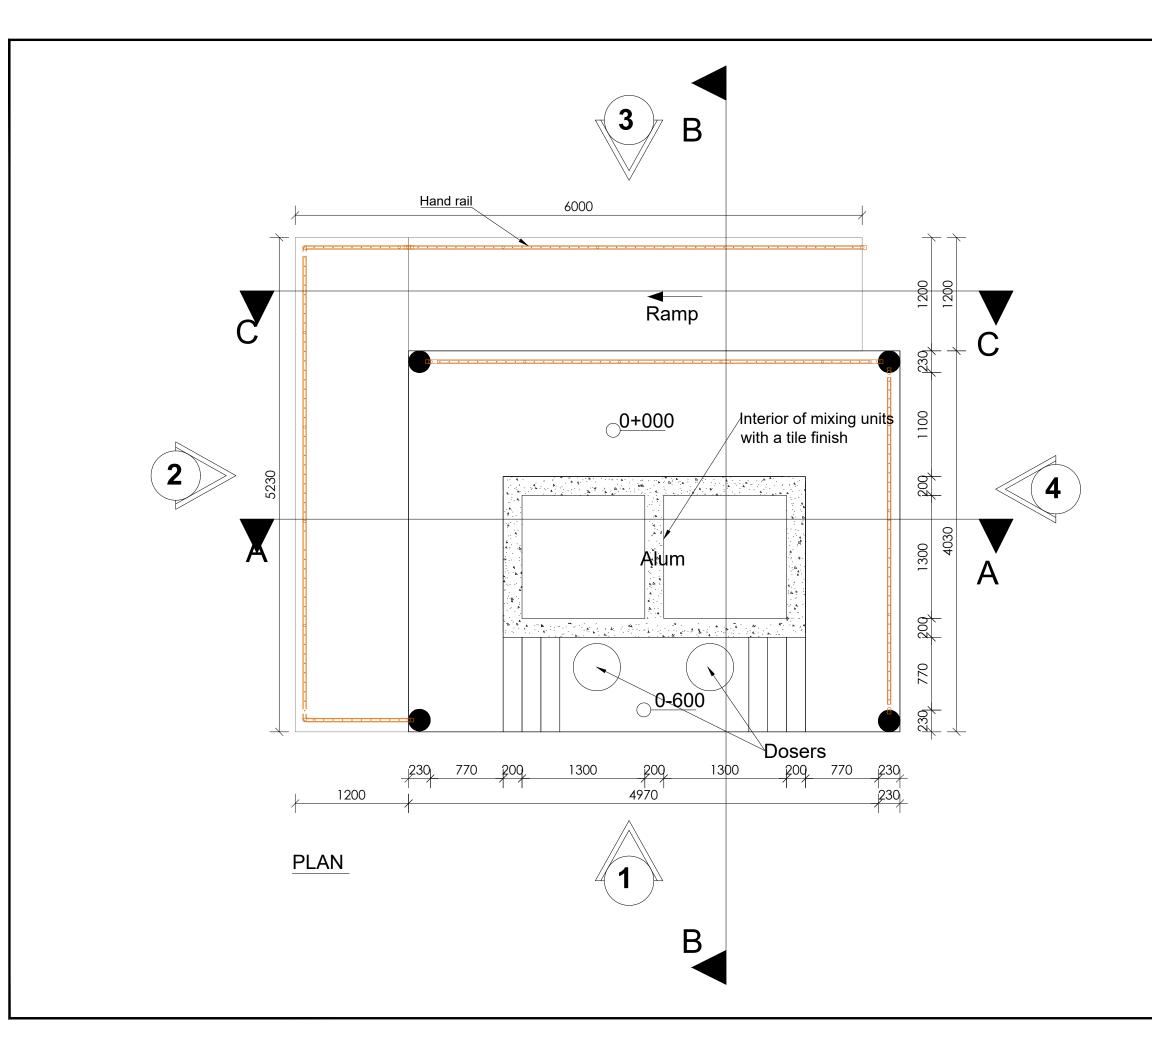


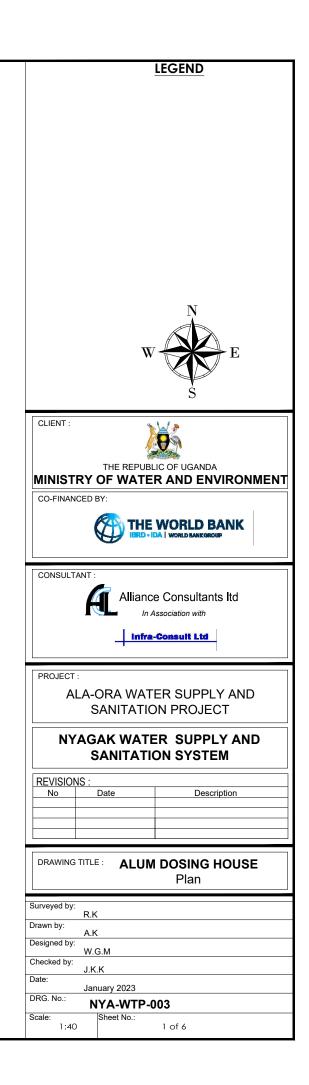


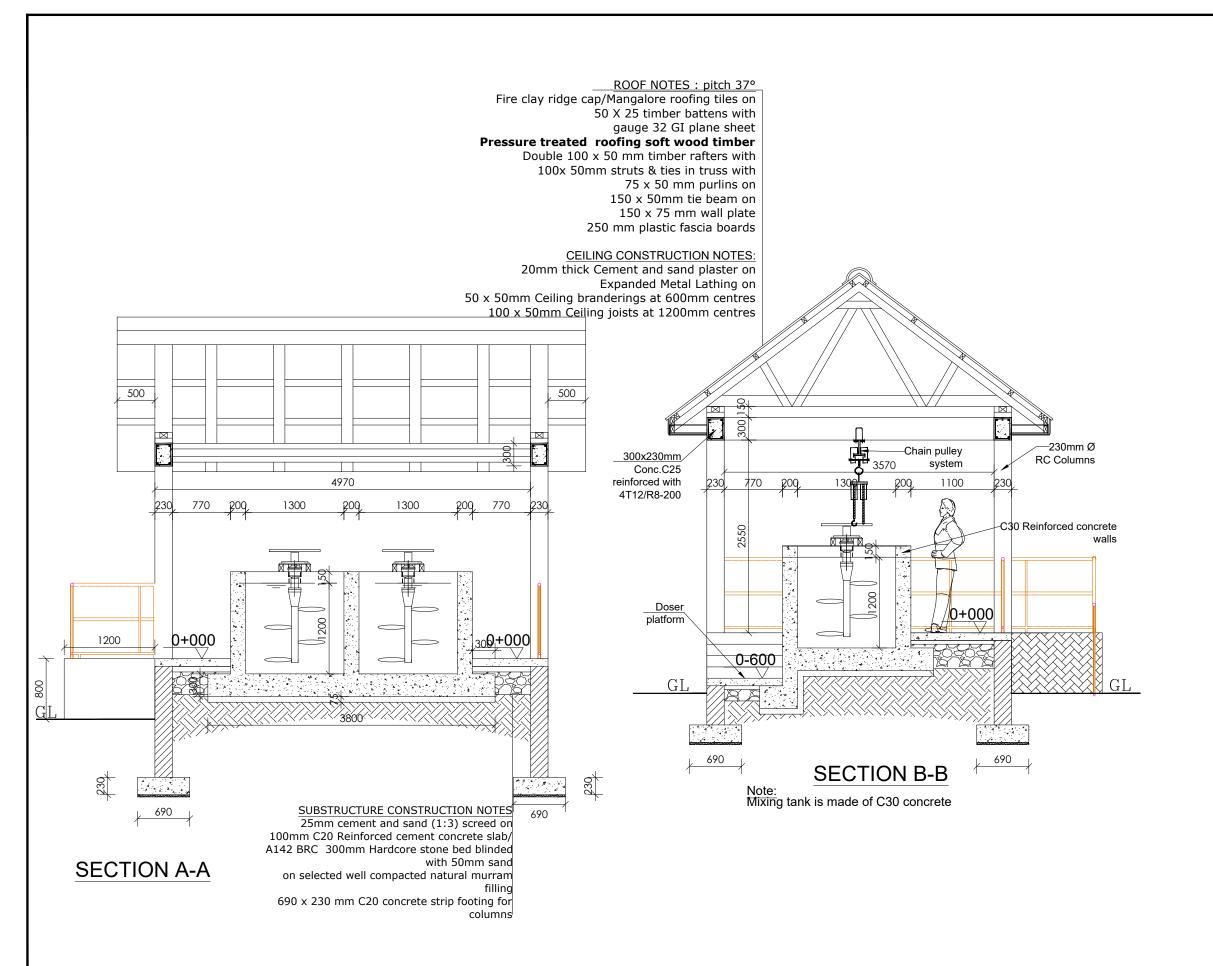

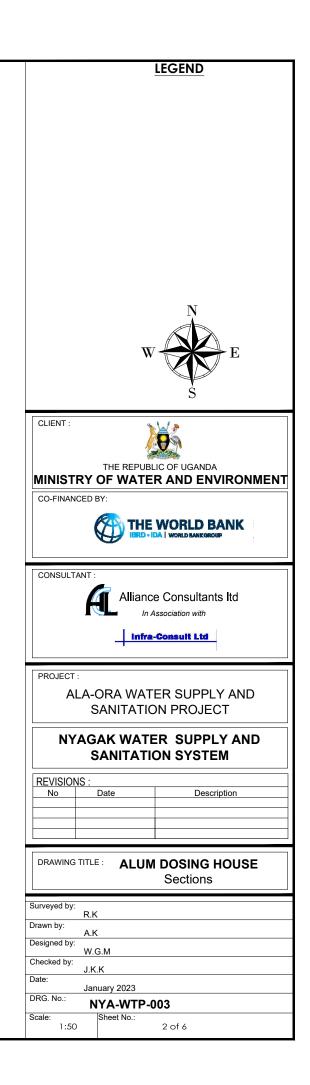


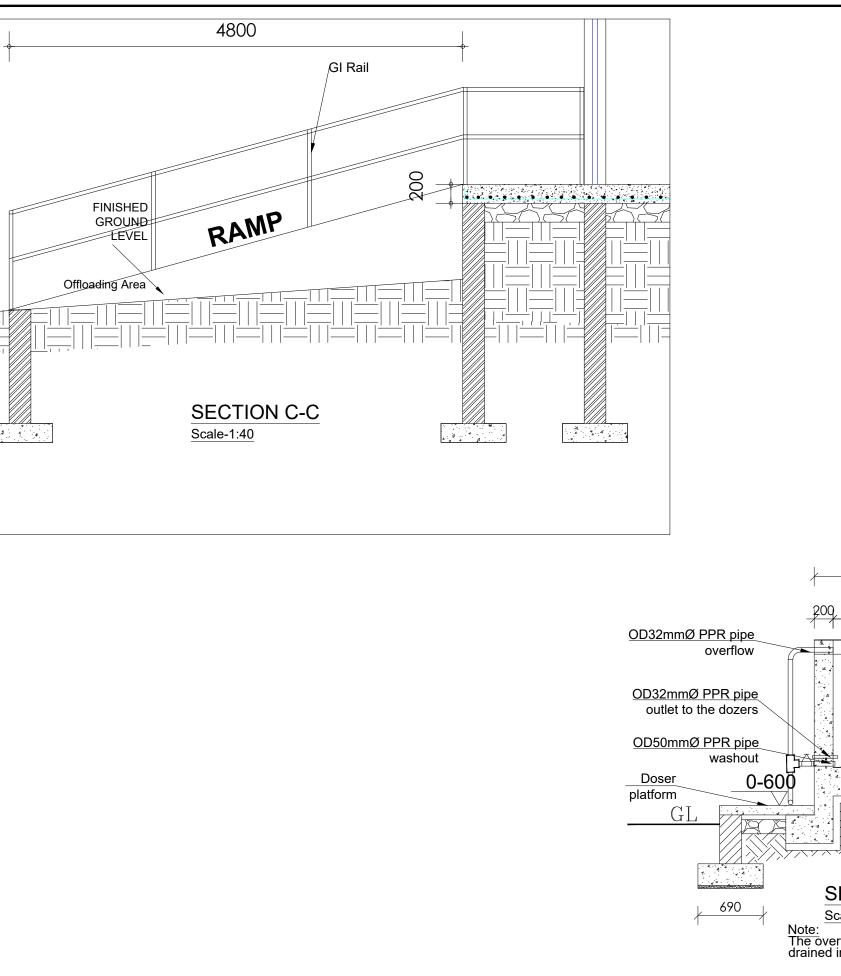


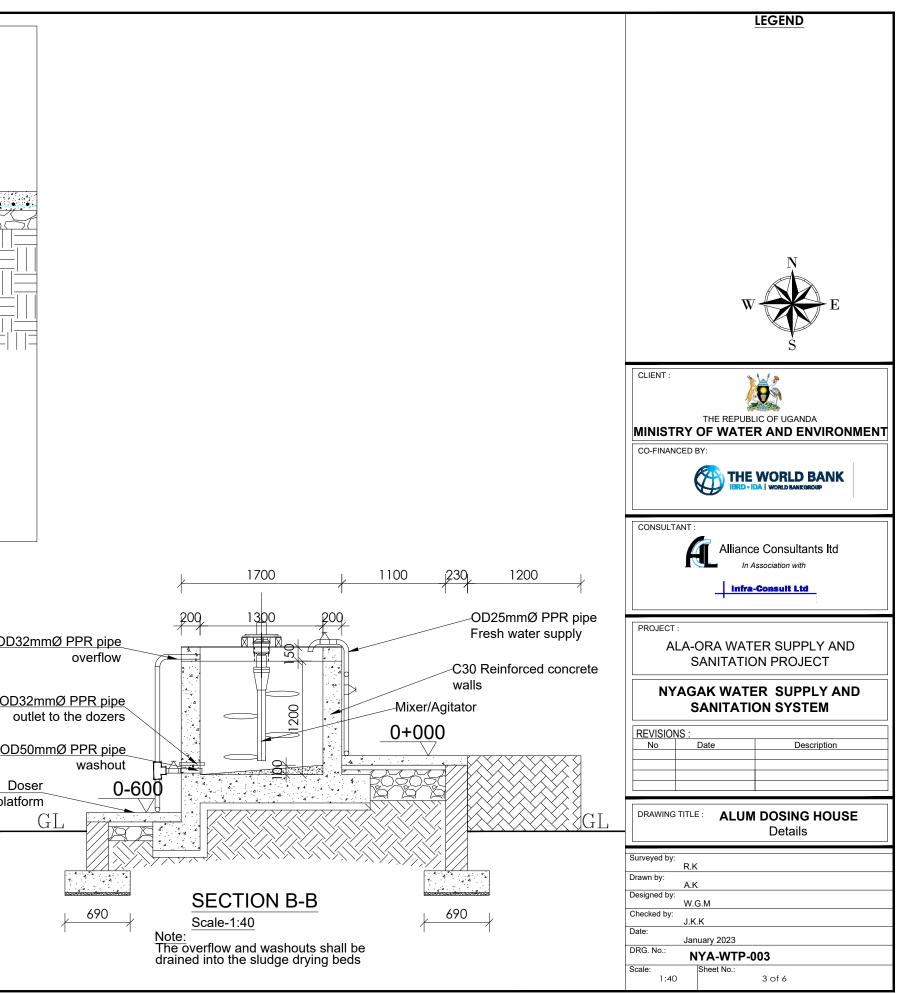

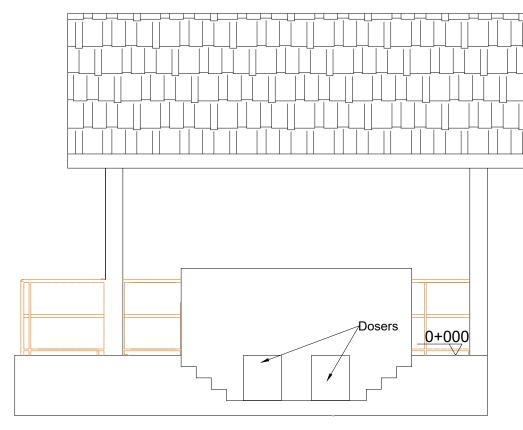



ELEVATION 1

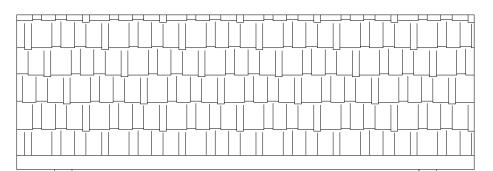


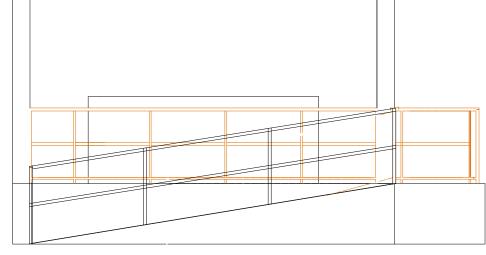



ELEVATION 3

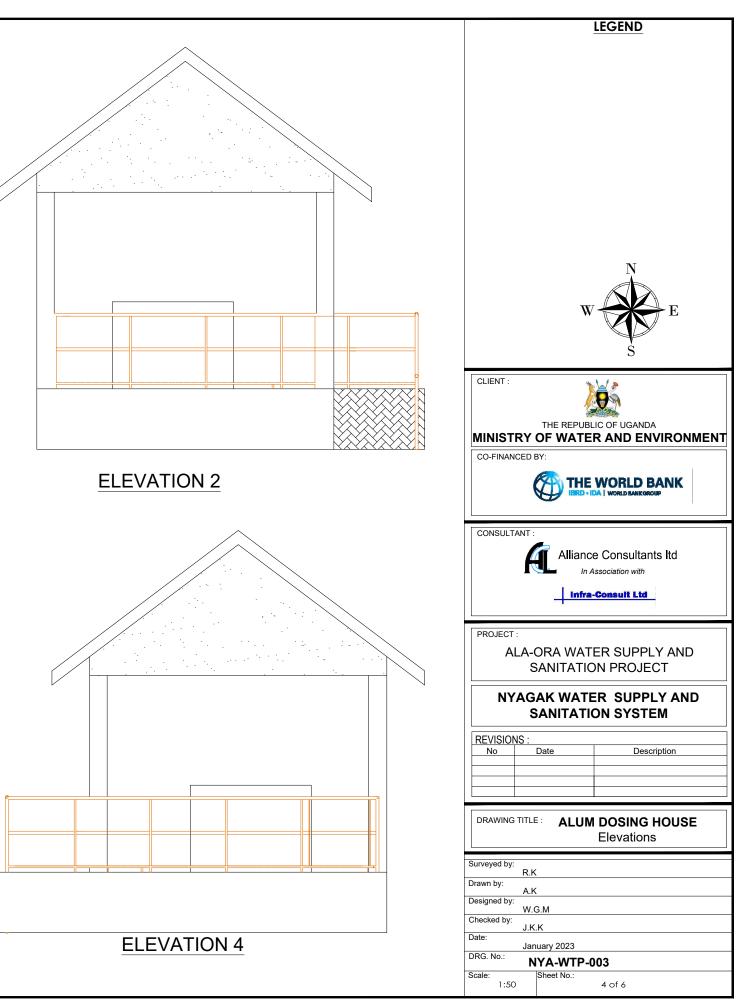


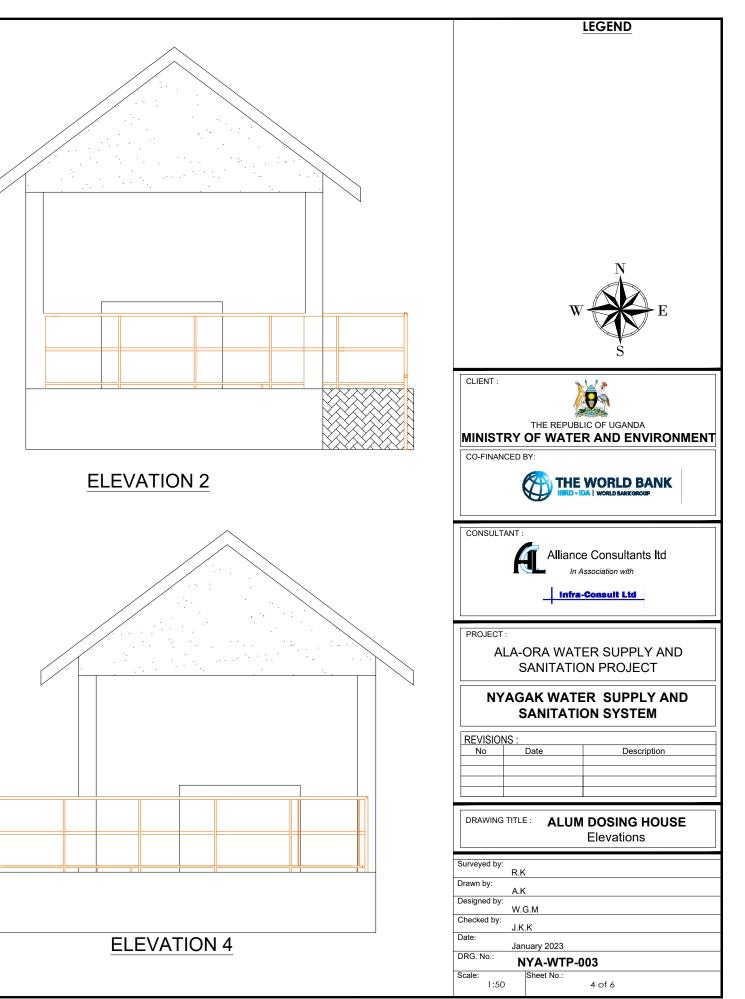

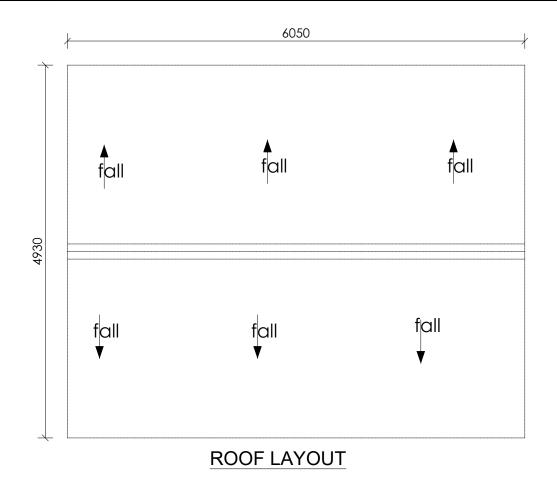

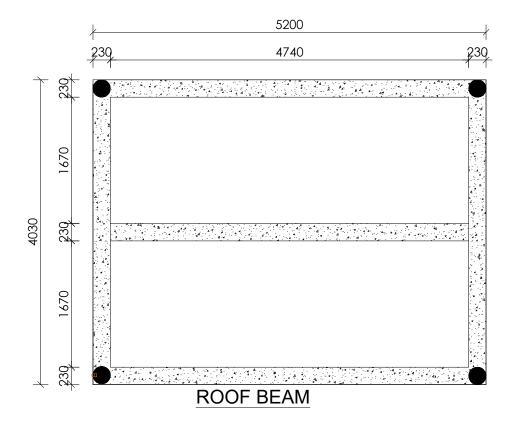


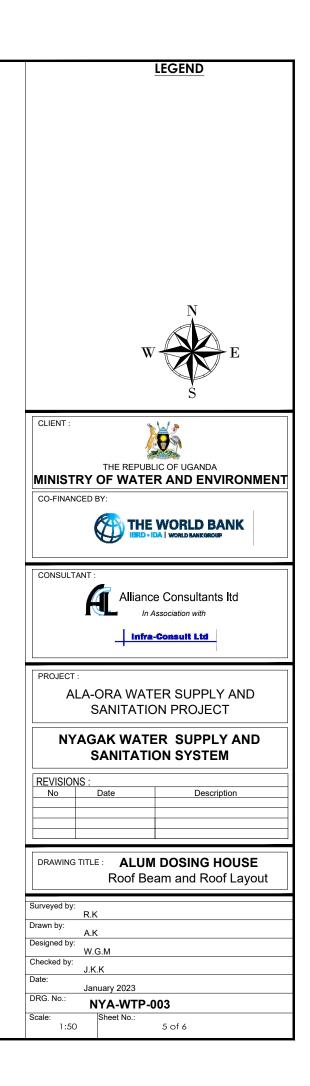


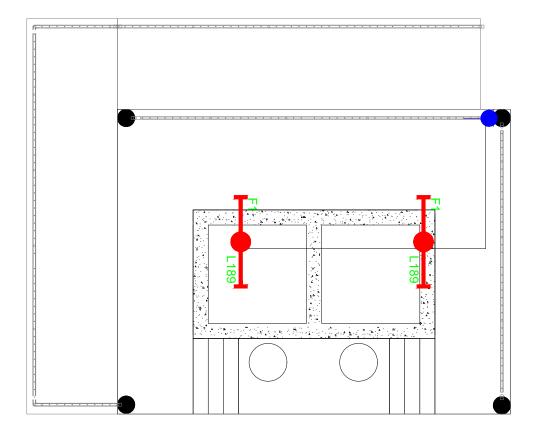


SYMBOL	DESCRIPTION				
F1	1200mm 18W LED batten with a removable LED engine. IP20 As Thorn PopPack LED. or equal approved. (Light Type F1)				
©	Pedant lighting fitting comprising ceiling Rose 300mm 3x1.5m flexible copper cable lamp holder and 6W LED Lamp				
	Pedant lighting fitting comprising ceiling Rose 300mm 3x1.5mm ² flexible copper cable lamp holder and 6WLED Lamp				
B	Pedant lighting fitting comprising ceiling Rose 300mm 3x1.5mm ² flexible copper cable lamp holder and 6W LED Lamp				
	wall mounted light				
s ²	Socket outlet on Wall				
CU	Consumer's Unit				
	One Gang 1way Switch				
••	Two Gang 1way Switch				
••••	Three Gang 1way Switch				


	LEGEND
	Ν
	W
	W V E
nm ²	5
	CLIENT :
—	
	THE REPUBLIC OF UGANDA
$\overline{m^2}$	MINISTRY OF WATER AND ENVIRONMENT
	CO-FINANCED BY:
	CONSULTANT :
	Alliance Consultants Itd
	In Association with
	Infra-Consult Ltd
	ALA-ORA WATER SUPPLY AND SANITATION PROJECT
]	NYAGAK WATER SUPPLY AND
	SANITATION SYSTEM
	REVISIONS :
	No Date Description
	DRAWING TITLE : ALUM DOSING HOUSE
	Electrical Layout
	Surveyed by:
	Drawn by:
	P.K Designed by:
	P.K
	Checked by:
	S.C.D Date:
	S.C.D Date: January 2023
	S.C.D Date: January 2023

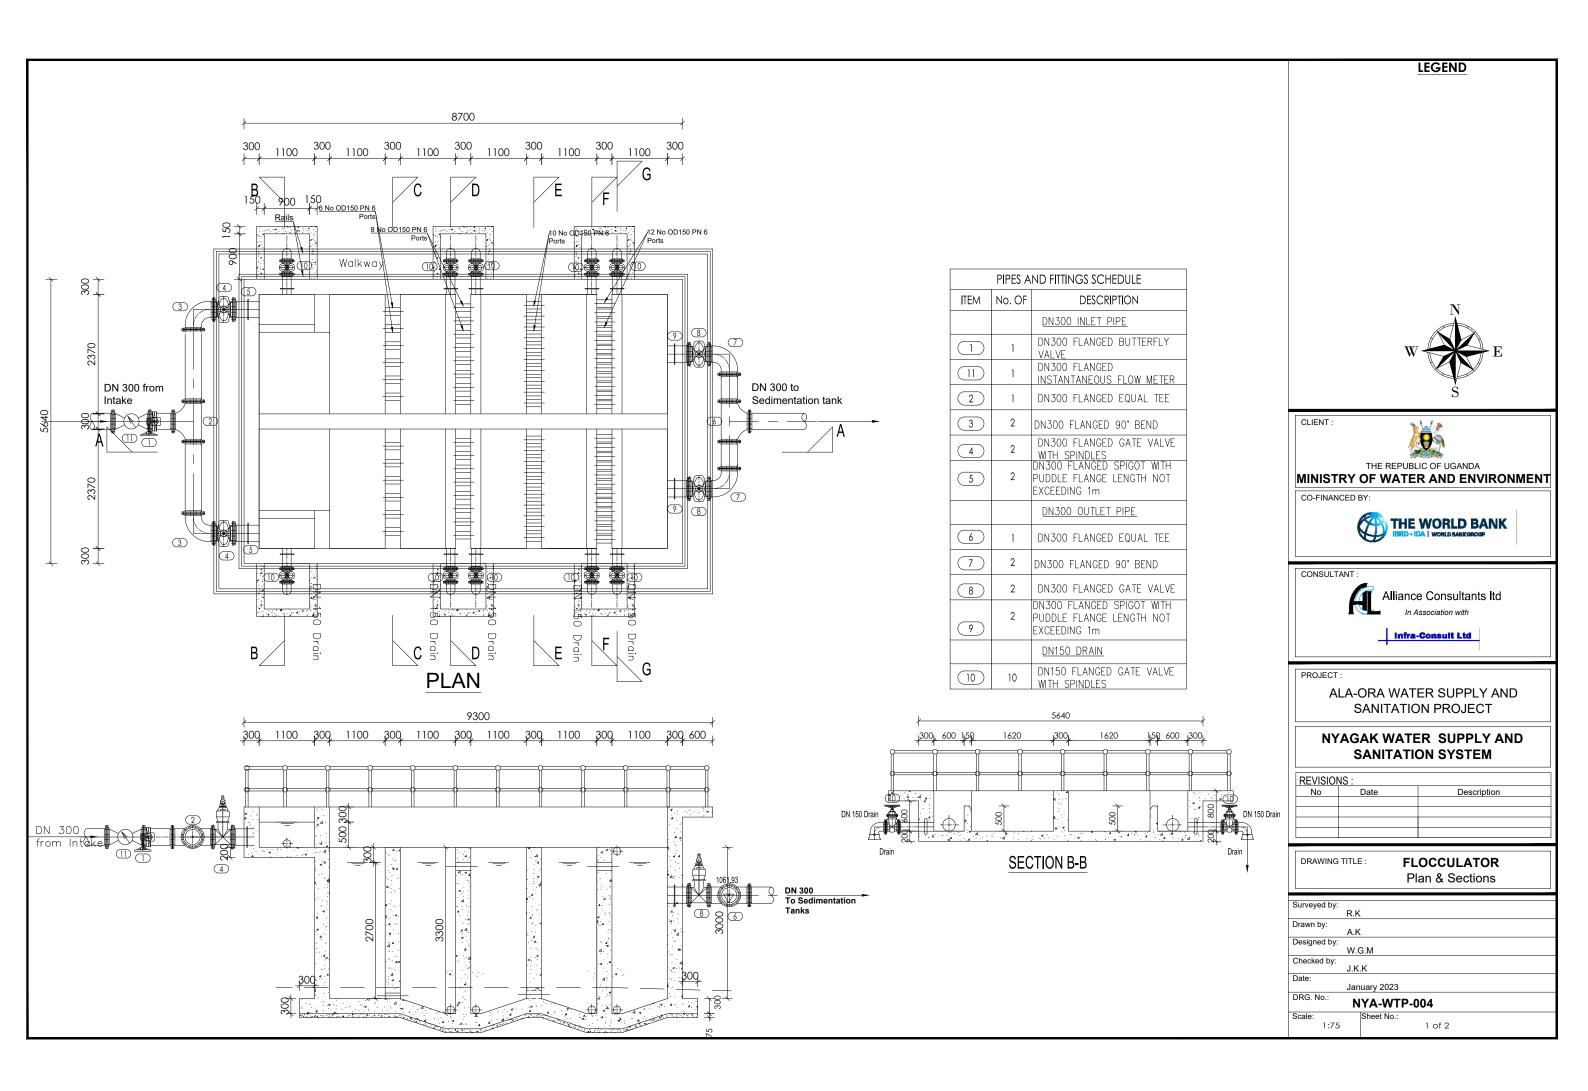


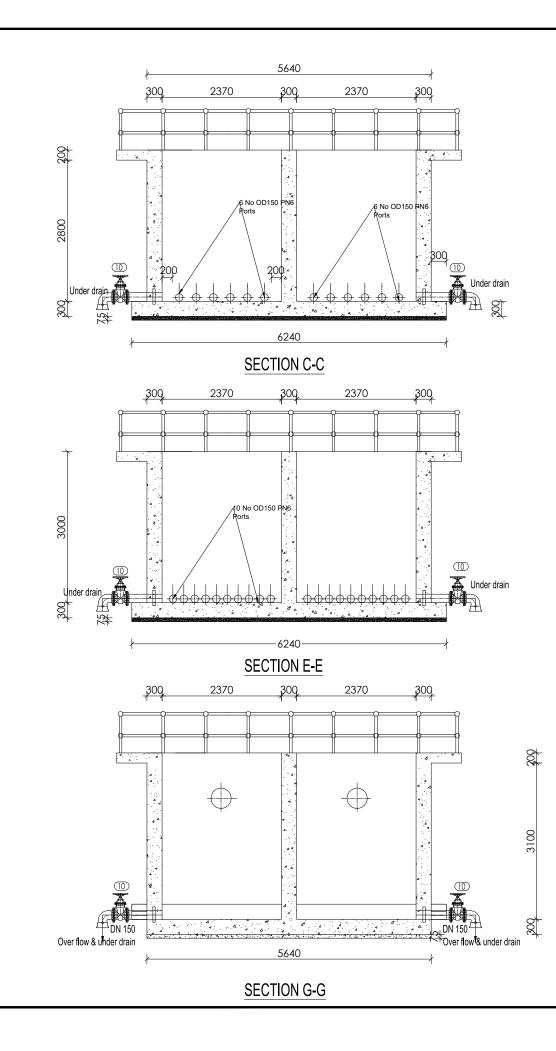


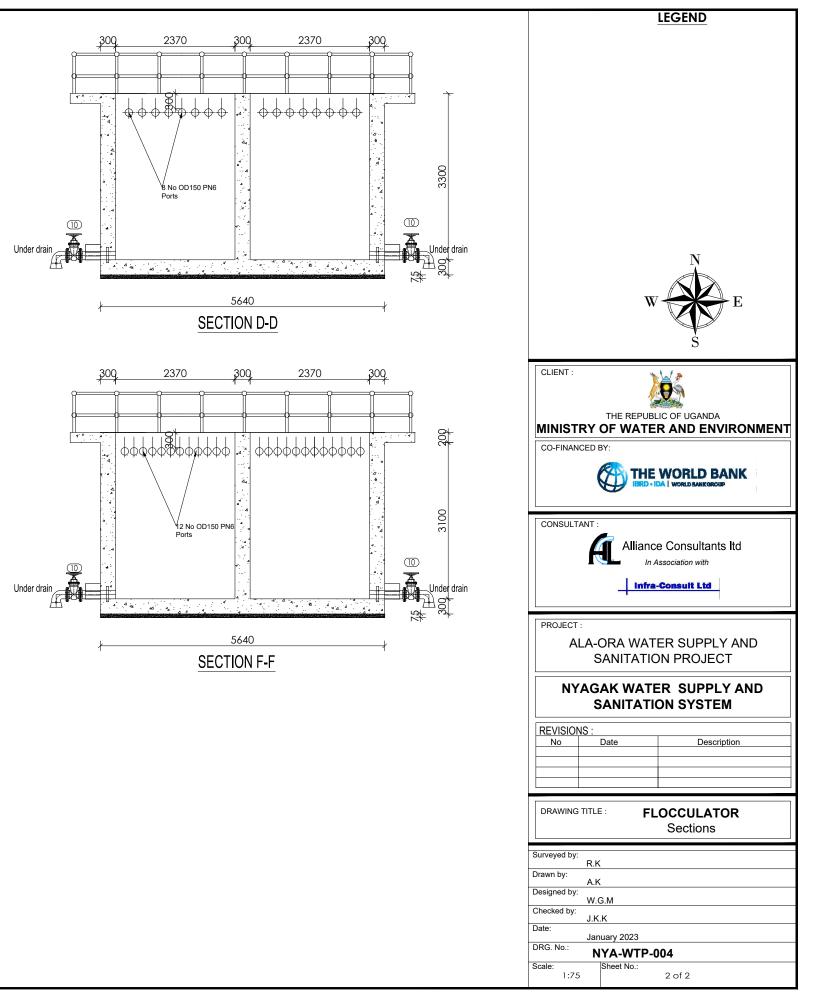





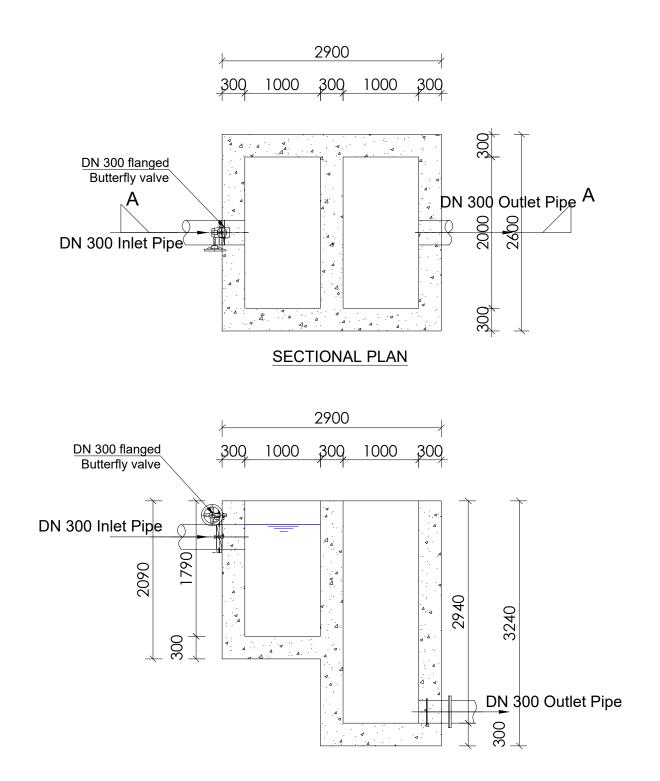

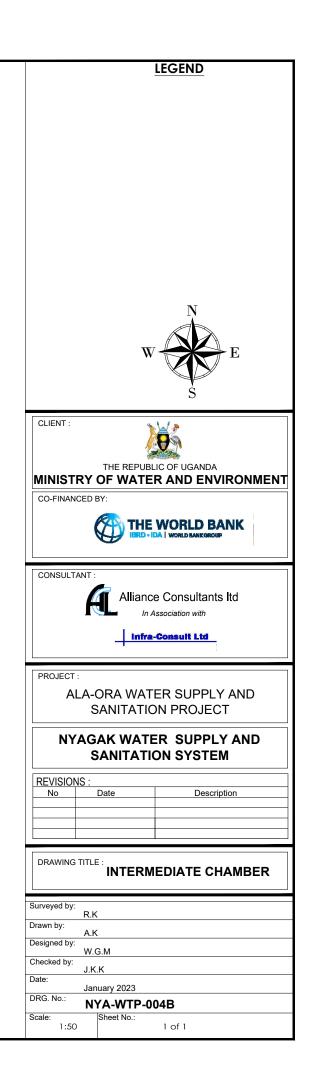


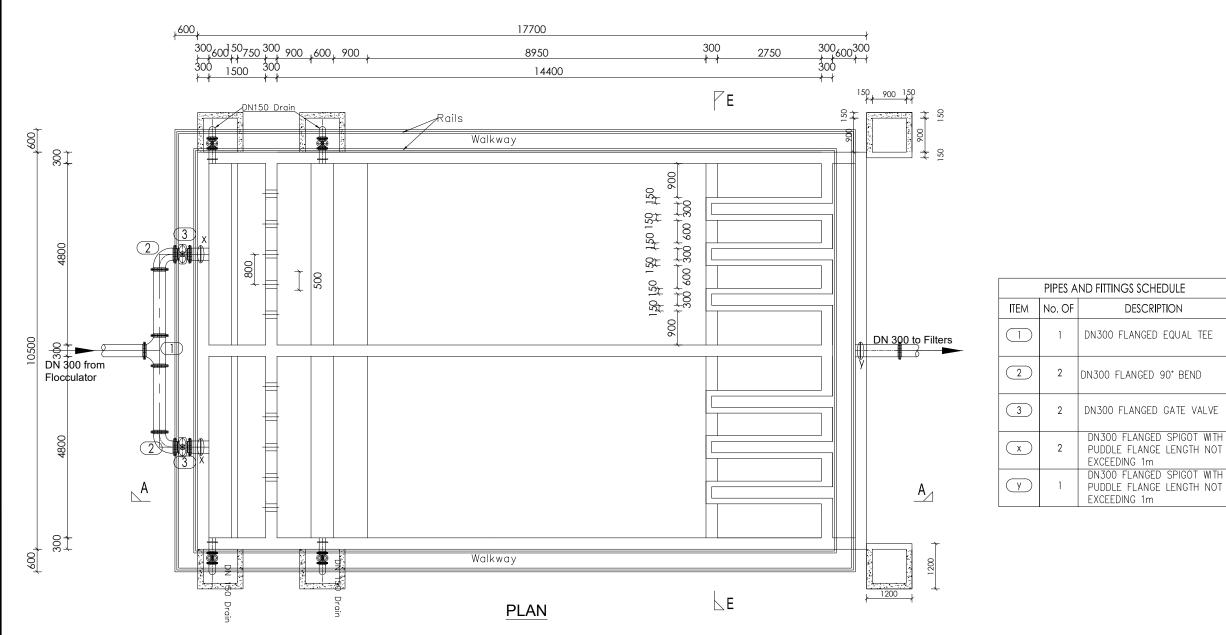

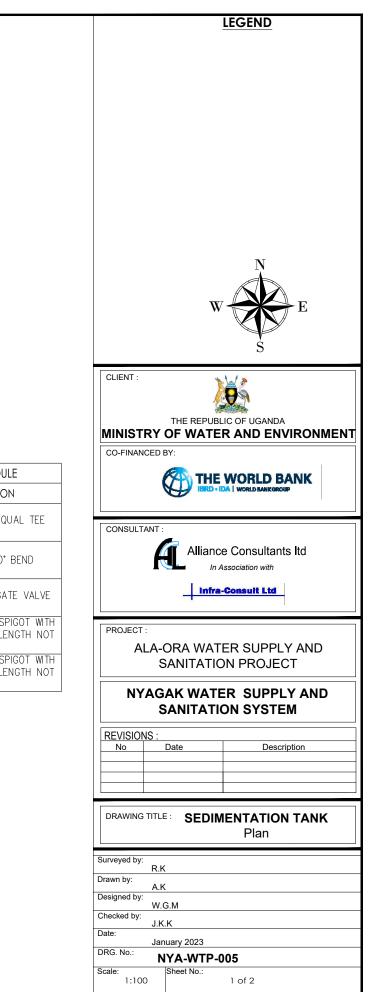


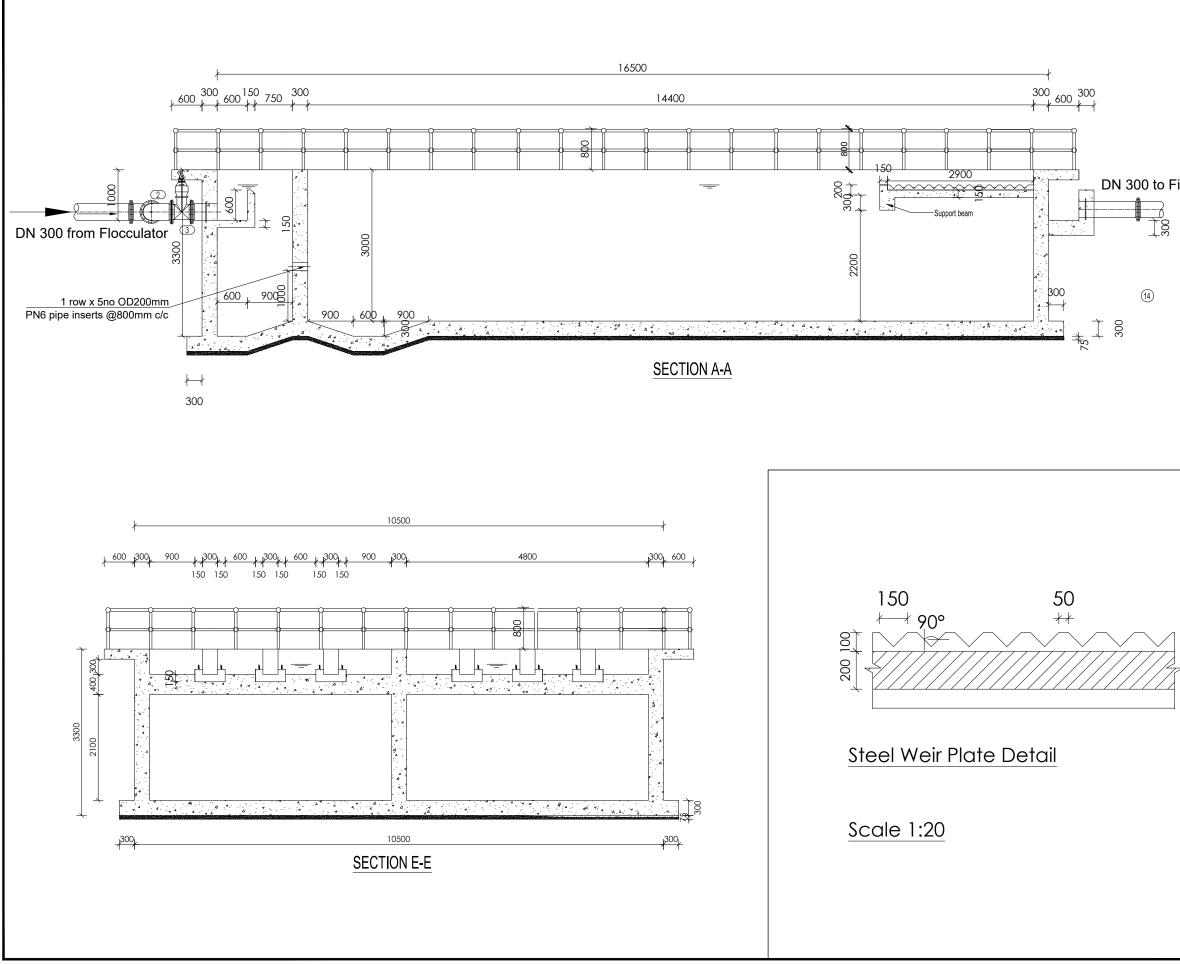



	LEGEND		
ilters			
	Ν		
	WEE		
	S		
	5		
	CLIENT :		
	THE REPUBLIC OF UGANDA		
	MINISTRY OF WATER AND ENVIRONMENT		
	CO-FINANCED BY:		
	IBRD + IDA WORLD BANKGROUP		
	CONSULTANT :		
	Alliance Consultants Itd		
	Infra-Consuit Ltd		
*	ALA-ORA WATER SUPPLY AND SANITATION PROJECT		
75 + +			
7	NYAGAK WATER SUPPLY AND		
	SANITATION SYSTEM		
	REVISIONS : No Date Description		
	No Date Description		
	DRAWING TITLE : SEDIMENTATION TANK		
	Sections		
	Surveyed by:		
	R.K Drawn by:		
	A.K Designed by:		
	W.G.M Checked by: J.K.K		
	J.K.K Date: January 2023		
	DRG. No.: NYA-WTP-005		
	Scale: Sheet No.: 1:75 2 of 2		

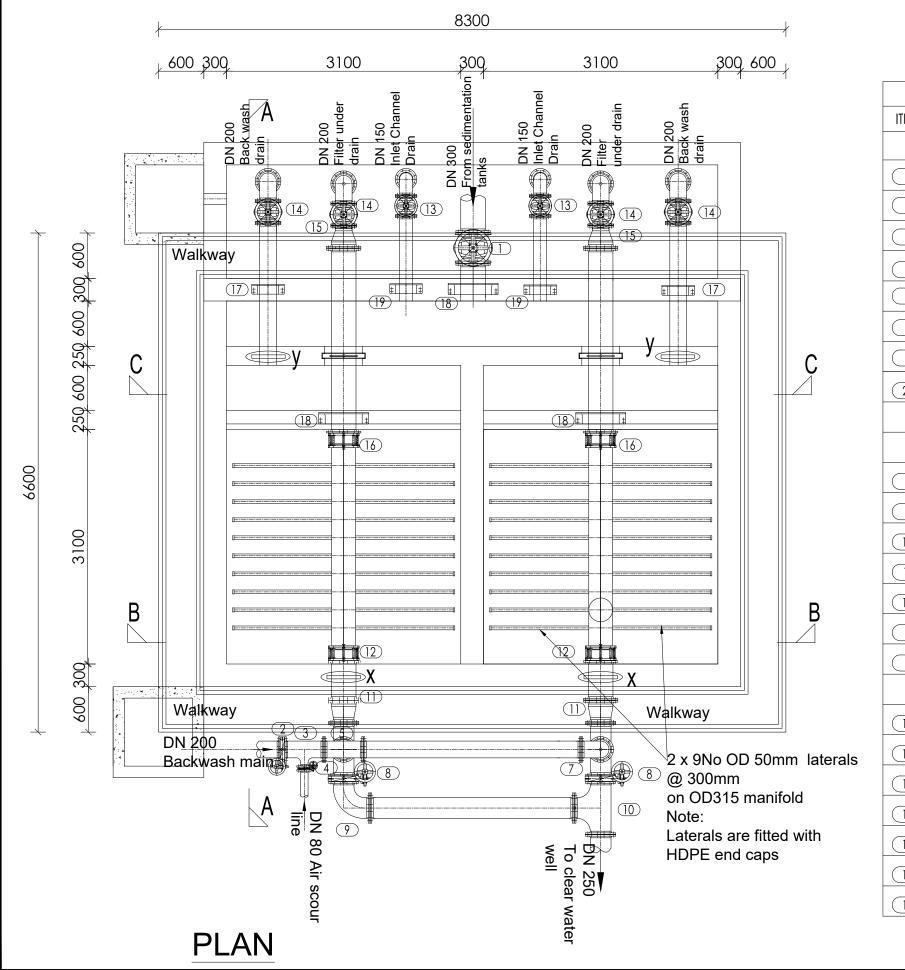


ITEM	No. OF	FITTINGS SCHEDULE (FILTERS)
	NO. OF	
\bigcirc	1	DN300 FLANGED GATE VALVE
2	3	DN200 FLANGED BUTTERFLY VALVE
3	1	DN200 x 80 FLANGED TEE
4	1	DN80 FLANGED BUTTERFLY VALVE
5	1	DN200 FLANGED EQUAL TEE
6	2	DN250 x 200 FLANGED TEE
7	1	DN200 FLANGED 90° BEND
20	2	DN200 FLANGED GATE VALVE
		OUTLET
8	2	DN250 FLANGED BUTTERFLY VALVE
9	1	DN250 FLANGED 90° BEND
10	1	DN250 FLANGED EQUAL TEE
$\bigcirc 11 \bigcirc$	1	DN300 / 250 FLANGED TAPERS
12	1	DN300/0D315 COUPLING
X	2	DN300 FLANGED & PUDDLED PIPE
У	2	DN200 FLANGED & PUDDLED PIPE
		DRAINS
13	2	DN150 FLANGED GATE VALVE
14	4	DN200 FLANGED GATE VALVE
15	2	DN300/DN200 FLANGED FLAT REDUCER
16	1	DN300/0D315 COUPLING
17	2	DN200 FLANGED SPIGOT PIPE WITH PUDDLE FLANGE
18	3	DN350 FLANGED SPIGOT PIPE WITH PUDDLE FLANGE
(19)	2	DN150 FLANGED SPIGOT PIPE WITH PUDDLE FLANGE

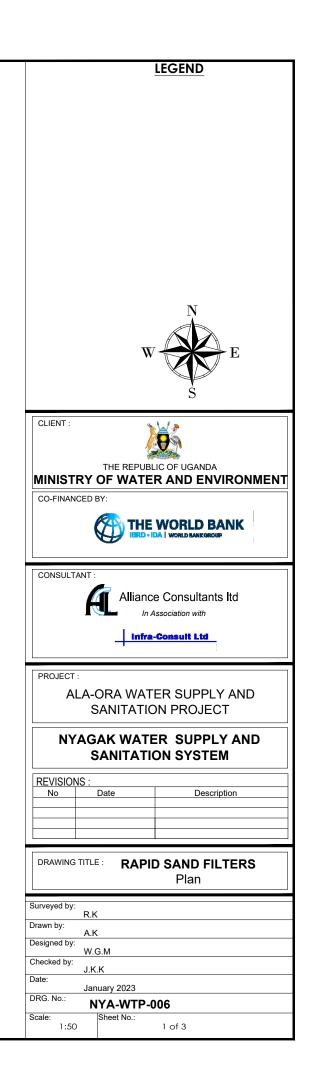

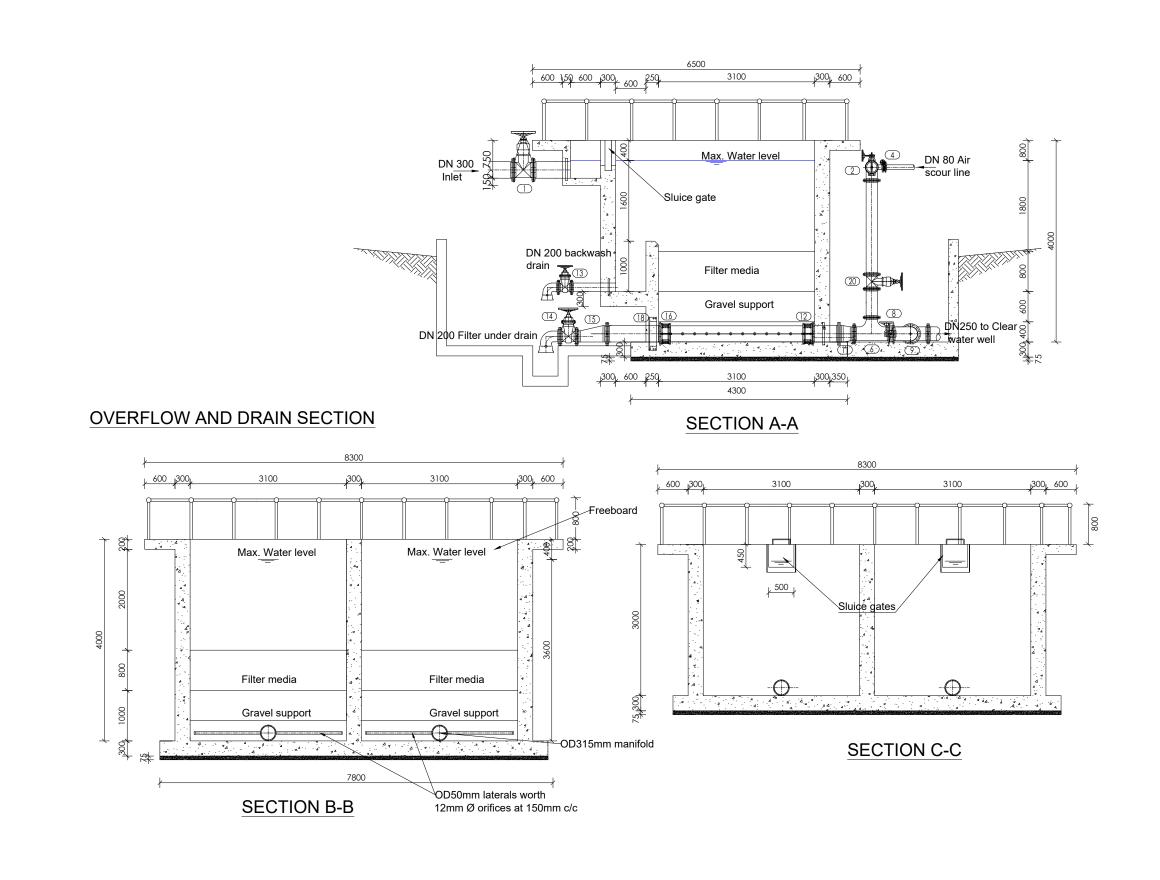

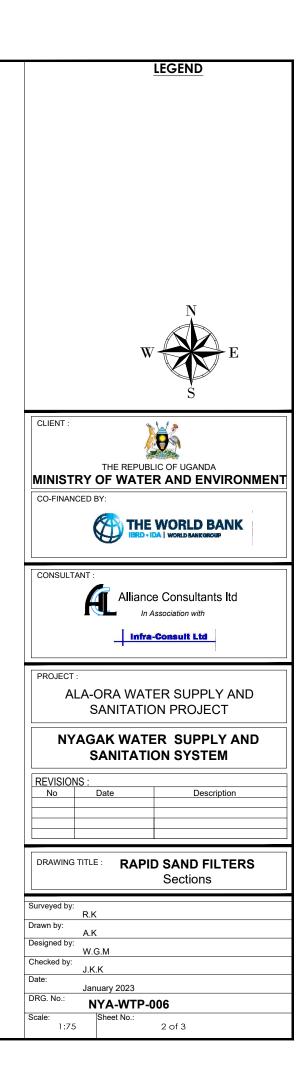

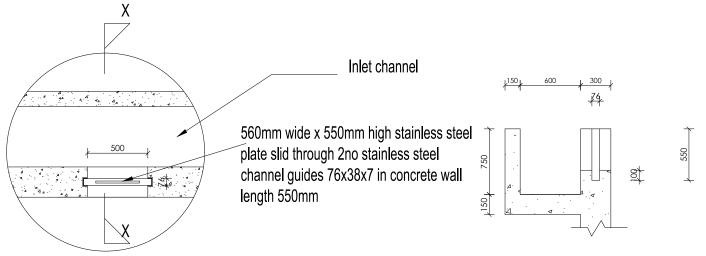


HAND STOCK FIXING PLAN DETAILS


DETAIL a


SECTION X-X


FILTER MEDIA SUPPORT BED

LAYER	DEPTH mm	Coefficient of Uniformity	EFFECTIVE SIZE mm
TOP	200	2.5	3.0
MIDDLE	200	2.5	10.0
BOTTOM	200	2.5	25.0

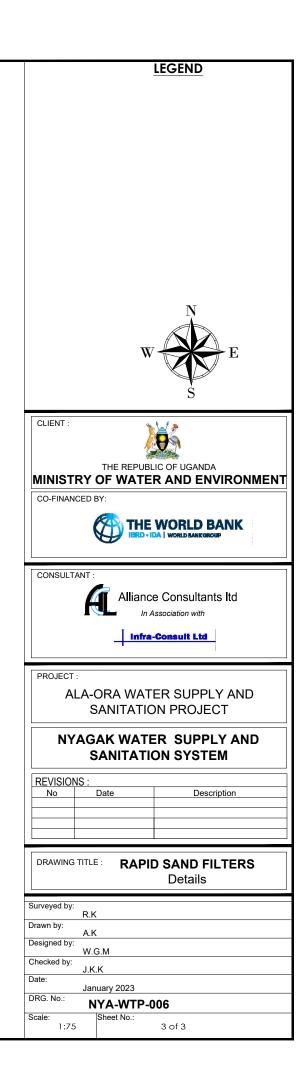


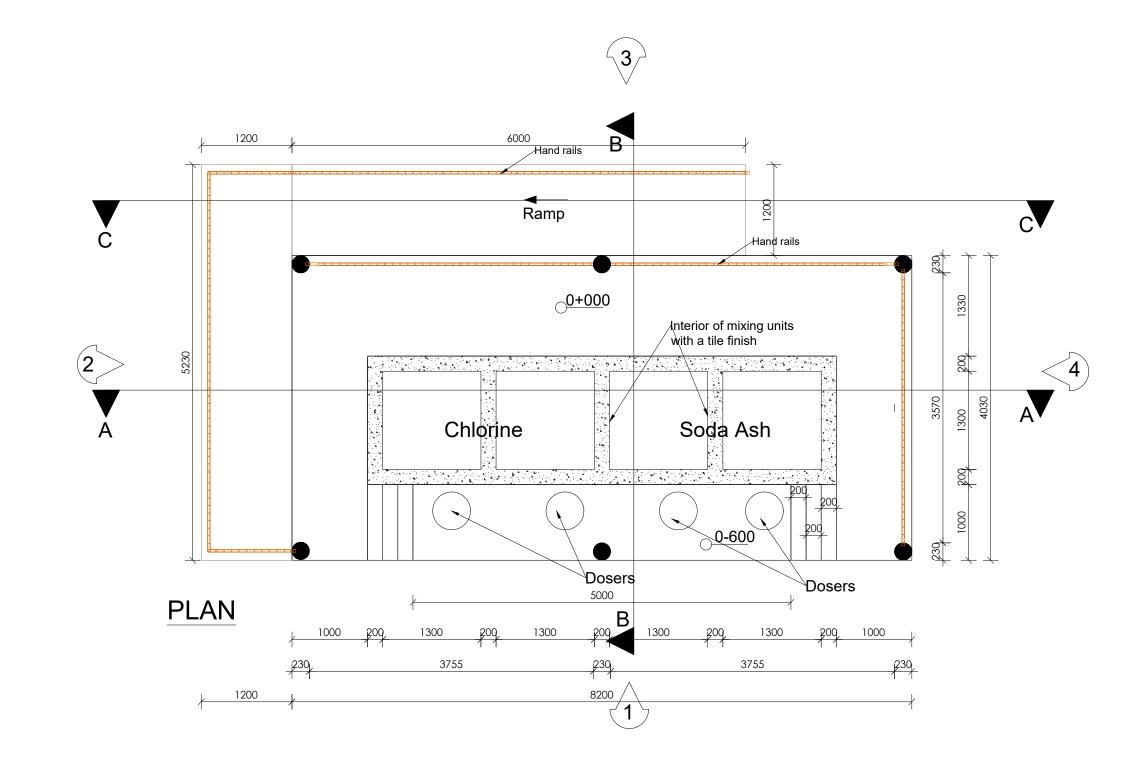


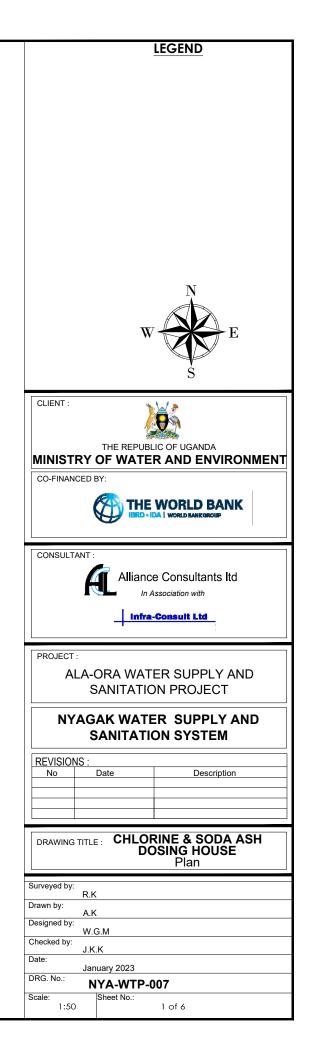


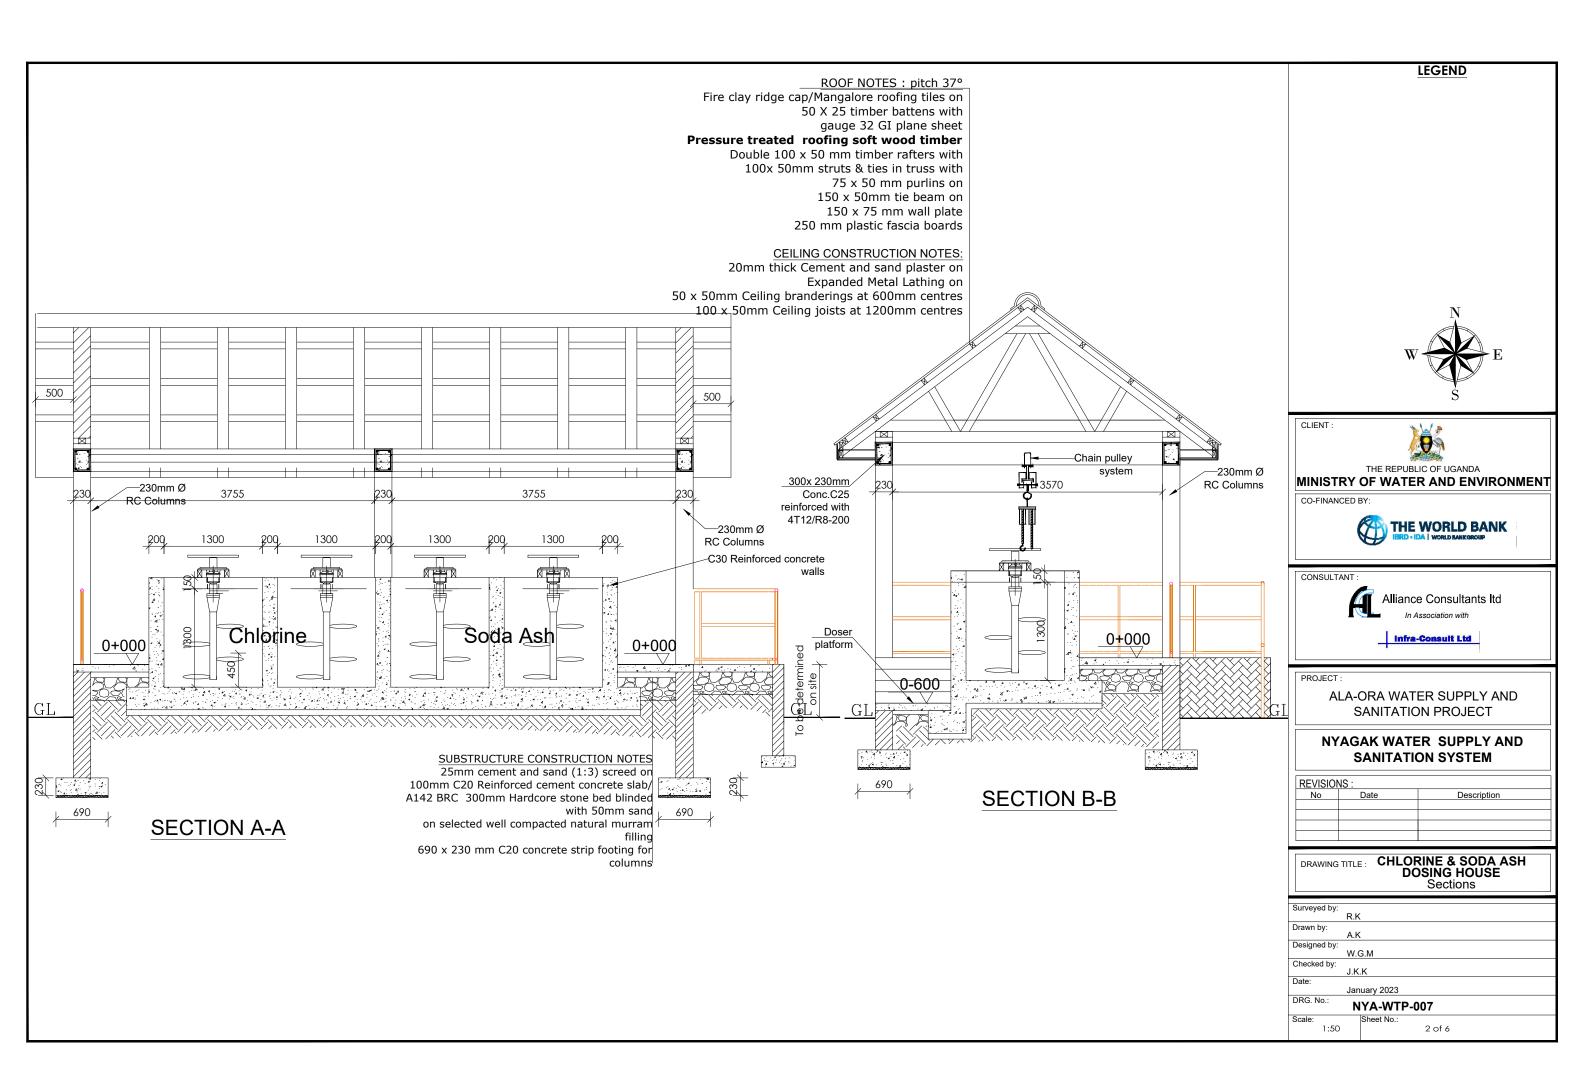





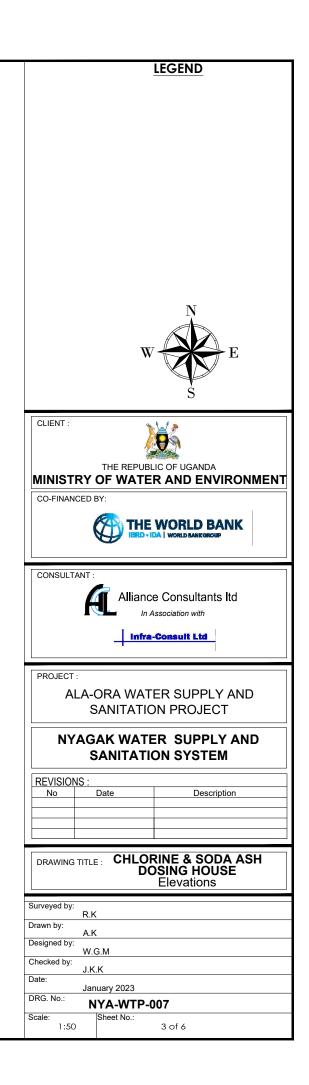


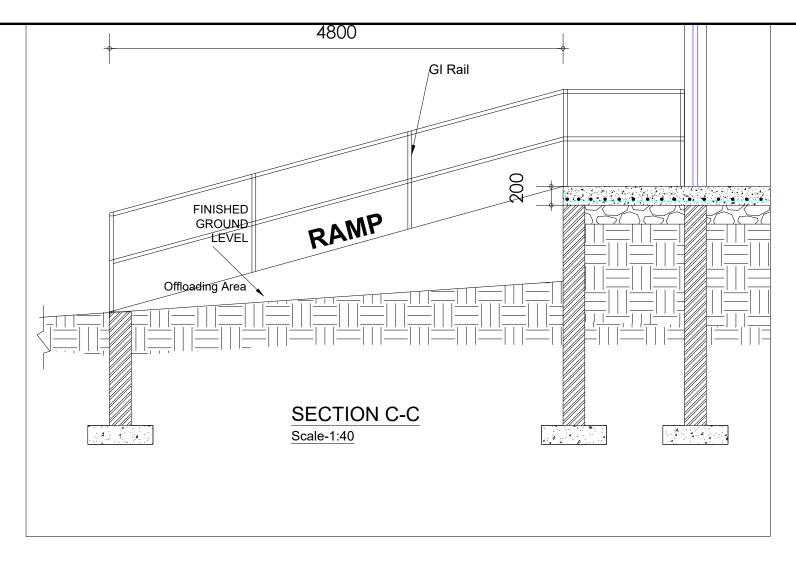


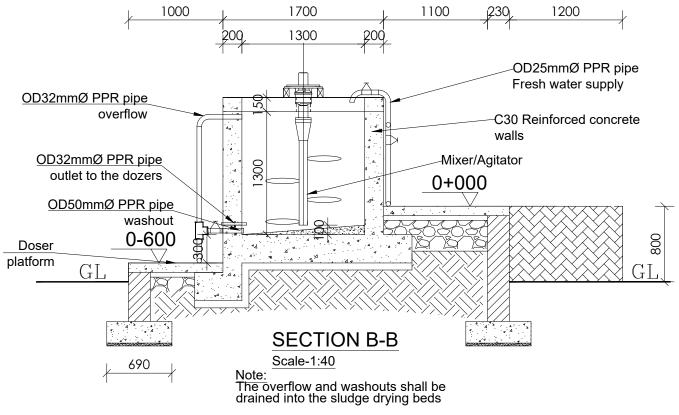

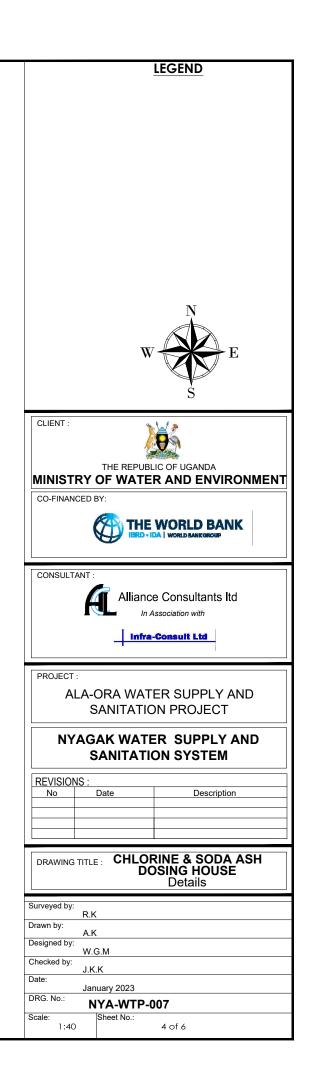


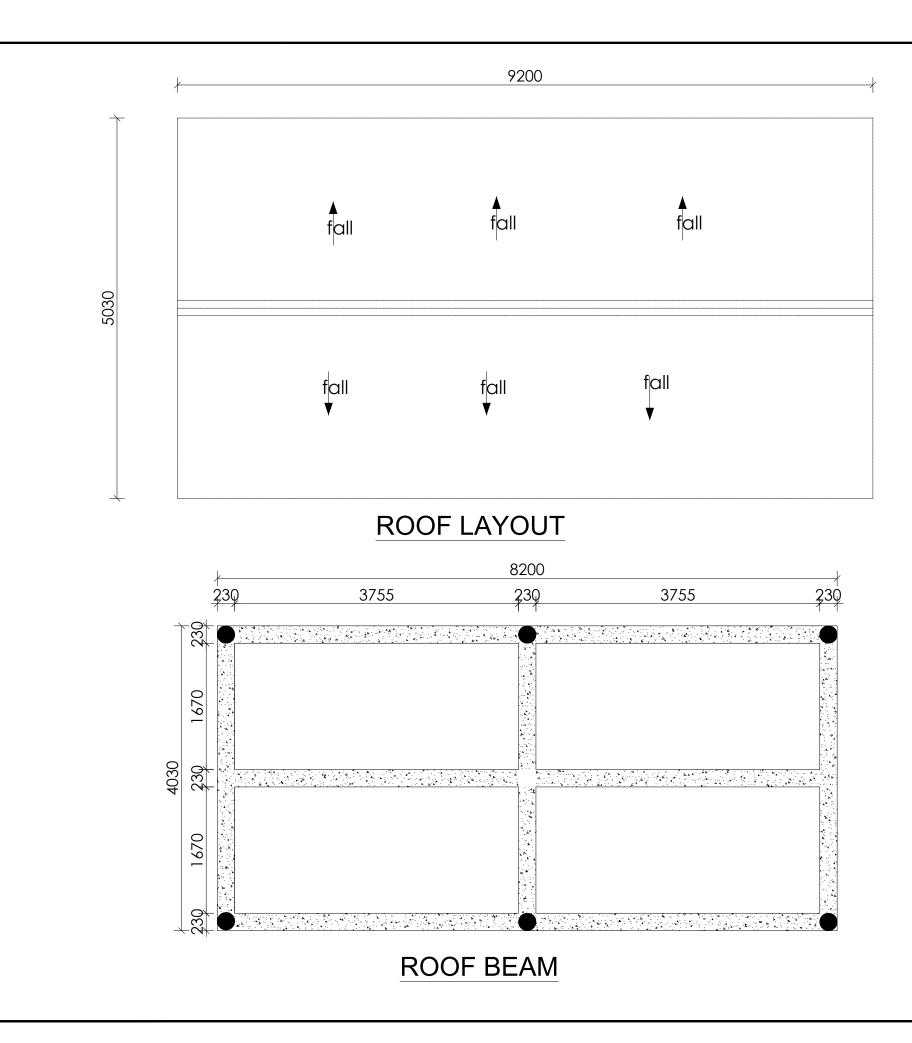


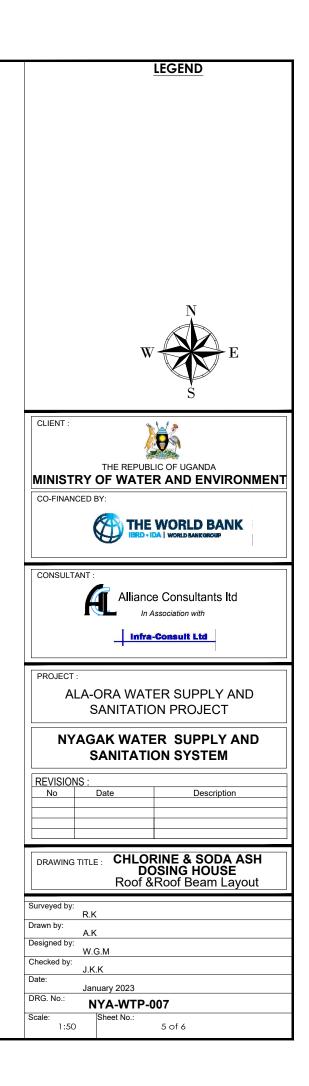

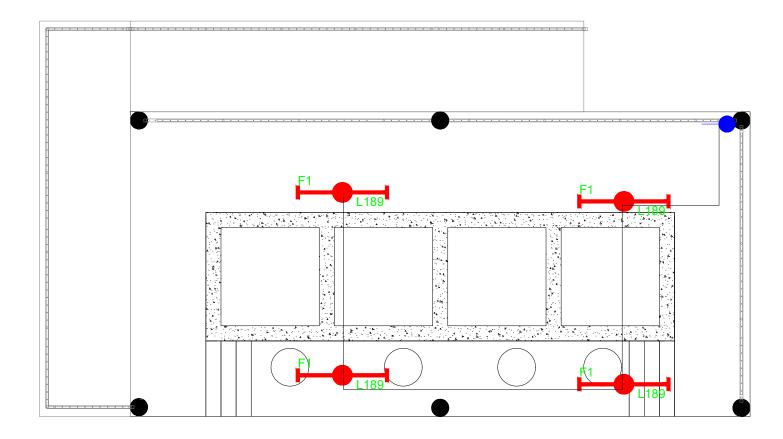



SYMBOL	DESCRIPTION
F1	1200mm 18W LED batten with a removable LED engine. IP20 As Thorn PopPack LED. or equal approved. (Light Type F1)
٥	Pedant lighting fitting comprising ceiling Rose 300mm 3x1.5mm ² flexible copper cable lamp holder and 6W LED Lamp
	Pedant lighting fitting comprising ceiling Rose 300mm 3x1.5mm ² flexible copper cable lamp holder and 6WLED Lamp
B	Pedant lighting fitting comprising ceiling Rose 300mm 3x1.5mm ² flexible copper cable lamp holder and 6W LED Lamp
	wall mounted light
s ² W	Socket outlet on Wall
	Consumer's Unit
•	One Gang 1way Switch
	Two Gang 1way Switch
	Three Gang 1way Switch

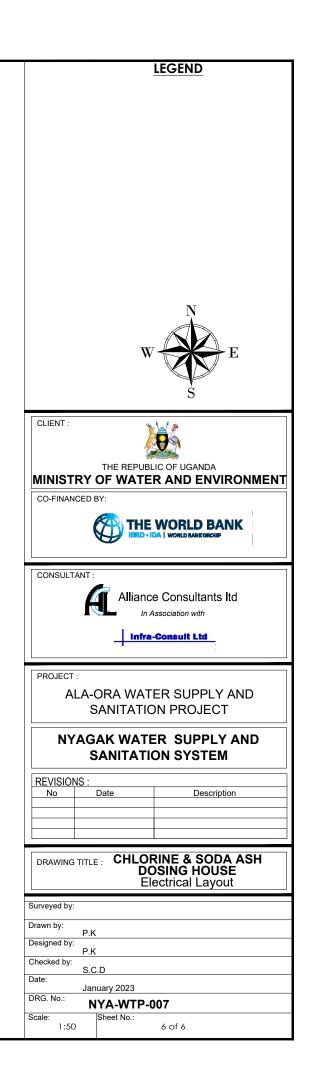


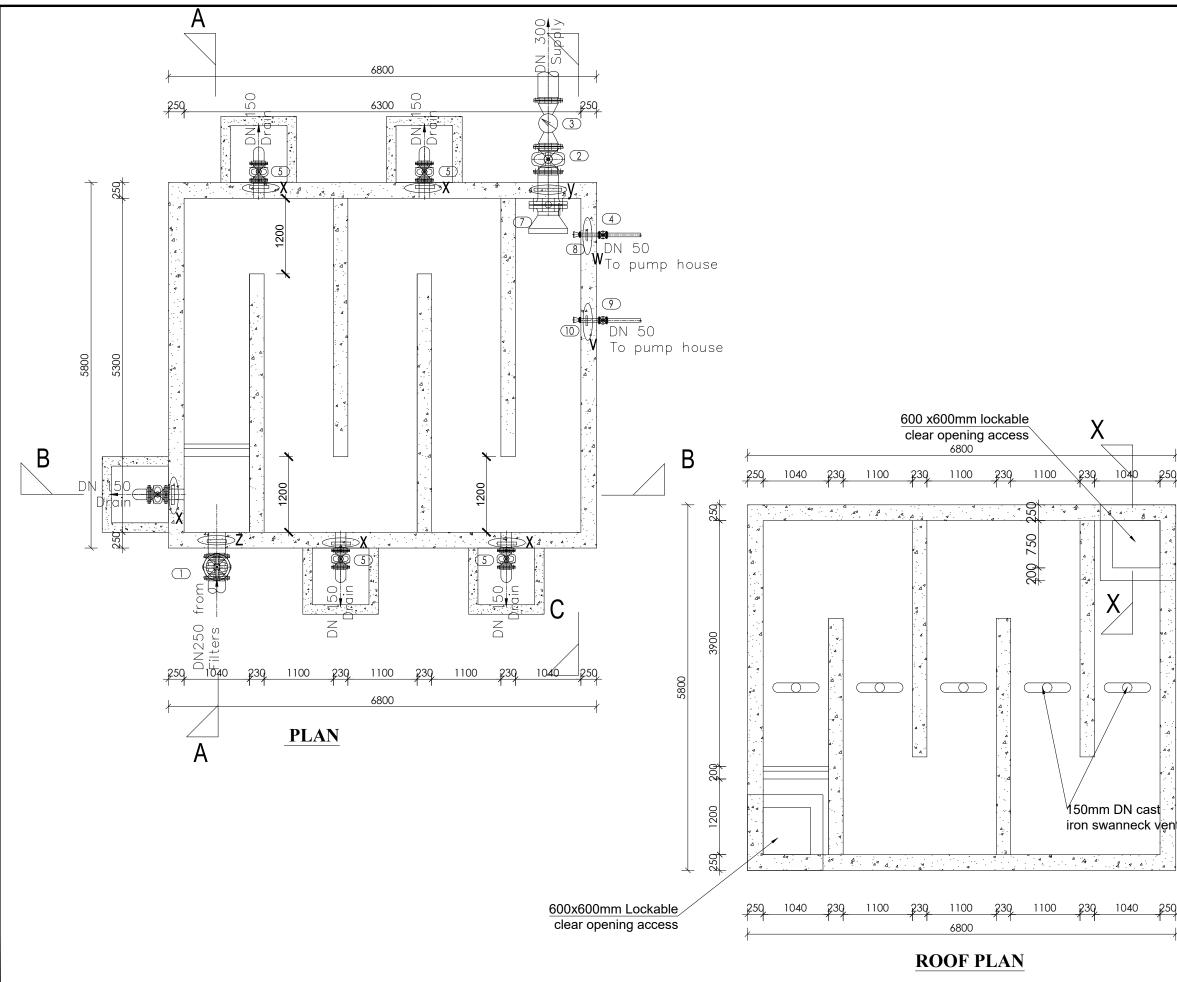



			LEGEND
		W	N E S
	CLIENT :	Ì	
			LIC OF UGANDA
			R AND ENVIRONMENT
\rightarrow	CO-FINANCED BY:		
50,			
	CONSULTANT :		
		Allianc	e Consultants Itd
			Association with
· · · · · · · · · · · · · · · · · · ·		Infra	-Consult Ltd
•			
۹۰- ۲ ۲۰	PROJECT :		
			ER SUPPLY AND
 4 . 	5	SANITATIO	ON PROJECT
	NYAG		ER SUPPLY AND
	S	SANITATI	ON SYSTEM
	REVISIONS :		
	No	Date	Description
4			
4	DRAWING TITLE		R WATER TANK
ntillation			Plan
	Surveyed by: R.K		
·	Drawn by: A.K		
	Designed by: W.0	G.M	
50	Checked by: J.K		
\rightarrow		uary 2023	
	DRG. No.: Scale:	Sheet No.:	008
	Scale: 1:60	Sheet NU.:	1 of 3

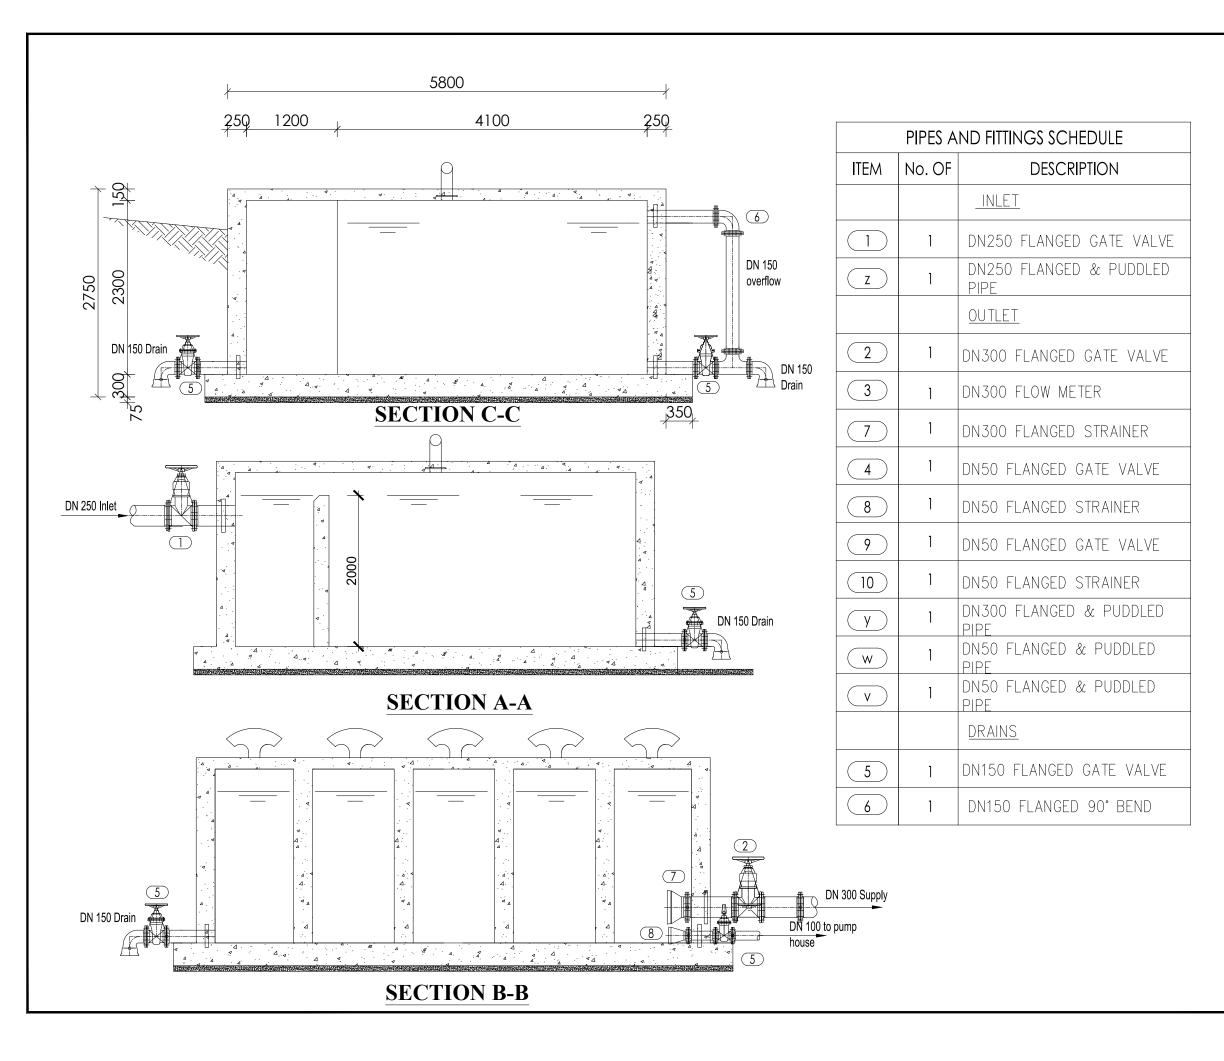

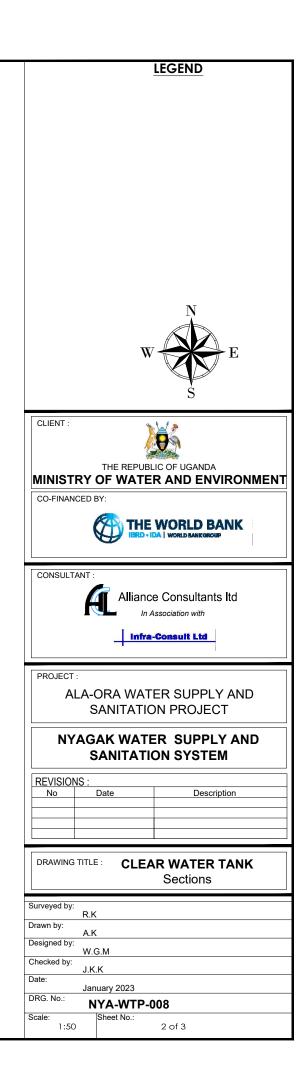


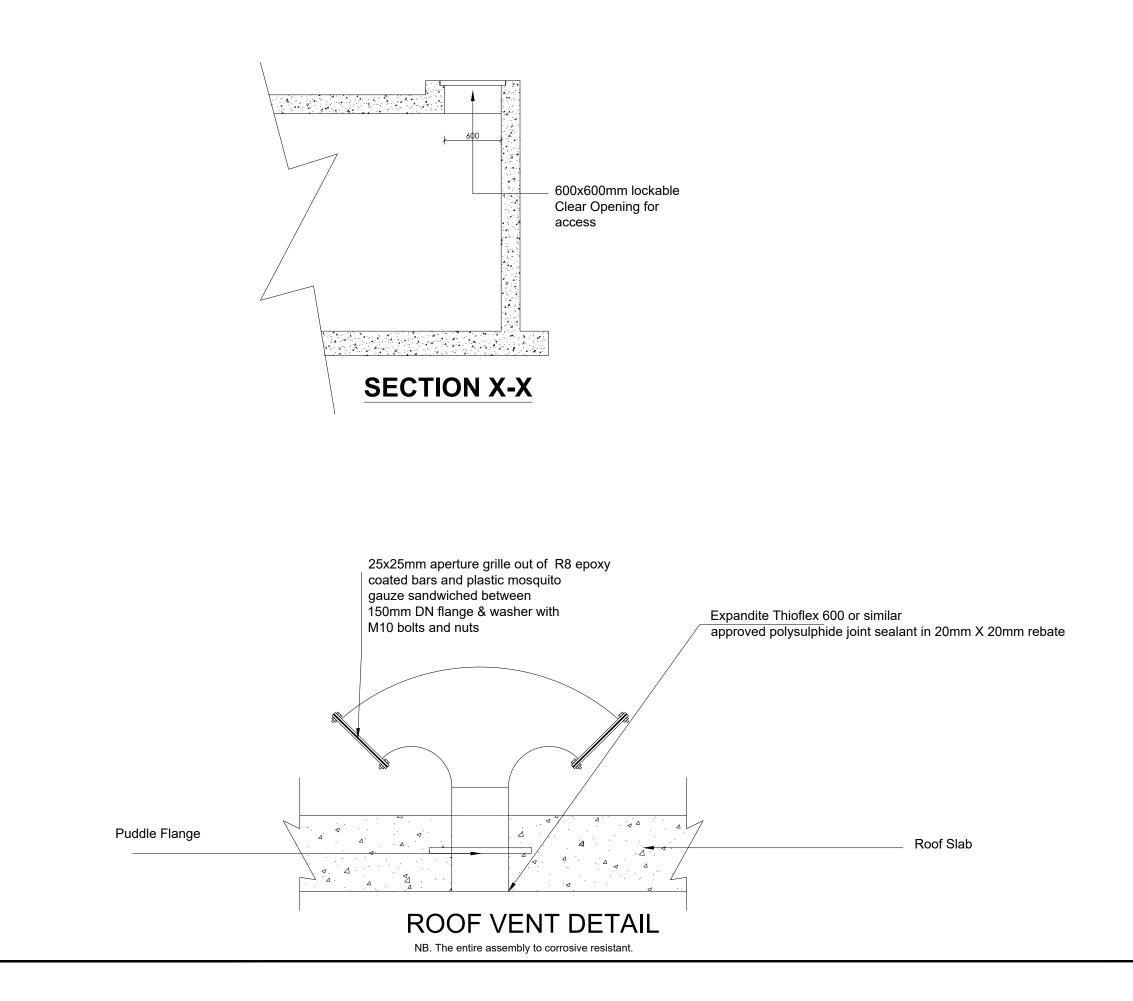

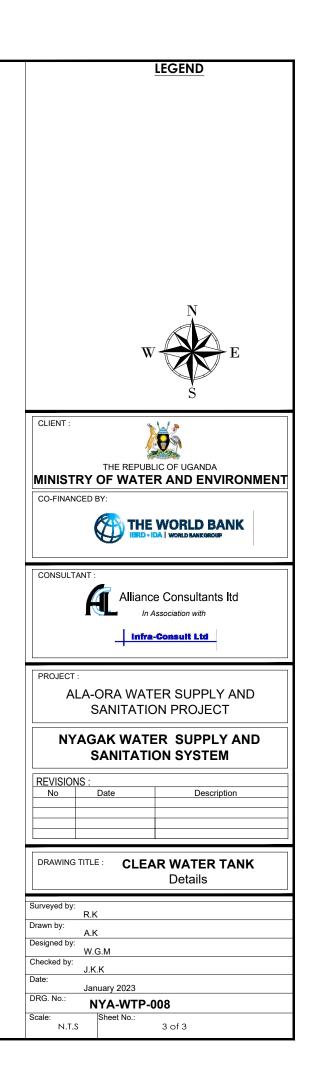


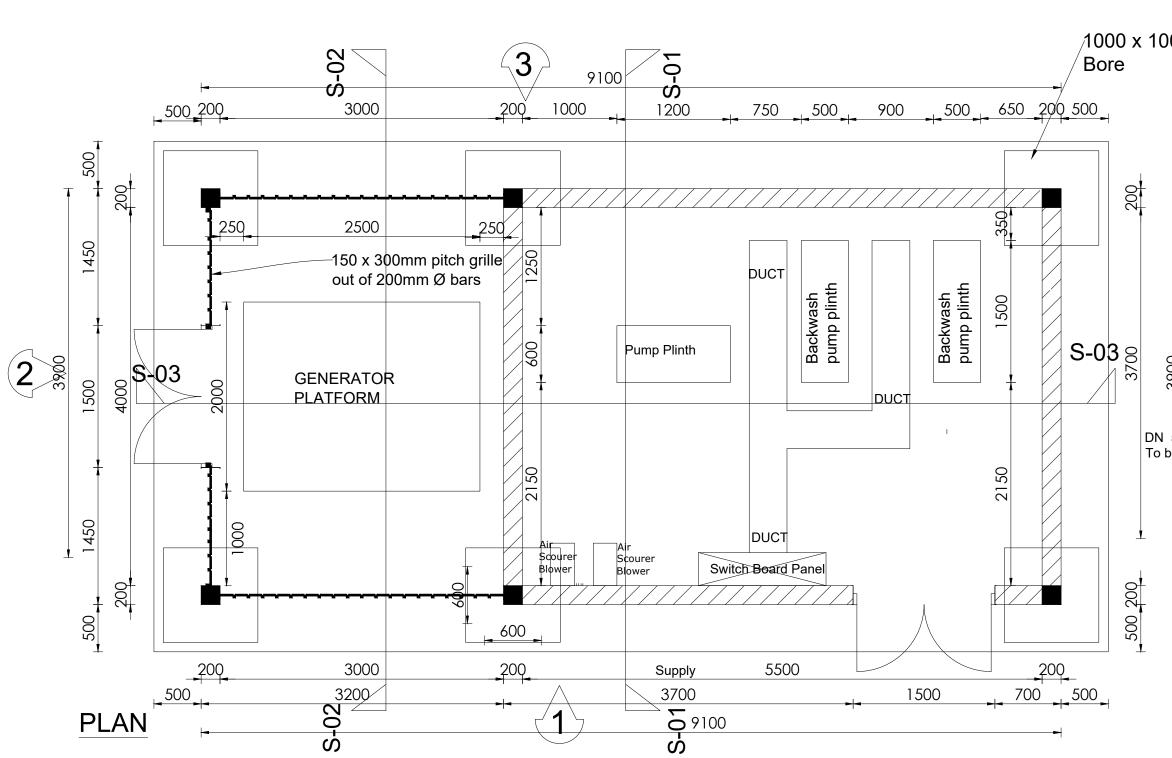



			LEGEND	
)00mm				
			N	
Ŧ				
		W7	E	
		w		
			5	
	CLIENT :	*		
		- A	P A	
			IC OF UGANDA	
_< 4)	MINISTRY	OF WATE	R AND ENVIRONMENT	
33000	CO-FINANCED E	BY:		
ň		THE		
			JAA WORLD BANKGROUP	
50	CONSULTANT :			
backwash tank	CONSULTANT !		o Conquitanto Itd	
			e Consultants Itd	
		Infra	Consult Ltd	
	PROJECT :			
<u>+</u>	ALA-0	ORA WAT	ER SUPPLY AND	
	S	SANITATIC	N PROJECT	
	NYAG		R SUPPLY AND	
			ON SYSTEM	
	REVISIONS :			
		Date	Description	
	DRAWING TITLE	: P	UMP HOUSE	
	Plan			
	Surveyed by:			
	R.K Drawn by:			
	A.K Designed by:			
	W.C Checked by: J.K.			
	Date:	uary 2023		
	DRG. No.: N	YA-WTP-0	009	
	Scale: 1:40	Sheet No.:	1 of 11	
	L			

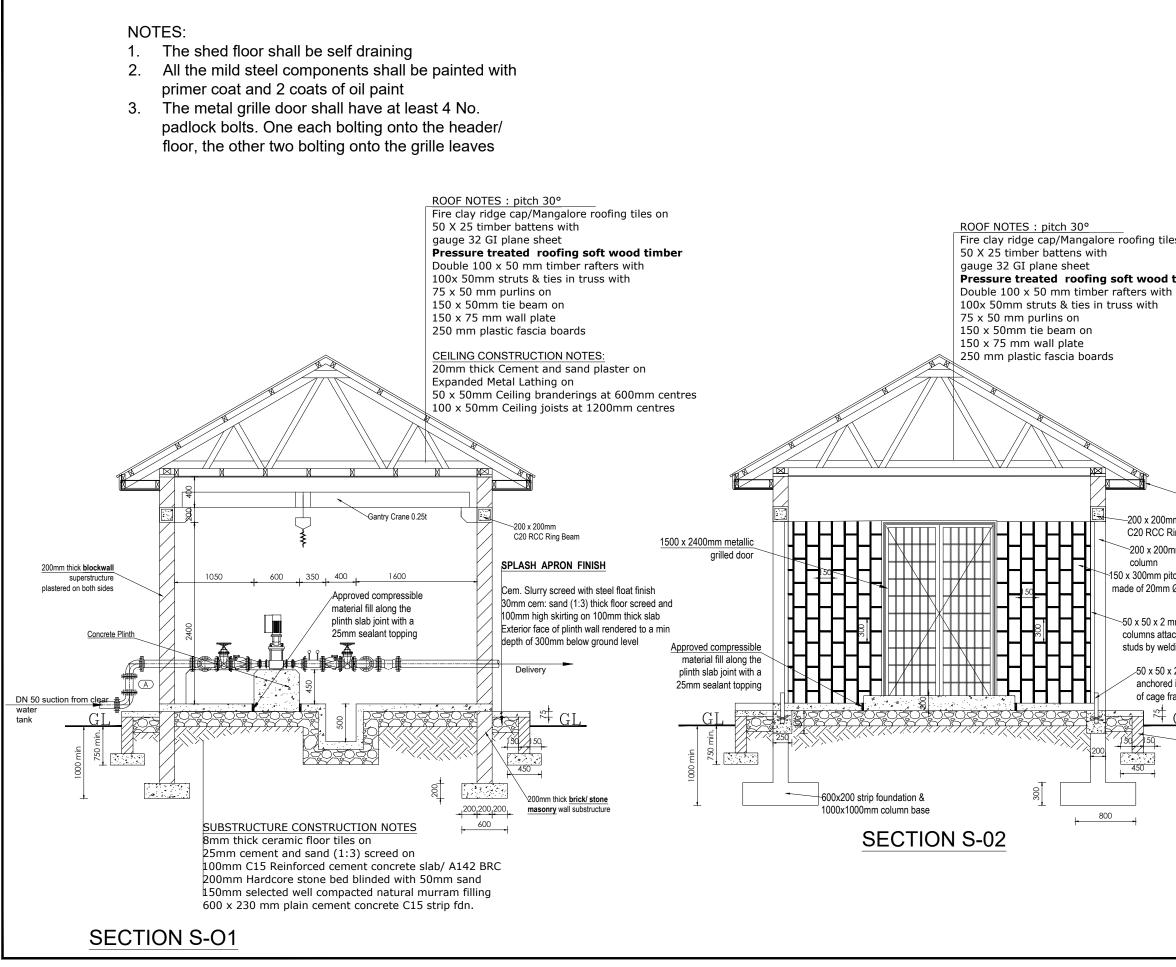


	LEGEND
	D.T.
es on	N
timber	W E
linder	
	¥ S
	CLIENT :
	THE REPUBLIC OF UGANDA MINISTRY OF WATER AND ENVIRONMENT
	CO-FINANCED BY:
Diratia	
Plastic fascia boards	CONSULTANT :
m	Alliance Consultants Itd
ing Beam	In Association with
nm reinforced conc.	Infra-Consult Ltd
ch metal grille	•
Øbars	PROJECT :
	ALA-ORA WATER SUPPLY AND
nm m.s SHS ched to the bedded	SANITATION PROJECT
ding	
2mm m.s SHS studs	NYAGAK WATER SUPPLY AND
in conc. slab for attach	SANITATION SYSTEM
ame by welding	REVISIONS :
GL	No Date Description
-150mm thick	
brickwall rendered	
on outer side 300mm below GL.	
DEIOW GL.	DRAWING TITLE : PUMP HOUSE
	Sections
	Surveyed by:
	R.K Drawn by:
	A.K Designed by:
	W.G.M Checked by:
	Date:
	January 2023
	NYA-WTP-009 Scale: Sheet No.:
	1:50 2 of 11

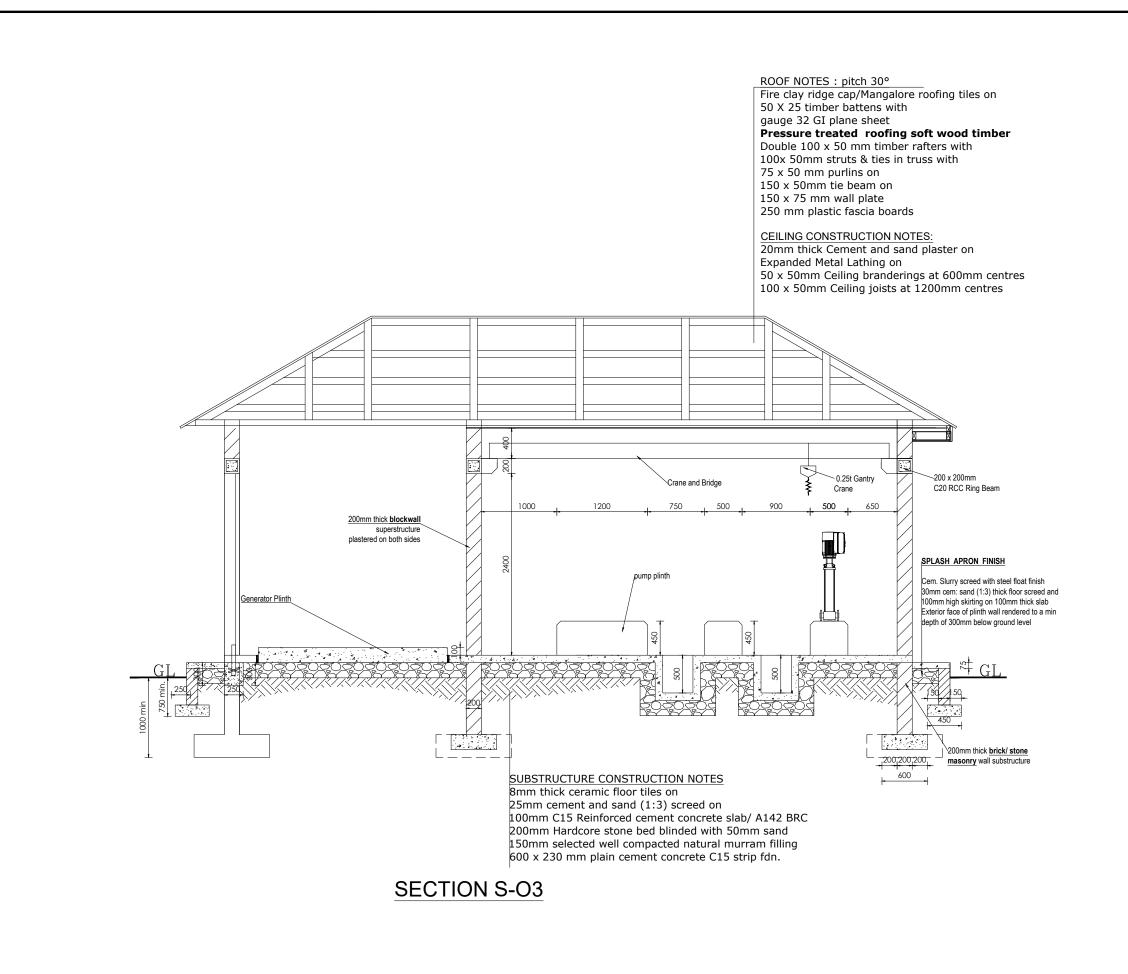


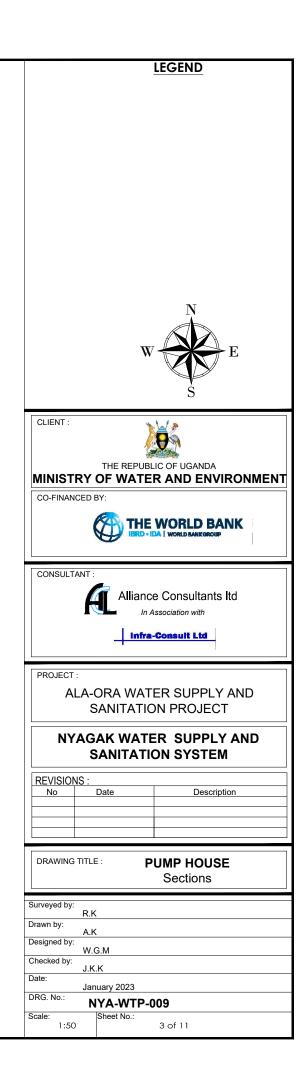

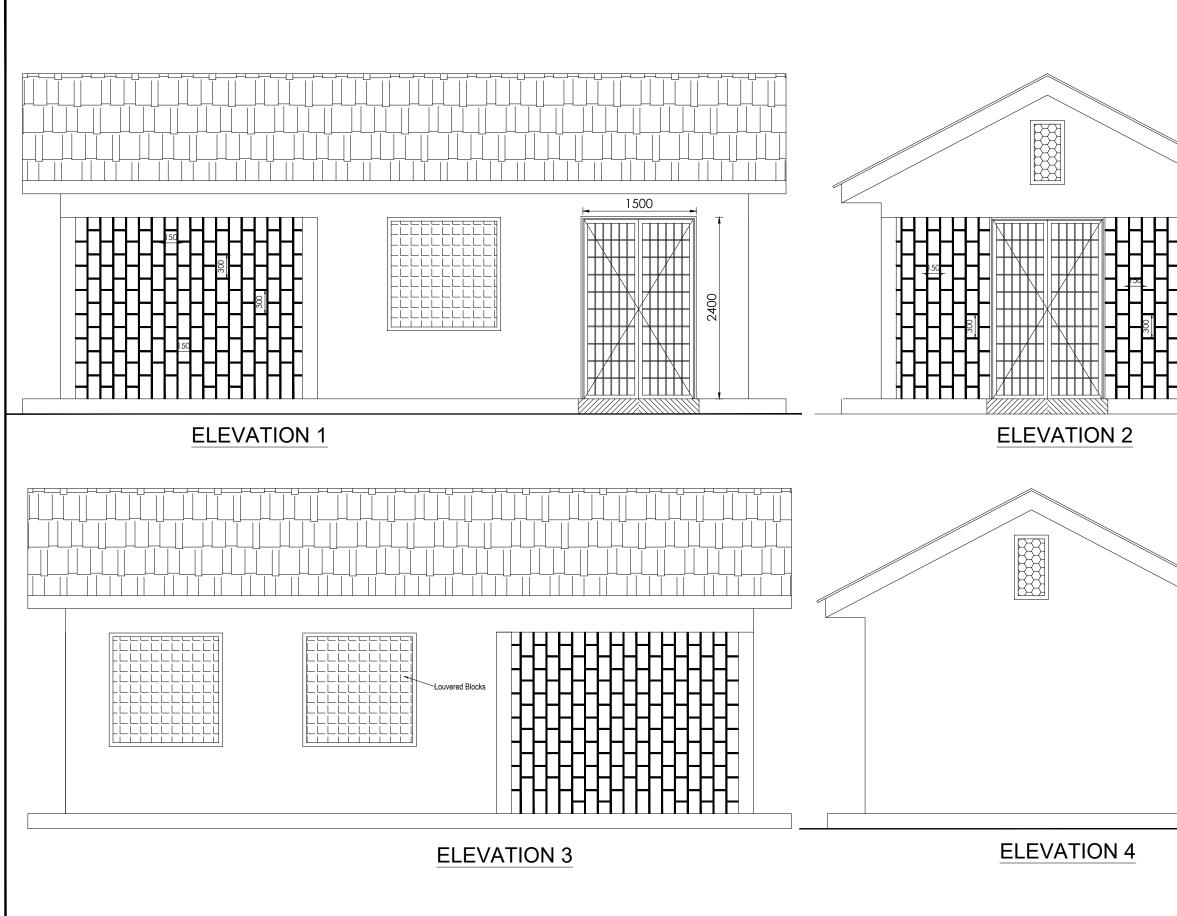

			LEGEND	
			Ν	
.				
┣┫		W/	E	
Ъ _∏ ∣		vv		
┫╋				
┫╊╴╵			5	
JH↓	CLIENT :	*	hal a	
		J.	9 %	
		THE REPUBL	IC OF UGANDA	
┫┣┤│	MINISTRY		R AND ENVIRONMENT	
┫╋┤	CO-FINANCED	BY:		
	CONSULTANT :			
	Alliance Consultants Itd			
	In Association with			
	Infra-Consult Ltd			
	PROJECT :			
	ALA-ORA WATER SUPPLY AND			
SANI			NITATION PROJECT	
	NYAG	AK WATE	R SUPPLY AND	
	S	SANITATIO	ON SYSTEM	
	REVISIONS :			
		Date	Description	
	DRAWING TITLE	=· D		
	DRAWING TITLE : PUMP HOUSE Elevations			
	Surveyed by: R.K	(
	Drawn by: A.K Designed by:	ζ.		
	Checked by:	G.M		
	J.K	.К		
	January 2023			
	I N	YA-WTP-0	109	
	Scale:	Sheet No.:		

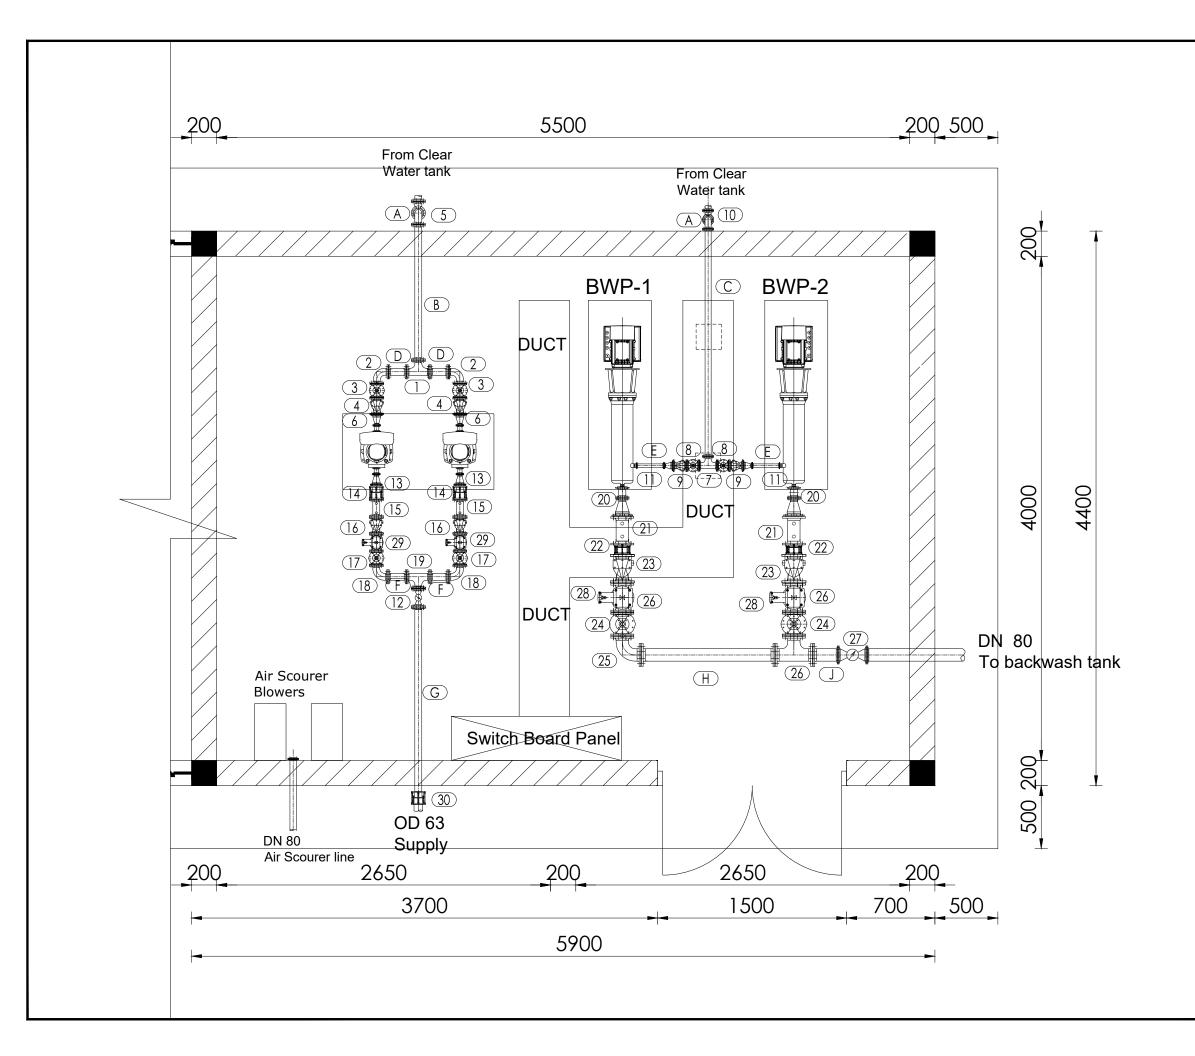

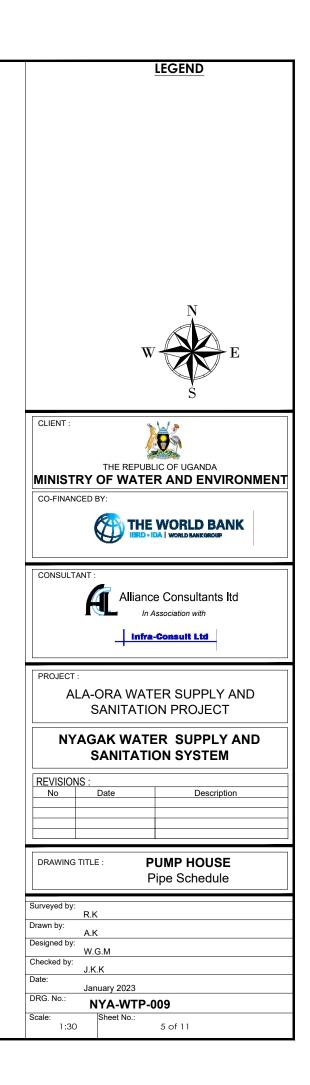


	PIPES AND FITTINGS SCHEDULE				
ITEM	No. OF	DESCRIPTION			
		DN50 SUCTIONS			
	1	DN50 ALL EQUAL TEE			
2	2	DN50 FLANGED 90° BEND			
3	2	DN50 FLANGED GATE VALVE			
4	2	D50 FLANGED NON-RETURN VALVE			
5	2	D50 FLANGED 90° BEND			
6	2	DN50/DN25 FLANGED REDUCER			
		DN50 SUNCTION			
7	1	D50 FLANGED EQUAL TEE			
8	2	DN50 FLANGED GATE VALVE			
9	2	DN50 FLANGED NON-RETURN VALVE			
10	2	D50 FLANGED 90° BEND			
	2	DN50/DN25 FLANGED REDUCERS			


	PIPES A	ND FITTINGS SCHEDULE
ITEM	No. OF	DESCRIPTION
		<u>DN50 DELIVERY TANK</u>
12	1	DN50 FLANGED BULK WATER METER
13	2	DN50/DN32 FLANGED REDUCER
14	2	DN50 DISMANTLING JOINT
15	2	DN50 FLANGED PRESSURE GAUGE
16	2	D50 FLANGED NON-RETURN VALVE
17	2	D50 FLANGED GATE VALVE
18	1	D50 FLANGED 90° BEND
19	2	D50 FLANGED ALL EQUAL TEE
29	2	D50 FLANGED AIR VALVE
30	1	D50/OD63 COUPLING
		DN80 DELIVERY (Backwashtank)
20	2	D80/DN32 FLANGED REDUCER
21	2	DN80 FLANGED PRESSURE GAUGE
22	2	DN80 DISMANTLING JOINT
23	2	DN80 FLANGED NON-RETURN VALVE
24	2	DN80 FLANGED GATE VALVE
25	1	D80 FLANGED 90° BEND
26	3	D80 FLANGED ALL EQUAL TEE
27	1	D80 FLANGED BULK WATER METER
28	2	D80 FLANGED AIR VALVE

PIPES AND FITTINGS SCHEDULE					
ITEM	No. OF	DESCRIPTION			
		DN50 PIPE SPECIALS			
A	2	DN 50 FLANGED PIPE LENGT n.e 0.35m			
В	1	DN 50 FLANGED PIPE LENGT n.e 1.2m			
C	1	DN 50 FLANGED PIPE LENGT n.e 2m			
D	2	DN 50 FLANGED PIPE LENGT n.e 0.2m			
E	2	DN 50 FLANGED PIPE LENGT n.e 0.3m			
F	2	DN 50 FLANGED PIPE LENGT n.e 0.2m			
G	1	DN 50 FLANGED PIPE LENGT n.e 1.5m			
		DN80 PIPE SPECIALS			
H	1	DN 80 FLANGED PIPE LENGT n.e 1.2m			
	2	DN 80 FLANGED PIPE LENGT n.e 0.25m			

				LEGEND	
T 11	-				
TH					
TH					
TH	-				
				Ν	
TH					
<u></u>			W	E	
TH					
TH	-			S	
TH		CLIENT :)		
		MINISTRY		IC OF UGANDA R AND ENVIRONMENT	
		CO-FINANCED I			
ΤH				WORLD BANK	
TH	-			WORLD BANK	
]	CONSULTANT :	a		
				e Consultants Itd	
		Infra-Consult Ltd			
		PROJECT :			
				ER SUPPLY AND	
		S	SANITATIC	N PROJECT	
		NYAGAK WATER SUPPLY AND			
		SANITATION SYSTEM			
		REVISIONS :			
		No	Date	Description	
		DRAWING TITLE		UMP HOUSE	
		Pipe Schedule			
		Surveyed by: R.K			
		Drawn by: A.K			
			G.M		
		Checked by: J.K Date:	.K		
		Jan		000	
		Scale:	YA-WTP-0 Sheet No.:		
		1:50		6 of 11	

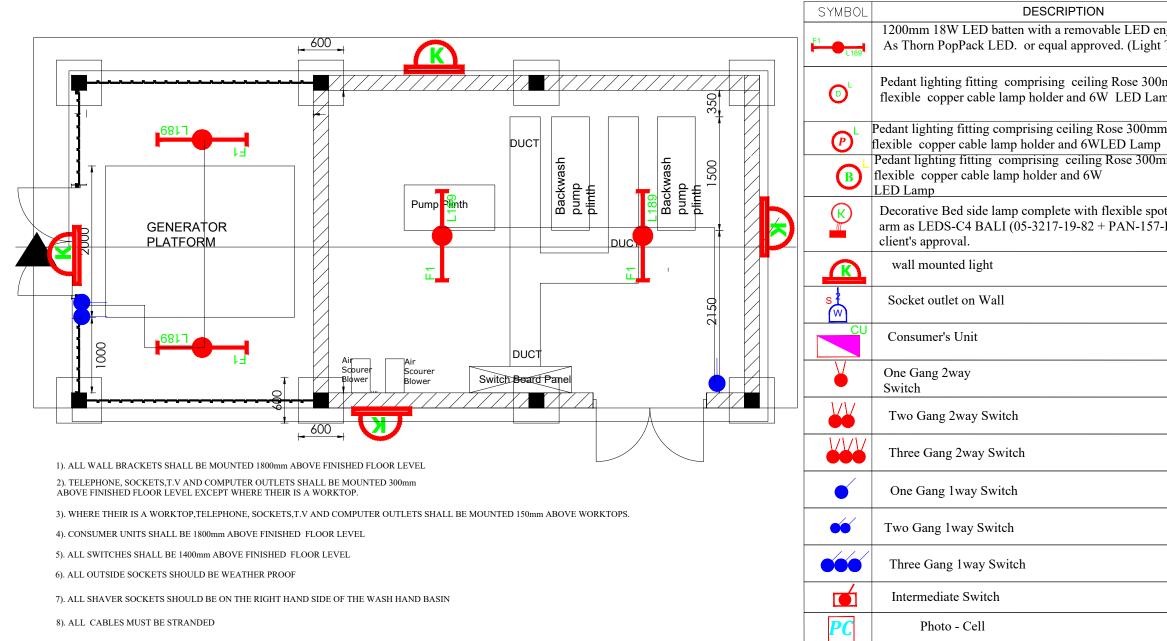



			LEGEND
igine. IP20			
Type F1)			
$nm 3x1.5mm^2$			
np			N
2.1.5.2			
$1.3 \times 1.5 \text{mm}^2$		W	E
$m 3x1.5mm^2$			
			5
t light	CLIENT :	*	
BY) to			
		1	
	MINISTRY		IC OF UGANDA R AND ENVIRONMENT
	CO-FINANCED		
	OO T NUNCED I		
		THE	
	CONSULTANT :		
	CONSULTANT :		
			e Consultants Itd
	-		
		Infra	Consult Ltd
	PROJECT :		
		ANITATIC	N PROJECT
	NYAG	AK WATE	R SUPPLY AND
	S	SANITATIO	ON SYSTEM
	REVISIONS :		
		Date	Description
	DRAWING TITLE		
		P	ipe Schedule
	Surveyed by: R.K		
	Drawn by: A.K		
	Designed by:	G.M	
	Checked by: J.K		
	Date:		
	DPG No :	uary 2023 YA-WTP-0	0.9
	Scale:	Sheet No.:	
	1:50		7 of 11

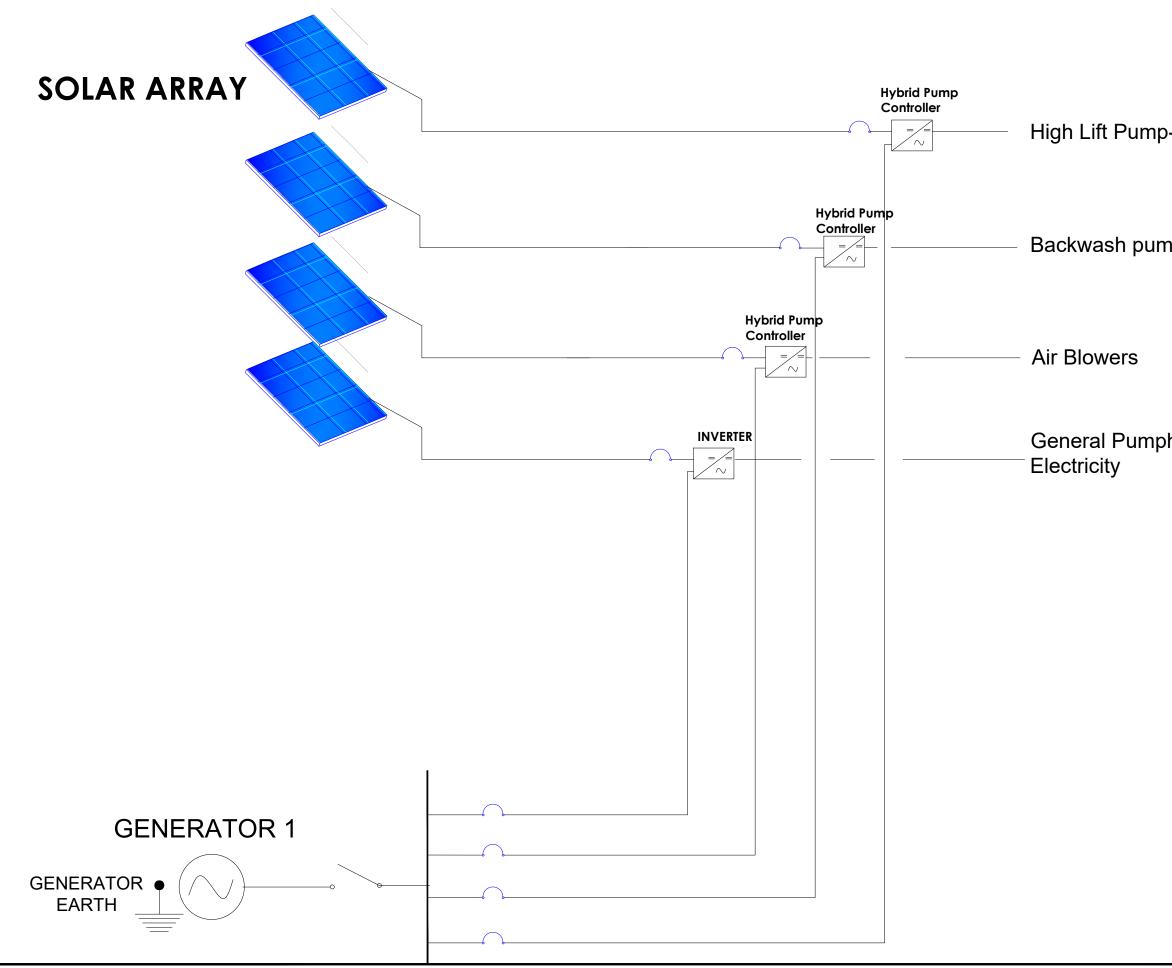



	LEGEND				
-1					
	Ν				
nps					
	WEE				
	W V E				
	5				
	CLIENT :				
	THE REPUBLIC OF UGANDA MINISTRY OF WATER AND ENVIRONMENT				
	CO-FINANCED BY:				
house					
	CONSULTANT :				
	Alliance Consultants Itd				
	In Association with				
	infra-Consult Ltd				
	PROJECT :				
	ALA-ORA WATER SUPPLY AND				
	SANITATION PROJECT				
	NYAGAK WATER SUPPLY AND				
	SANITATION SYSTEM				
	REVISIONS : No Date Description				
	DRAWING TITLE : PUMP HOUSE				
	Solar Array Layout				
	Surveyed by:				
	R.K Drawn by:				
	P.K Designed by:				
	P.K Checked by: S.C.D Date:				
	January 2023 DRG. No.: NYA-WTP-009				
	Scale: Sheet No.:				
	1:500 8 of 11				




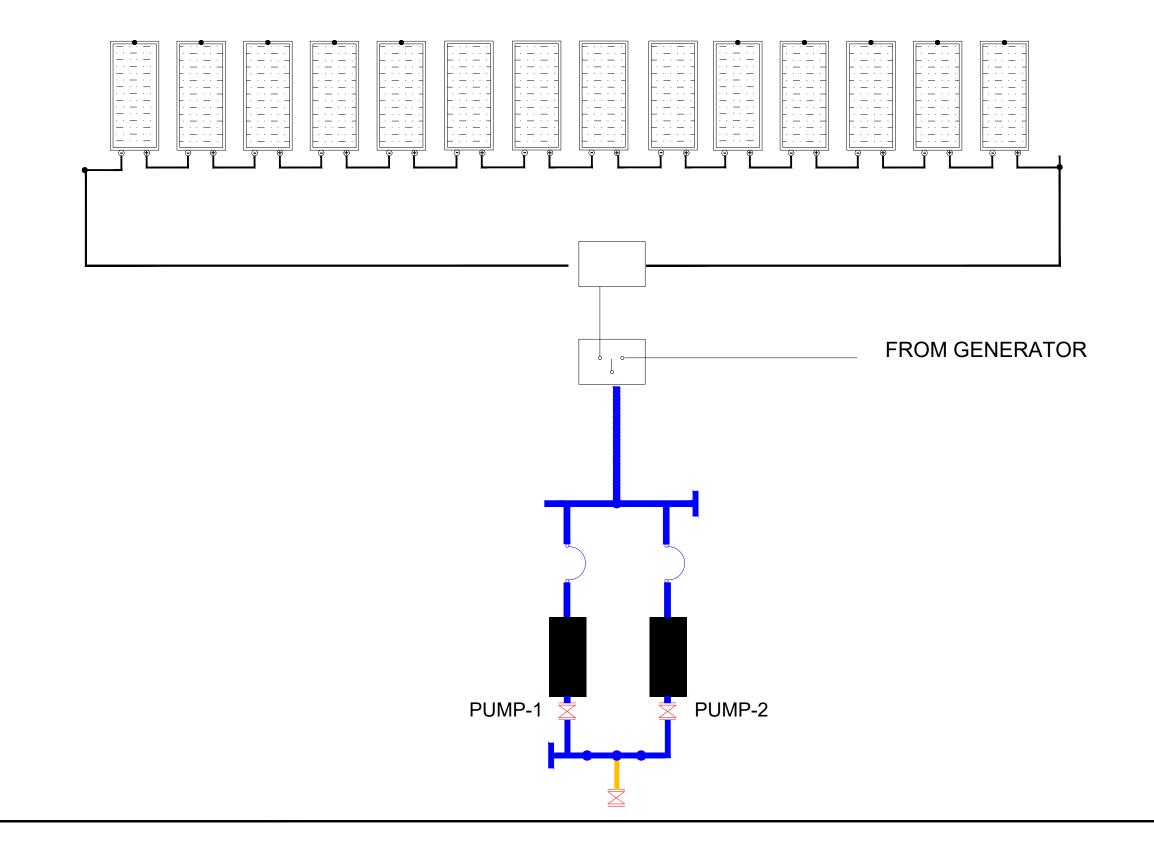


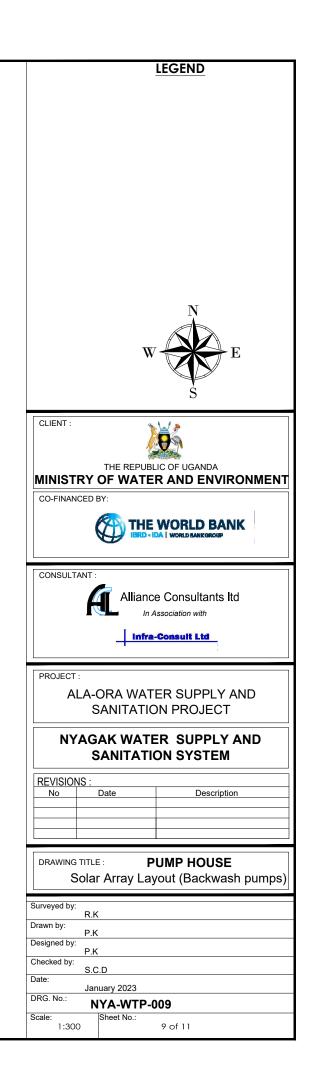


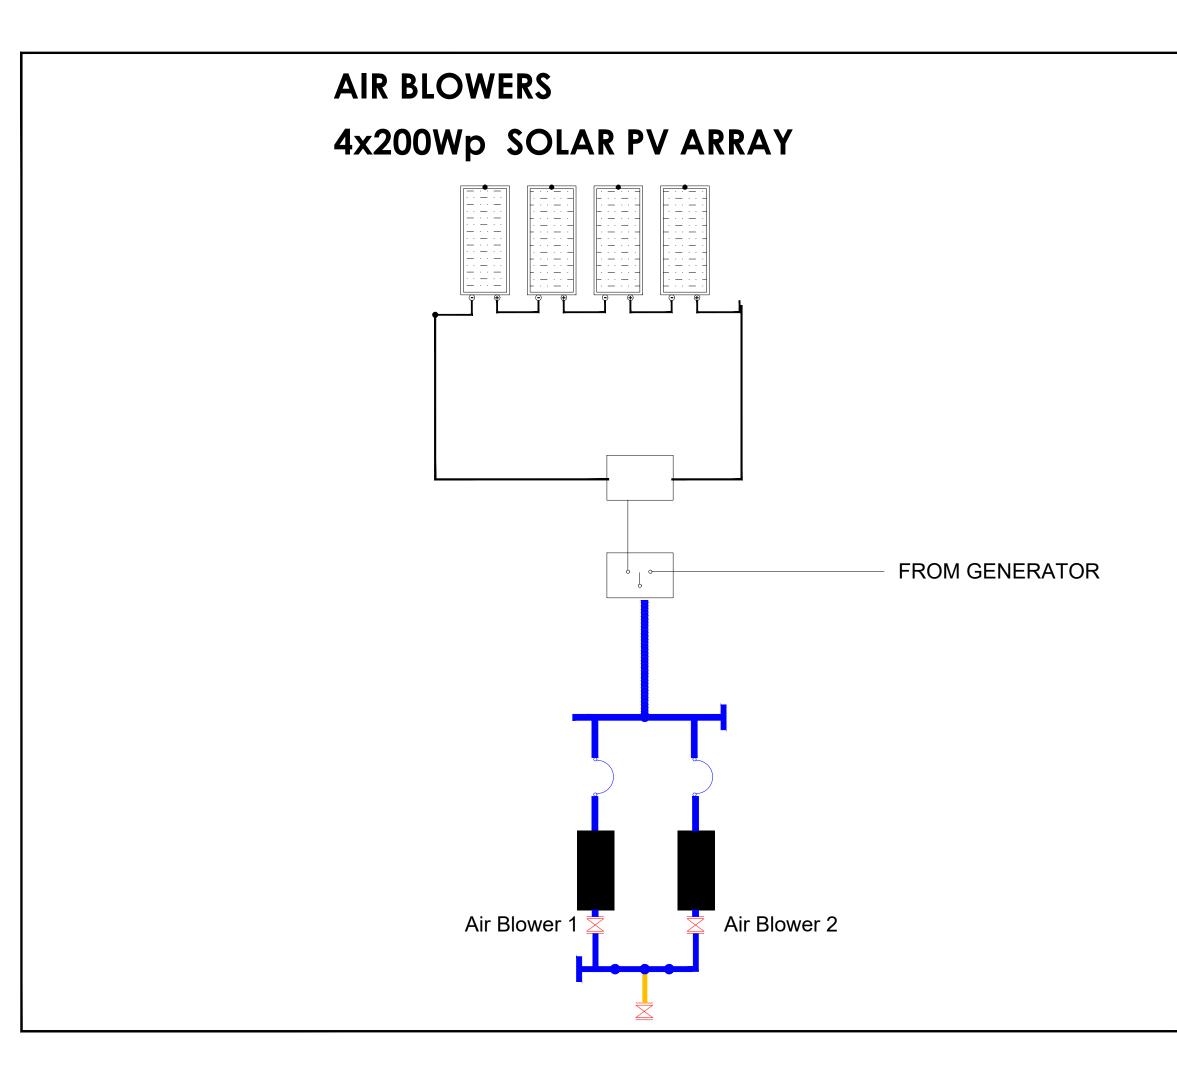


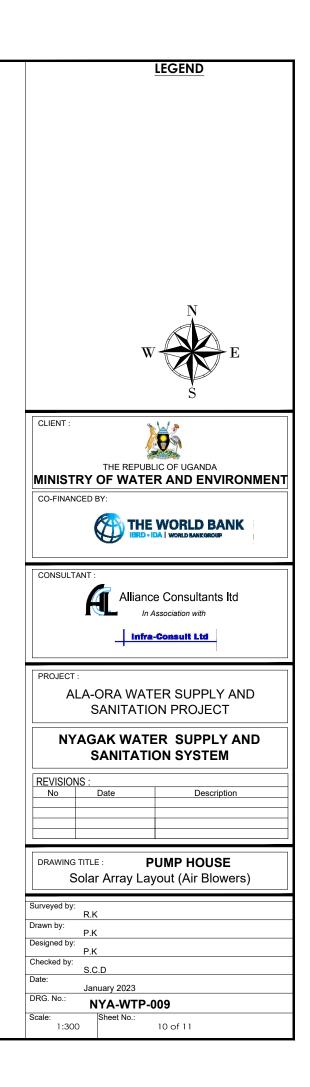


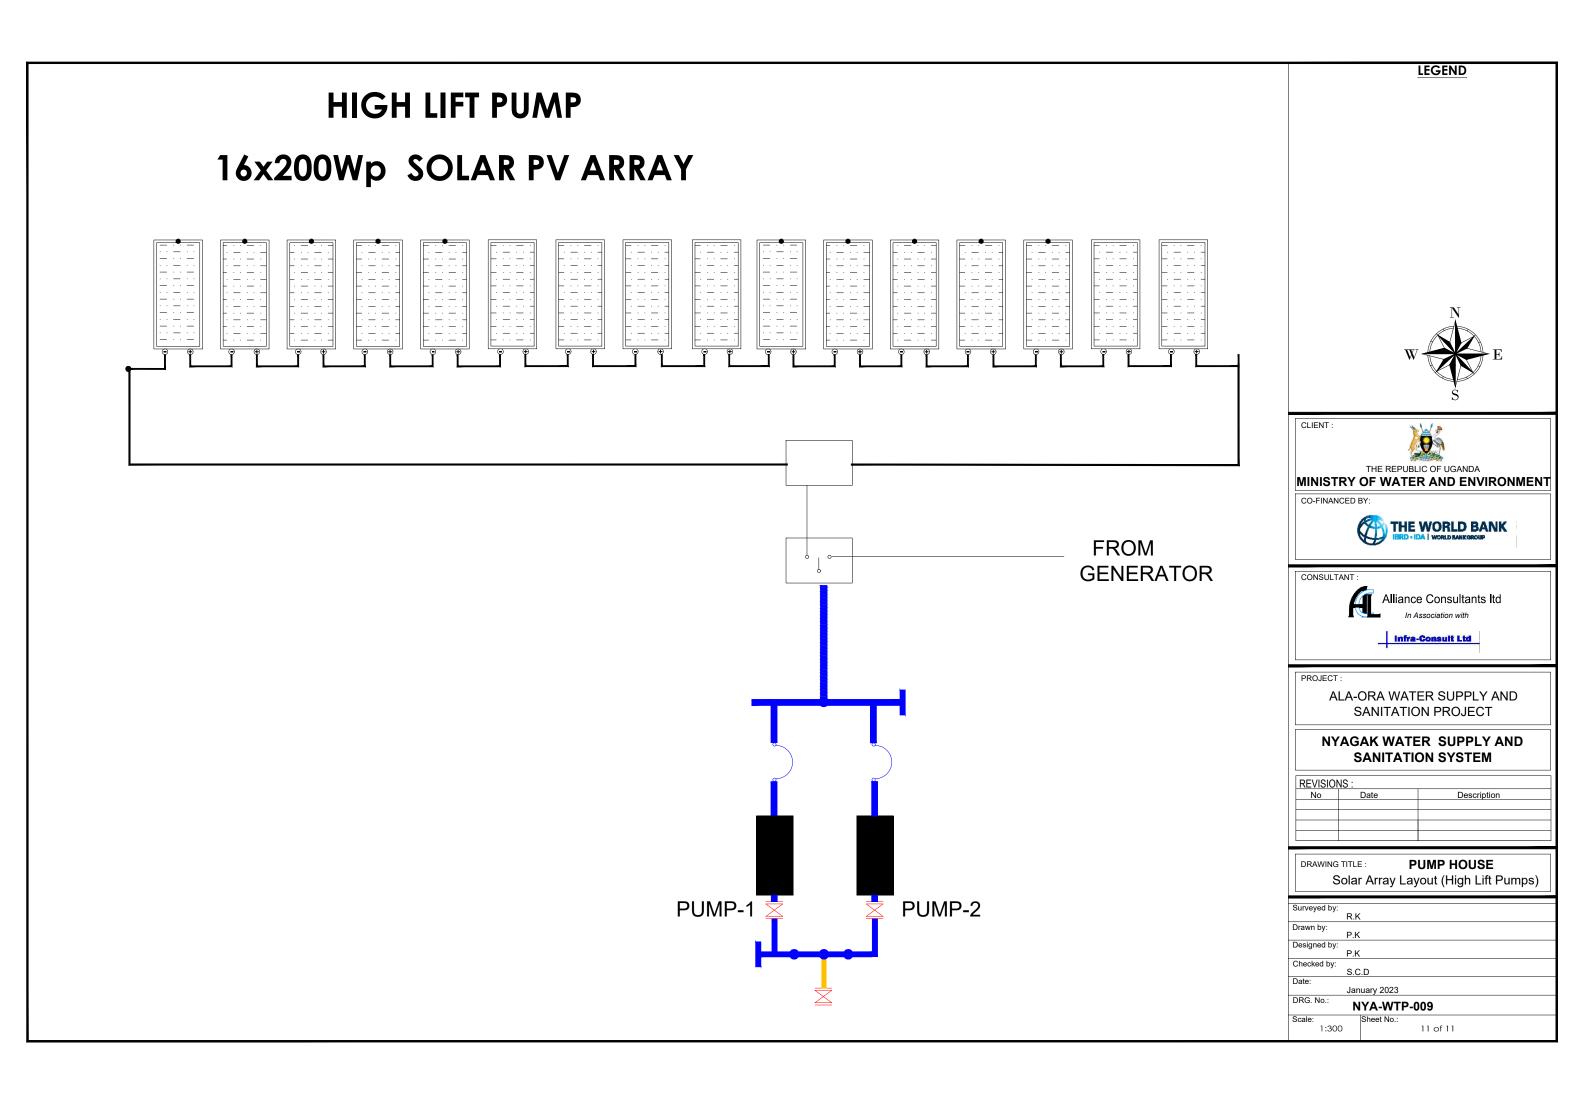


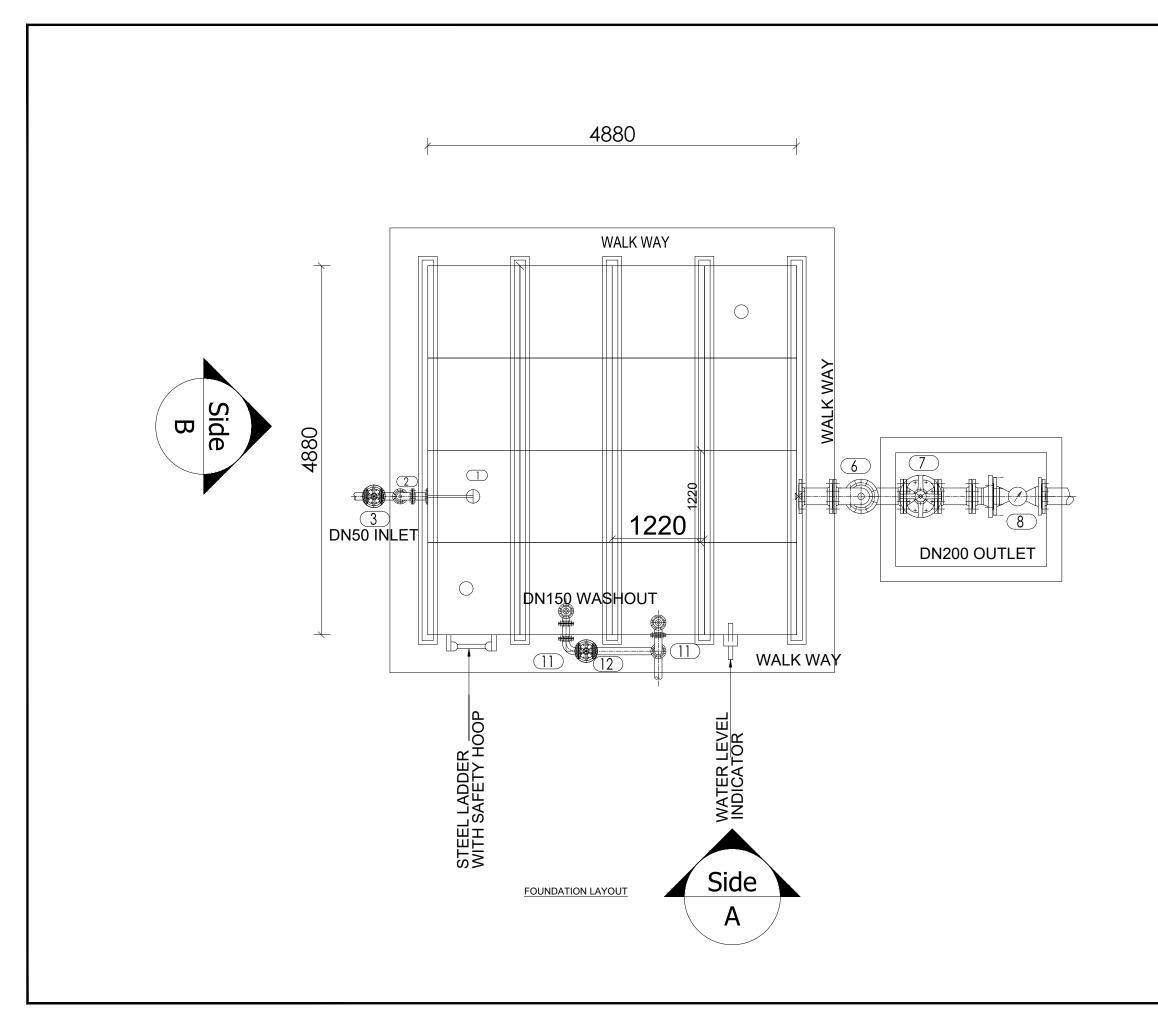


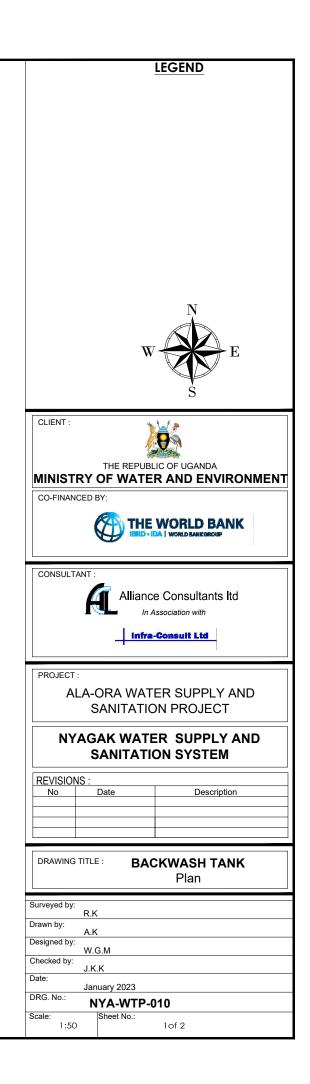


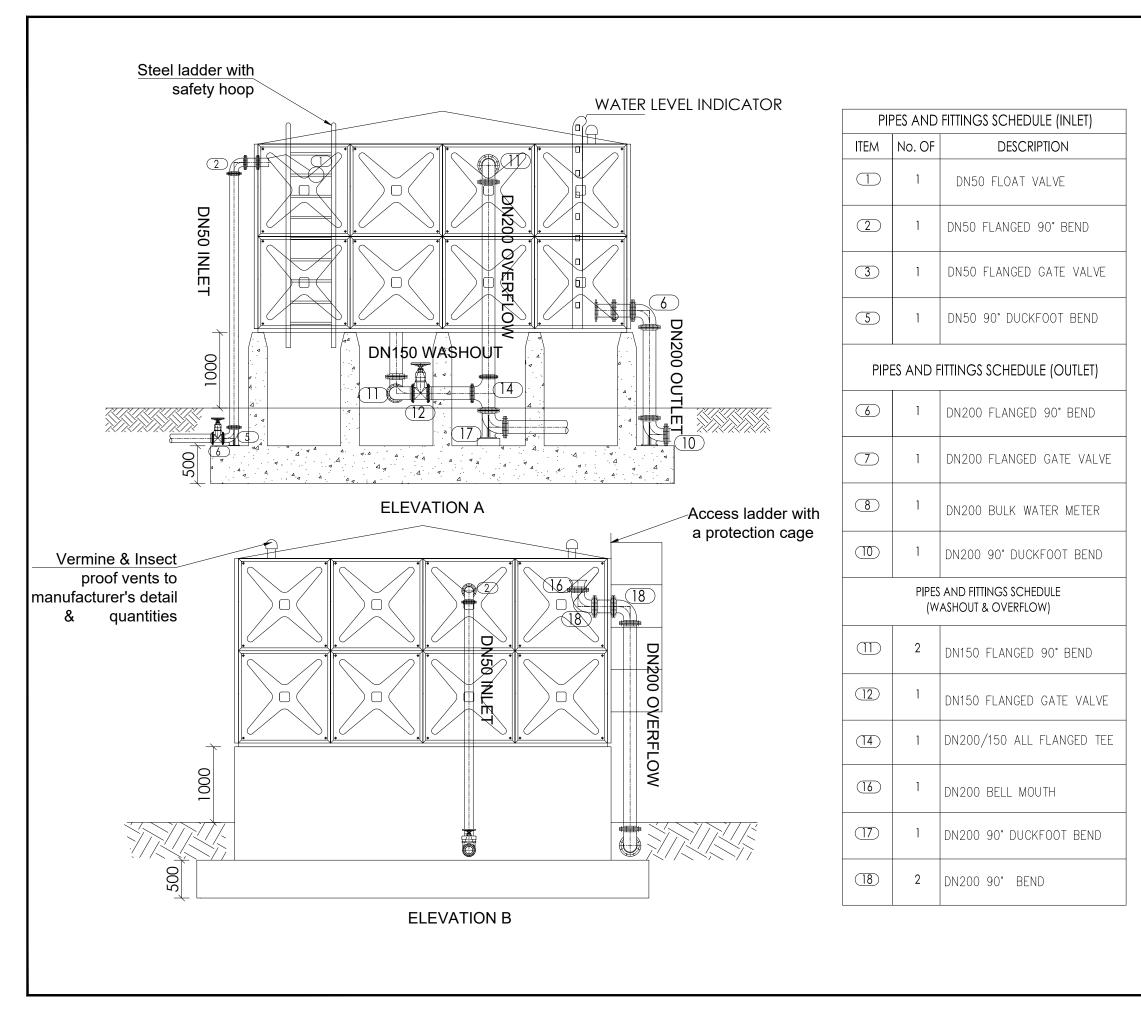

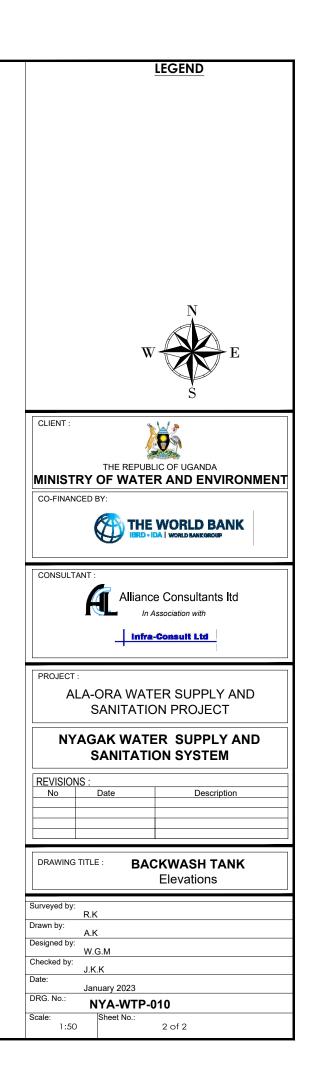


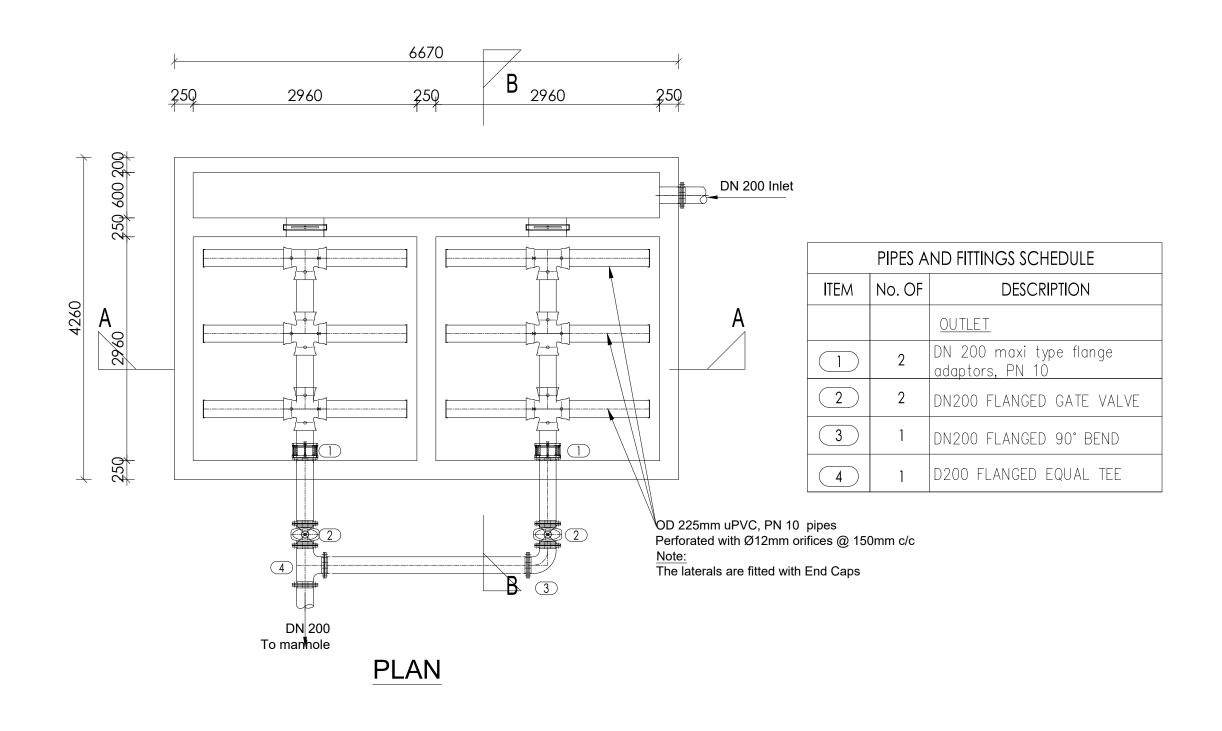

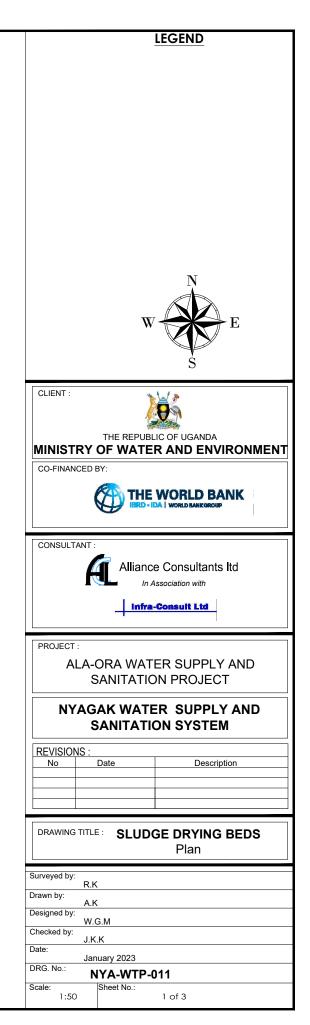


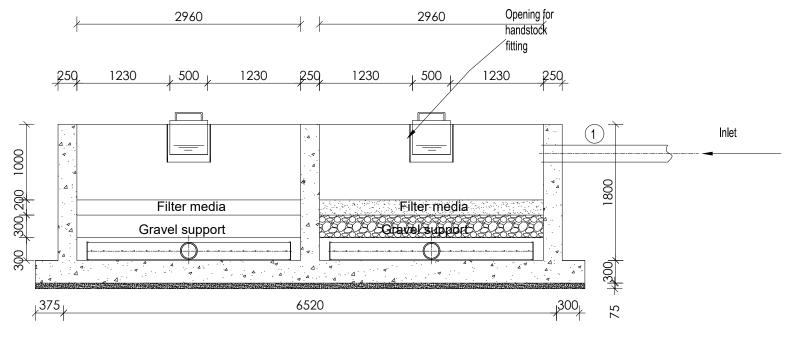


SECTION A-A

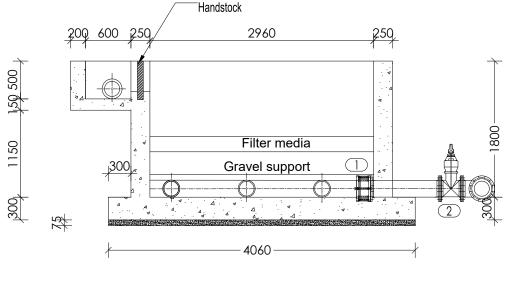



SECTION B-B

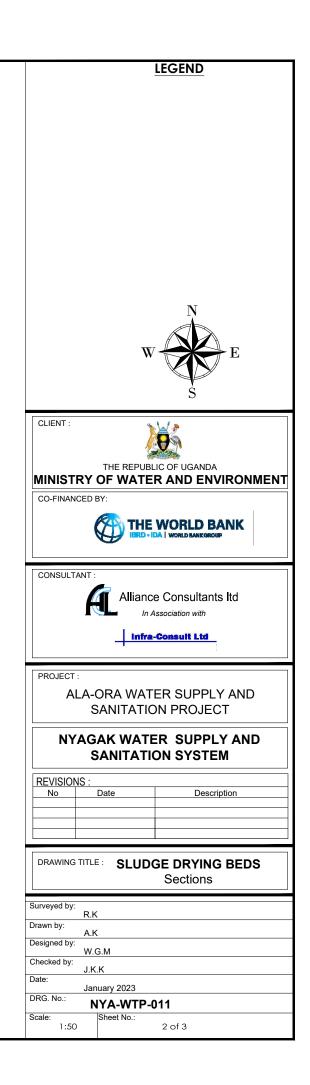


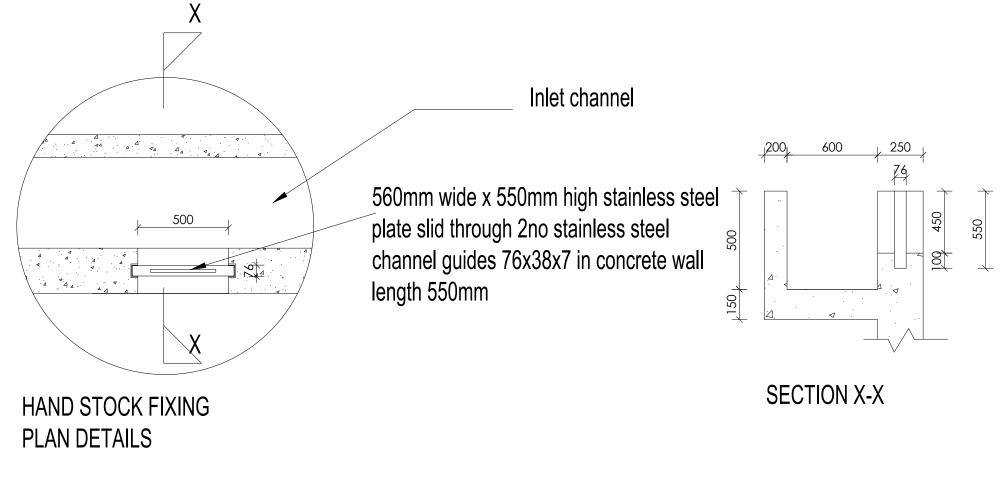



DETAIL a

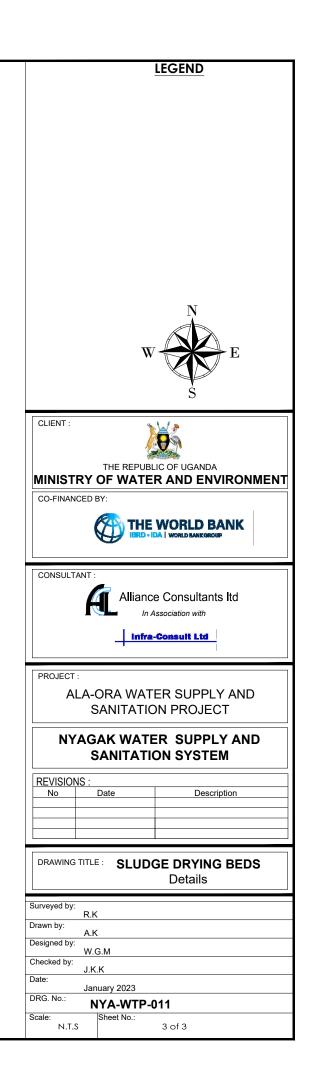


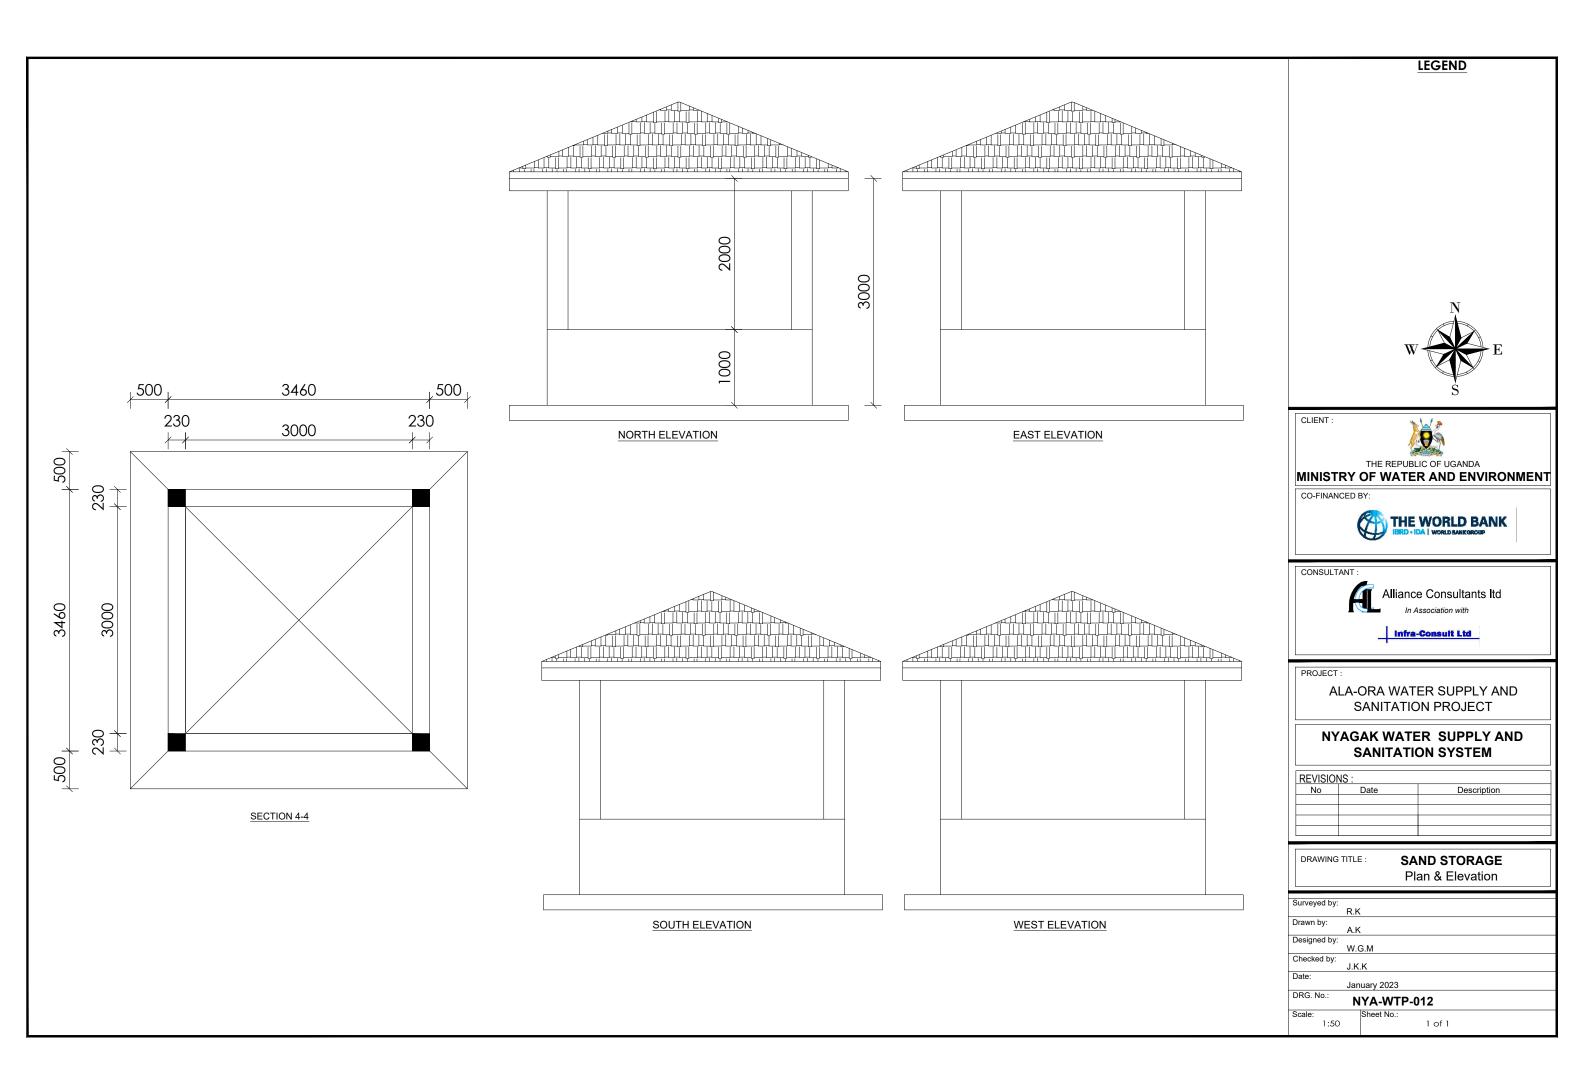

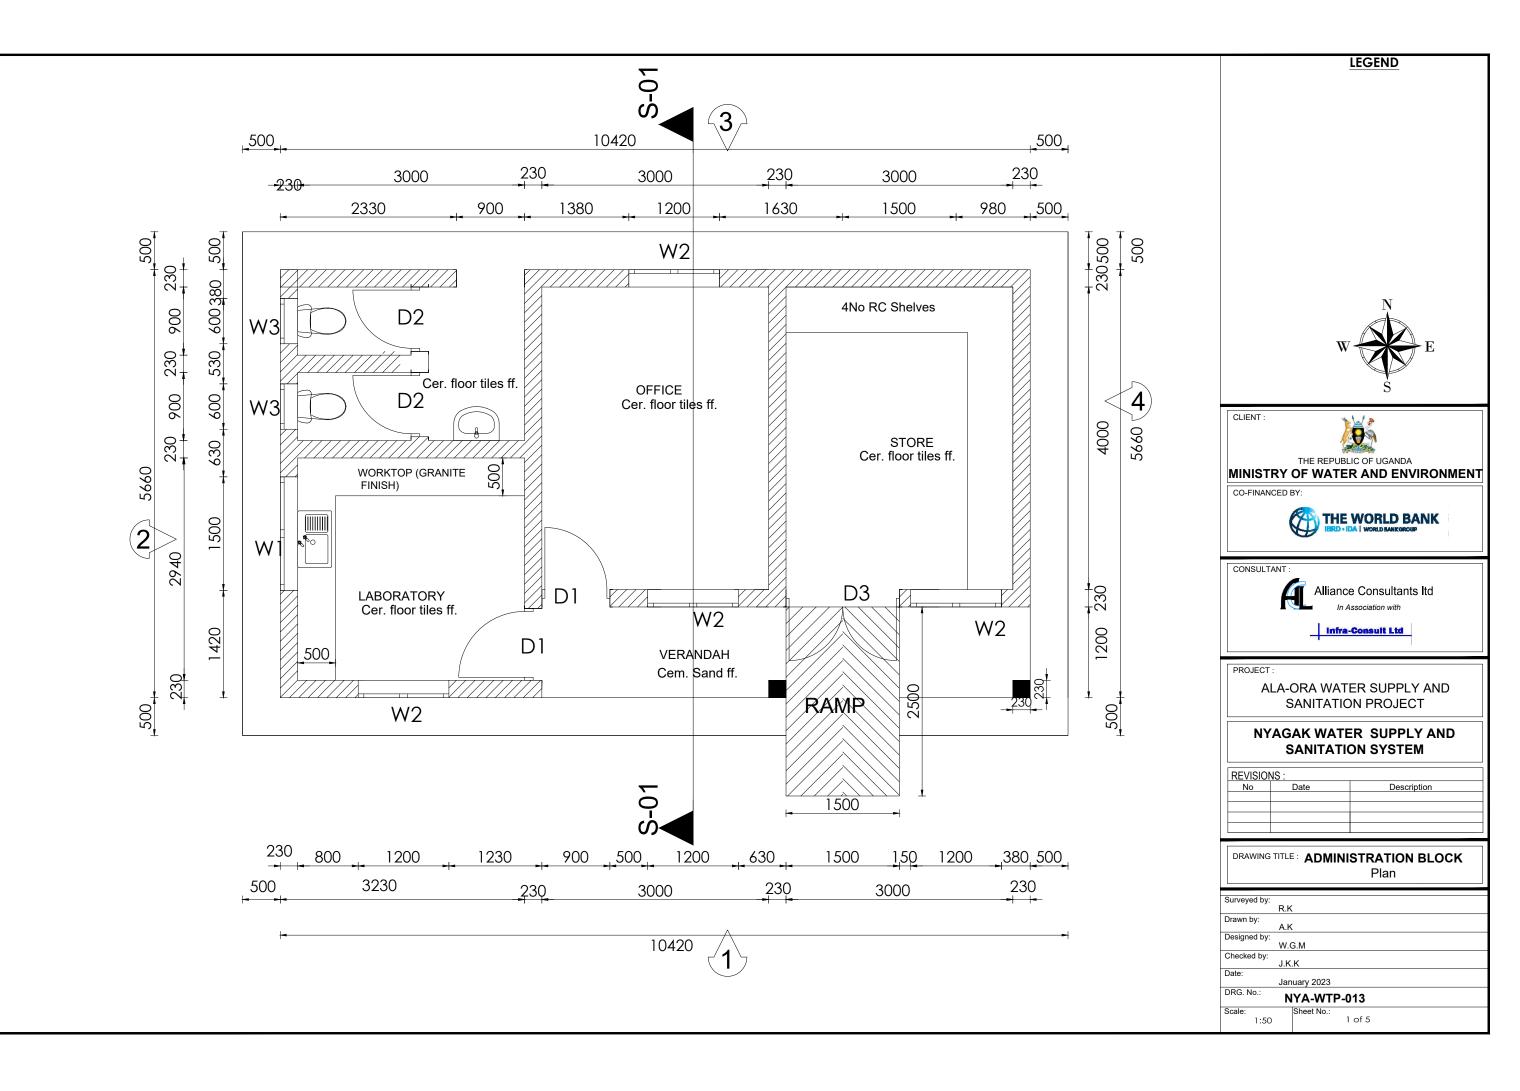


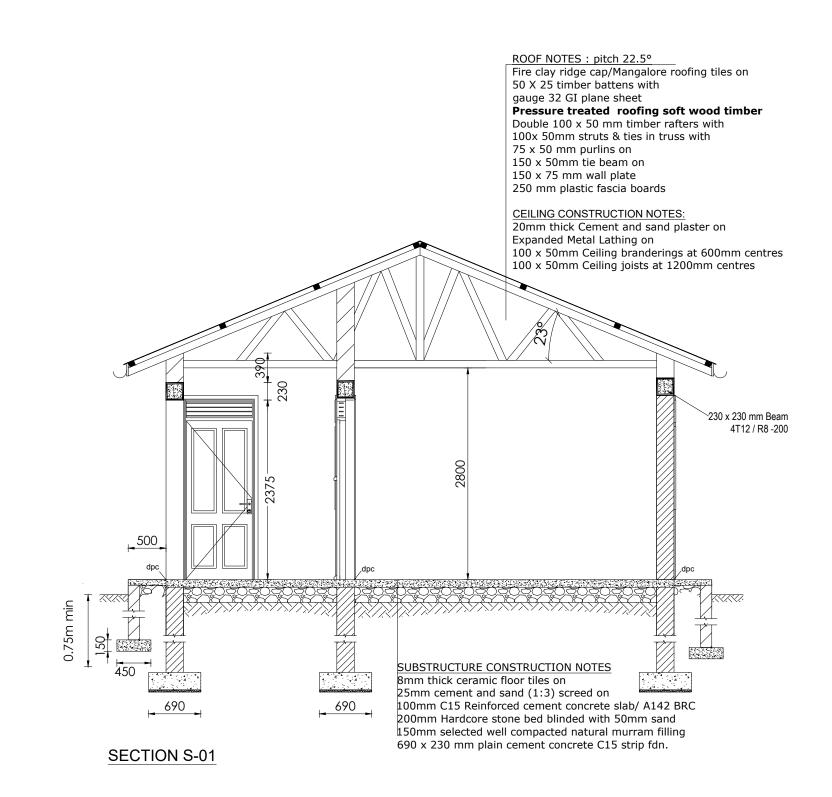


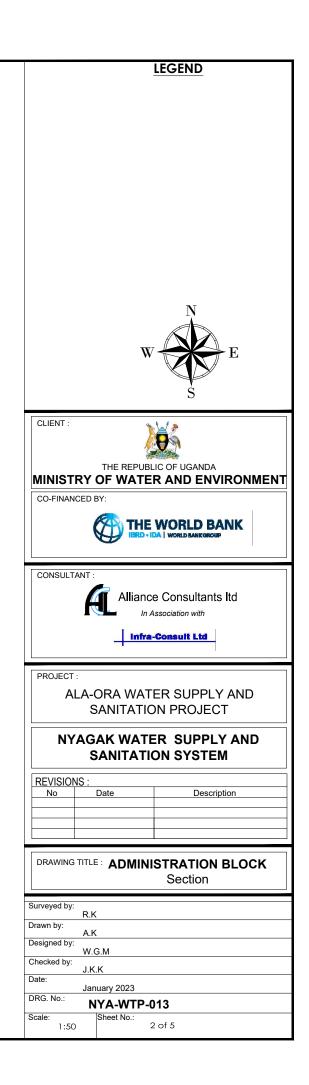

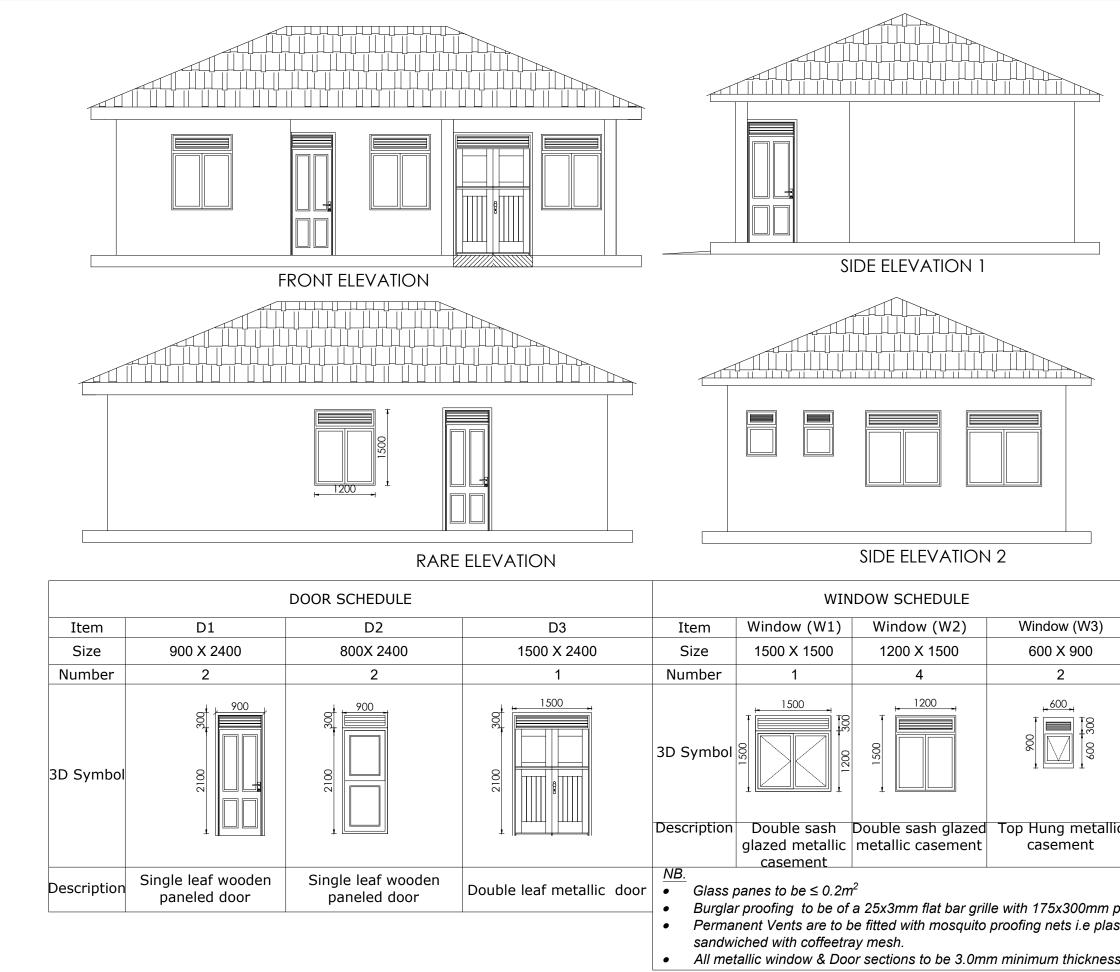



	-
	LEGEND
	N
	W
	S
	CLIENT :
	THE REPUBLIC OF UGANDA
	MINISTRY OF WATER AND ENVIRONMENT
	CO-FINANCED BY:
	CONSULTANT :
	Alliance Consultants Itd
	In Association with
	infra-Consult Ltd
	PROJECT :
	ALA-ORA WATER SUPPLY AND
	SANITATION PROJECT
	NYAGAK WATER SUPPLY AND
	SANITATION SYSTEM
	REVISIONS : No Date Description
	No Date Description
с	Elevations
C	Surveyed by:
	R.K Drawn by:
	A.K Designed by:
	W.G.M
oitch.	Checked by: J.K.K
stic net	Date: January 2023
	DRG. No.: NYA-WTP-013
s	Scale: Sheet No.:
-	1:75 3 of 5

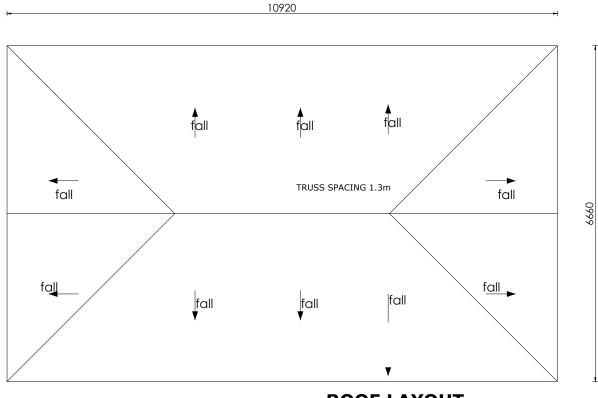


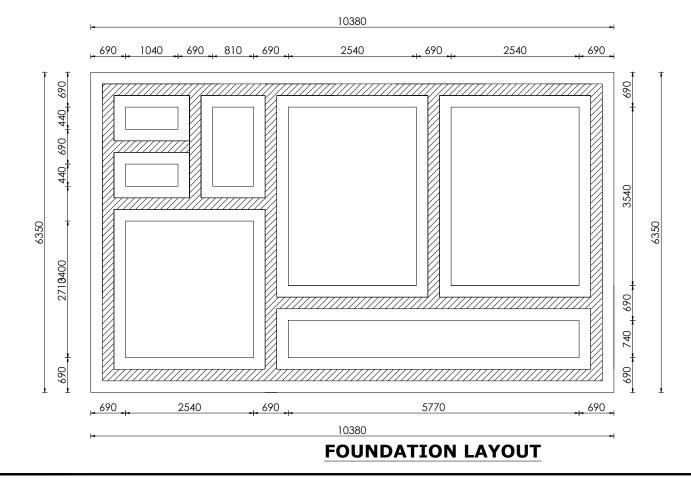





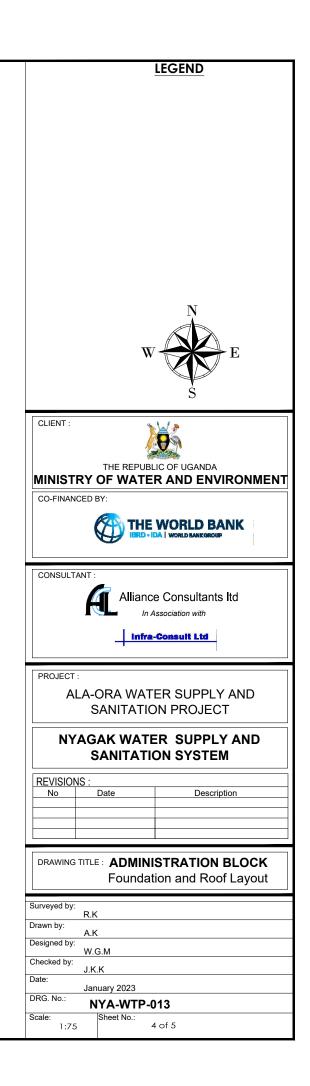

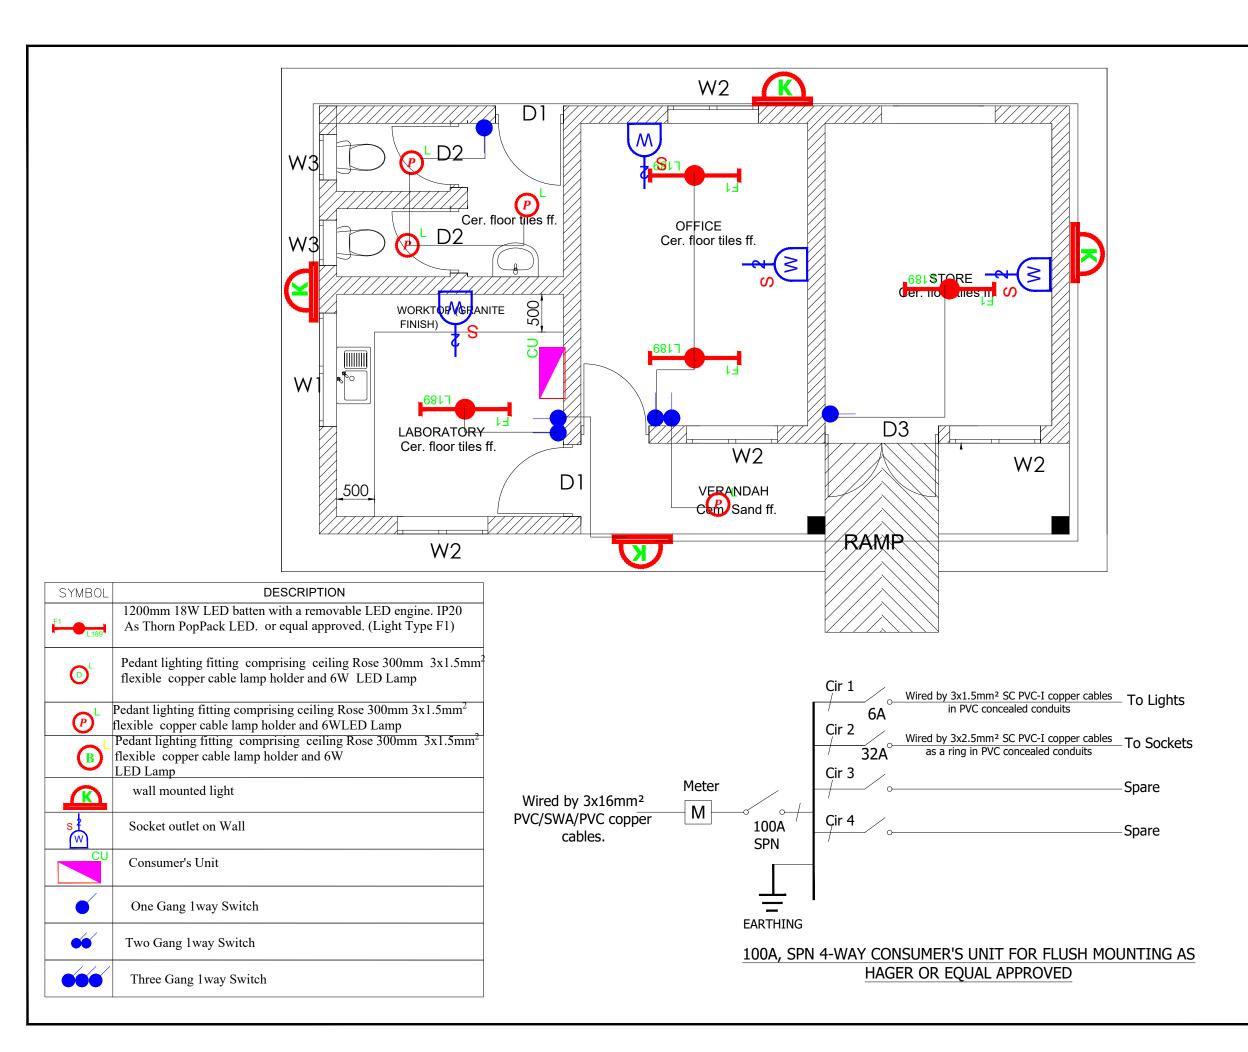

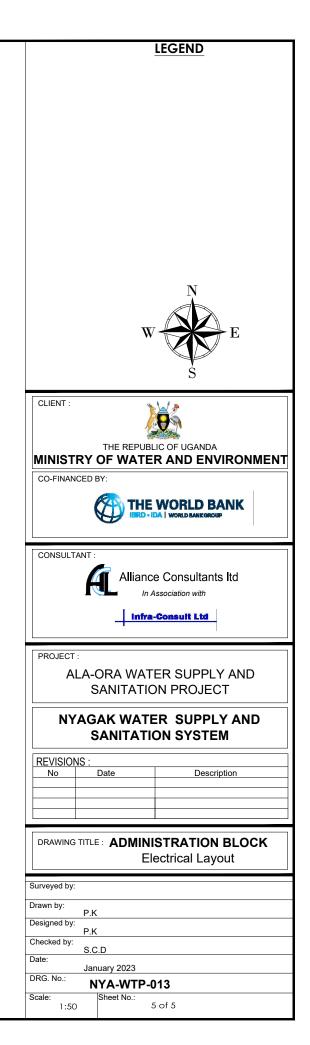

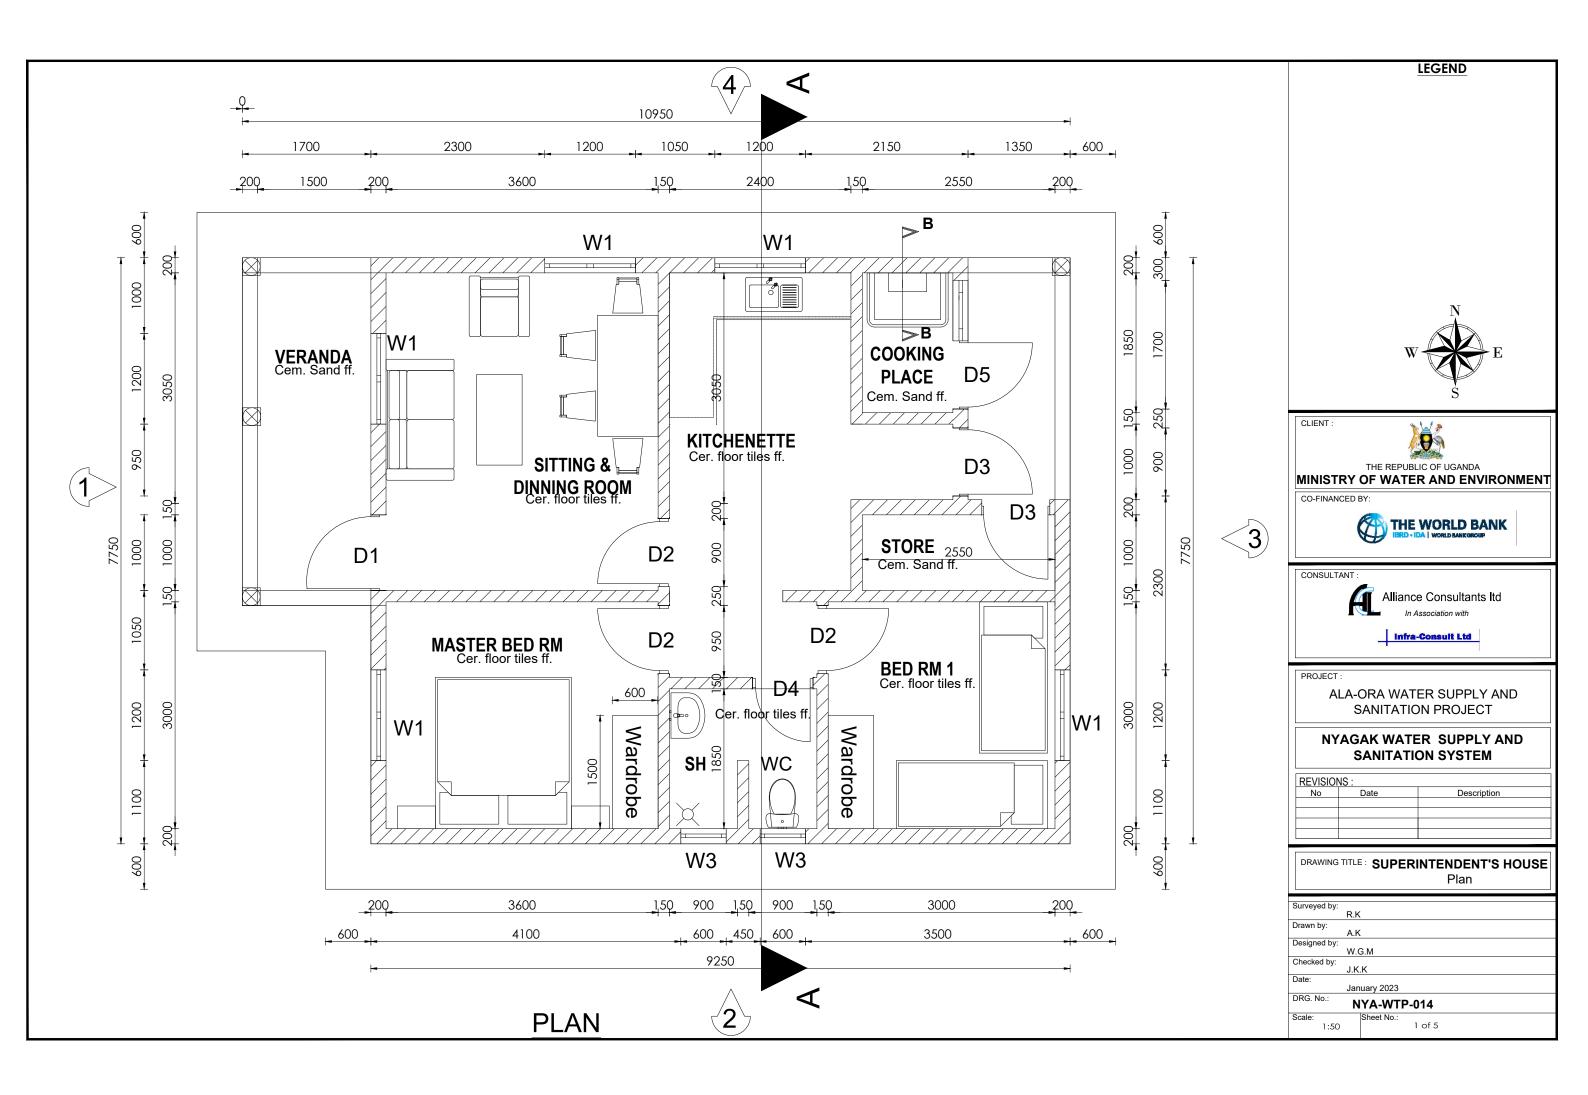


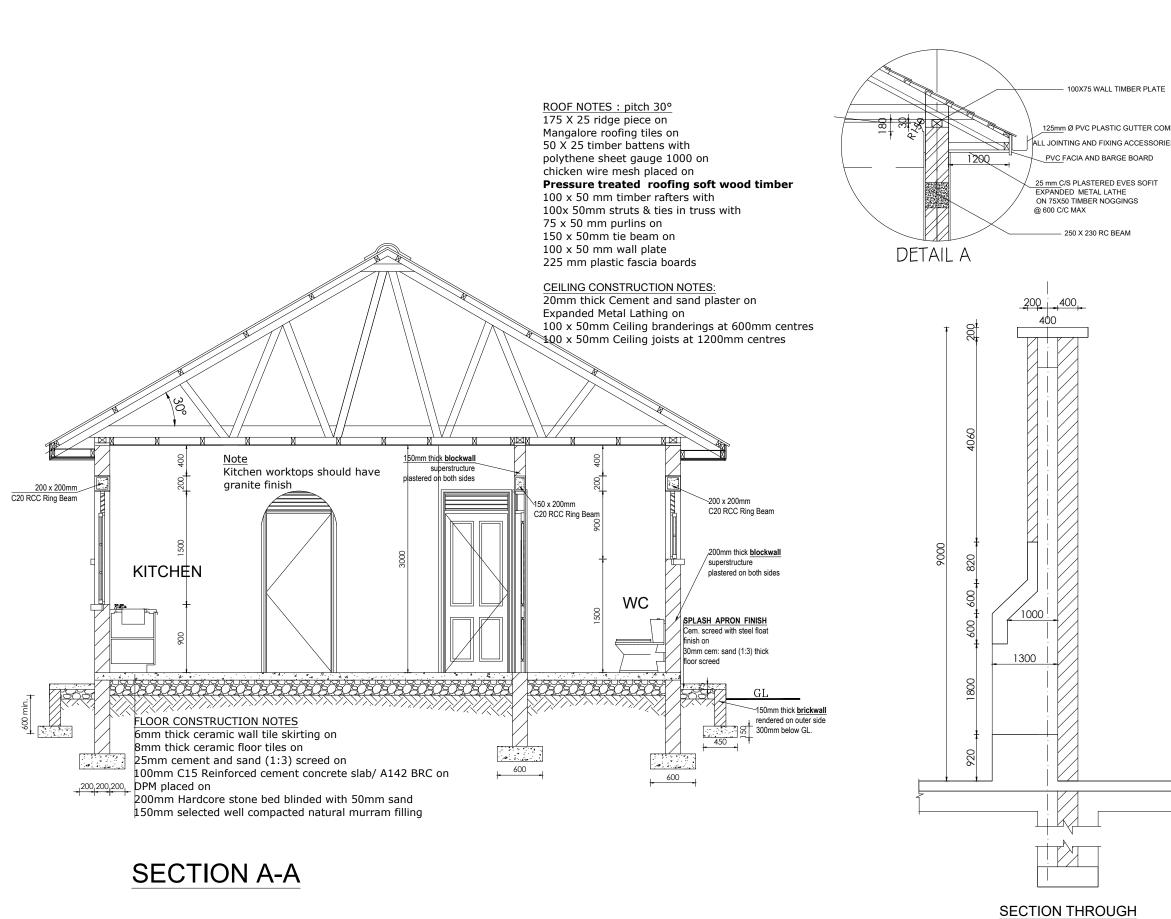

COOKING PLACE B-B


	LEGEND
E	
-	
OMPLTE WITH	
RIES, 2No. DOWN PIPES	
	Ņ
	W E
	Š
	CLIENT:
	THE REPUBLIC OF UGANDA
	CO-FINANCED BY:
	THE WORLD BANK
	CONSULTANT :
	Alliance Consultants Itd
	In Association with
	Infra-Consult Ltd
	PROJECT :
	ALA-ORA WATER SUPPLY AND
	SANITATION PROJECT
	NYAGAK WATER SUPPLY AND
	SANITATION SYSTEM
	REVISIONS : No Date Description
	DRAWING TITLE: SUPERINTENDENT'S HOUSE
_	Section and Details
	Surveyed by:
	R.K Drawn by:
	A.K
	Designed by: W.G.M
	Checked by: J.K.K
	Date:
	January 2023 DRG. No.: NIXA NATE Of 4
	NYA-WIP-014
	Scale: Sheet No.:
	1:50 2 of 5




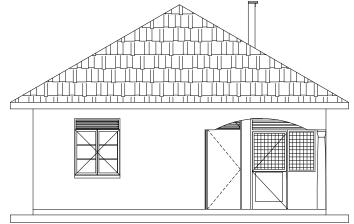


ELEVATION 3


ELEVATION 4

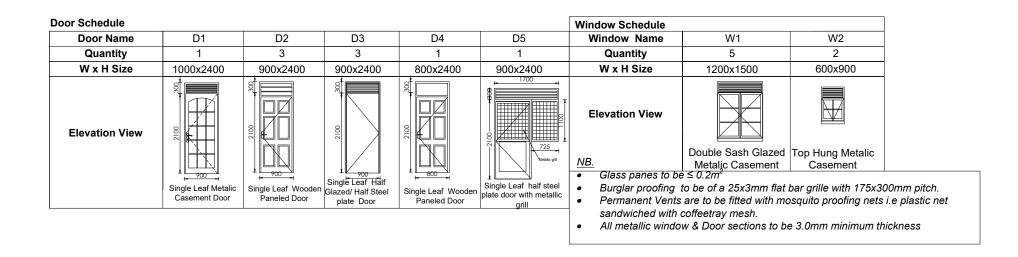


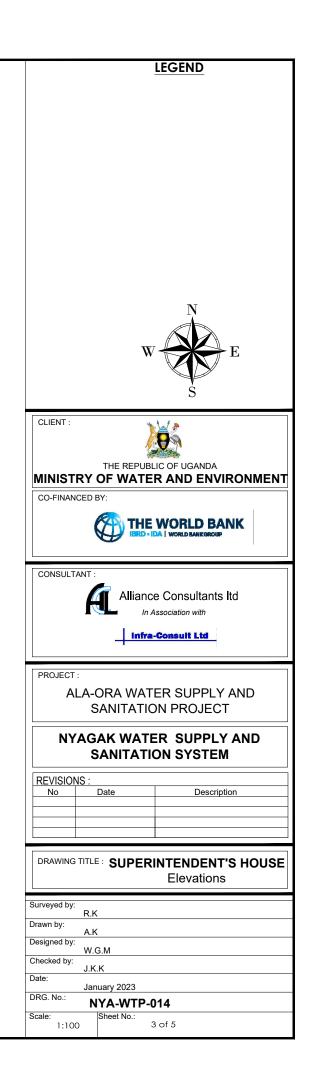


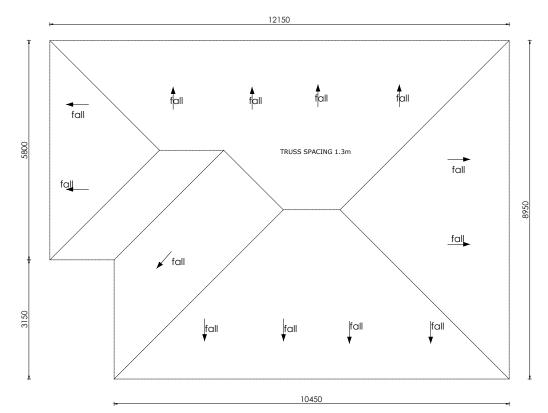




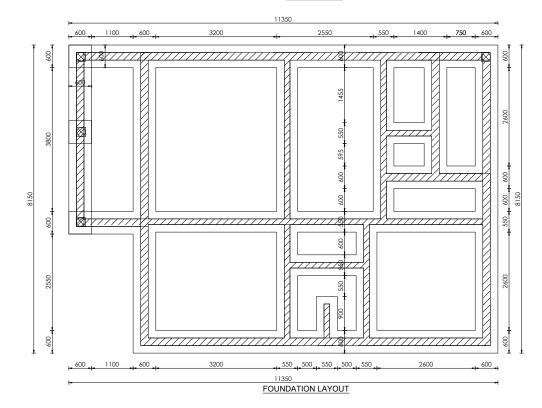


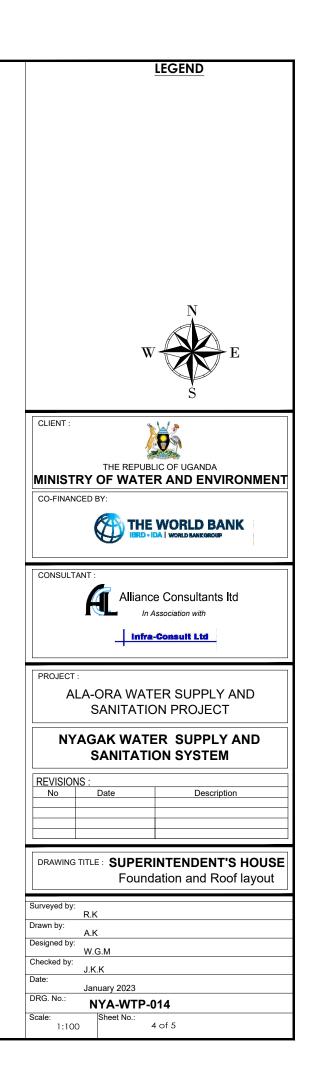


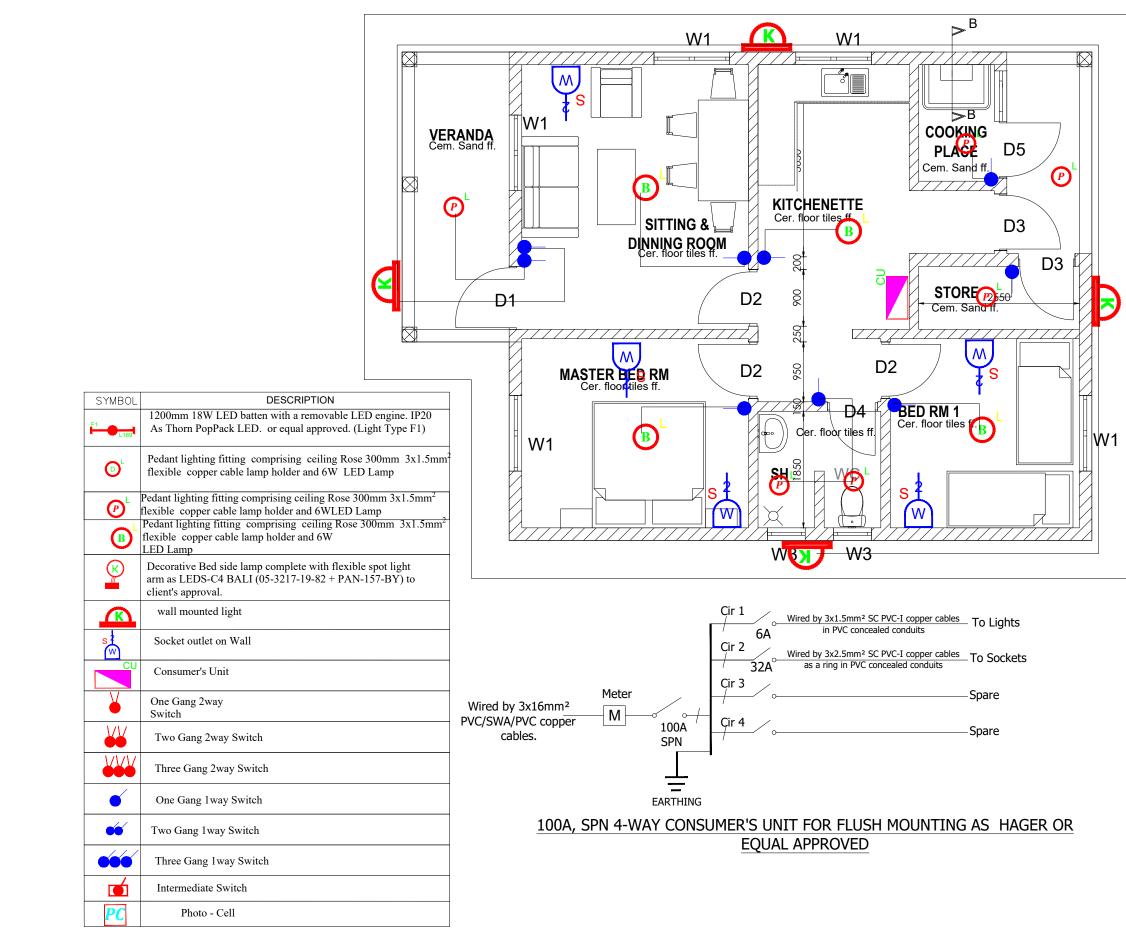



	LEGEND
Г	
	W E S
	CLIENT :
	THE REPUBLIC OF UGANDA
	MINISTRY OF WATER AND ENVIRONMENT
	CO-FINANCED BY:
	THE WORLD BANK
	CONSULTANT :
	Alliance Consultants Itd
	In Association with
	Infra-Consult Ltd
	PROJECT :
	ALA-ORA WATER SUPPLY AND SANITATION PROJECT
	NYAGAK WATER SUPPLY AND SANITATION SYSTEM
	REVISIONS :
	No Date Description
	DRAWING TITLE : SUPERINTENDENT'S HOUSE Electrical layout
	Surveyed by:
	R.K Drawn by:
	P.K Designed by:
	P.K Checked by:
	S.C.D Date:
	January 2023 DRG. No.: NYA-WTP-014
	Scale: Sheet No.:
	1:60 5 of 5

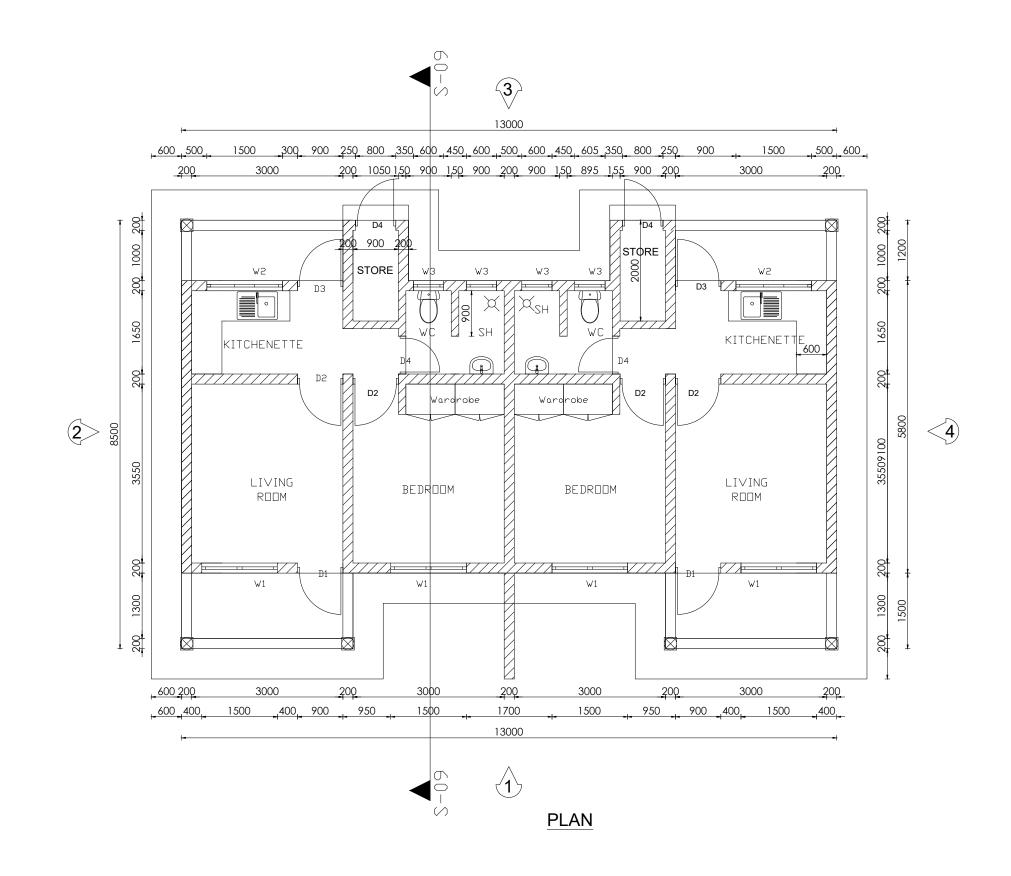

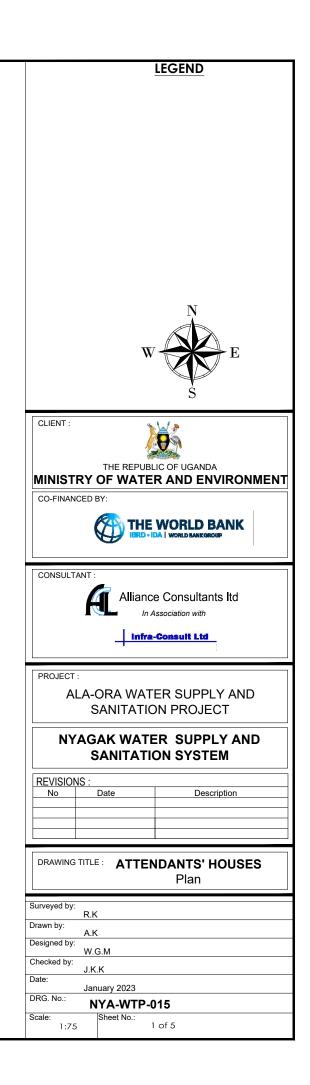


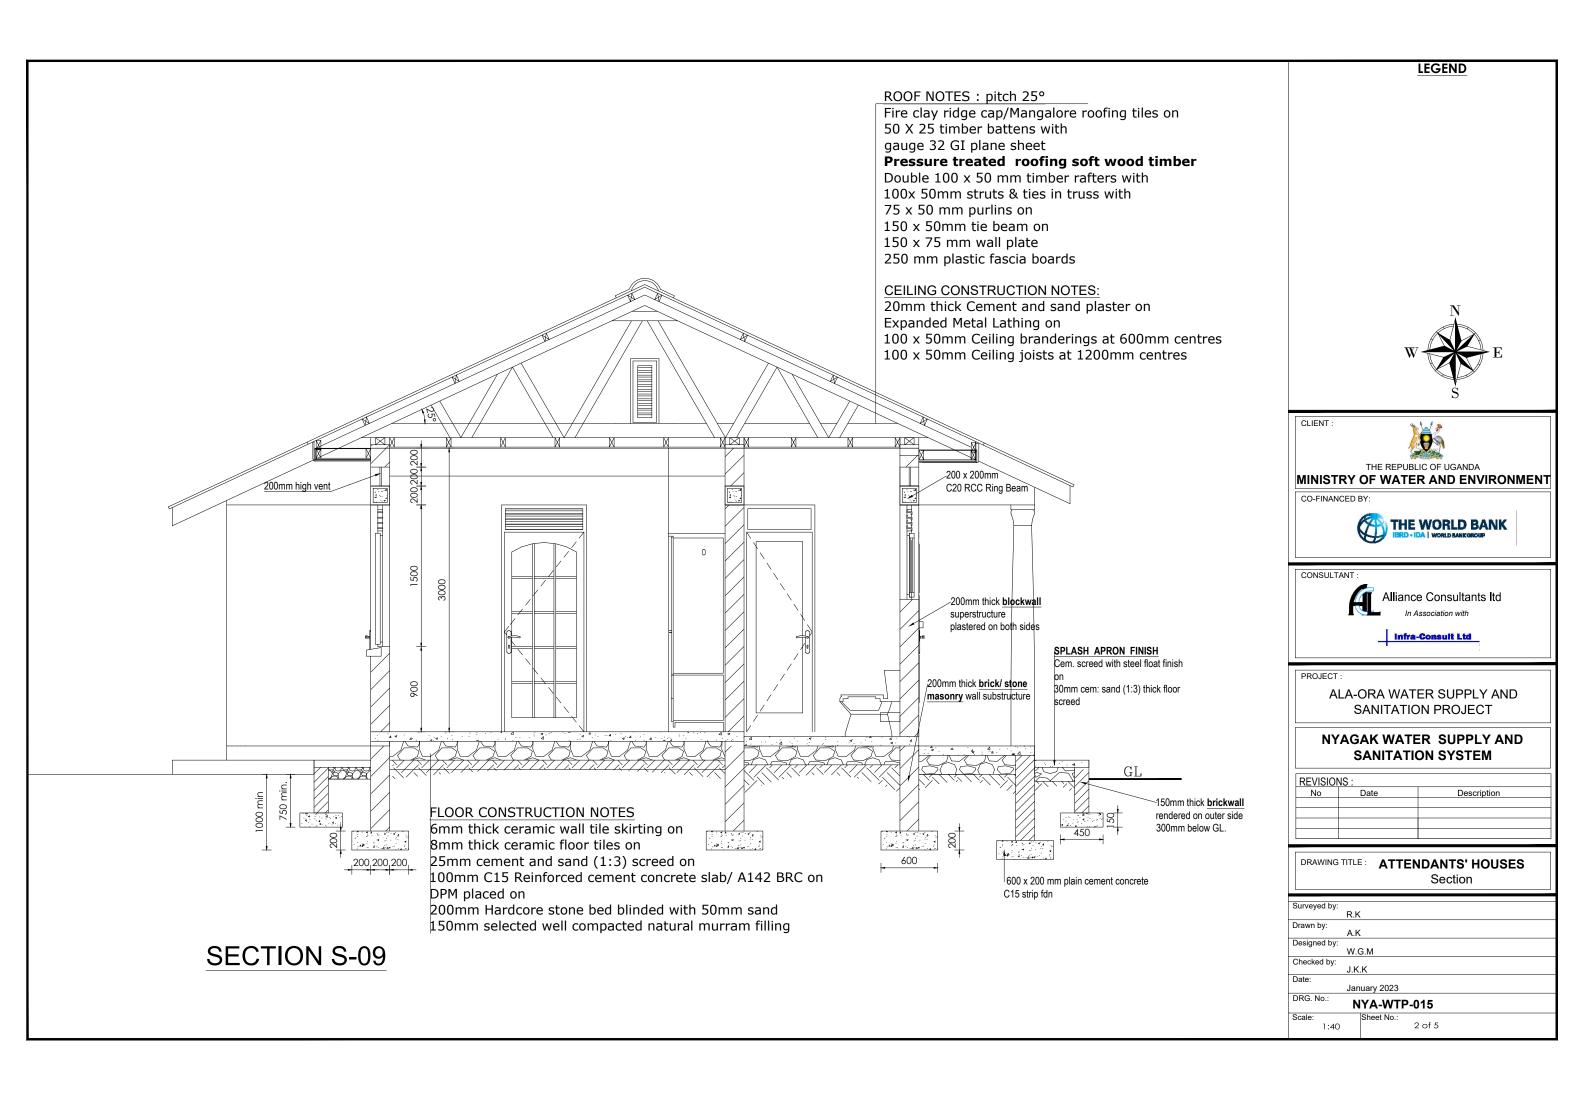

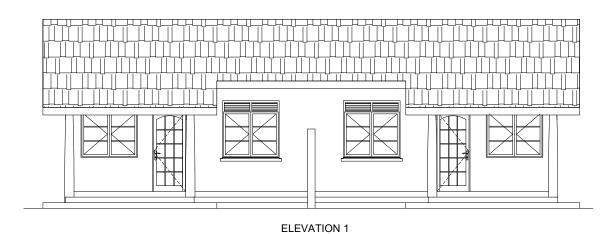

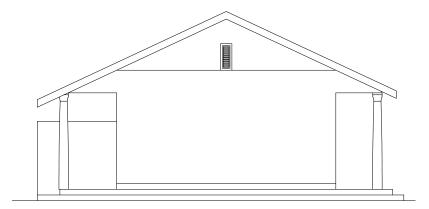


ELEVATION 2

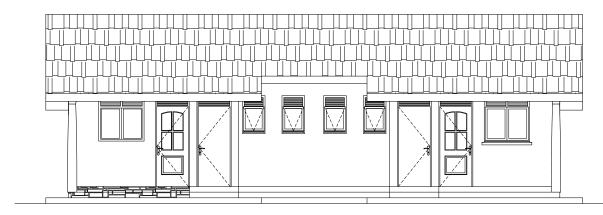



ELEVATION 4


ELEVATION 3

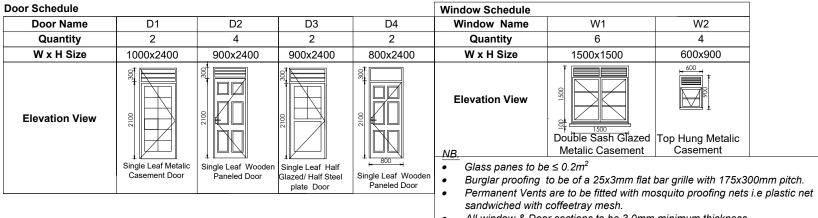


All window & Door sections to be 3.0mm minimum thickness

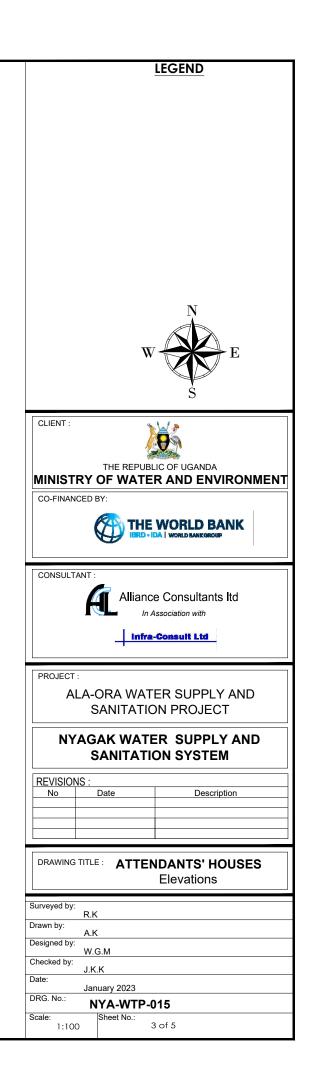


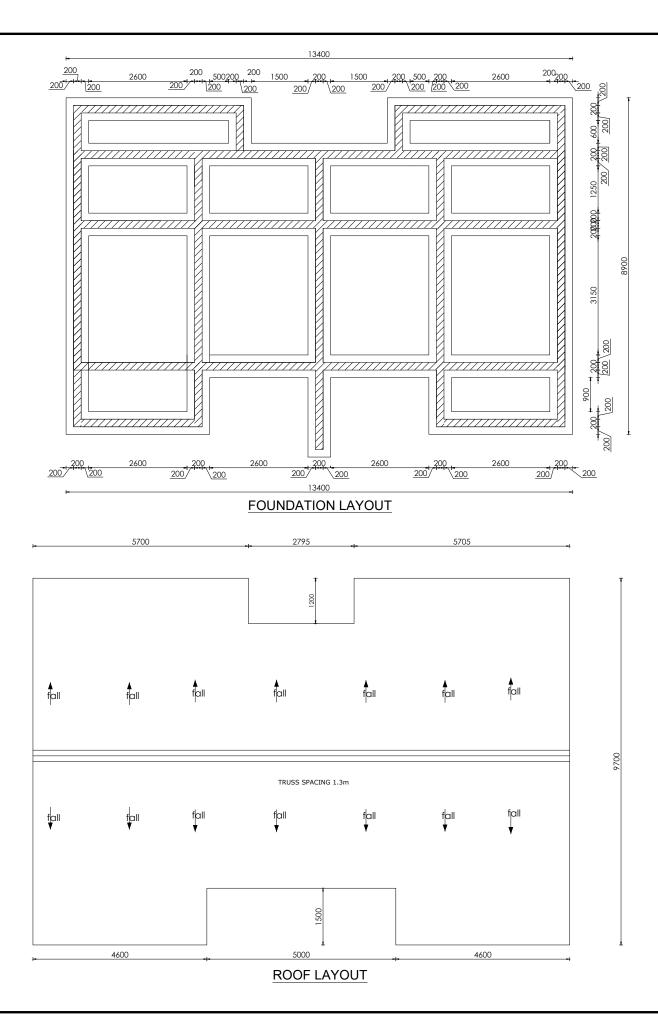


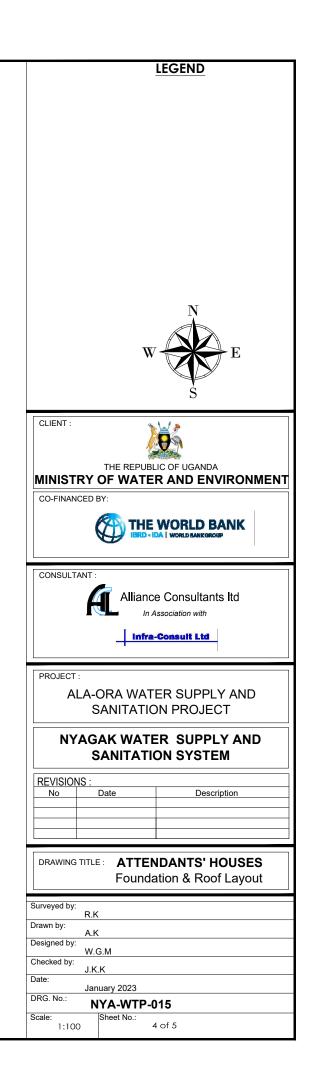


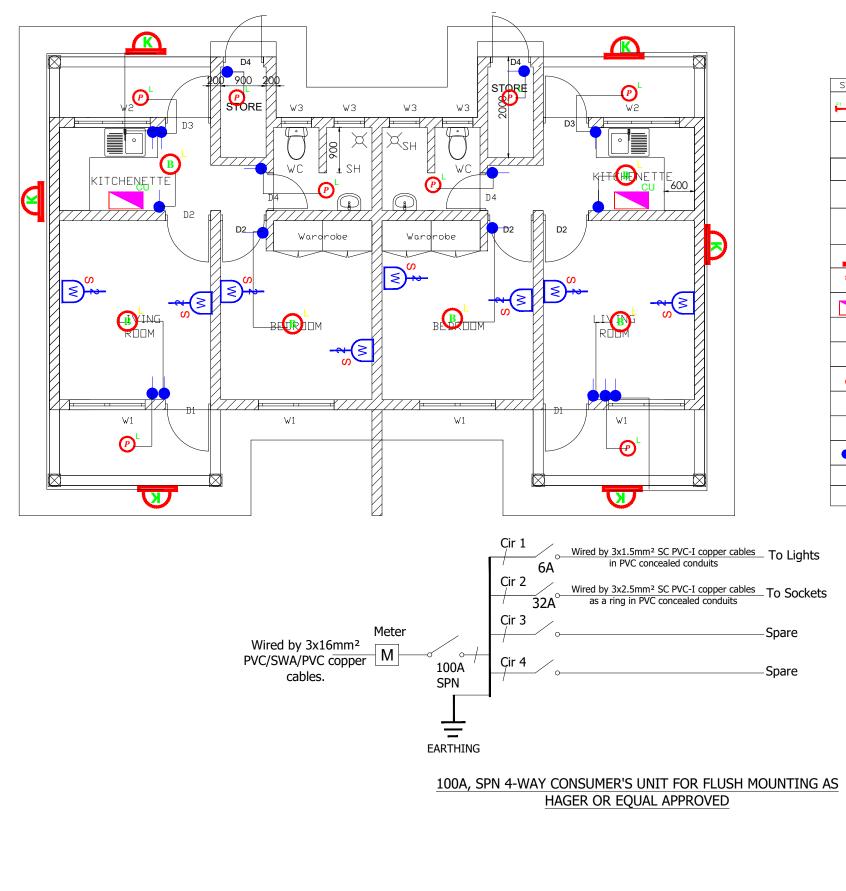



SYMBOL	DESCRIPTION
	1200mm 18W LED batten with a removable LED engine. IP20 As Thorn PopPack LED. or equal approved. (Light Type F1)
٥	Pedant lighting fitting comprising ceiling Rose 300mm 3x1.5mm flexible copper cable lamp holder and 6W LED Lamp
Ø	Pedant lighting fitting comprising ceiling Rose 300mm 3x1.5mm ² flexible copper cable lamp holder and 6WLED Lamp
₿	Pedant lighting fitting comprising ceiling Rose 300mm 3x1.5mm ² flexible copper cable lamp holder and 6W LED Lamp
	Decorative Bed side lamp complete with flexible spot light arm as LEDS-C4 BALI (05-3217-19-82 + PAN-157-BY) to client's approval.
	wall mounted light
s‡ M	Socket outlet on Wall
CU	Consumer's Unit
¥	One Gang 2way Switch
¥¥	Two Gang 2way Switch
	Three Gang 2way Switch
•	One Gang 1way Switch
**	Two Gang Iway Switch
666	Three Gang Iway Switch
	Intermediate Switch
PC	Photo - Cell

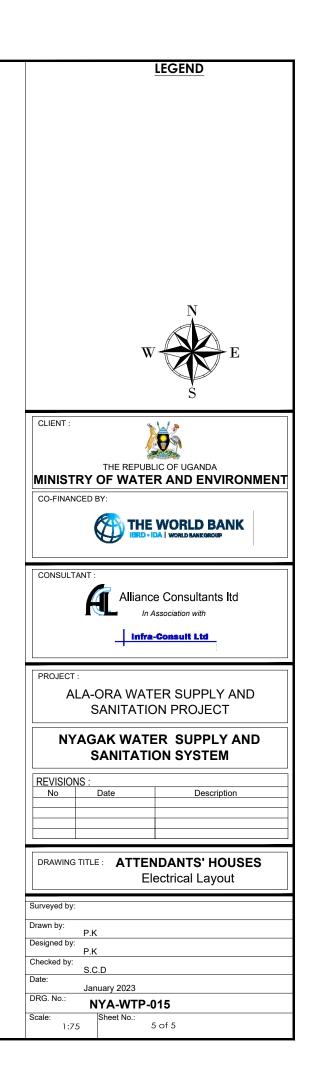


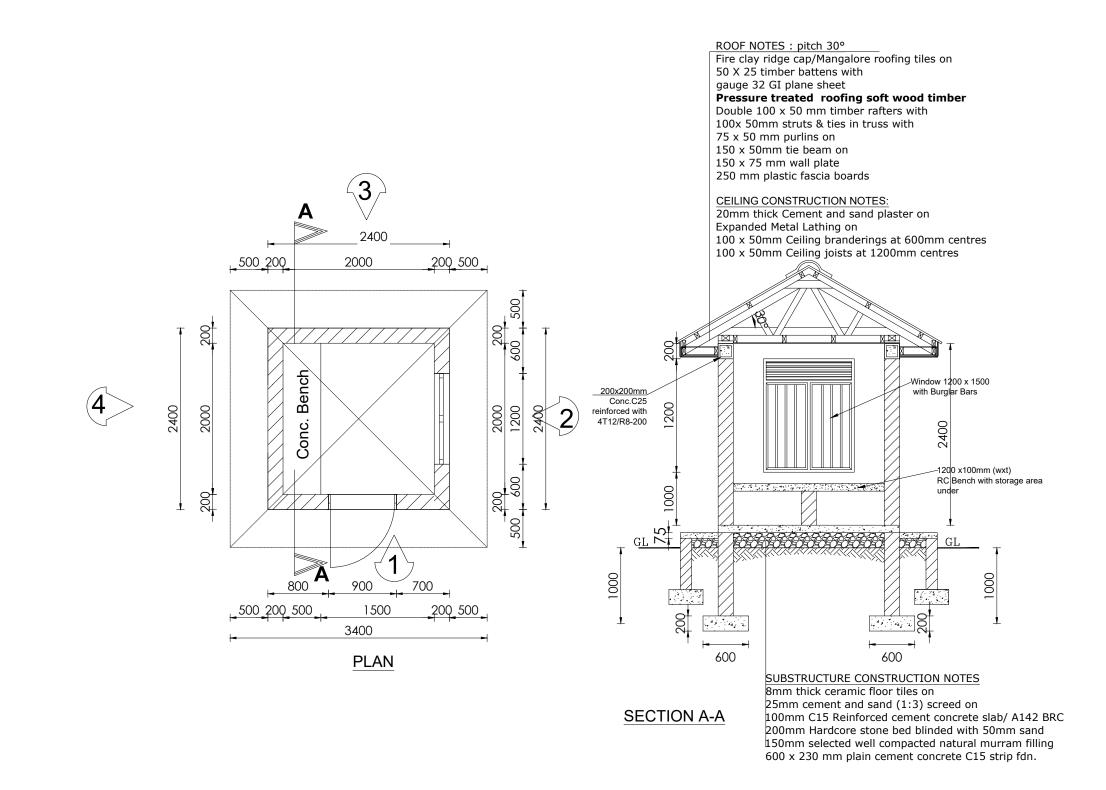


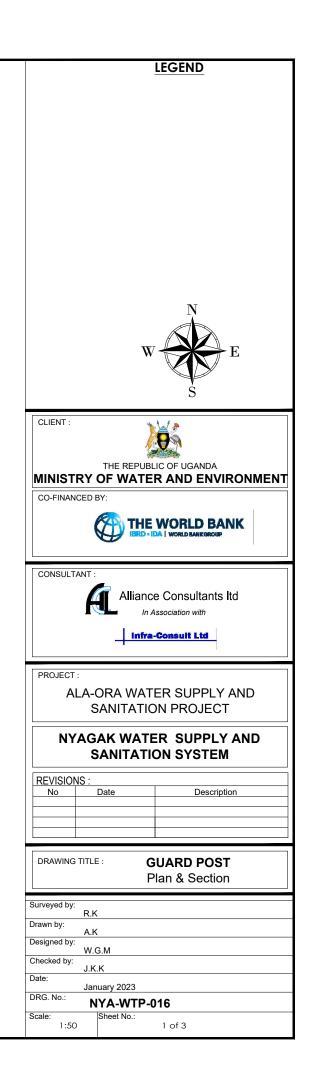


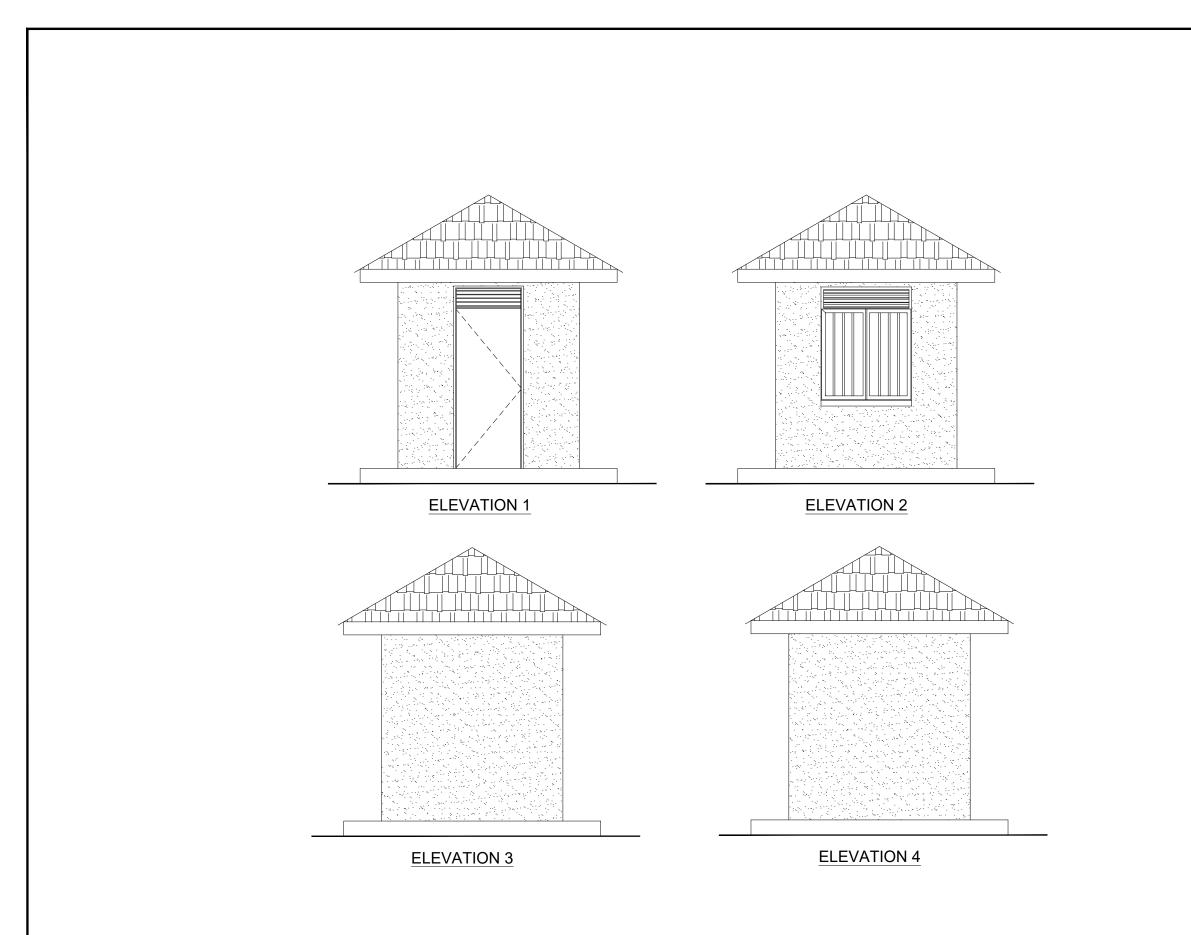


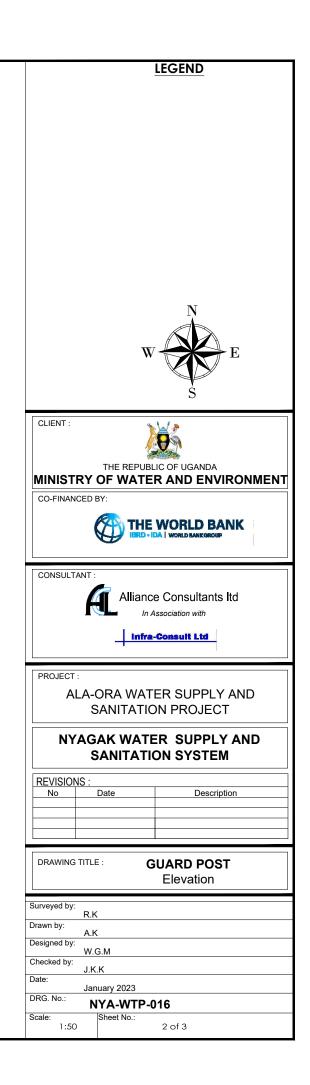


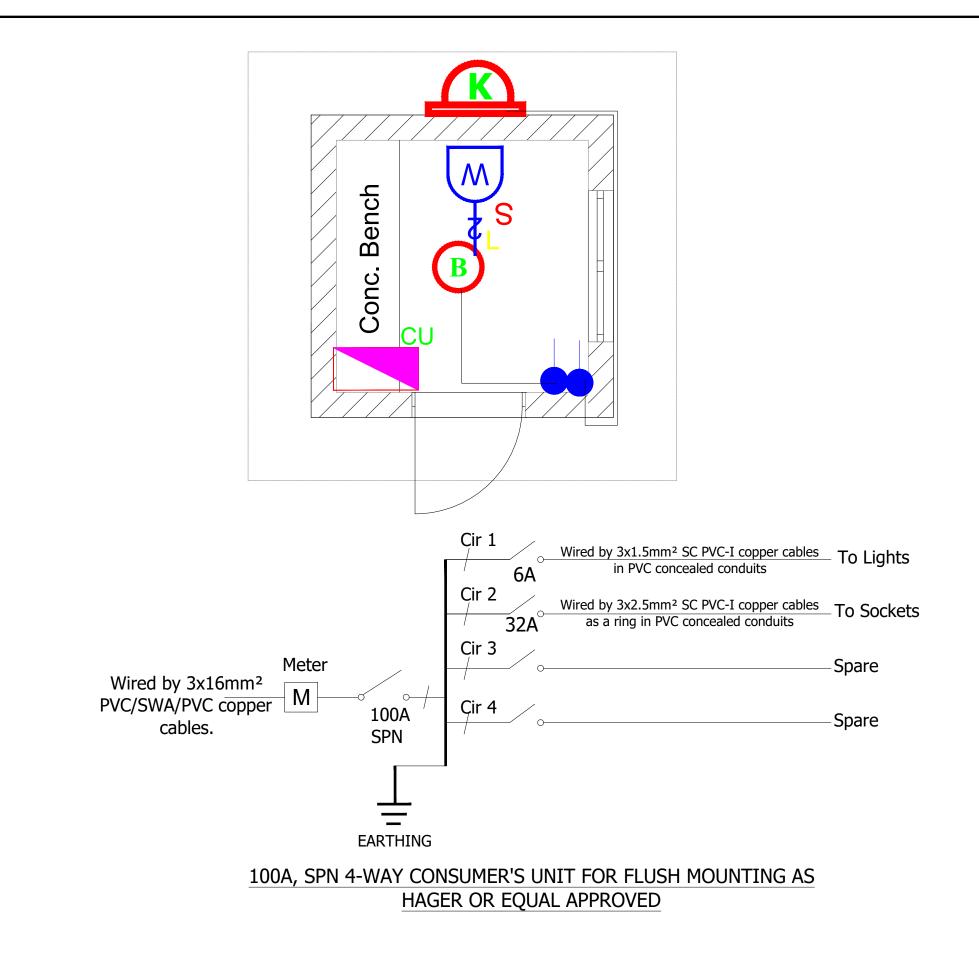


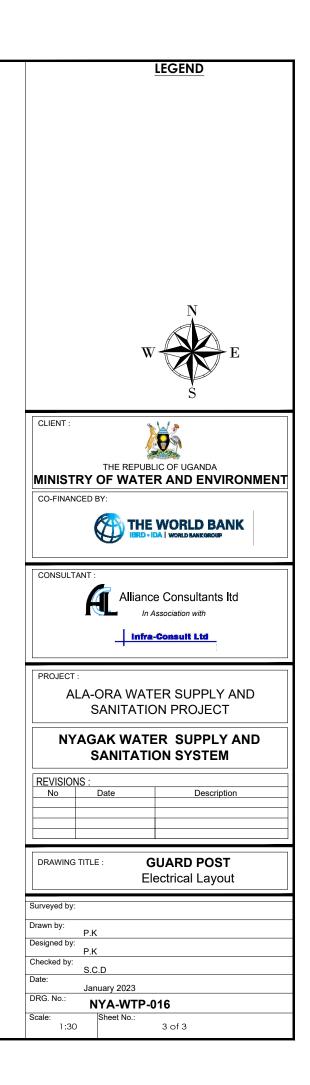


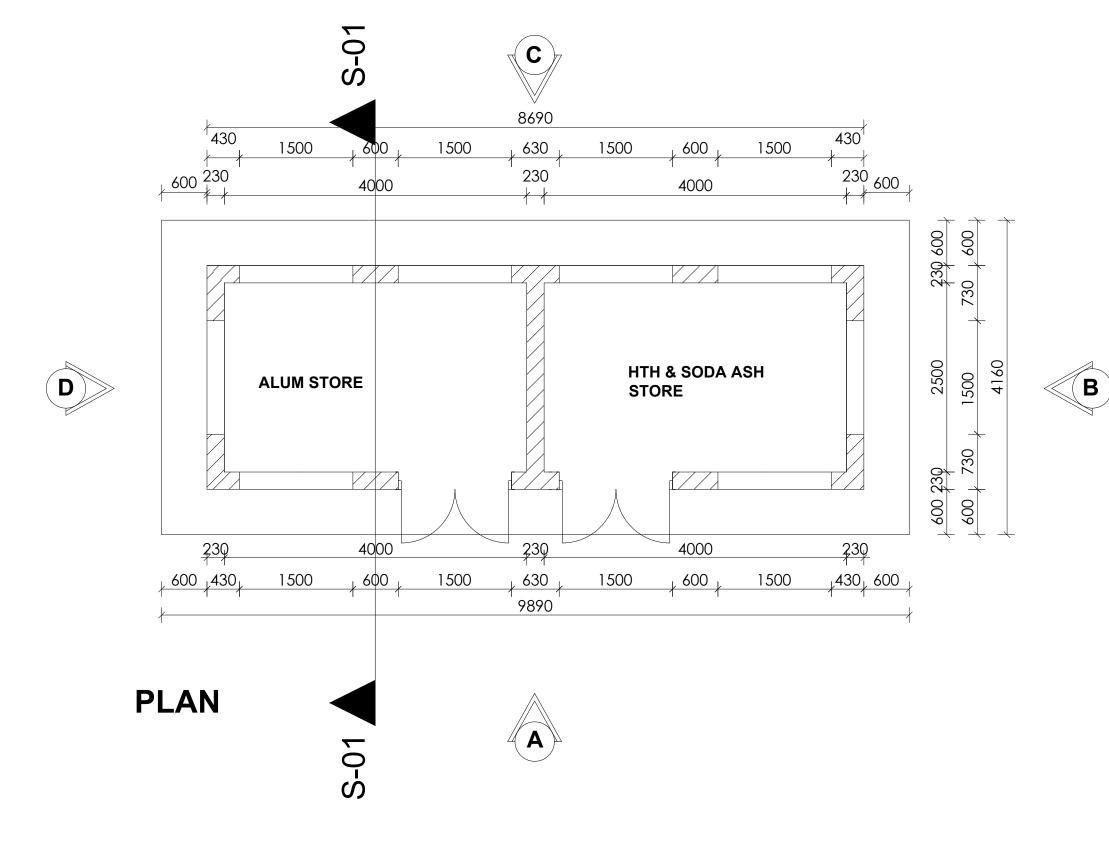

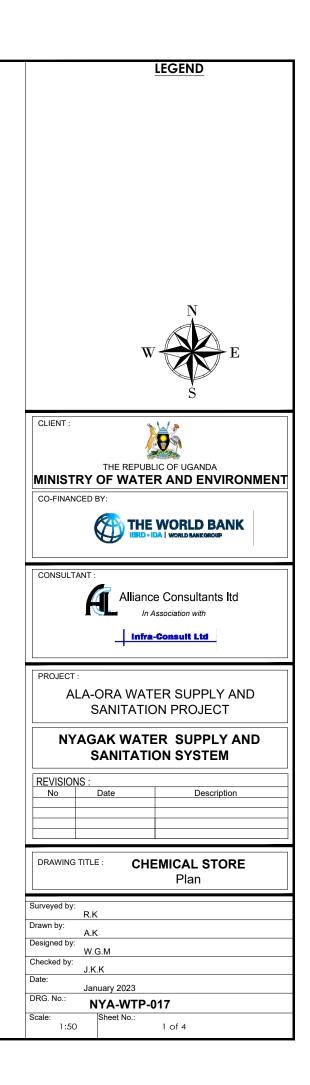


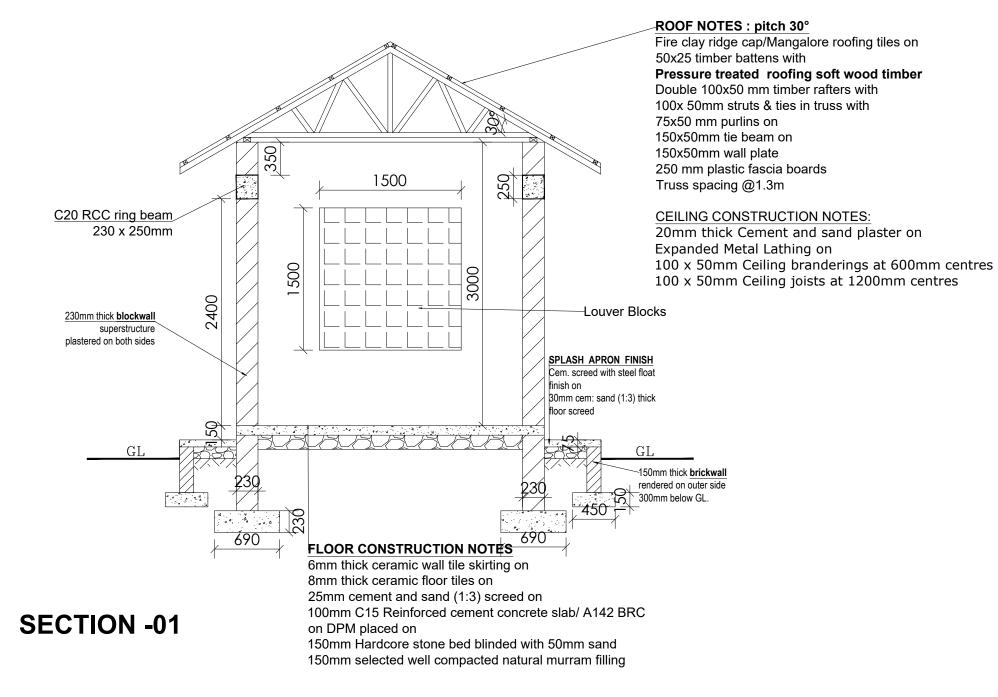


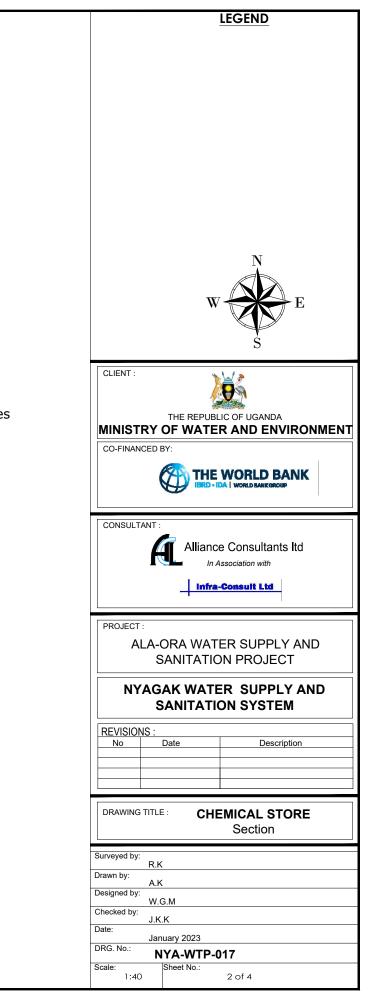


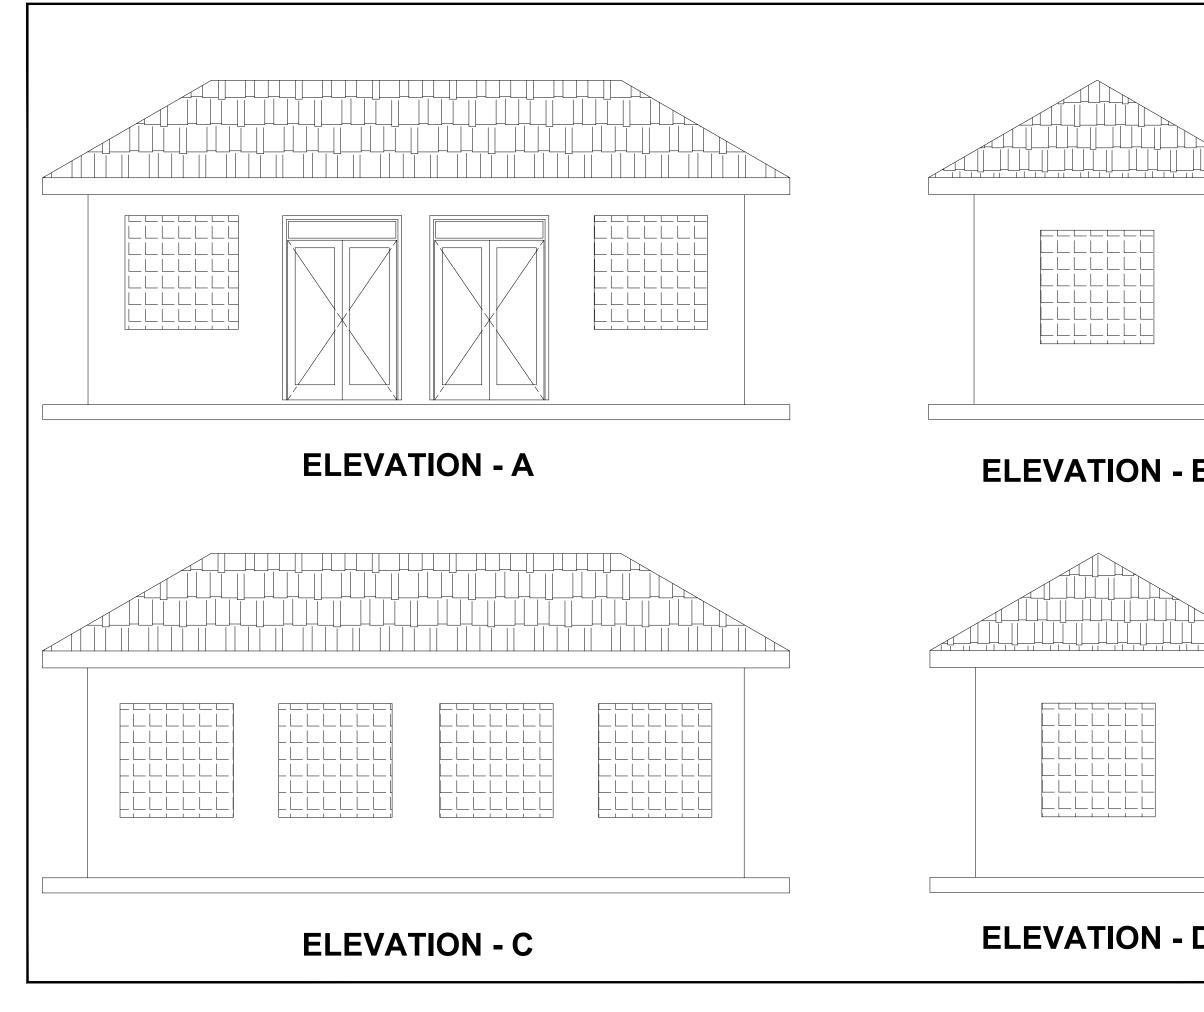

	LEGEND
\searrow	
	Ŋ
	W E
	Š
	CLIENT :
	THE REPUBLIC OF UGANDA
_	CO-FINANCED BY:
3	
	CONSULTANT :
	Alliance Consultants Itd
	Infra-Consult Ltd
	PROJECT : ALA-ORA WATER SUPPLY AND
	SANITATION PROJECT
	NYAGAK WATER SUPPLY AND
	SANITATION SYSTEM
	REVISIONS : No Date
	DRAWING TITLE : CHEMICAL STORE
	Elevations
	Surveyed by:
J	R.K Drawn by:
	A.K Designed by: W.G.M
	W.C.M Checked by: J.K.K
	Date: January 2023
J	DRG. No.: NYA-WTP-017
	Scale: Sheet No.: 1:50 3 of 4

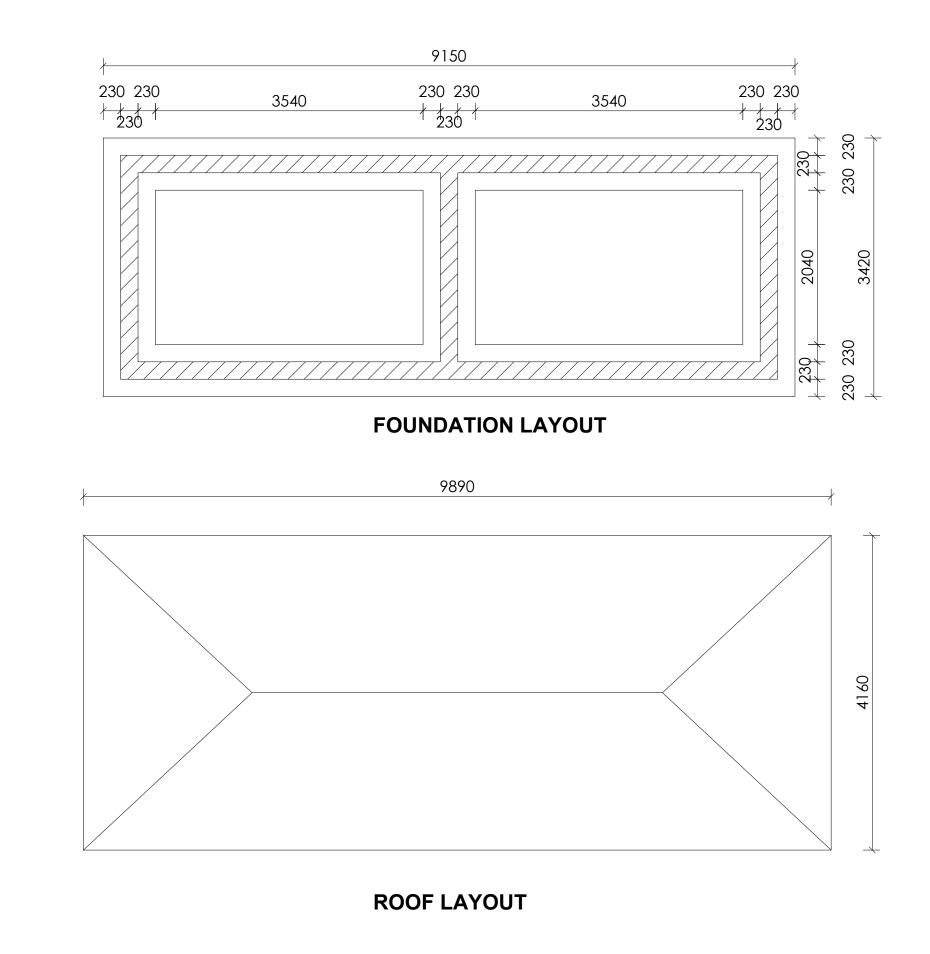

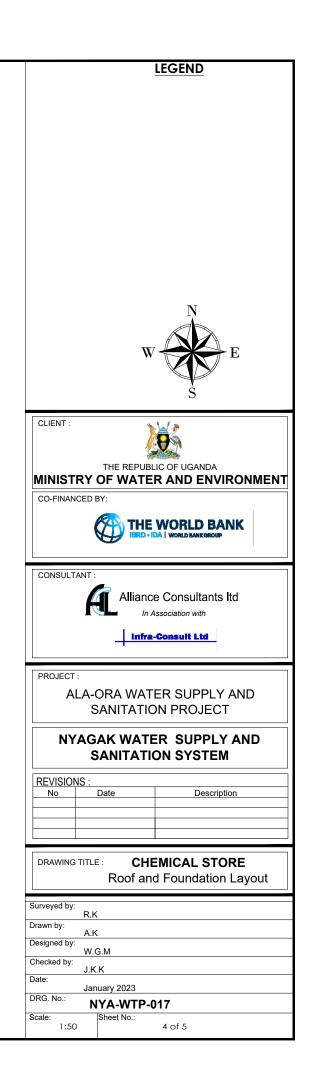


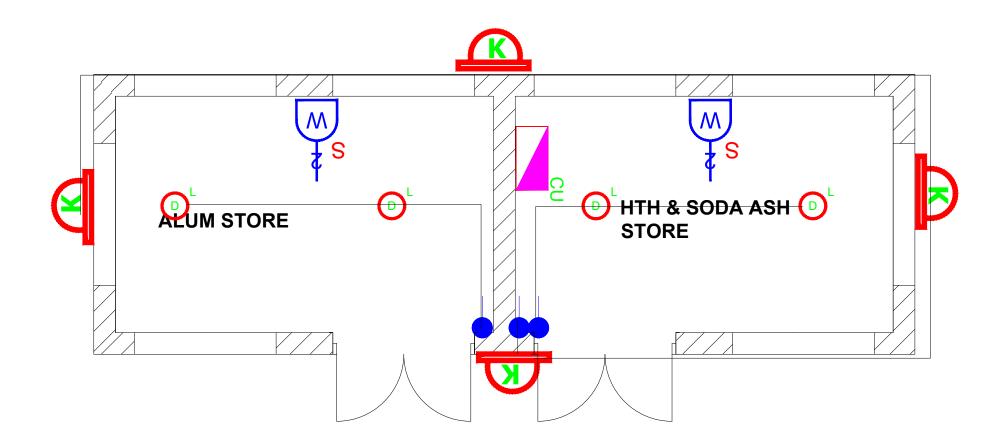



1). ALL WALL BRACKETS SHALL BE MOUNTED 1800mm ABOVE FINISHED FLOOR LEVEL


- 2). TELEPHONE, SOCKETS, T.V AND COMPUTER OUTLETS SHALL BE MOUNTED 300mm ABOVE FINISHED FLOOR LEVEL EXCEPT WHERE THEIR IS A WORKTOP.
- 3). WHERE THEIR IS A WORKTOP, TELEPHONE, SOCKETS, T.V AND COMPUTER OUTLETS SHALL BE MOUNTED 150mm ABOVE WORKTOPS.
- 4). CONSUMER UNITS SHALL BE 1800mm ABOVE FINISHED FLOOR LEVEL
- 5). ALL SWITCHES SHALL BE 1400mm ABOVE FINISHED FLOOR LEVEL
- 6). ALL OUTSIDE SOCKETS SHOULD BE WEATHER PROOF
- 7). ALL SHAVER SOCKETS SHOULD BE ON THE RIGHT HAND SIDE OF THE WASH HAND BASIN
- 8). ALL CABLES MUST BE STRANDED


1						
	234801	DECODINTION				
	SYMBOL	DESCRIPTION 1200mm 18W LED batten with a removable LED engine. IP20 As Thom PopPack LED. or equal approved. (Light Type F1)				
	C ¹	Pedant lighting fitting comprising ceiling Rose 300mm 3x1.5mm ²				
		flexible copper cable lamp holder and 6W LED Lamp Pedant lighting fitting comprising ceiling Rose 300mm 3x1.5mm ²				
	© 0	flexible copper cable lamp holder and 6WLED Lamp Pedant lighting fitting comprising ceiling Rose 300mm 3x1.5mm ² flexible copper cable lamp holder and 6W LED Lawn				
	Ŷ	LED Lamp Decorative Bed side lamp complete with flexible spot light arm as LEDS-C4 BAL1 (05-3217-19-82 + PAN-157-BY) to				
	A	client's approval. wall mounted light				
	<u>a</u>	Socket outlet on Wall				
		Consumer's Unit				
	¥	One Gang 2way Switch				
	#	Two Gang 2way Switch				
		Three Gang 2way Switch				
	•	One Gang Iway Switch				
		Two Gang Iway Switch Three Gang Iway Switch				
		Intermediate Switch				
	PC	Photo - Cell				
	THE REPUBLIC OF UGANDA MINISTRY OF WATER AND ENVIRONMENT CO-FINANCED BY: THE WORLD BANK ISRD - IDA WORLD BANK GROUP					
C	CONSULTANT : Alliance Consultants Itd In Association with					
PI	PROJECT : ALA-ORA WATER SUPPLY AND SANITATION PROJECT					
	NYAGAK WATER SUPPLY AND SANITATION SYSTEM					
R	EVISION					
	NO	Date Description				
DRAWING TITLE : CHEMICAL STORE Electrical Layout						
Surveyed by:						
R.K Drawn by:						
A.K Designed by:						
W.G.M Checked by: J.K.K						
Date	J.K.K Date: January 2023					
DRG	6. No.:	NYA-WTP-017				
See	Scale: Sheet No.: 1:40 5 of 5					
Scal	1:40	5 of 5				

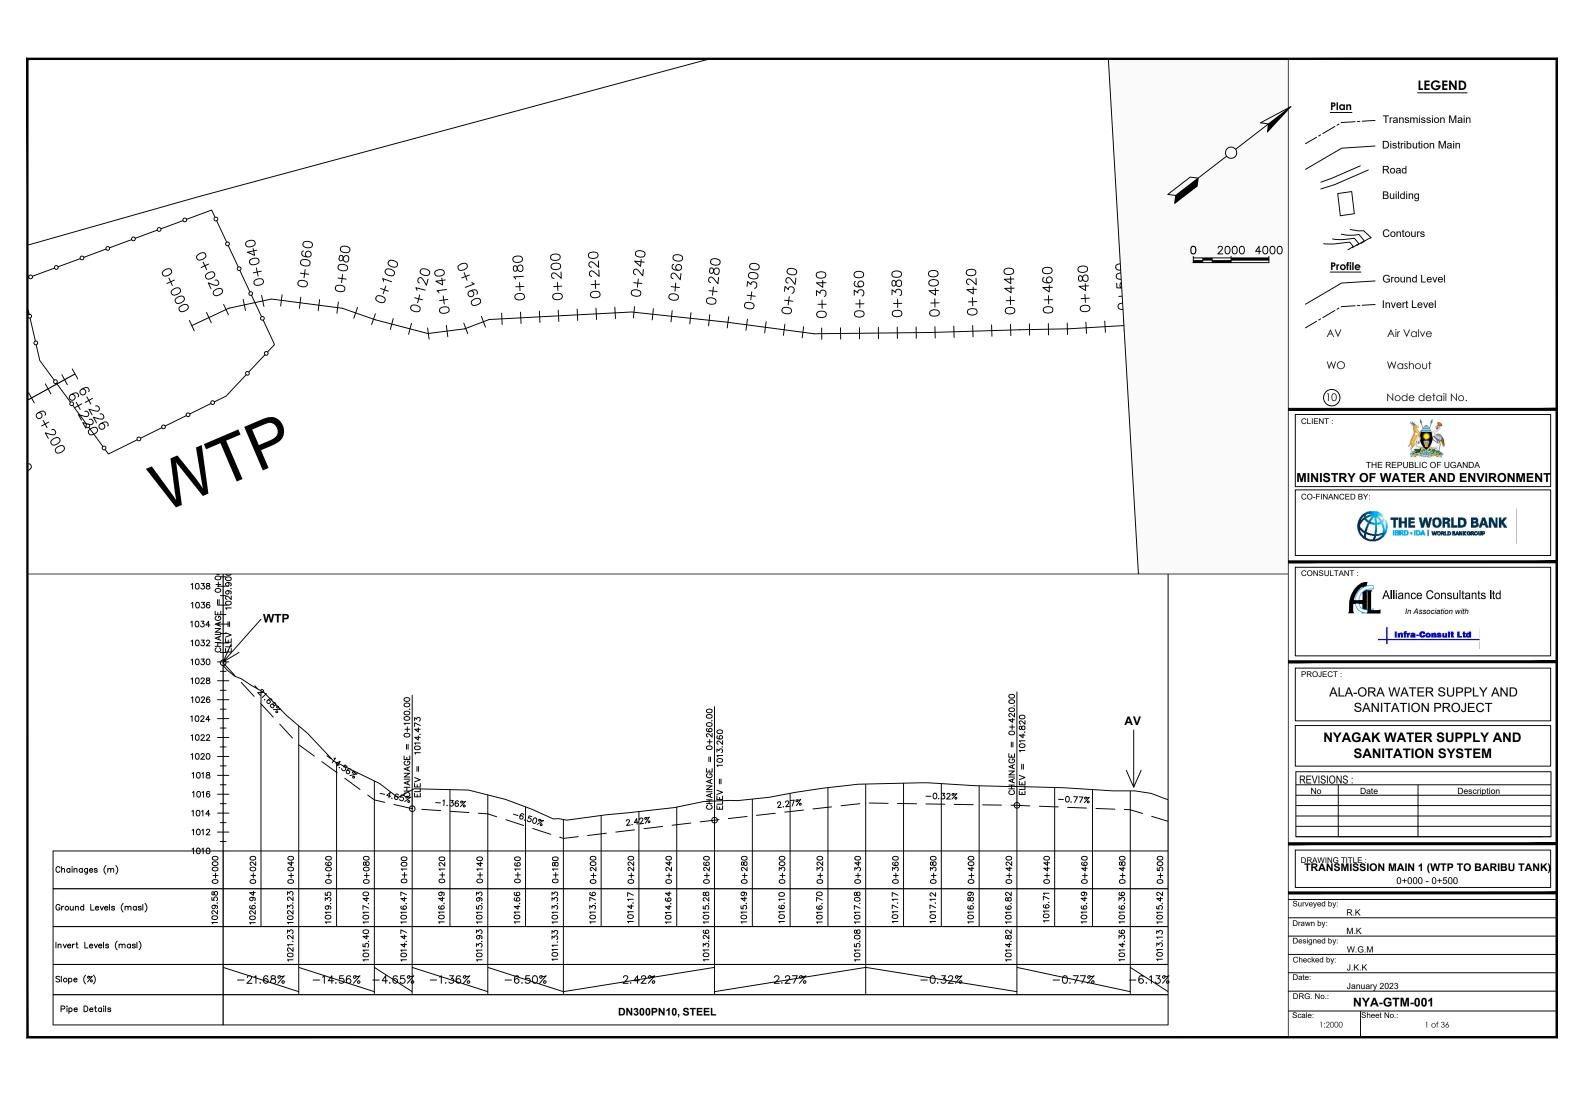


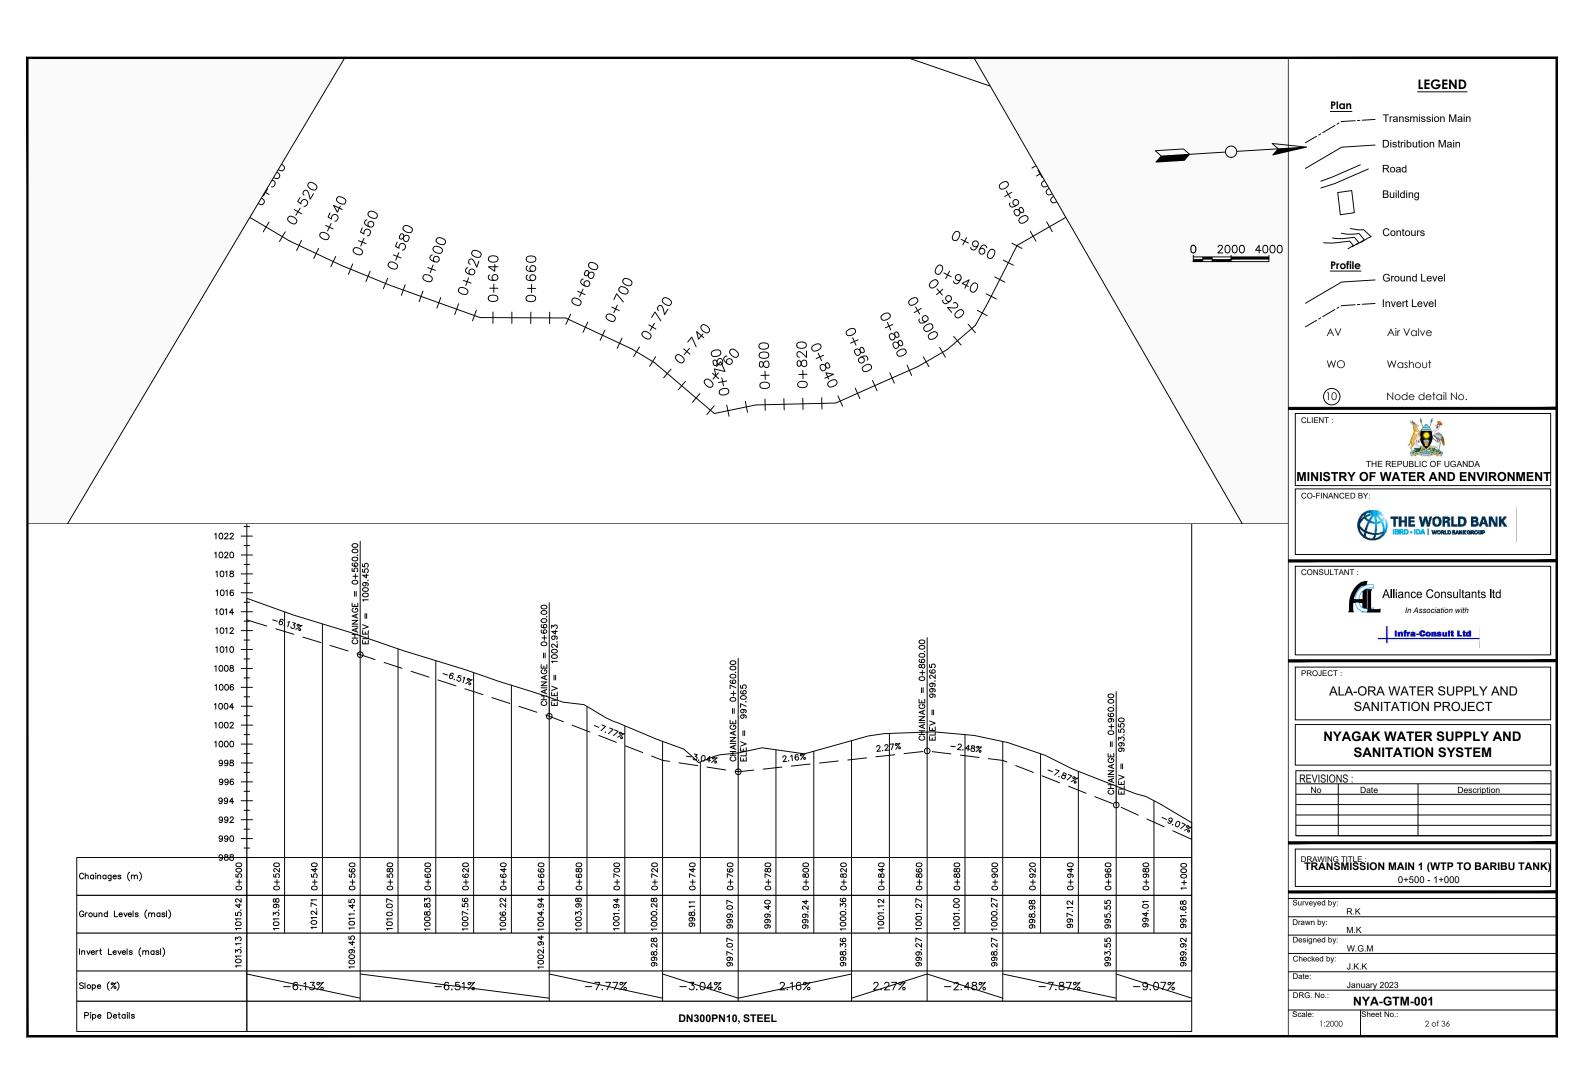


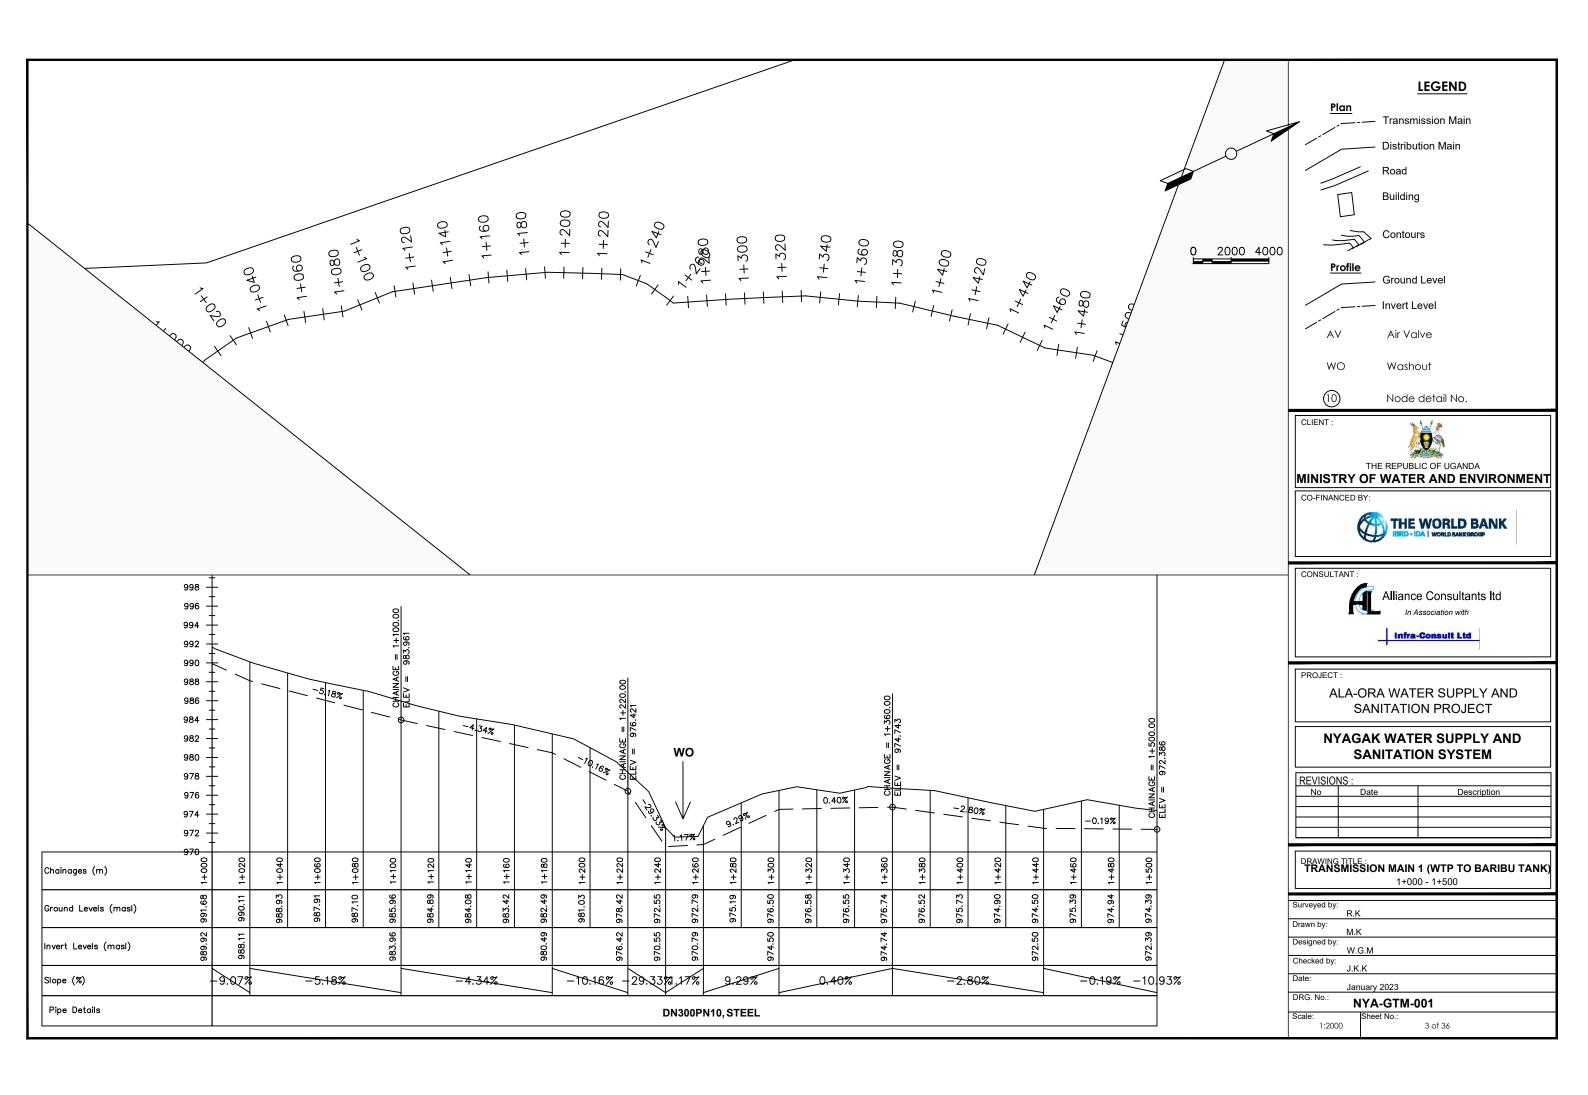


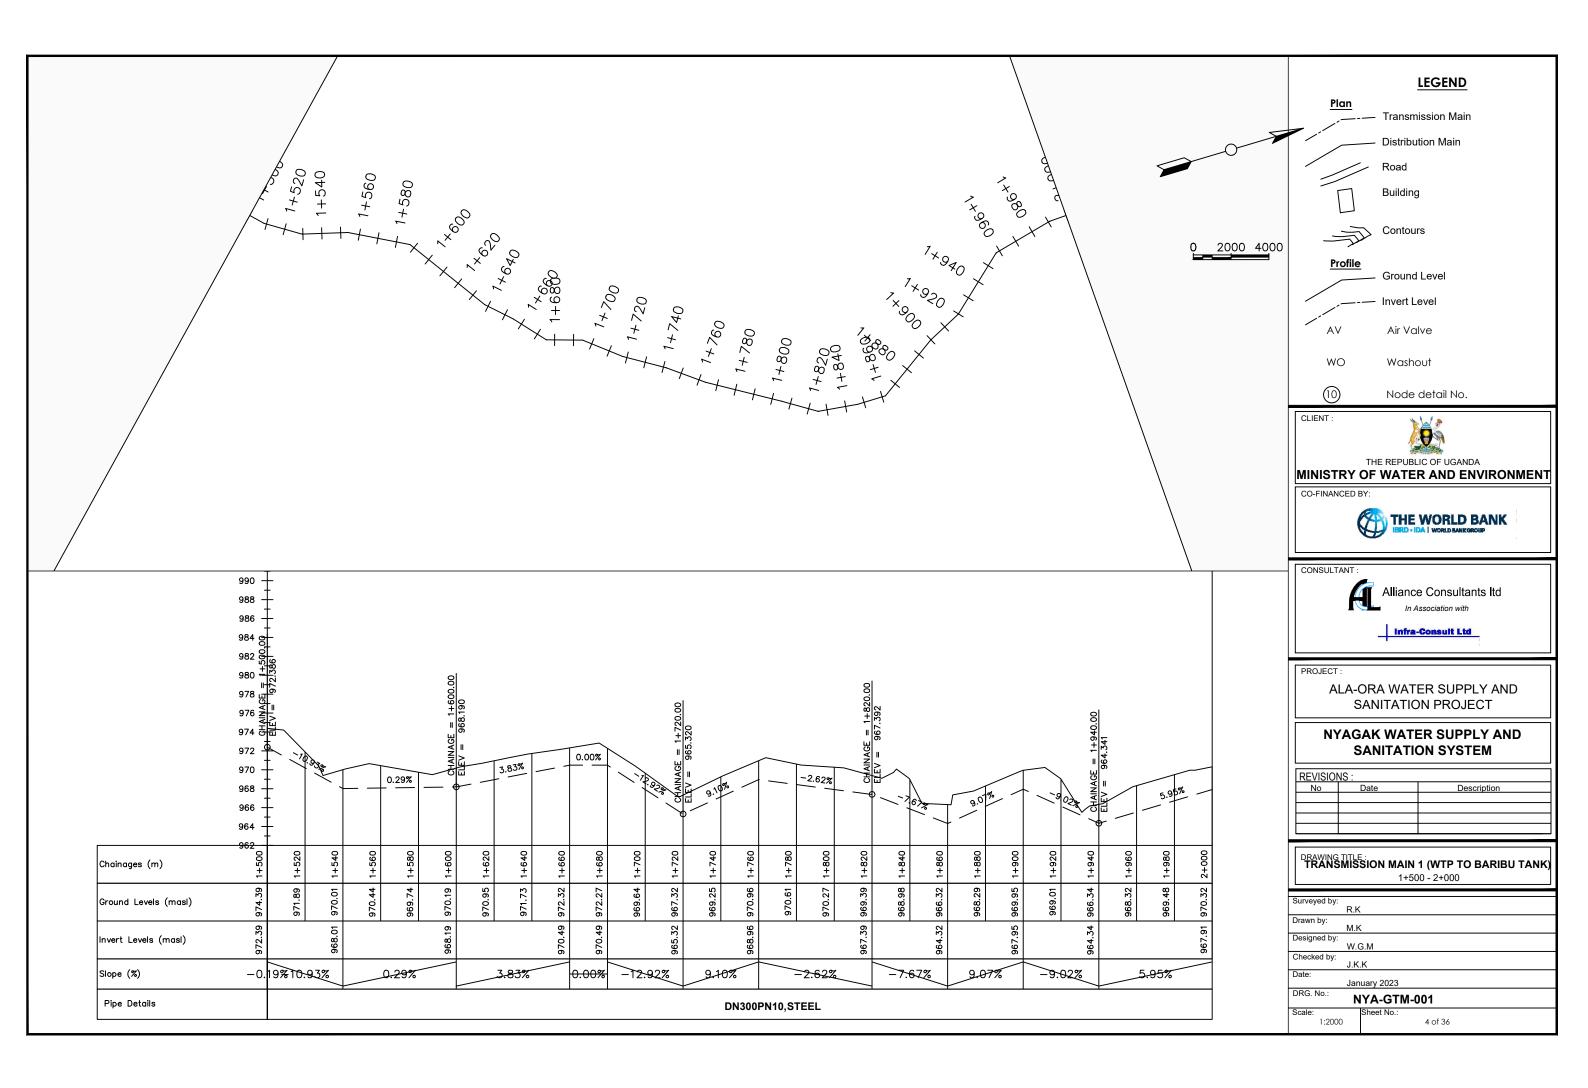


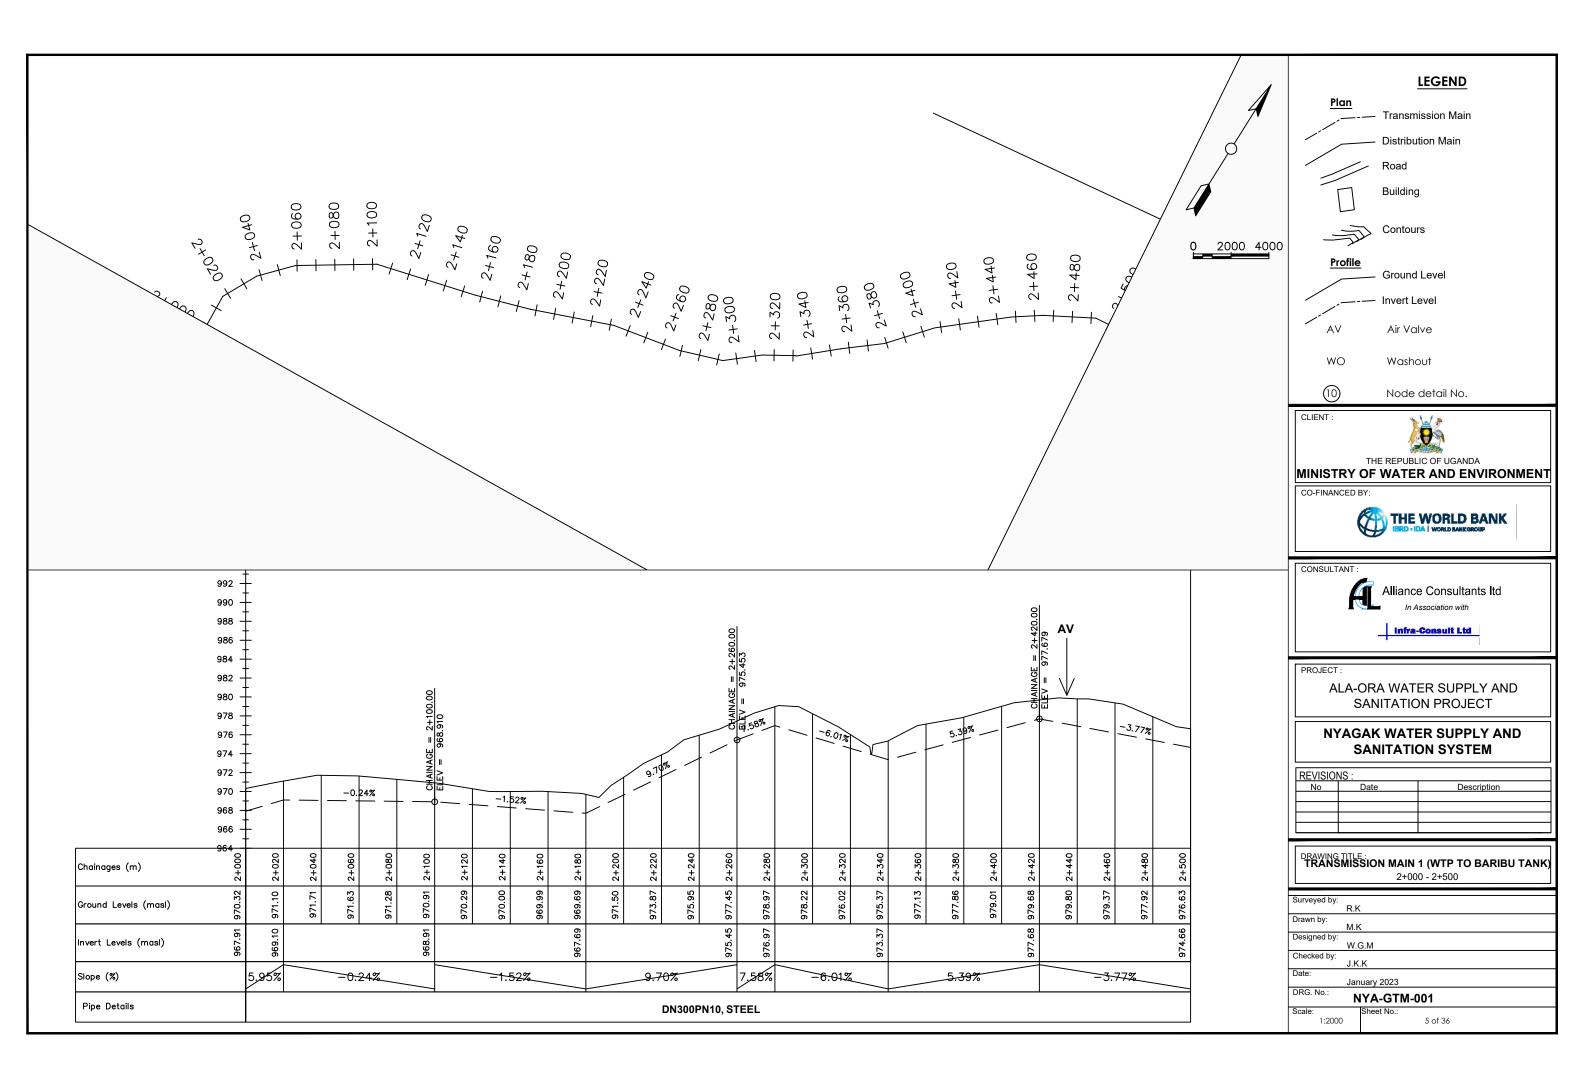


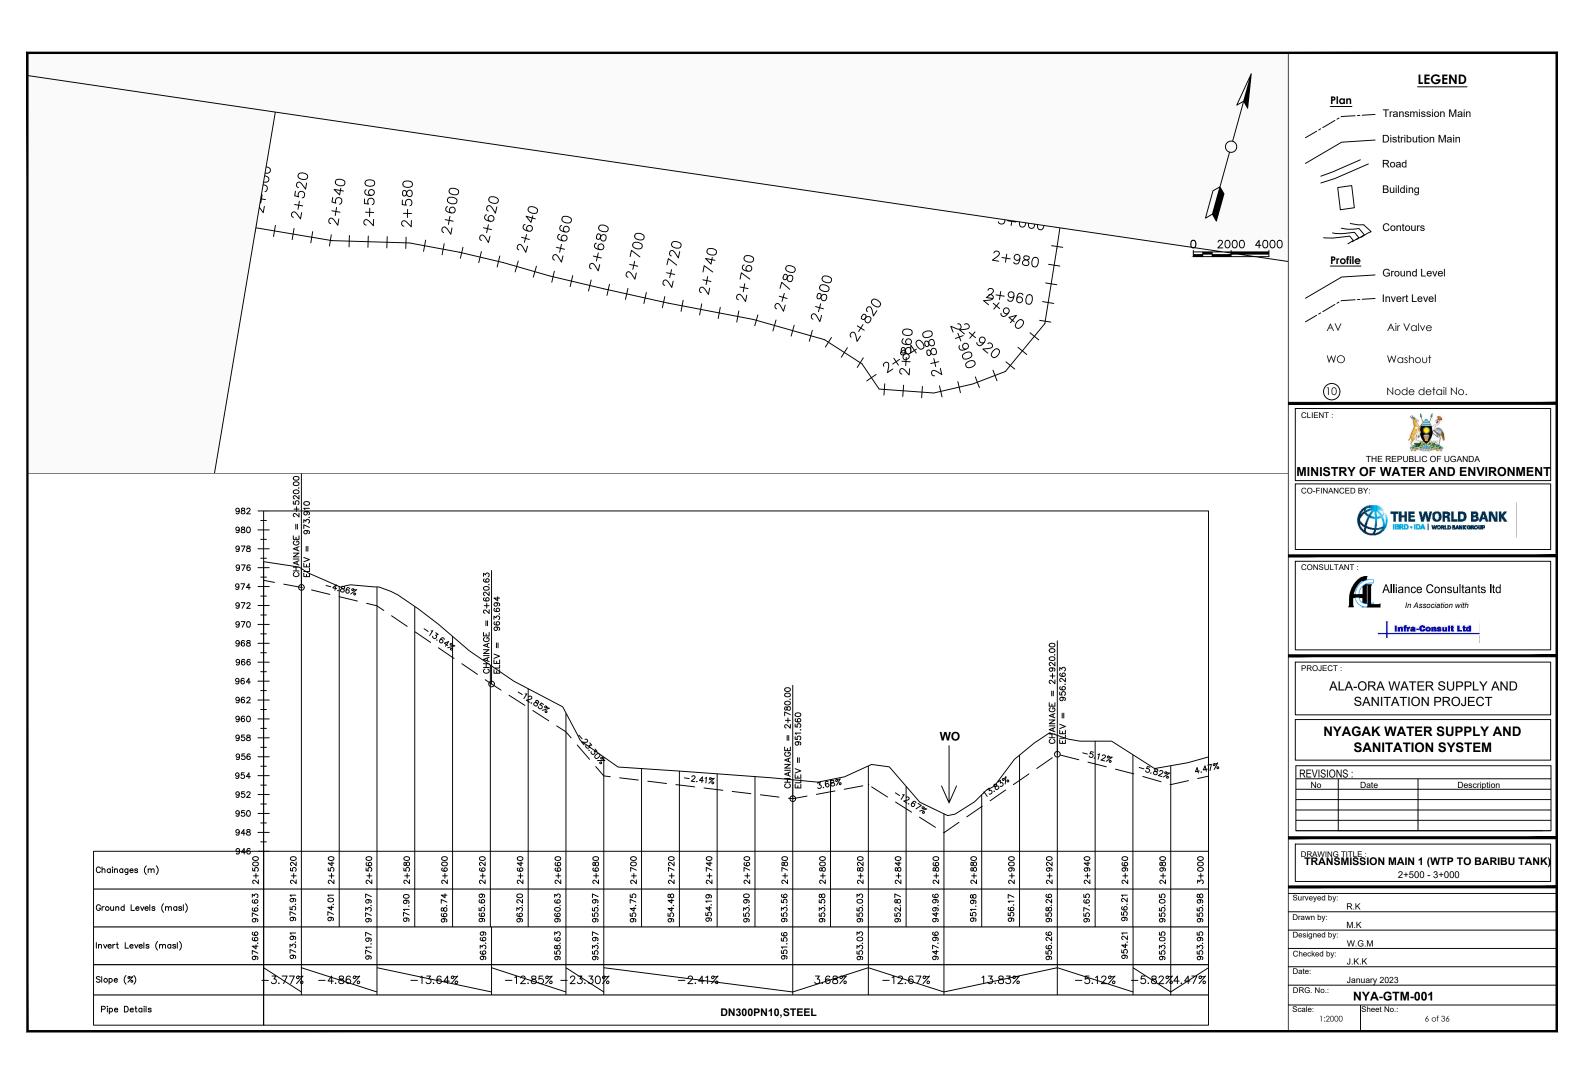


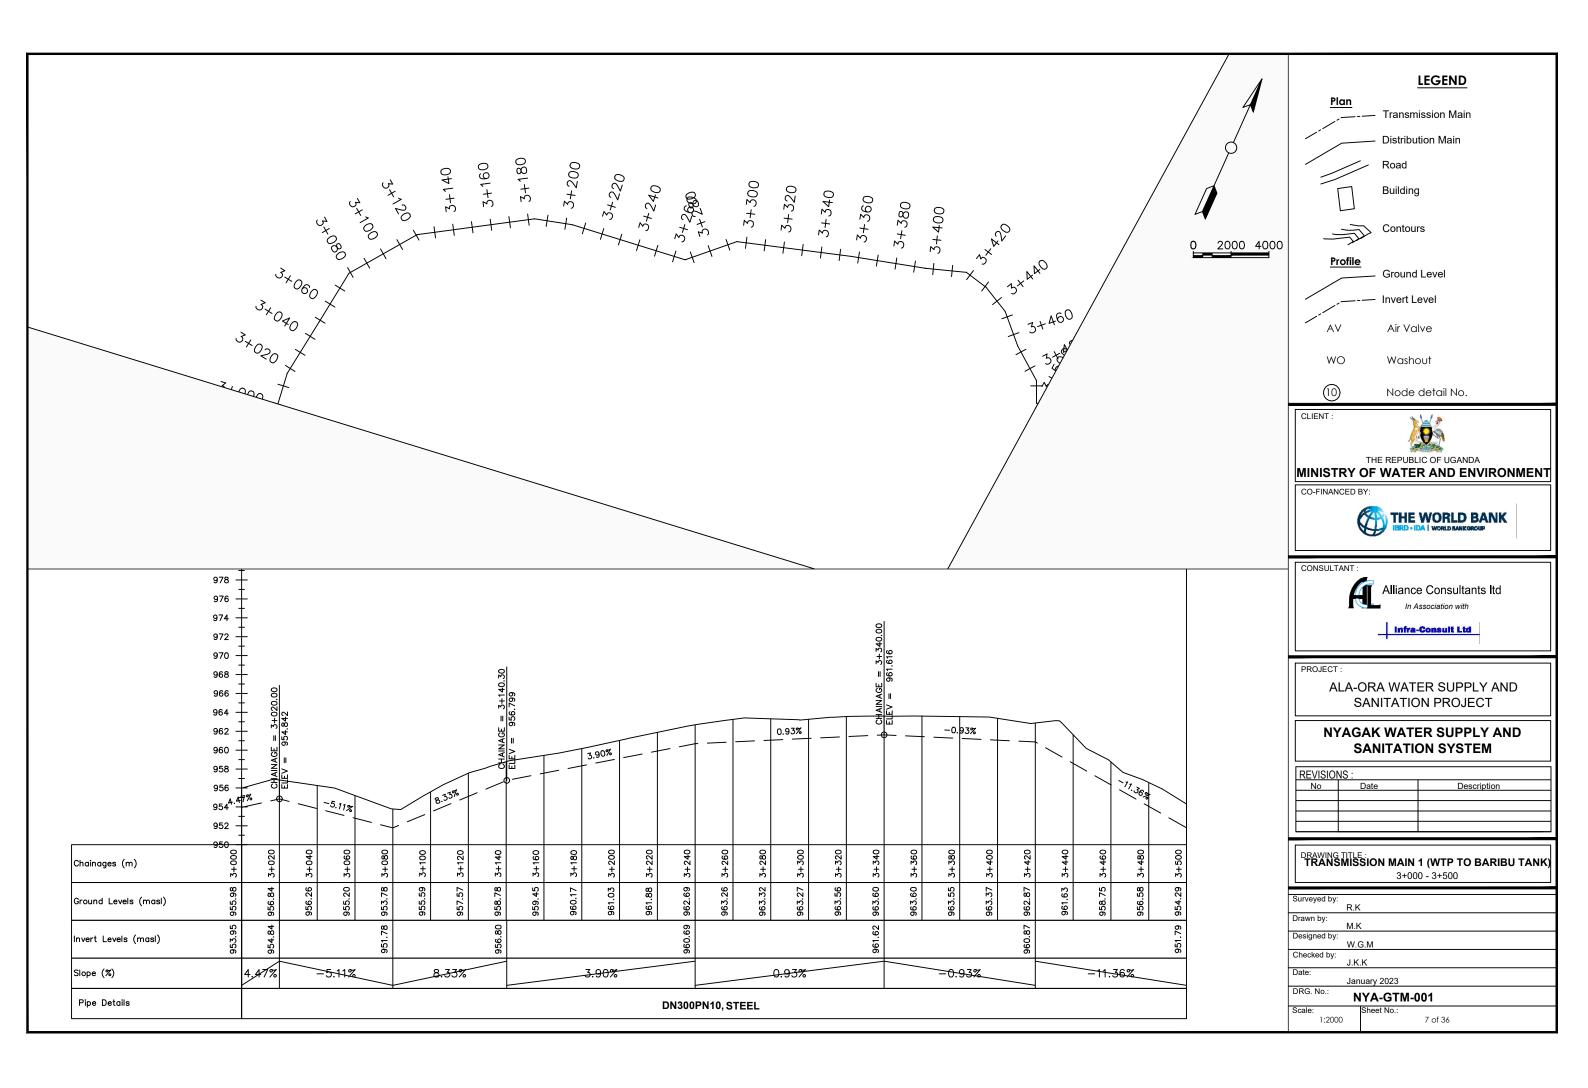


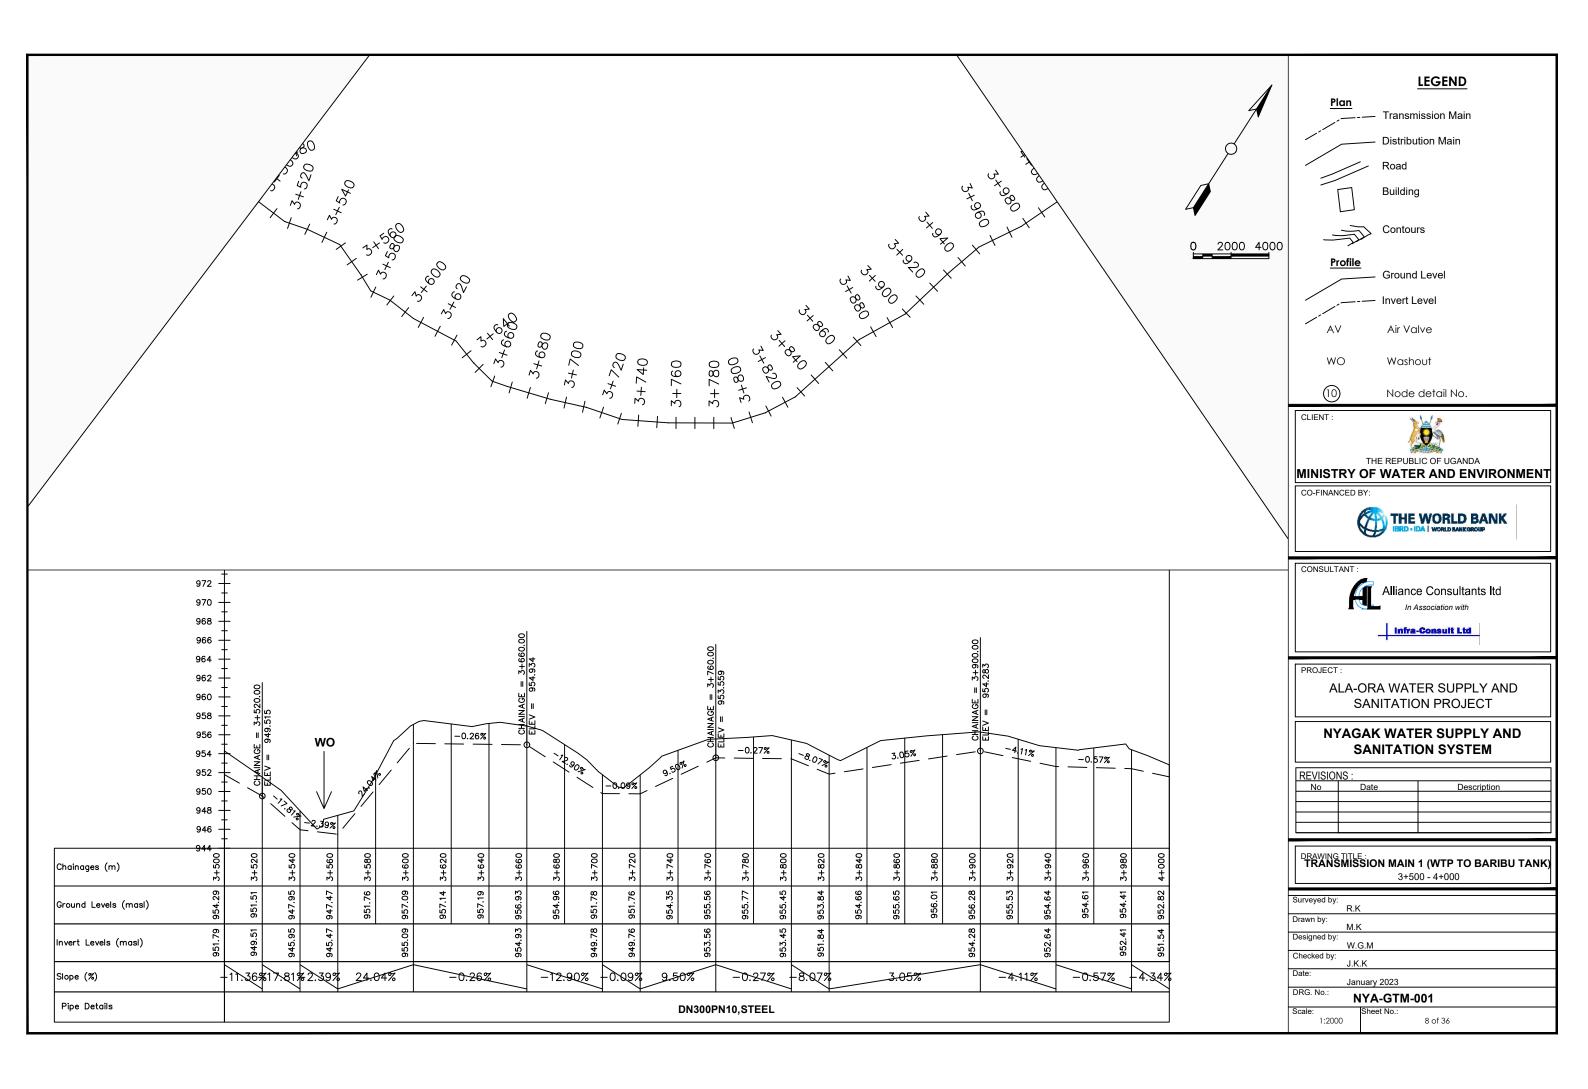


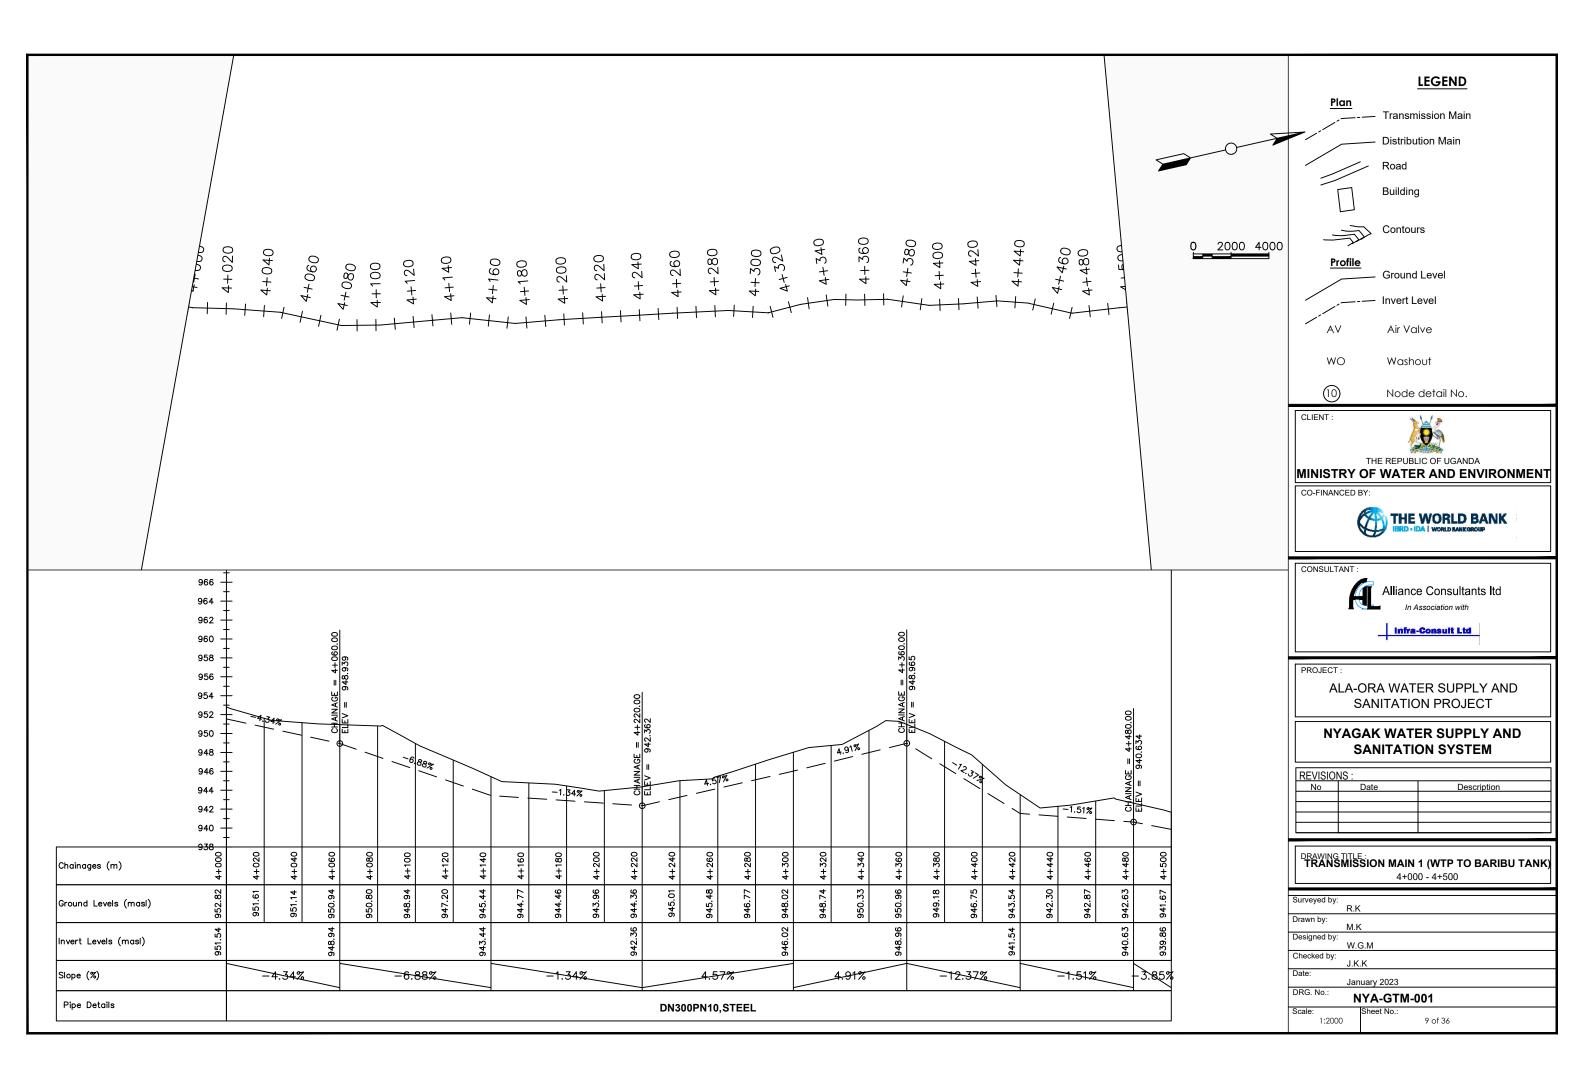


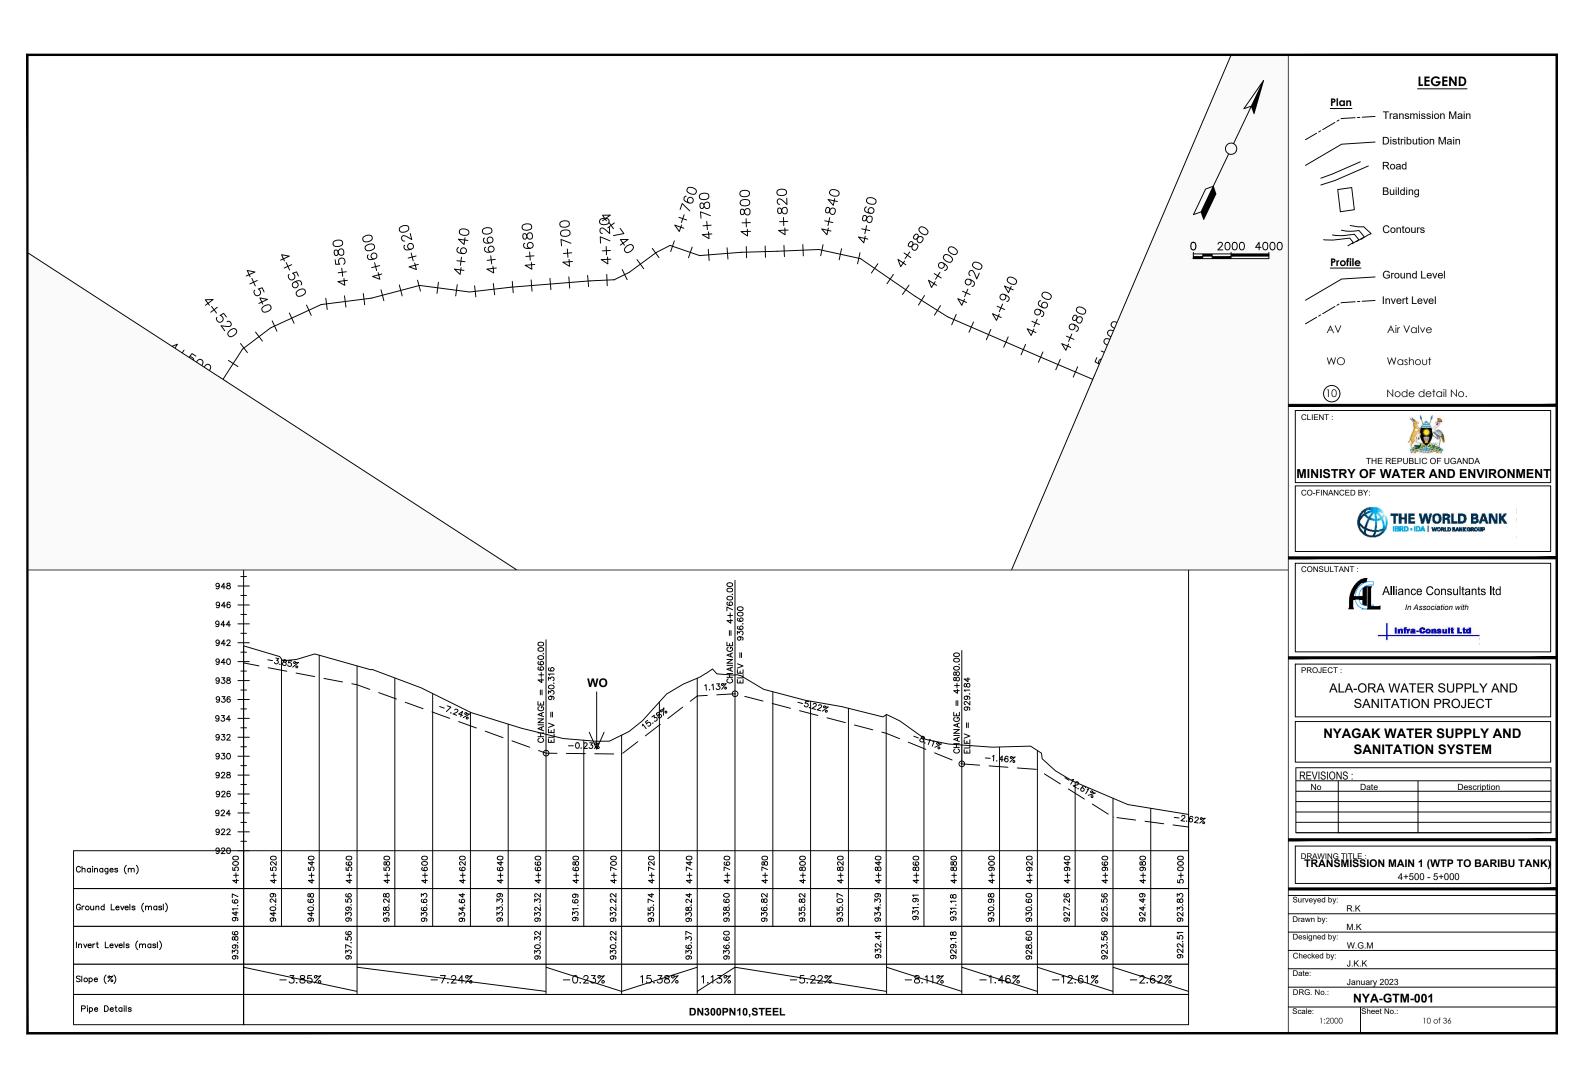


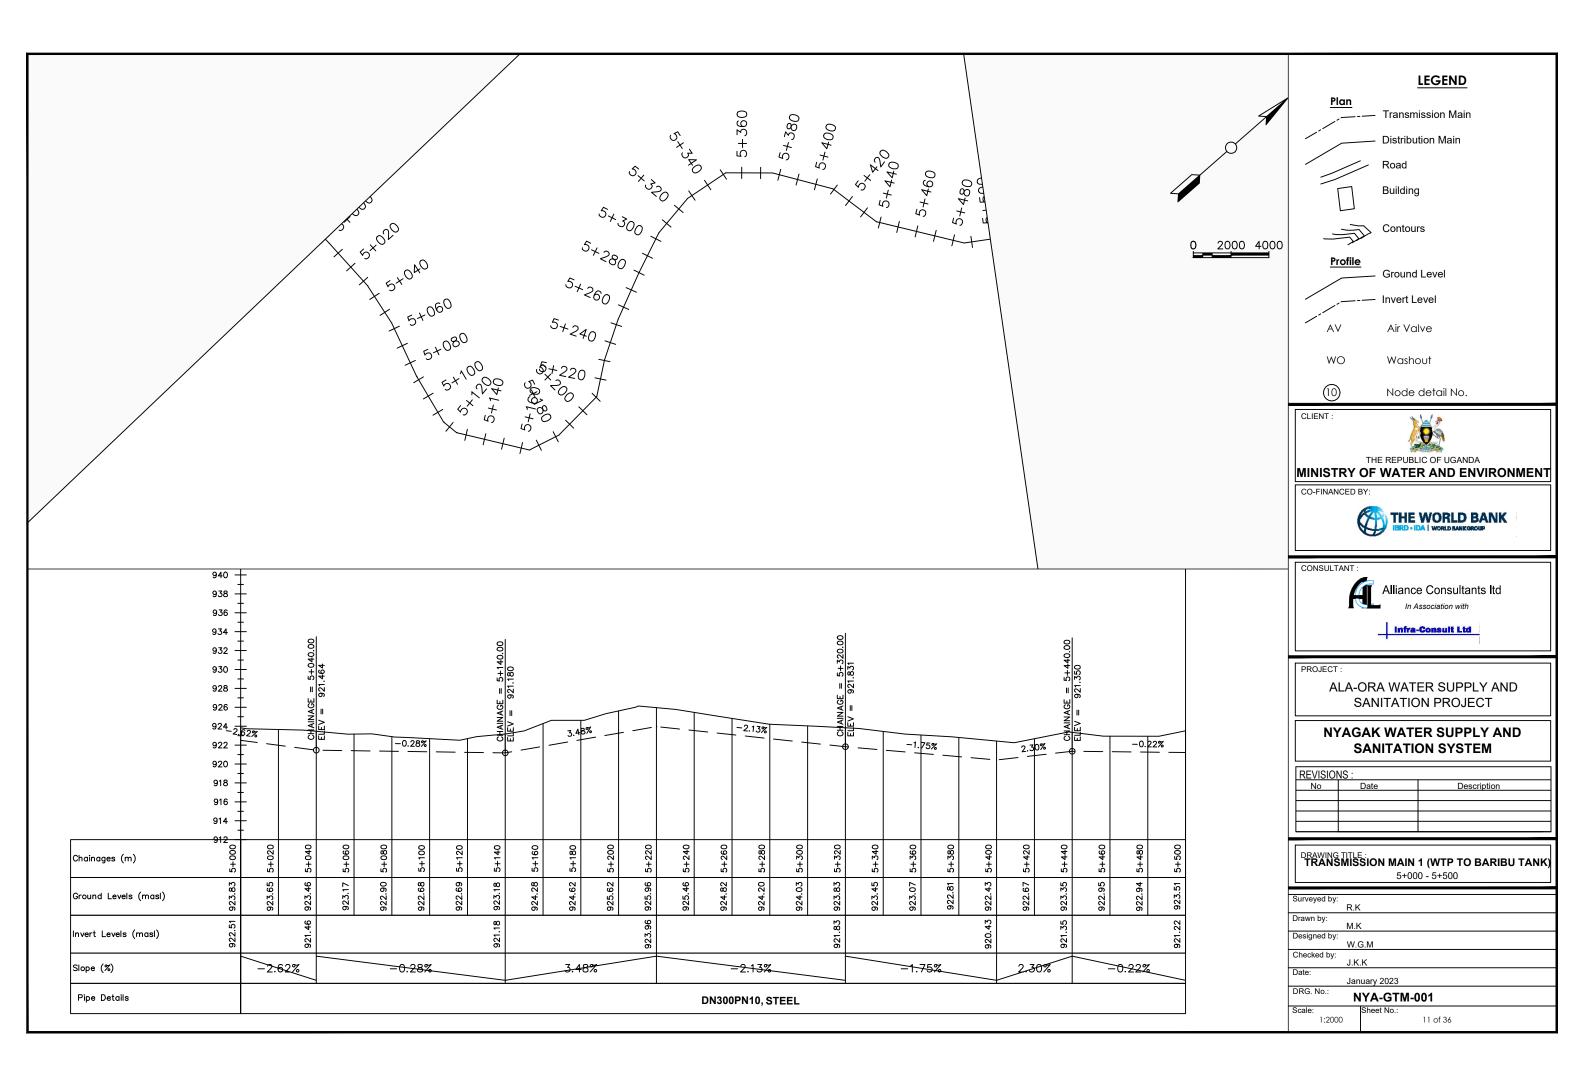


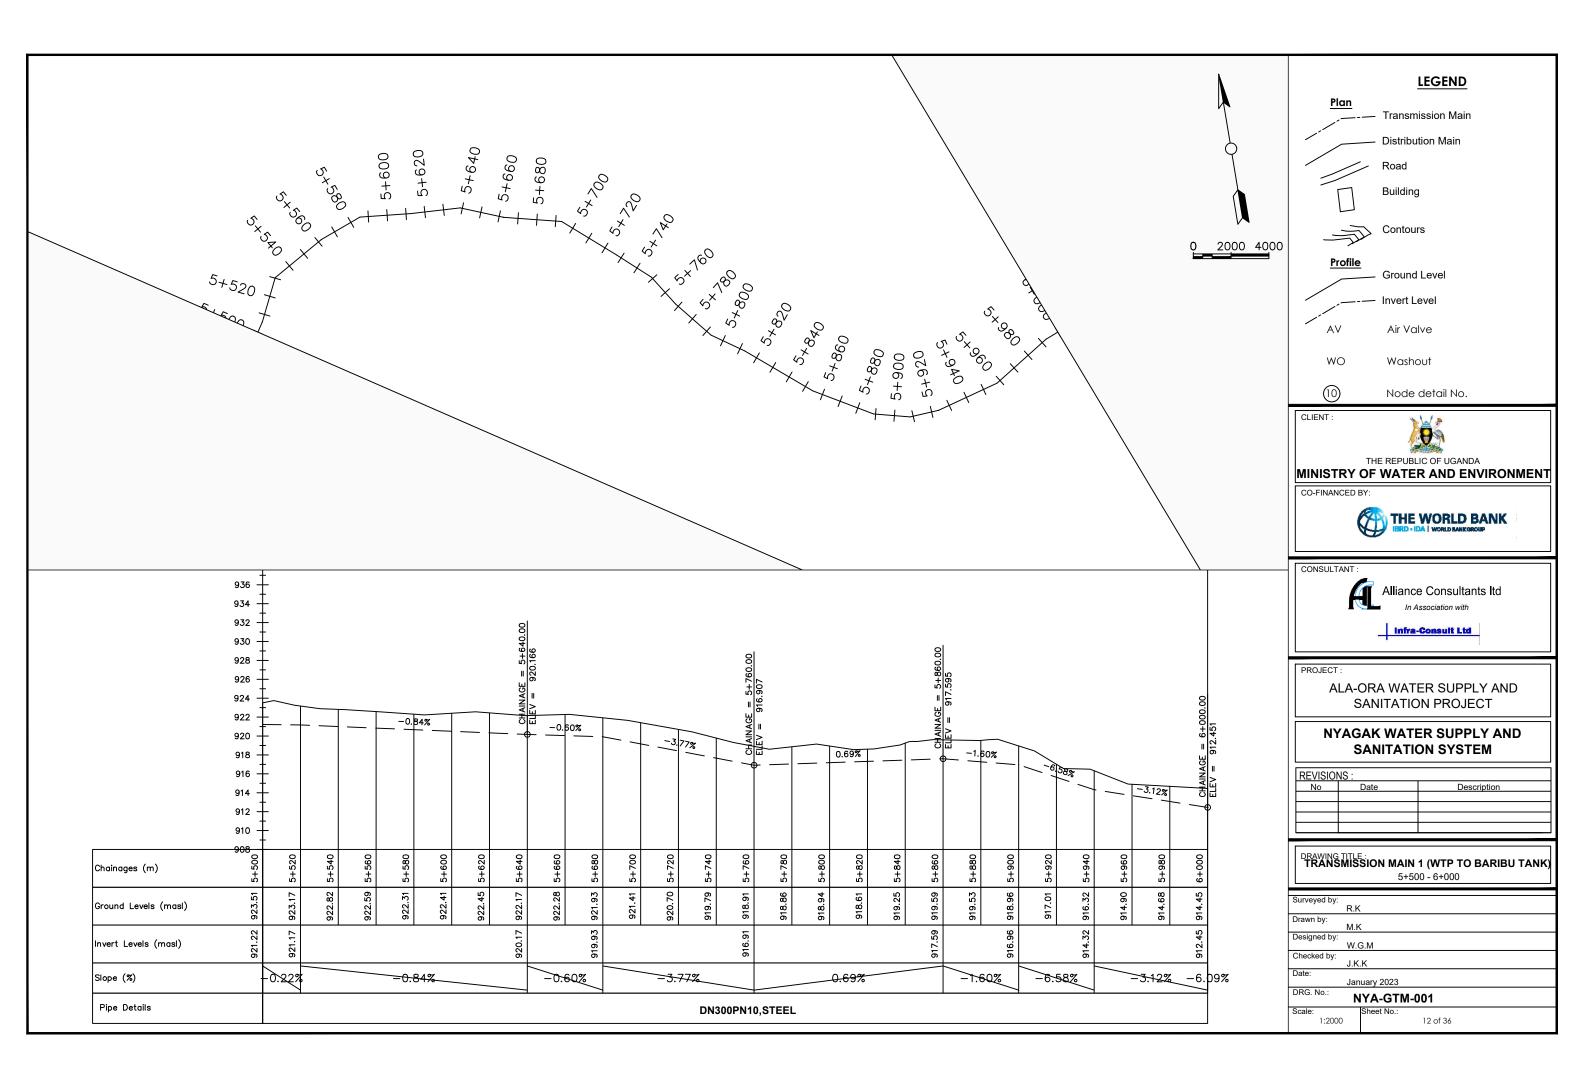

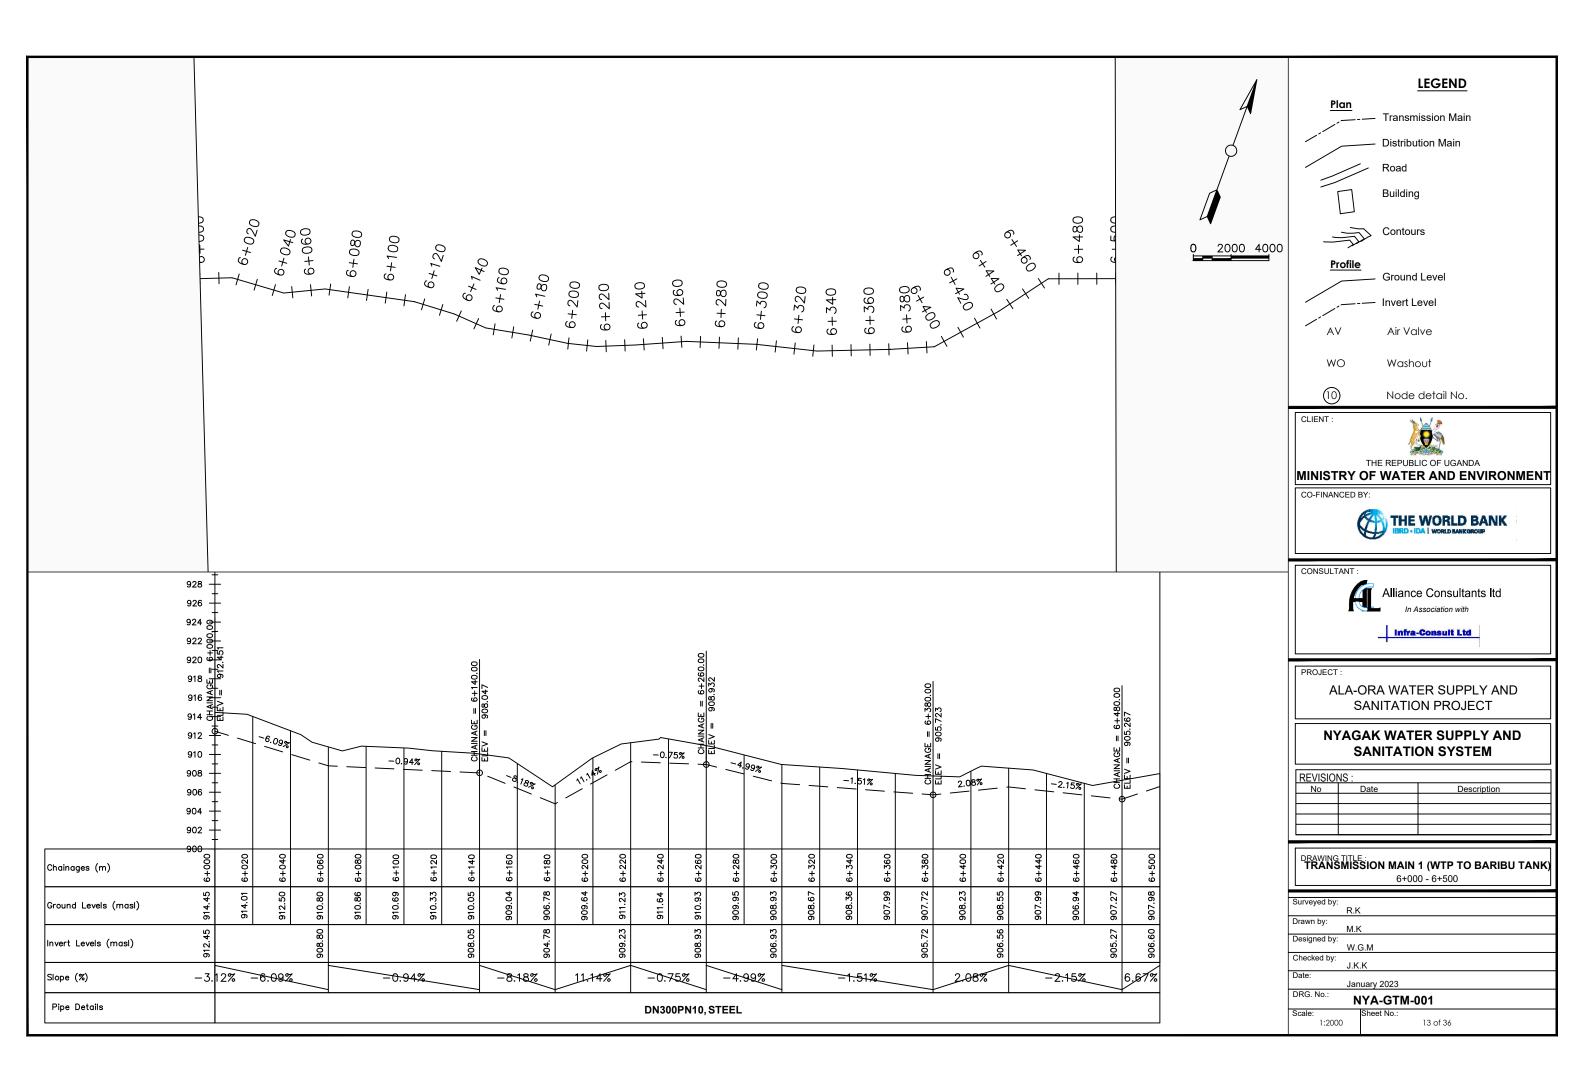


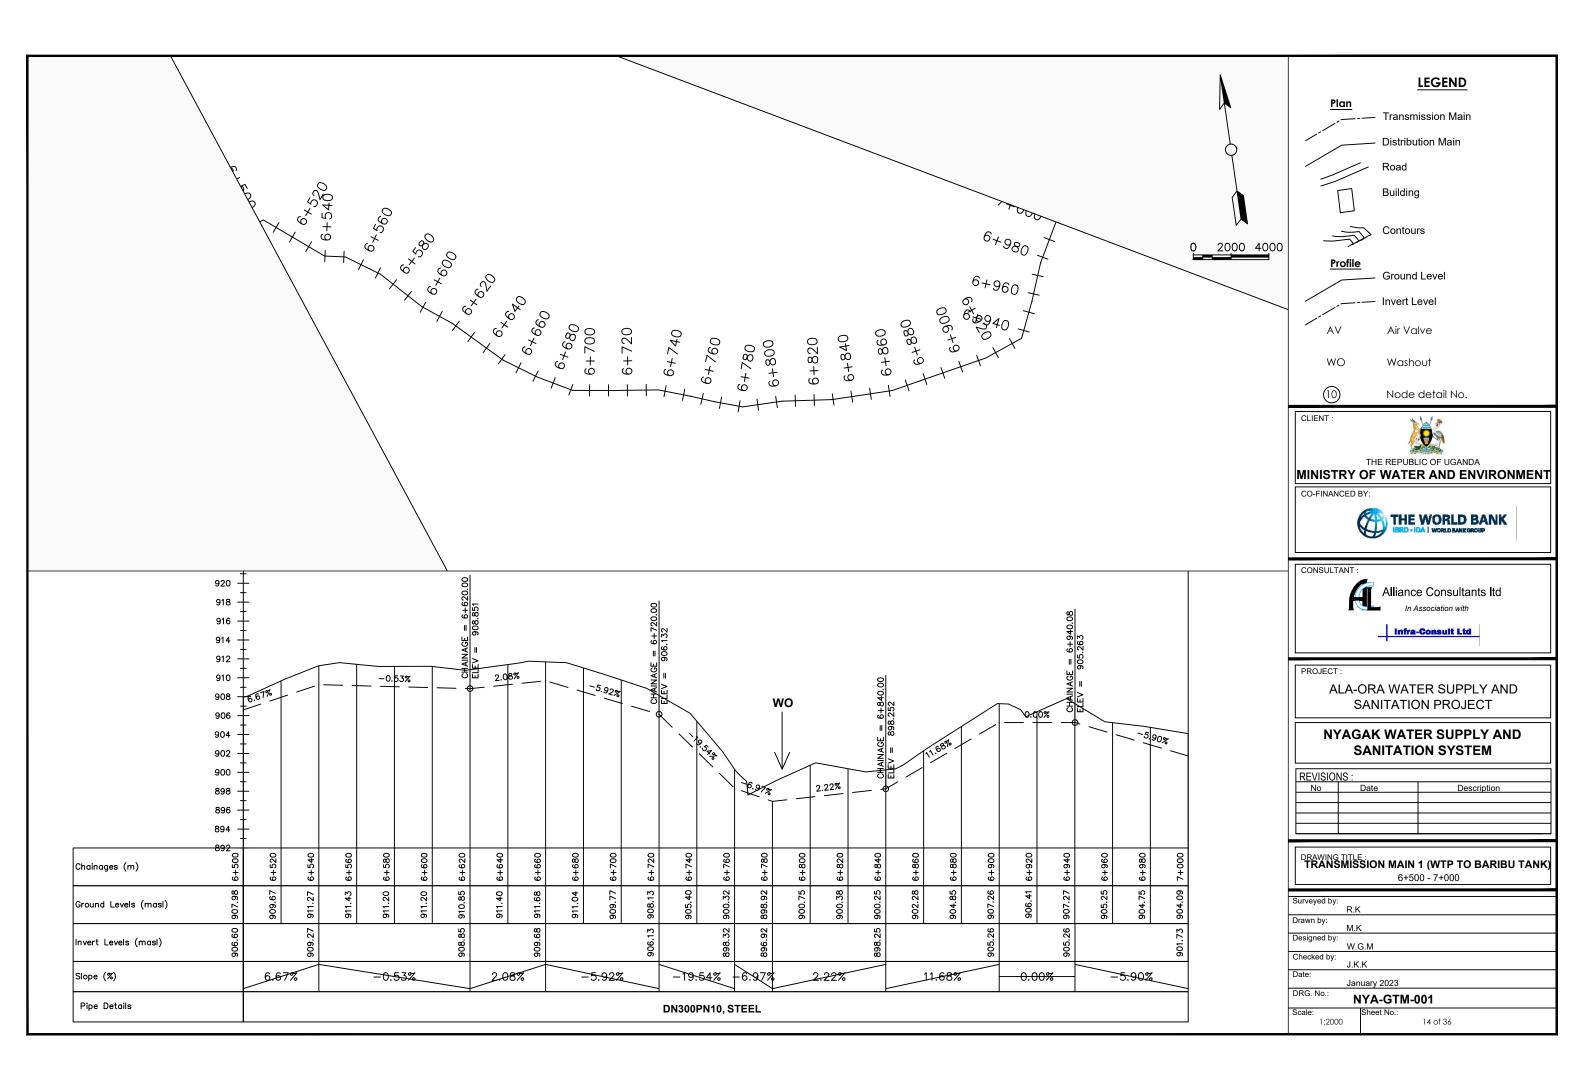

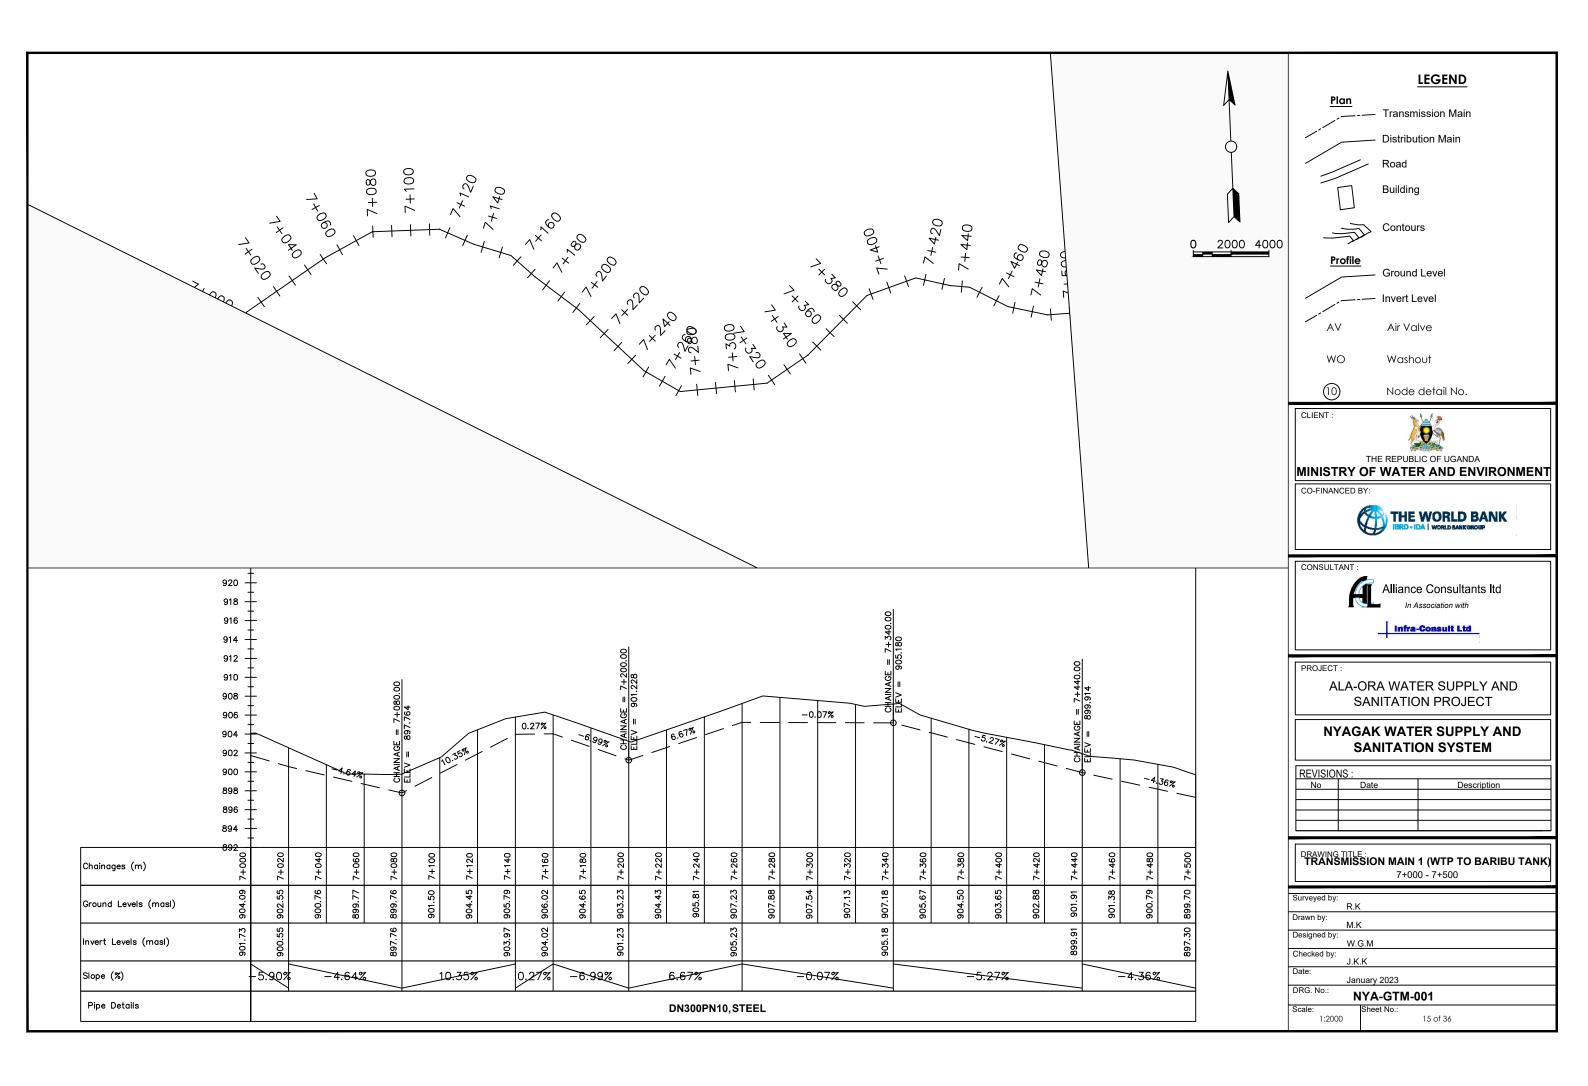


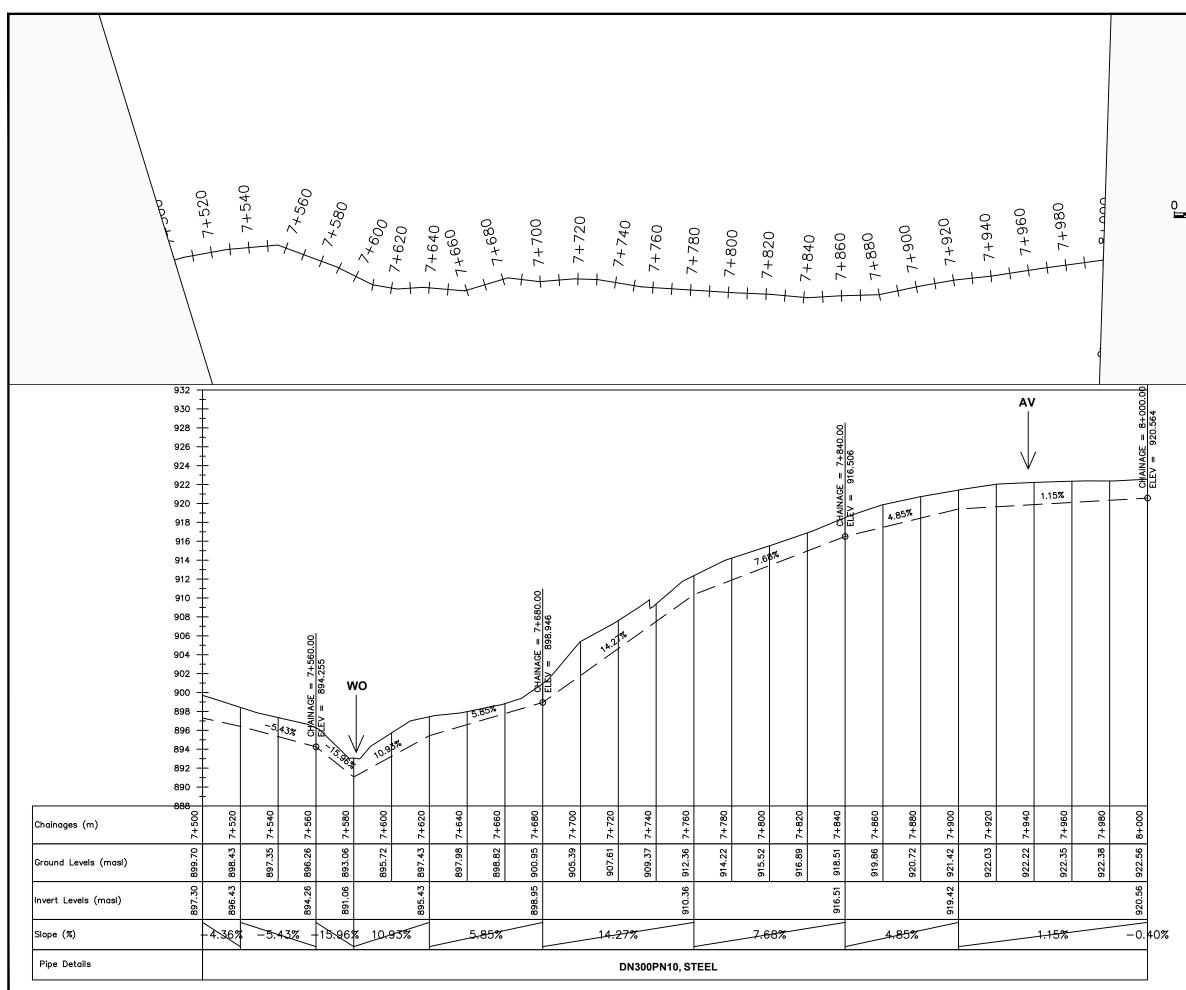


Node detail No. CLIENT: THE REPUBLIC OF UGANDA MINISTRY OF WATER AND ENVIRONMENT CO-FINANCED BY: CO-FINANCED BY: CONSULTANT: CONSULTANT: PROJECT: ALA-ORA WATER SUPPLY AND SANITATION PROJECT NYAGAK WATER SUPPLY AND SANITATION SYSTEM REVISIONS: No Date Description REVISIONS: No Date Description DESCRIPTION	2000 4000	Plan Profile AV WO	LEGEND Transmission Main Distribution Main Road Building Contours Ground Level Air Valve Washout
ALA-ORA WATER SUPPLY AND SANITATION PROJECT NYAGAK WATER SUPPLY AND SANITATION SYSTEM REVISIONS : No Date Date Description		CLIENT : MINISTRY CO-FINANCED E	THE REPUBLIC OF UGANDA OF WATER AND ENVIRONMENT BY: THE WORLD BANK IN END - IDA WORLD BANKCOROUP Alliance Consultants Itd In Association with
R.K Drawn by: M.K Designed by: W.G.M Checked by: J.K.K Date: January 2023		ALA-C S NYAG S REVISIONS : No DRAWING TITLE TRANSMISS Surveyed by: R.K Drawn by: M.K Designed by: Checked by: J.K. Date:	ANITATION PROJECT AK WATER SUPPLY AND ANITATION SYSTEM Date Date Description Sion MAIN 1 (WTP TO BARIBU TANK) 7+500 - 8+000 G. G.M .K

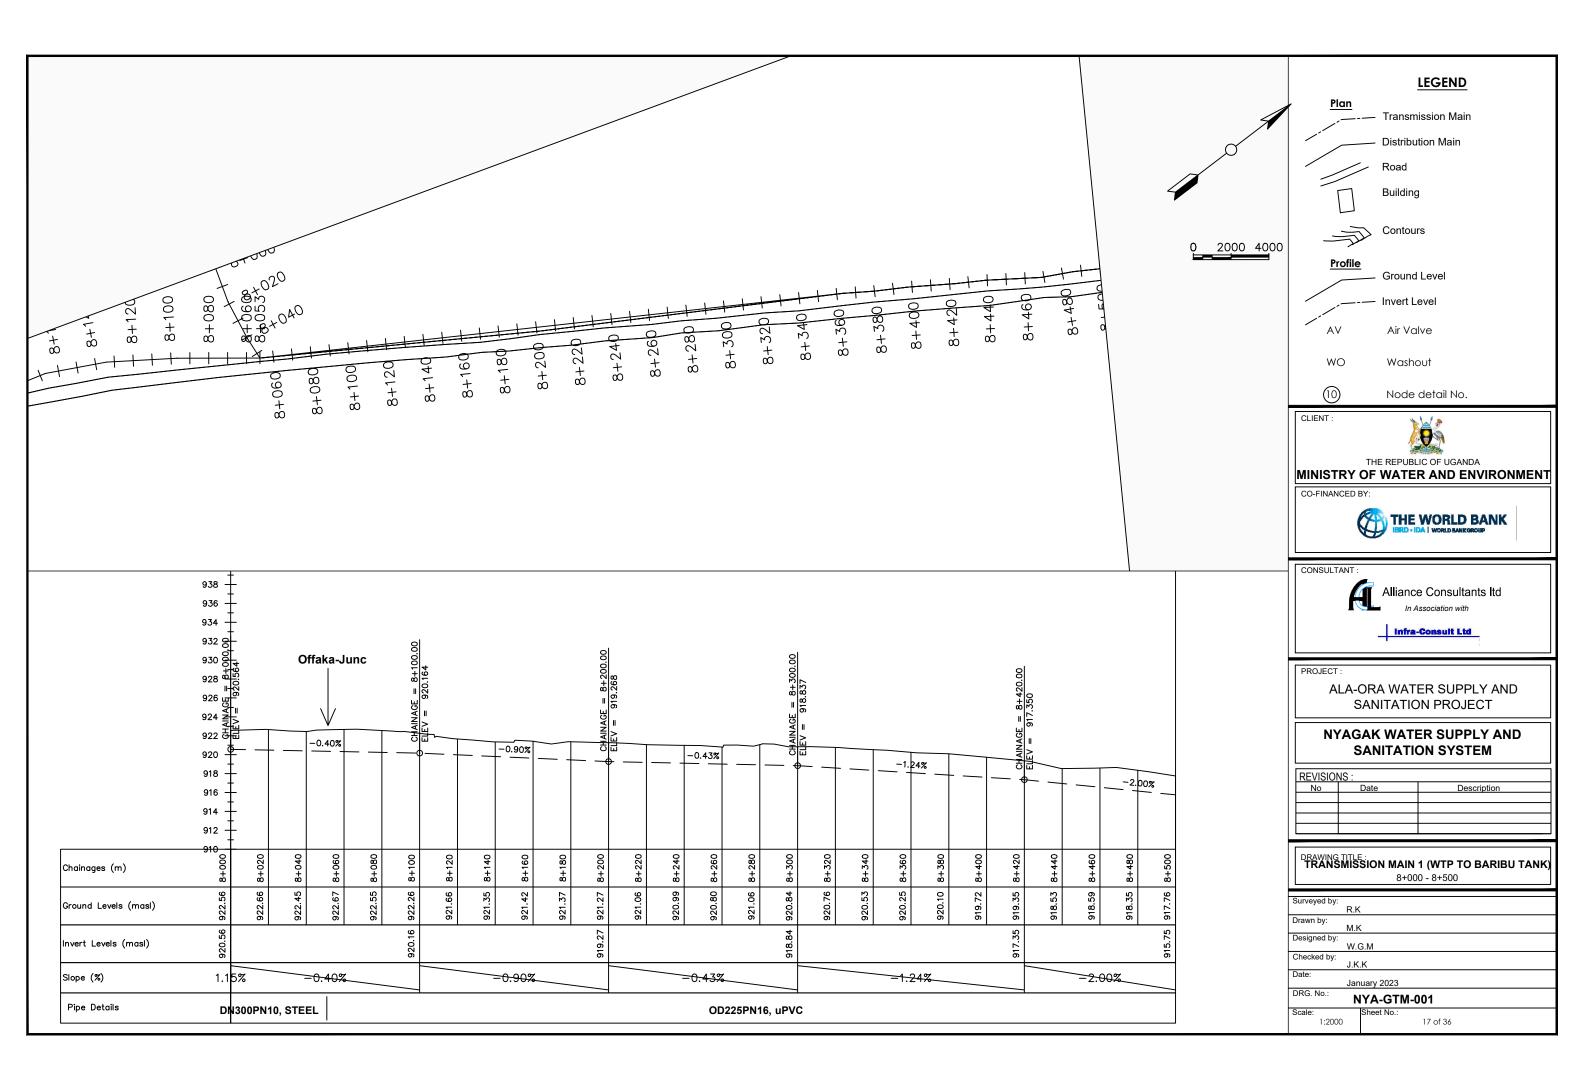


NDIRIBA SUPPLY AREA

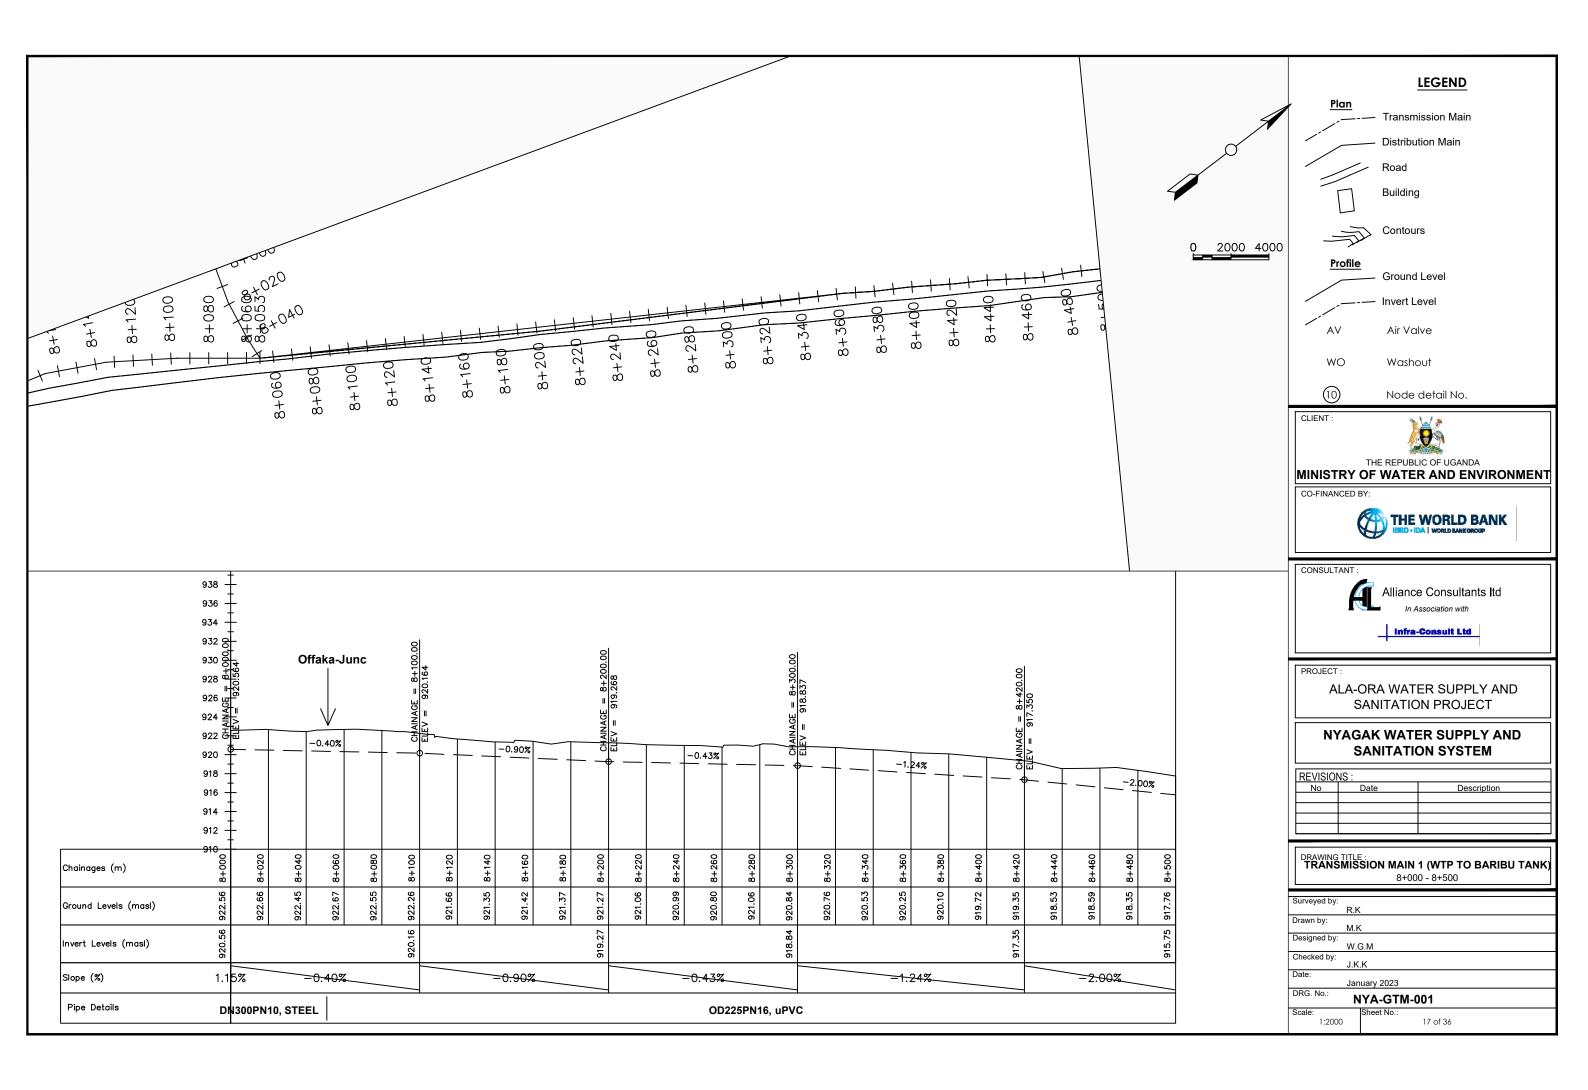


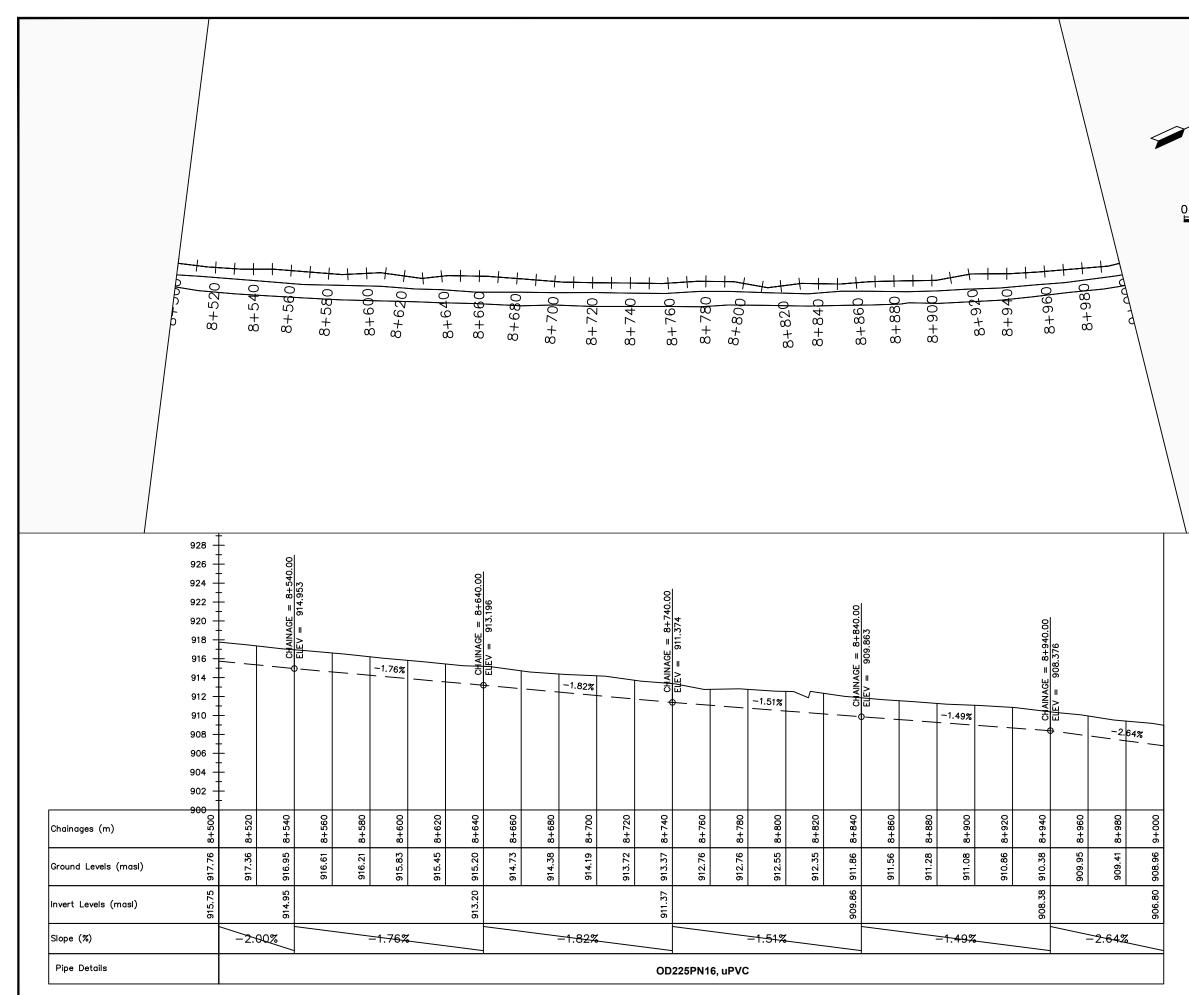



		LEGEND					
	<u>Plan</u>	Torrent size Main					
A		Transmission Main					
		Distribution Main					
	· /	 Road 					
		Building					
		Contours					
2000 4000	Profile						
		— Ground Level					
		— Invert Level					
	AV	Air Valve					
	WO	Washout					
	10	Node detail No.					
	CLIENT :						
		THE REPUBLIC OF UGANDA					
	-	OF WATER AND ENVIRONMENT					
	CO-FINANCED B						
	(
	CONSULTANT :						
		Alliance Consultants Itd					
		In Association with					
		Infra-Consult Ltd					
	PROJECT :						
	ALA-ORA WATER SUPPLY AND SANITATION PROJECT						
		AK WATER SUPPLY AND ANITATION SYSTEM					
	REVISIONS :	Date Description					
	DRAWING TITLE	N MAIN 1 (OFFAKA-JUNC TO NDIRIBA-TANK					
		8+500 - 9+000					
	Surveyed by: R.K Drawn by:						
	, MIC						
	M.K Designed by: W.G	S.M					
	Designed by: W.G Checked by: J.K.I						
	Designed by: Checked by: Date: DRG, No :	K Jary 2023					
	Designed by: Checked by: Date: DRG. No.: N	К					

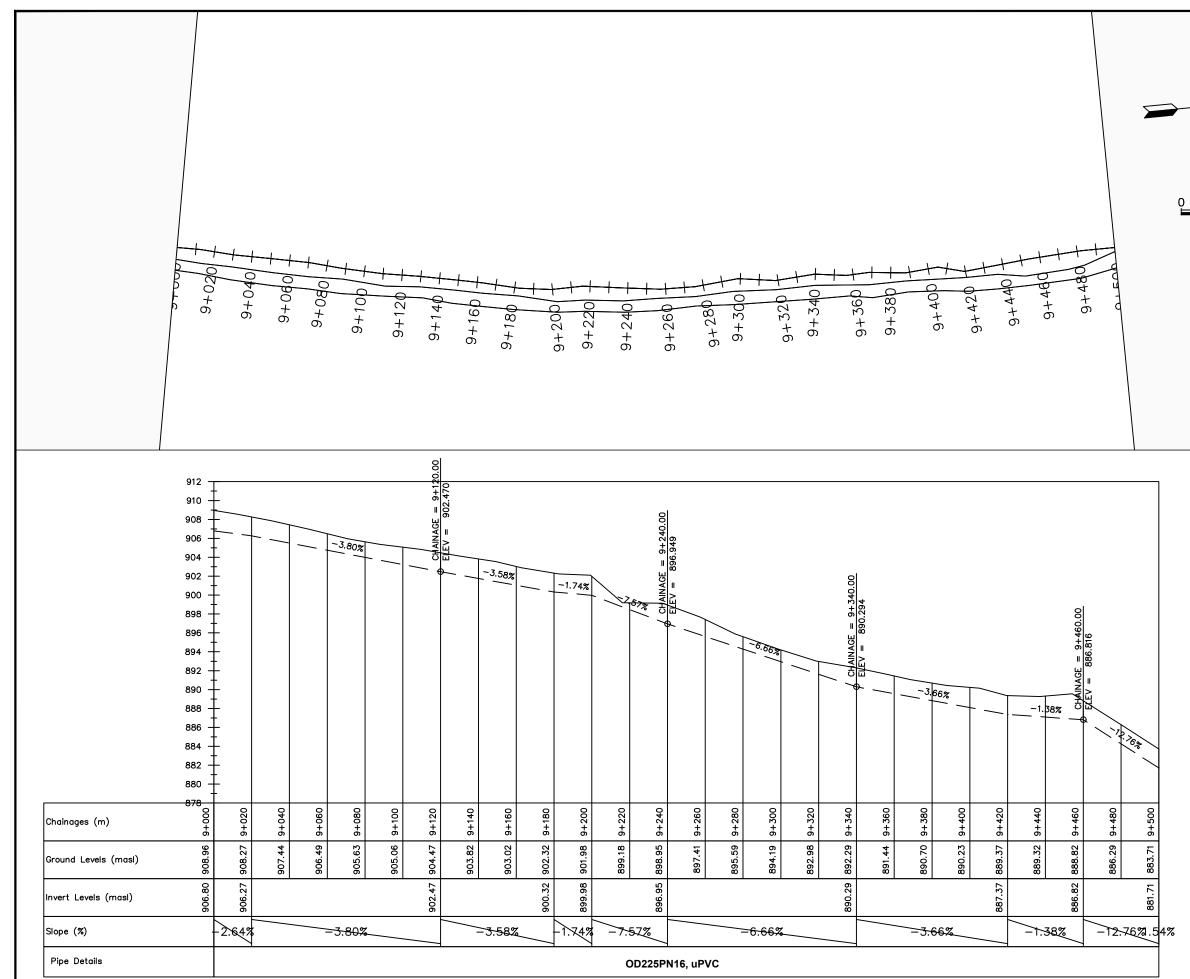



		LEGEND						
	<u>Plan</u>	— Transmission Main						
		Distribution Main						
		Road						
		Building						
		Lanang						
2000 4000		Contours						
	Profile	Ground Level						
		— Invert Level						
	AV	Air Valve						
	WO	Washout						
	10	Node detail No.						
	CLIENT :	X						
	MINISTRY	THE REPUBLIC OF UGANDA OF WATER AND ENVIRONMENT						
	CO-FINANCED E	3Y:						
	(
	CONSULTANT :							
		Alliance Consultants Itd						
	-	In Association with						
	ALA-ORA WATER SUPPLY AND SANITATION PROJECT							
		AK WATER SUPPLY AND ANITATION SYSTEM						
	REVISIONS :	Date Description						
	DRAWING TITLE	N MAIN 1 (OFFAKA-JUNC TO NDIRIBA-TAN 9+000 - 9+500						
	Surveyed by: R.K							
	Drawn by: M.K							
	Designed by: W.C Checked by:							
		K uary 2023						
	DRG No ·	YA-GTM-001 Sheet No.:						
	1:2000	19 of 36						

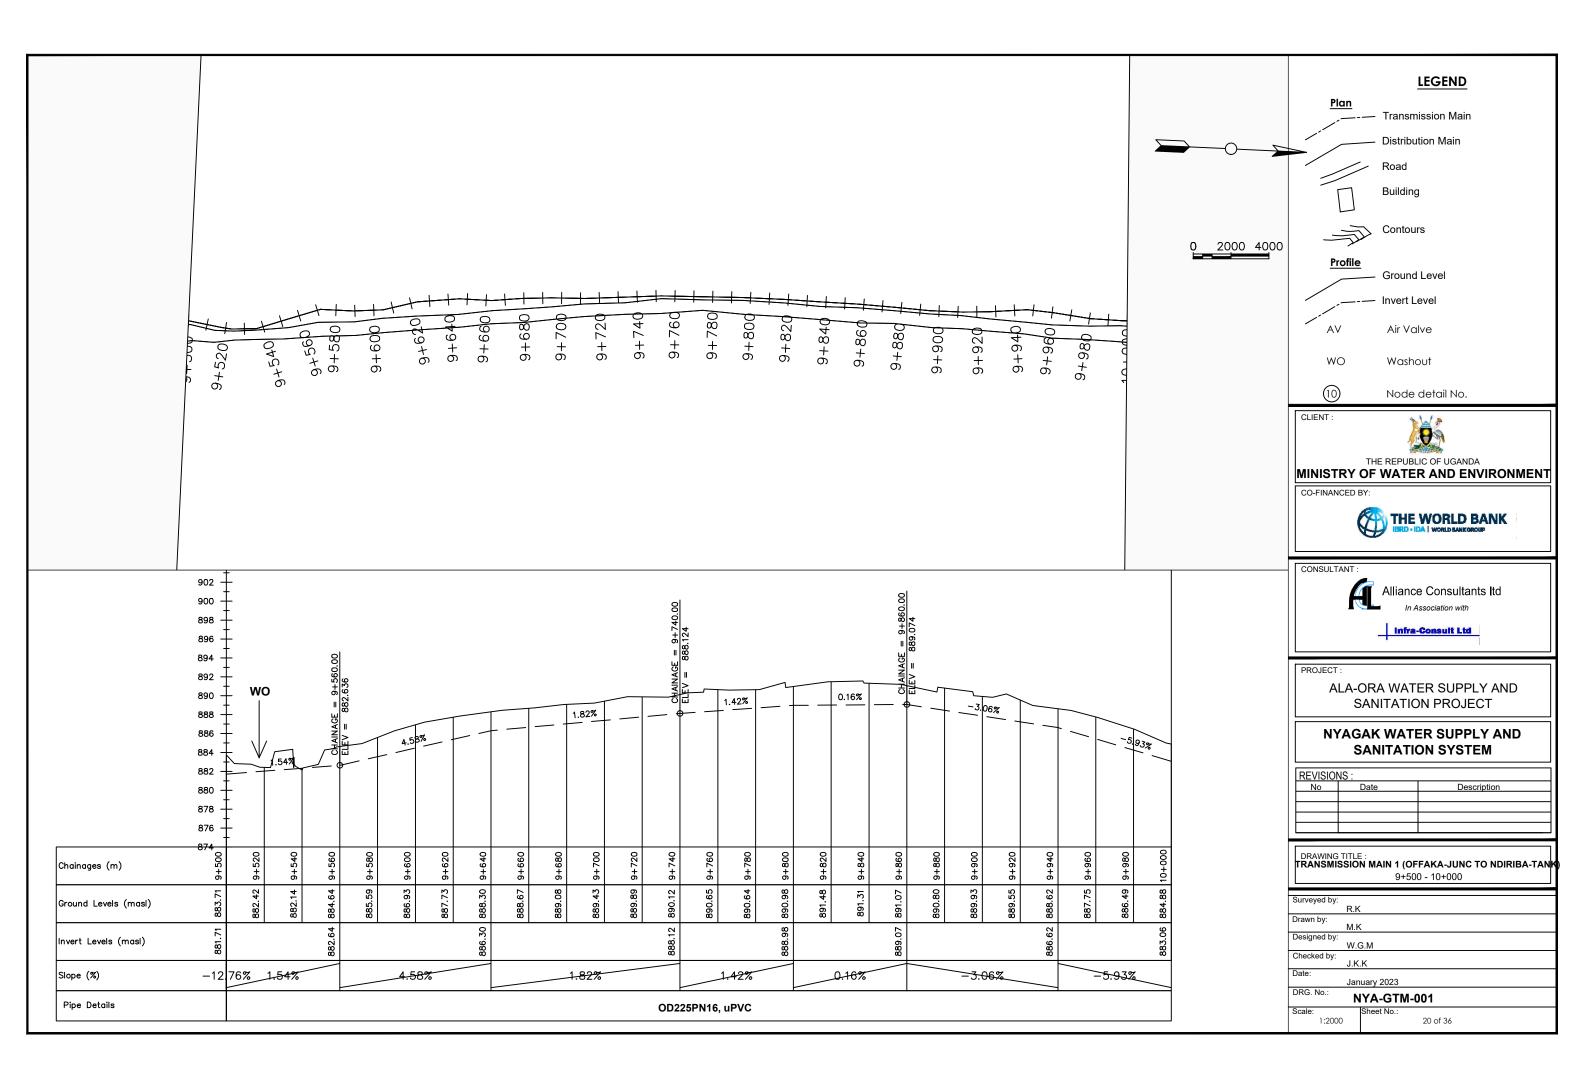

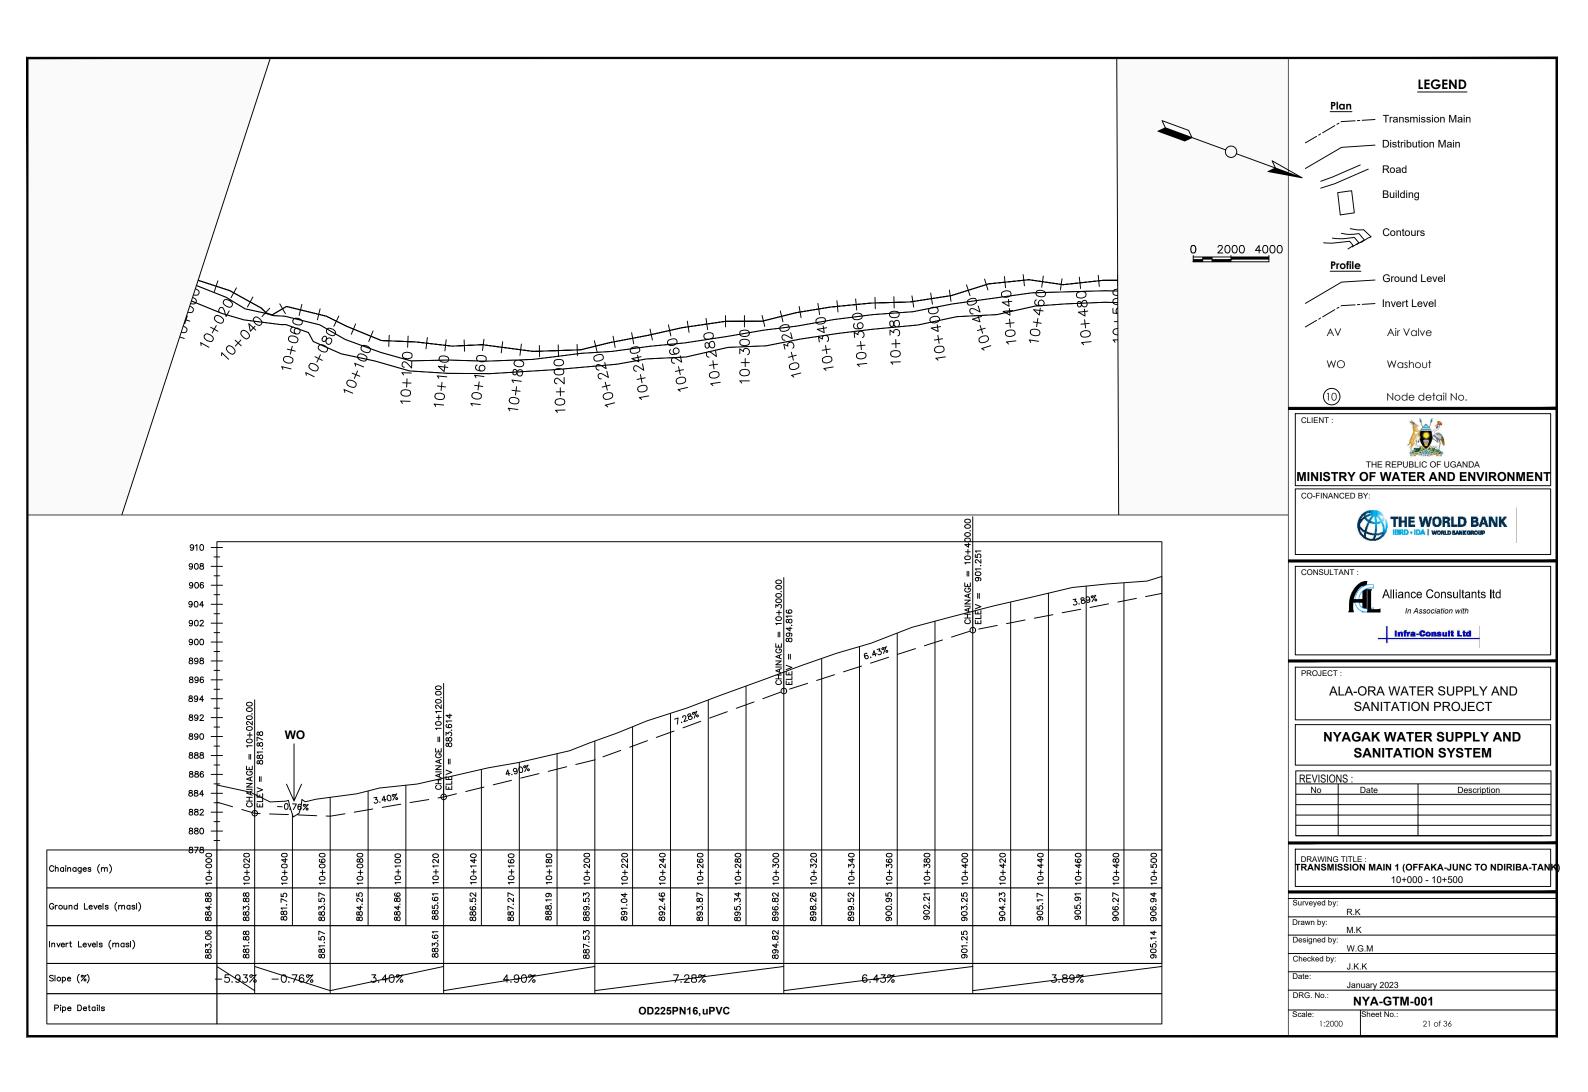


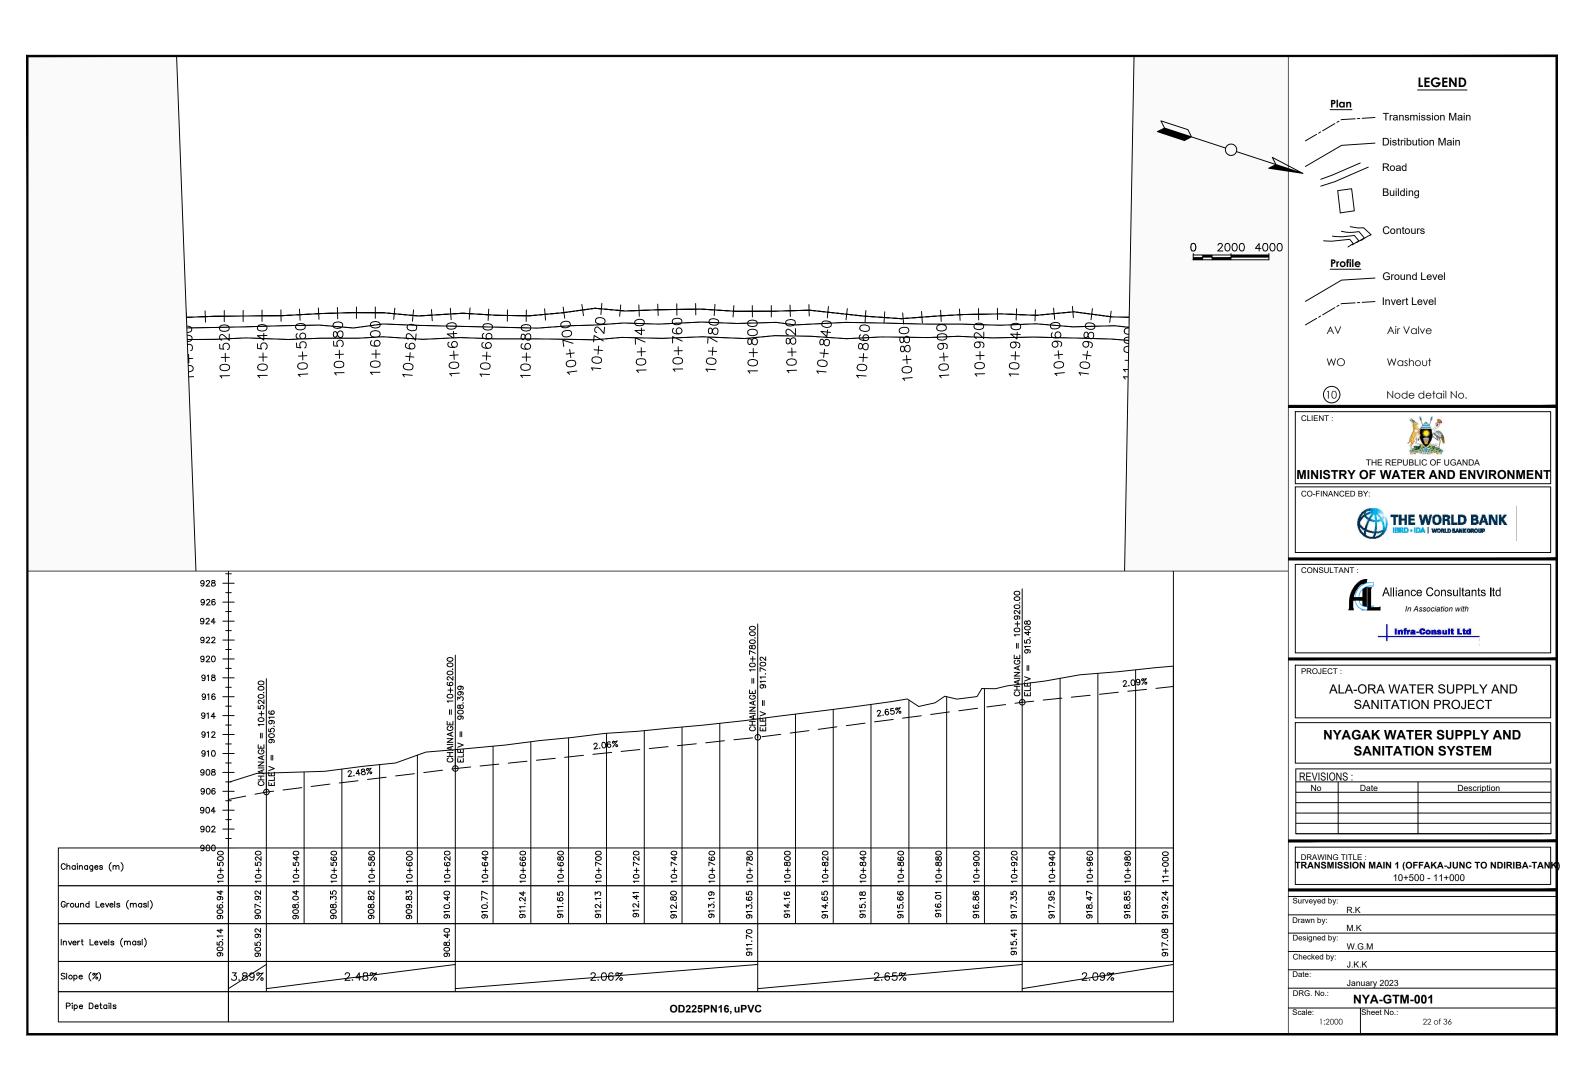


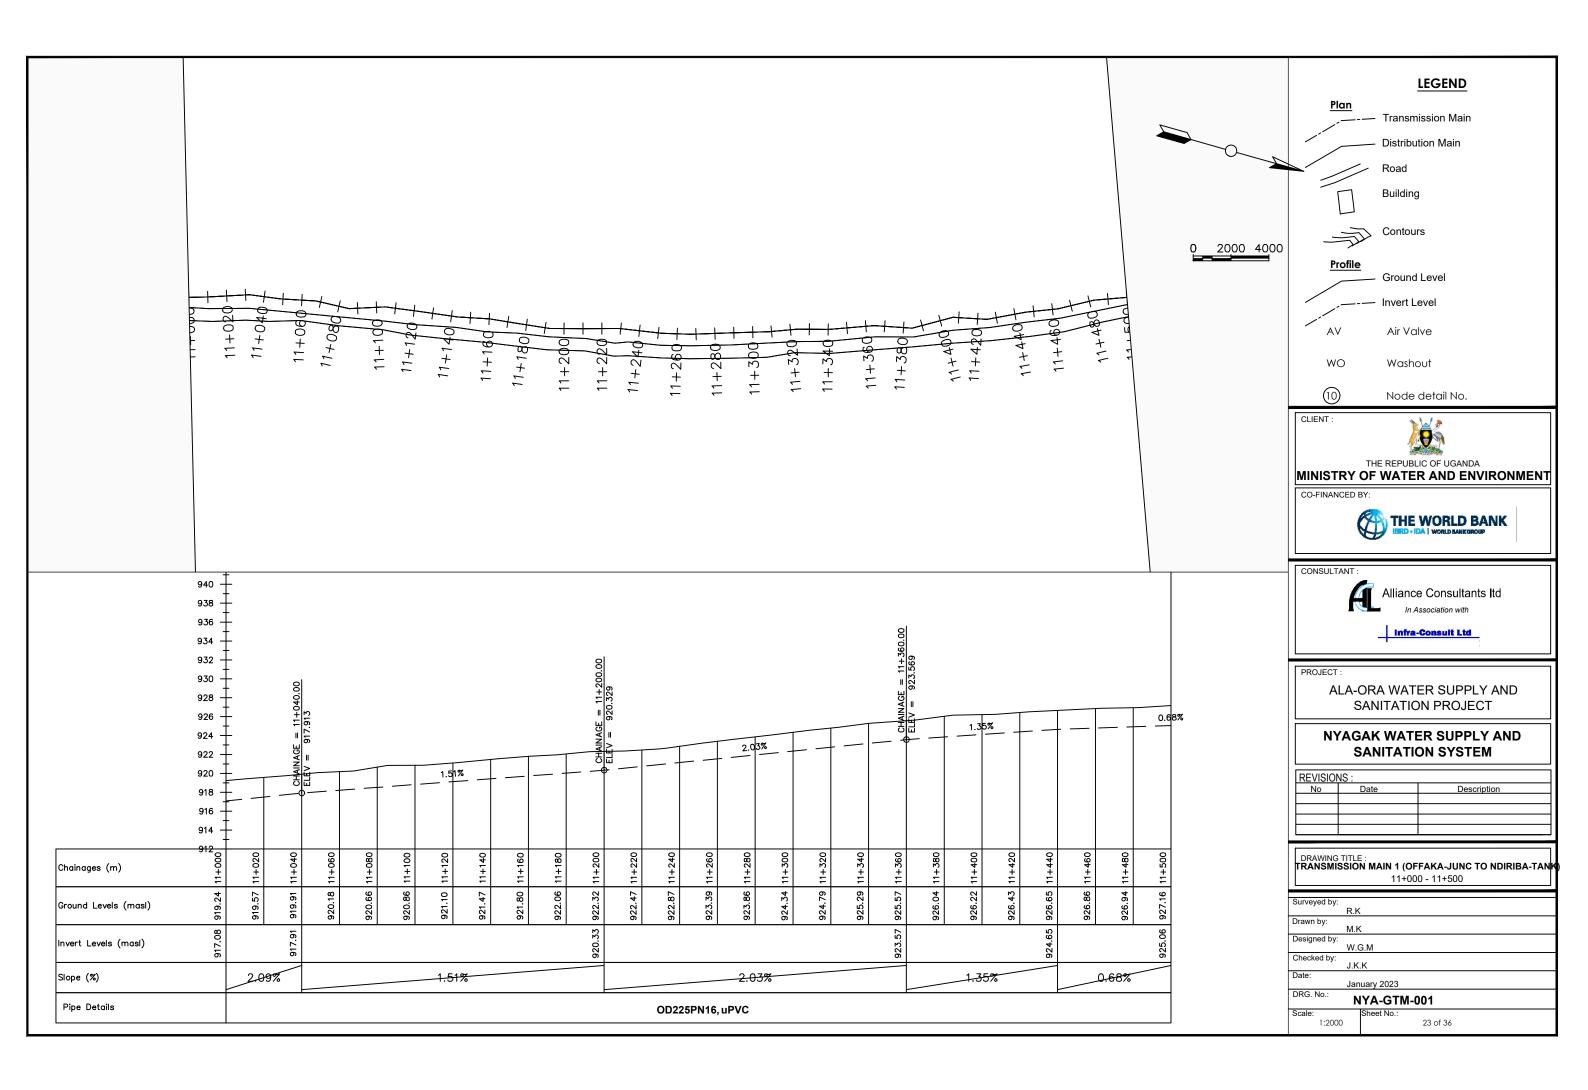


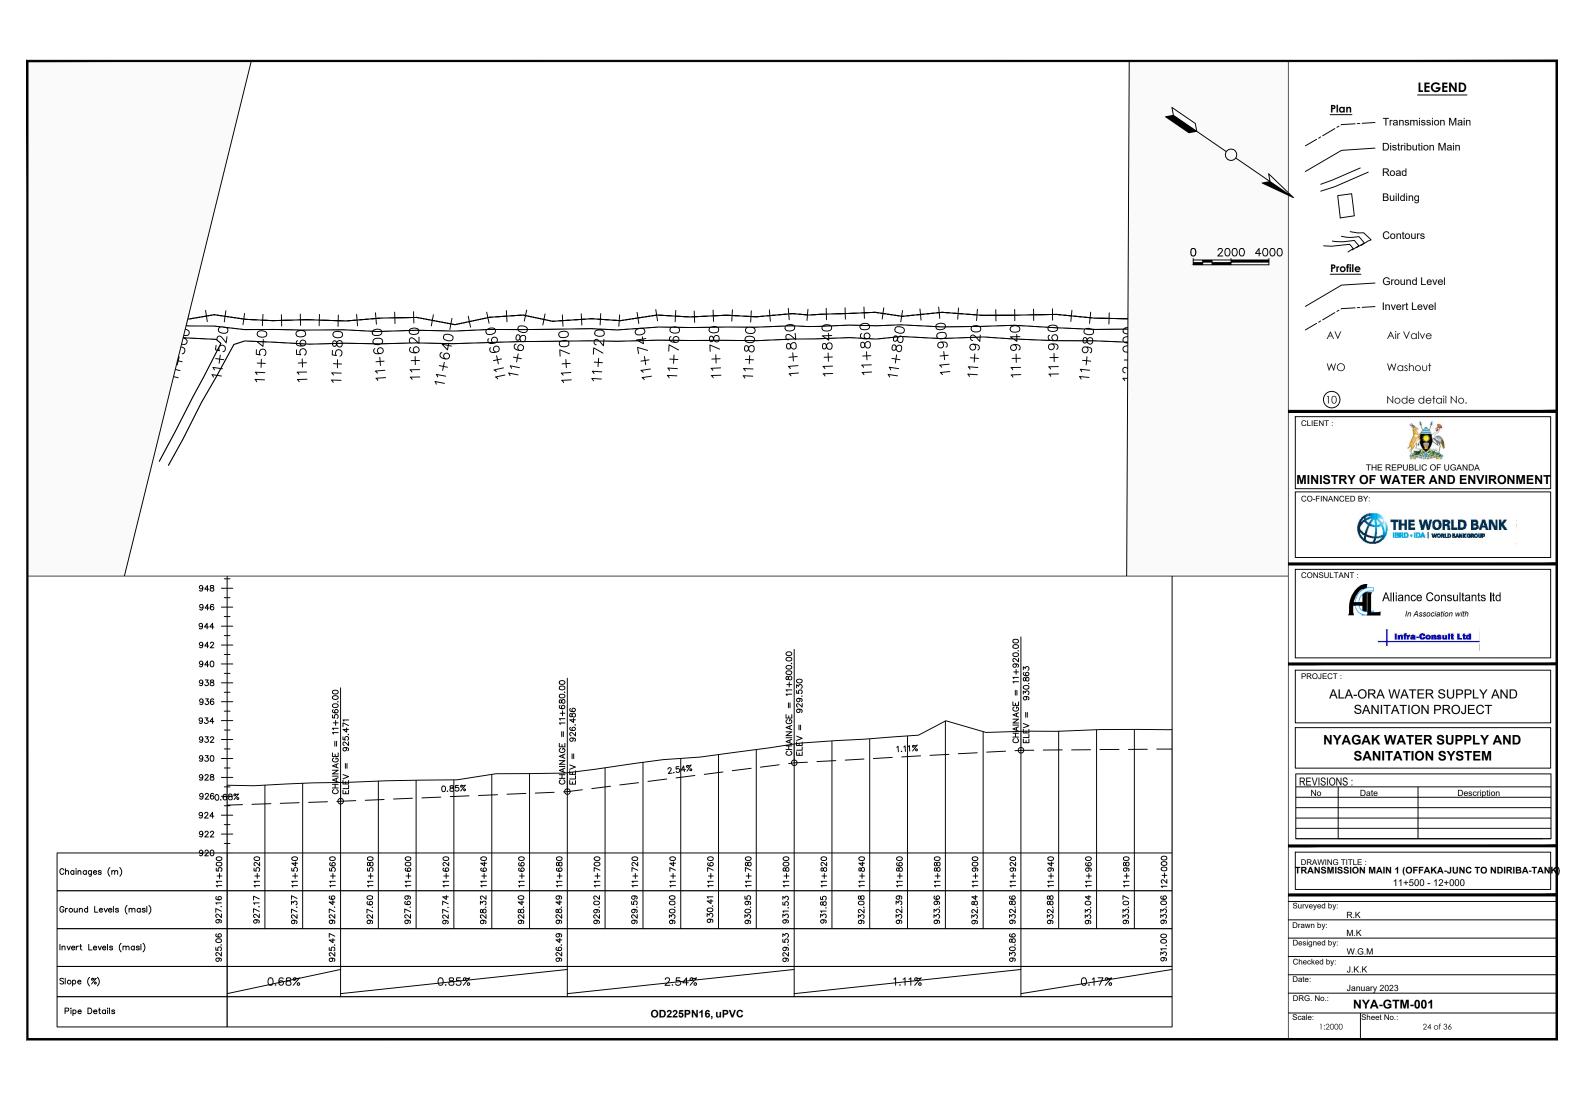



	12+020+	12+040+	12+060+	12+080+	12+120+	12+140+	12+1607	12+180+	12+2007	12+220+	12+240+	12+260+	12+280+	12+300+	12+320+	12+340+	12+360+	12+380+	12+400+	12+420+	+0				
	954 +																								
	954 952 950 948 946 944 944 942 940 938 936 938 936 934 932 930 928	0.1	7%	+			$\frac{1}{10000000000000000000000000000000000$			+	1.11%	3	+		CHAINAGE = 12+300.00					1.52%				CHAINAGE = 12+479.98	
Chainages (m)	926 000 15+ 000 75	12+020		12+060	12+100	12+120	5 12+140	12+160	+ 12+180	12+200	12+220	12+240	12+260	12+280	12+300	12+320	12+340	12+360	12+380	12+400	12+420		12+460	12+480	12+500
Ground Levels (masl)	933.06	933.16	933.08	933.13	933.02	933.22	933.23	933.21	933.44	933.68	933.89	934.19	934.35	934.68	935.01	935.30	935.53	935.54	935.99	936.27	936.74	936.86	937.32	937.75	937.61
Invert Levels (masl)	931.00		_				931.23			_					933.01									935.75	935.46
Slope (%)				0.17%							1.119	%								1.52%					-1.46%
Pipe Details												OD225F	PN16, uF	PVC											

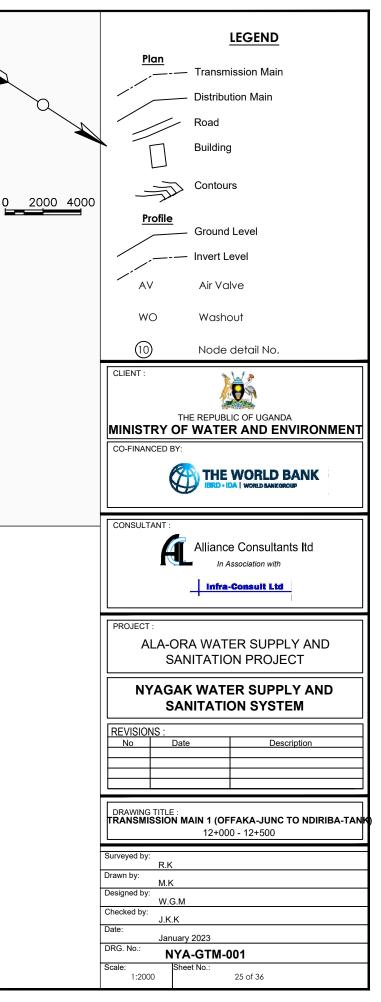

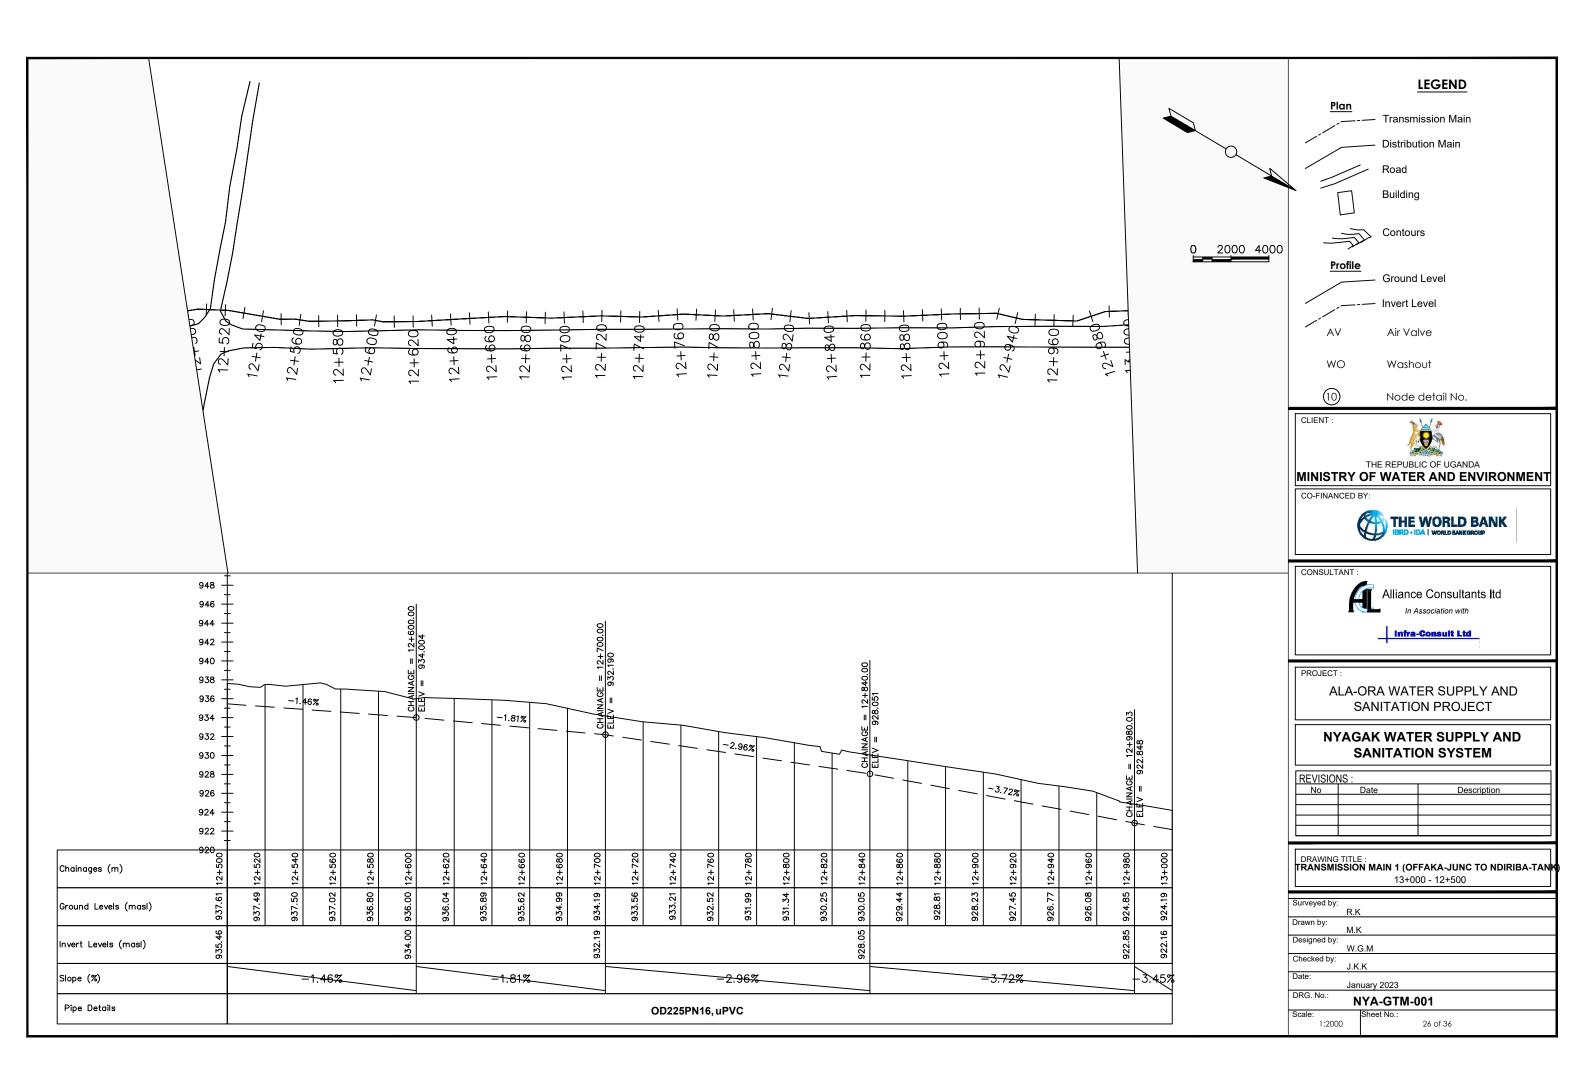


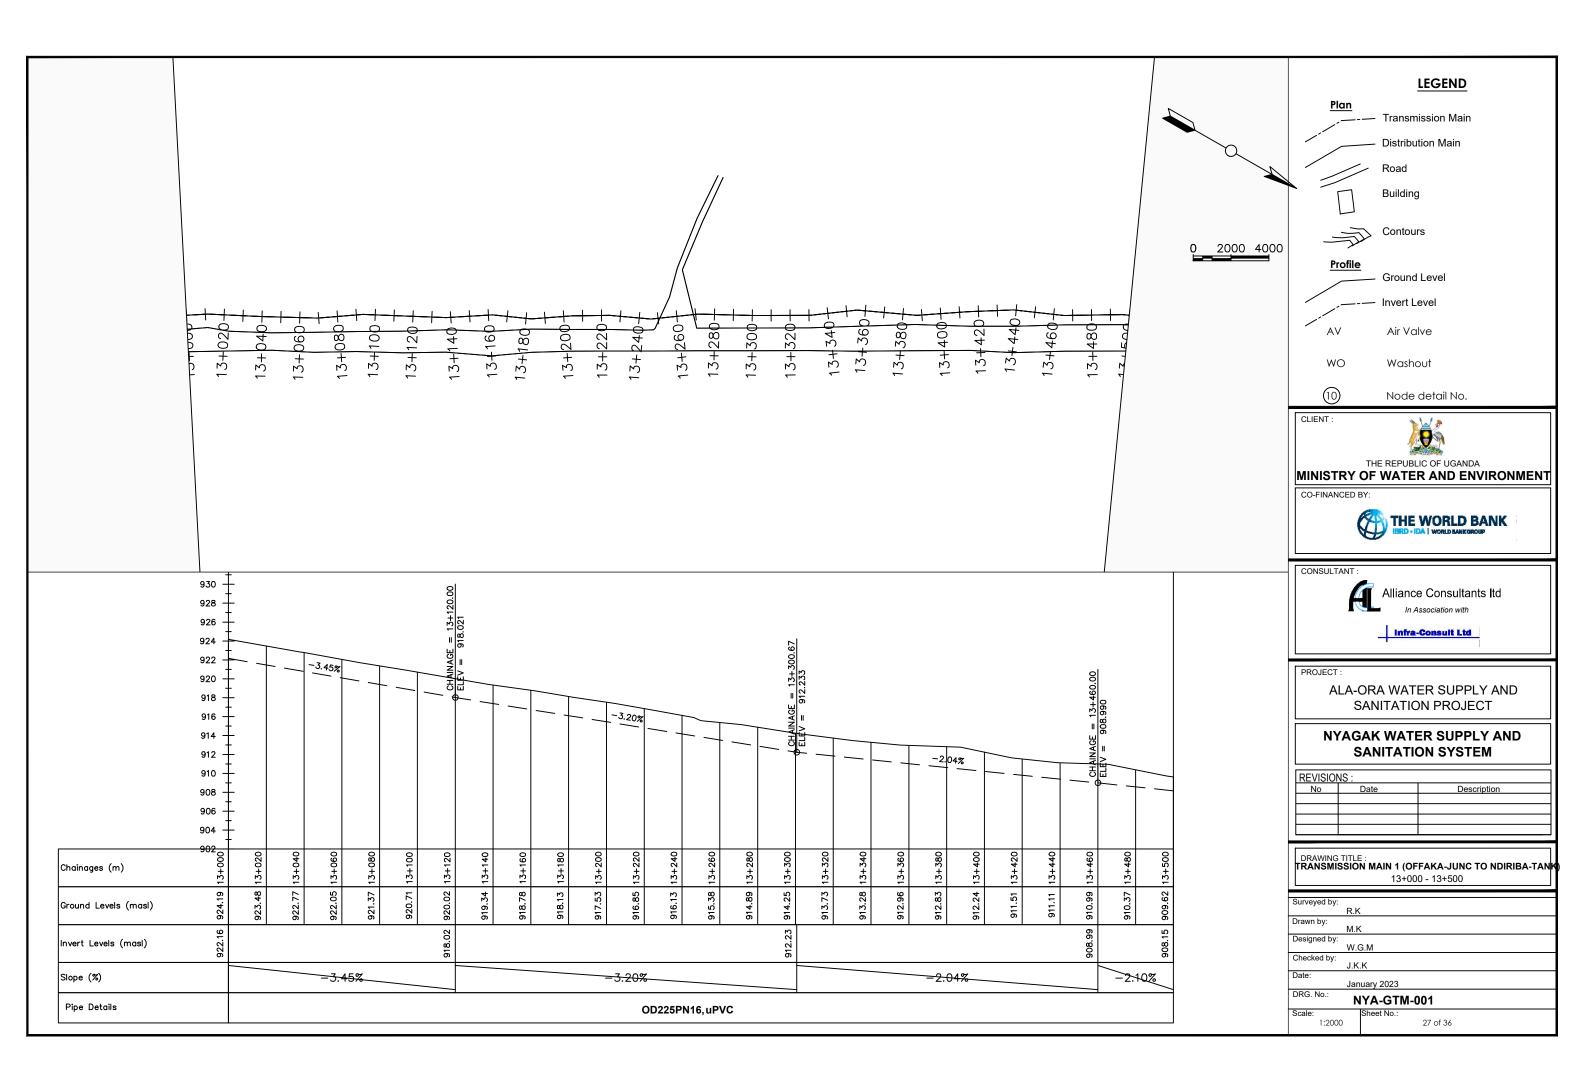

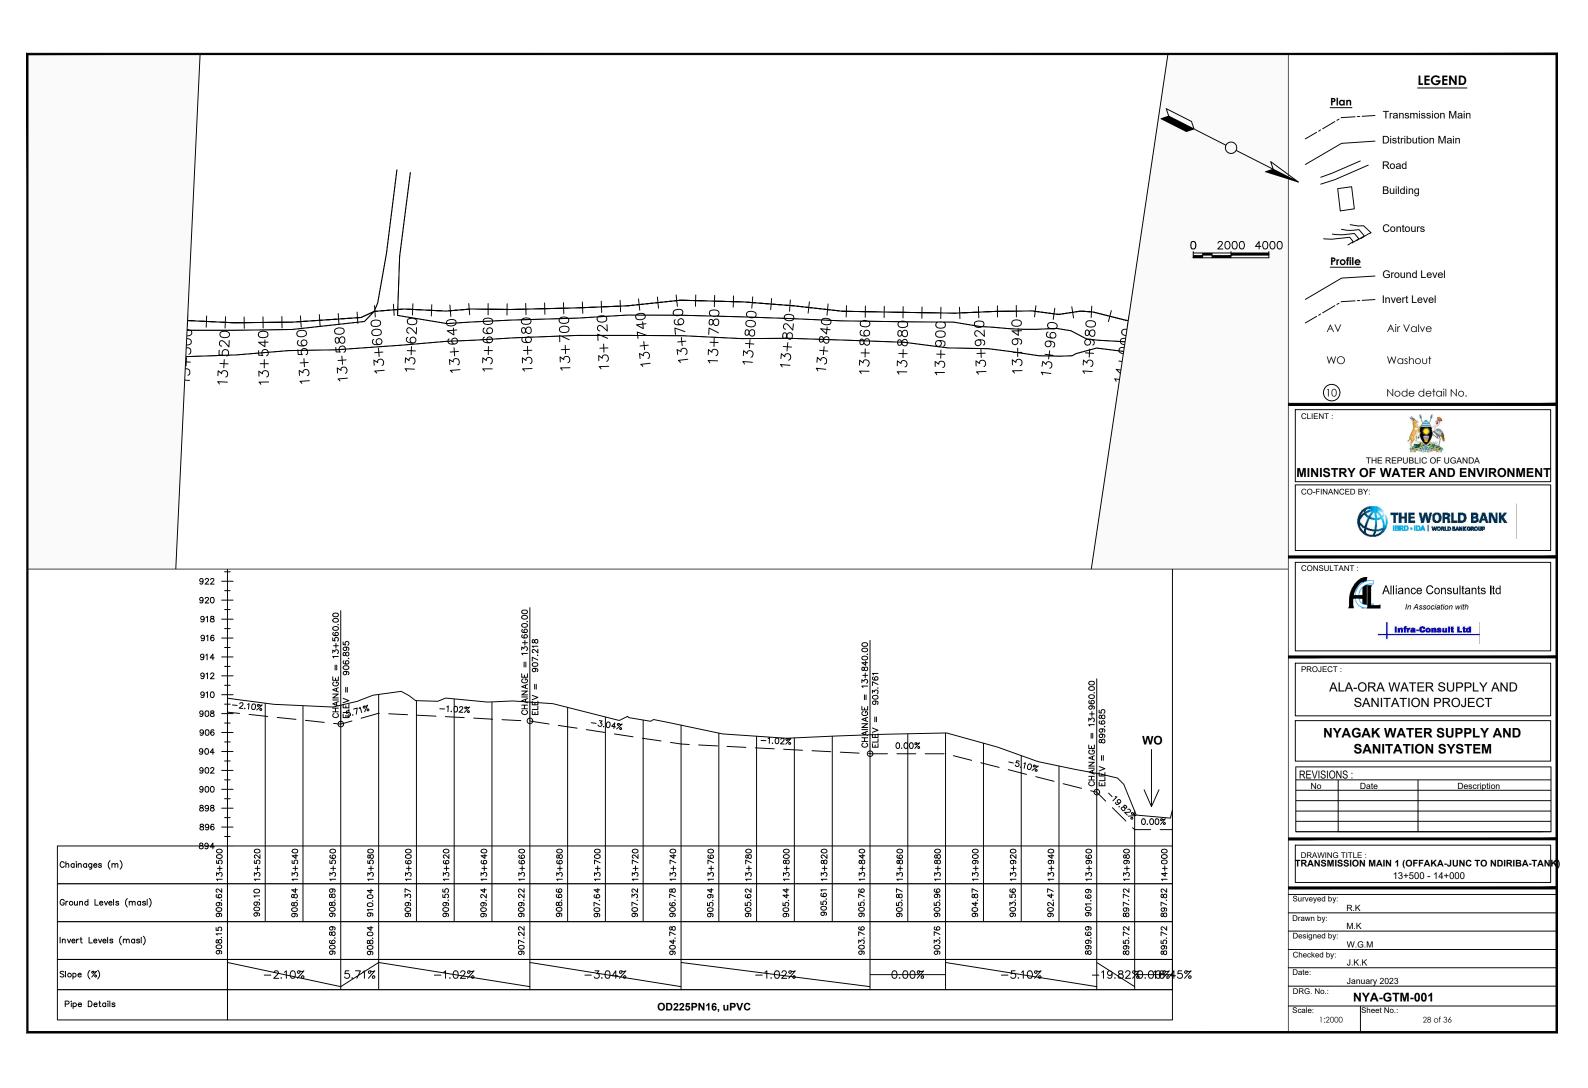

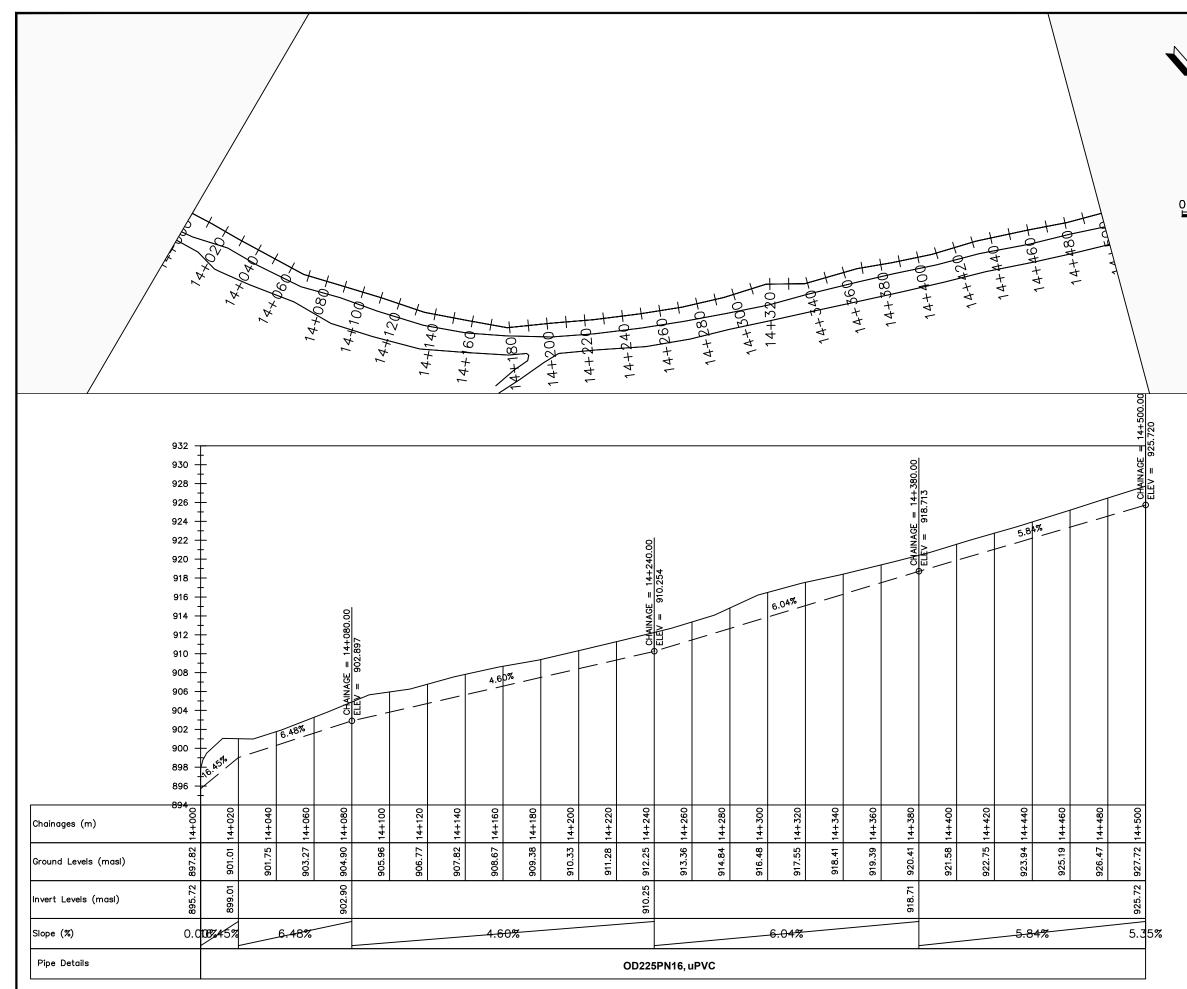



	Plan	LEGEND
	<u>Plan</u>	Transmission Main
\mathbf{b}		— Distribution Main
Υ.		Road
×		Building
`		─ Contours
2000 4000		
	Profile	Ground Level
		Invert Level
	AV	Air Valve
	WO	Washout
		Node detail No.
	CLIENT :	
		THE REPUBLIC OF UGANDA
	_	OF WATER AND ENVIRONMENT
	CO-FINANCED	
	CONSULTANT :	
		Alliance Consultants Itd
	7	In Association with
		Infra-Consult Ltd
	PROJECT :	
		ORA WATER SUPPLY AND
	-	GAK WATER SUPPLY AND
	REVISIONS :	
	No	Date Description
		N MAIN 1 (OFFAKA-JUNC TO NDIRIBA-TAN
		N MAIN 1 (OFFAKA-JUNC TO NDIRIBA-TAN 14+000 - 14+500
	Surveyed by: R.K	
	Drawn by: M.Ł Designed by:	
	W.0 Checked by: J.K	З.М .К
	Date: Jar	uary 2023
	Scale:	IYA-GTM-001 Sheet No.:
	1:2000	29 of 36

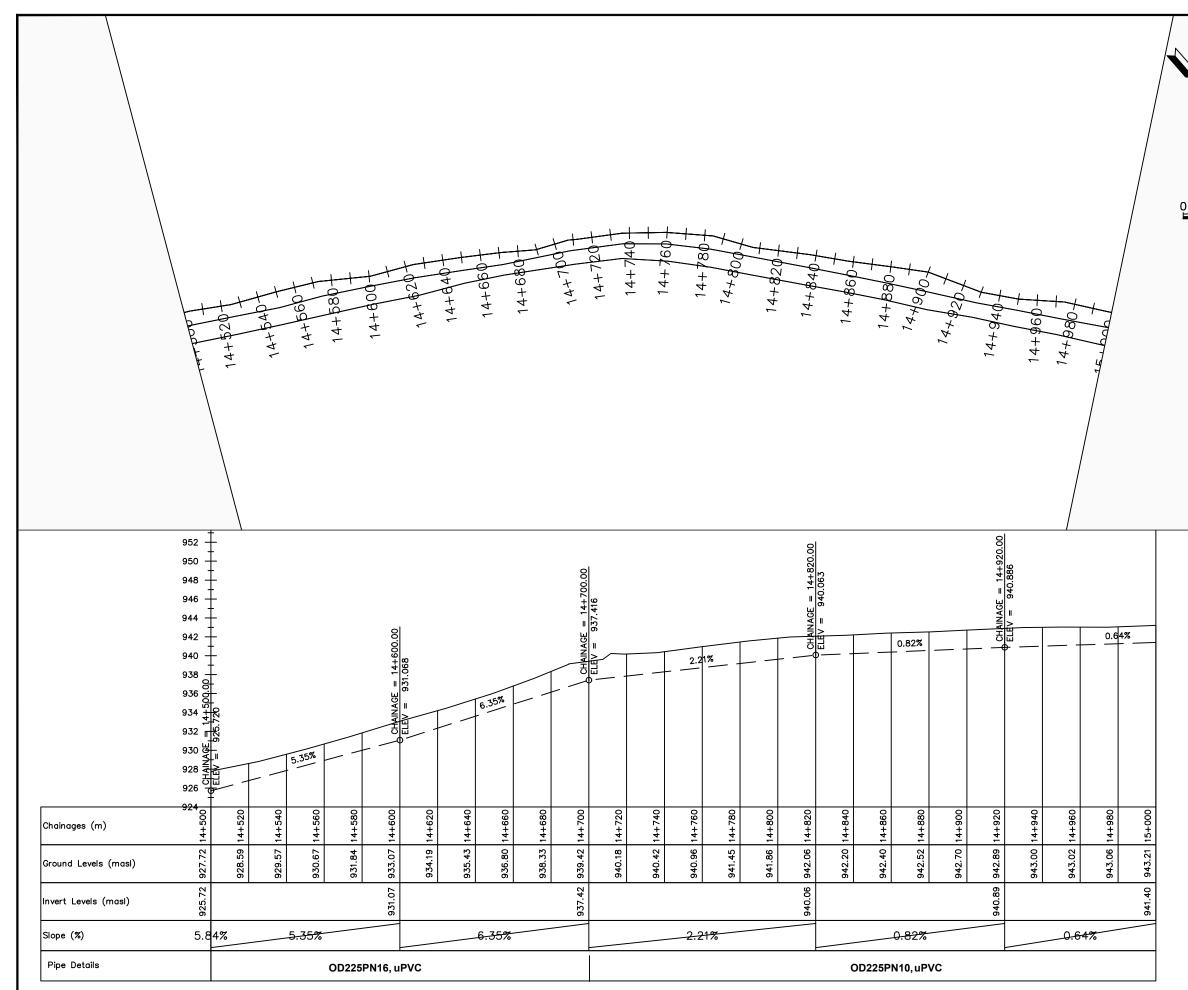



		LEGEND
	<u>Plan</u>	— Transmission Main
\mathbf{h}		Distribution Main
\sim		 Road
		Building
2000 4000	T	Contours
	<u>Profile</u>	— Ground Level
		- Invert Level
	AV	Air Valve
	WO	Washout
	10	Node detail No.
	CLIENT :	
		THE REPUBLIC OF UGANDA
	CO-FINANCED B	
	(
	CONSULTANT :	Alliance Consultants Itd
		In Association with
		Infra-Consult Ltd
	PROJECT :	
		ORA WATER SUPPLY AND ANITATION PROJECT
		AK WATER SUPPLY AND ANITATION SYSTEM
	REVISIONS :	Date Description
	DRAWING TITLE	MAIN 1 (OFFAKA-JUNC TO NDIRIBA-TAN) 14+500 - 15+000
	Surveyed by:	
	Drawn by: M.K	
	Designed by: W.G Checked by:	G.M
	J.K.	K uary 2023
	DRG. No.: N	YA-GTM-001
	Scale: 1:2000	Sheet No.: 30 of 36


	240 040	15 + 100 + 15 + 100 + 15 + 100 + 15 + 120 + 15 + 120 + 15 + 120 + 15 + 160 + 15 + 180 + 15 + 15 + 180 + 15 + 180 + 15 + 180 + 15 + 180 + 15 + 180 + 15 + 180 + 15 + 180 + 15 + 180 + 15 + 180 + 15 + 15 + 15 + 15 + 15 + 15 + 15 + 1	15+200+ 15+220+ 15+240+ 15+260+ 15+280+ 15+280+	15+320+15+340+15+360+15+360+15+380+15-380+15-380+15-380+15-380+15-380+15-380-10000000000000000000000000000000000	
966 - 964 - 962 - 960 - 958 - 958 - 955 - 955 - 952 - 950 - 948 - 944 - 944 - 944 - 944 - 942 - 940 - 942 - 940 - 942 - 942 - 944 - 942 - 944 - 942 - 944 - 942 - 944 - 945 - 945 - 945 - 948 - 946 - 948 -	943.38 15+020	943.71 943.78 944.11 944.43 944.75	045.17 15+200 046.17 15+200 0946.24 15+200 0946.24 15+200 0946.24 15+200 0946.17 15+260 0946.17 15+260 0946.17 15+280 000 000 000 000 000 000 000	946.43 15+300 946.48 15+320 946.48 15+320 946.55 15+340 946.84 15+360 946.84 15+360 946.76 15+380 CHAINAG	

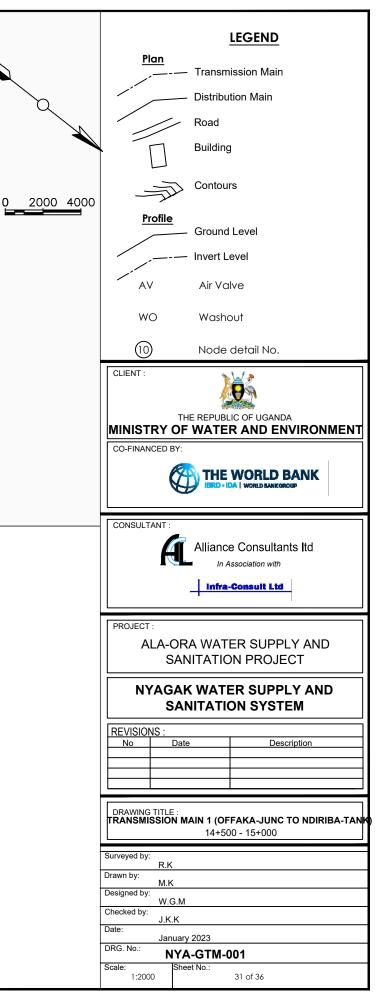


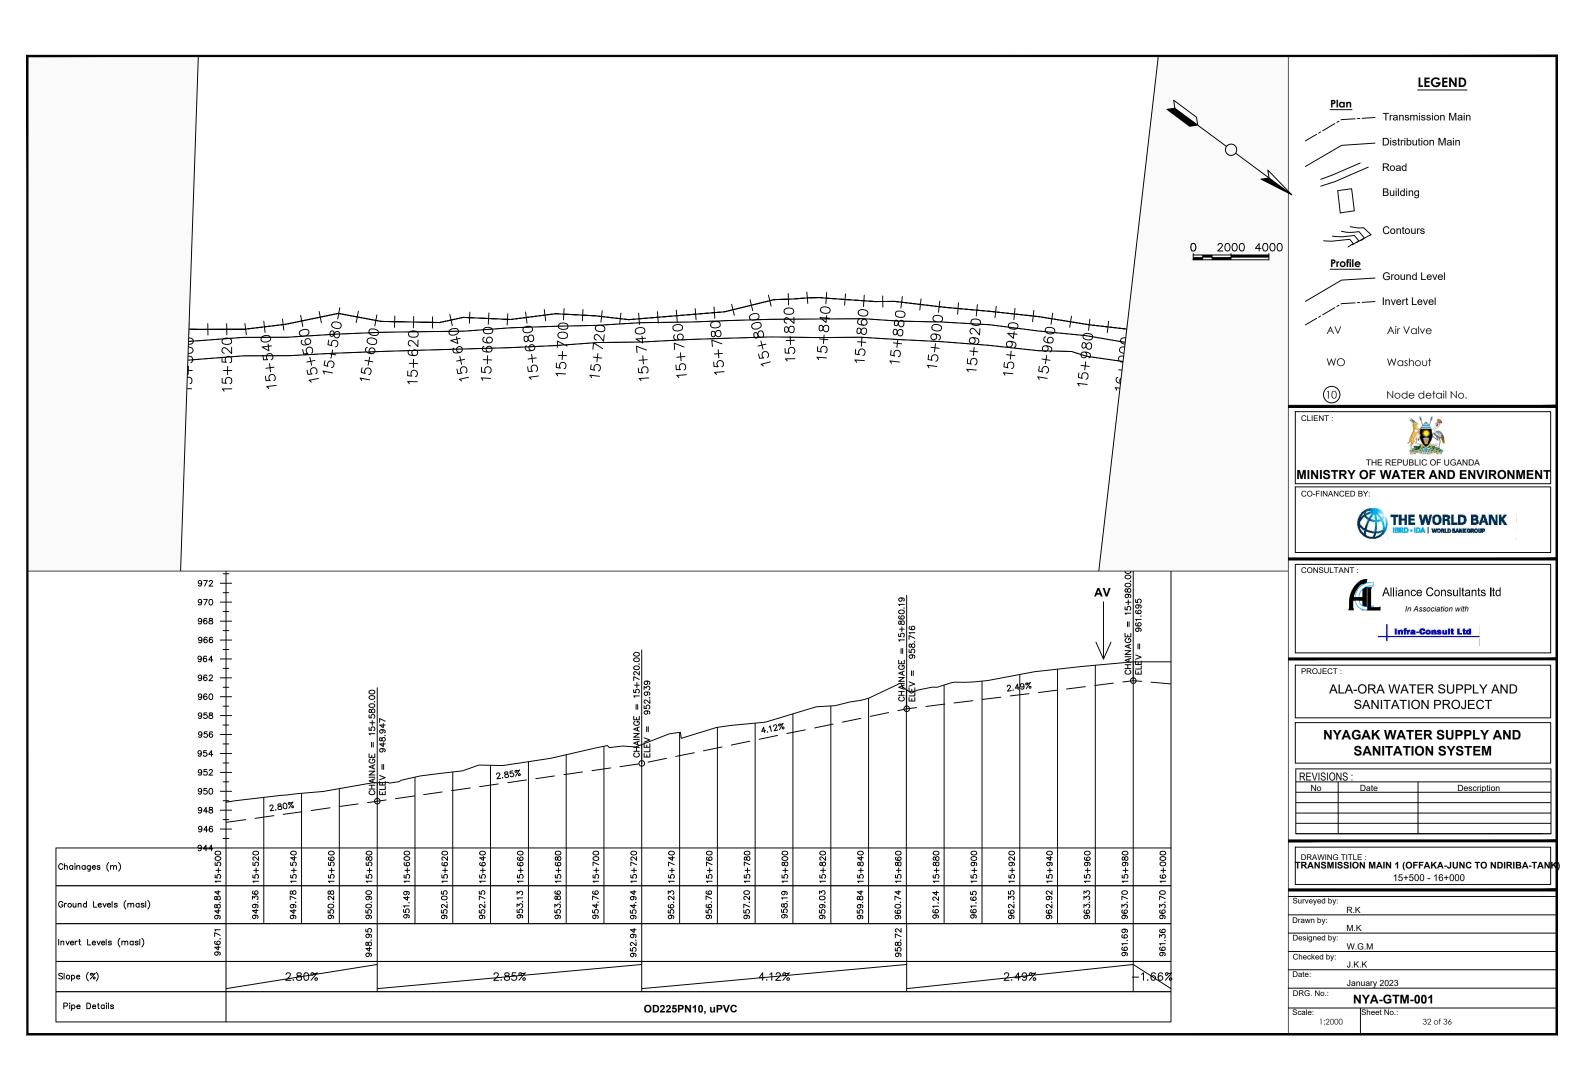

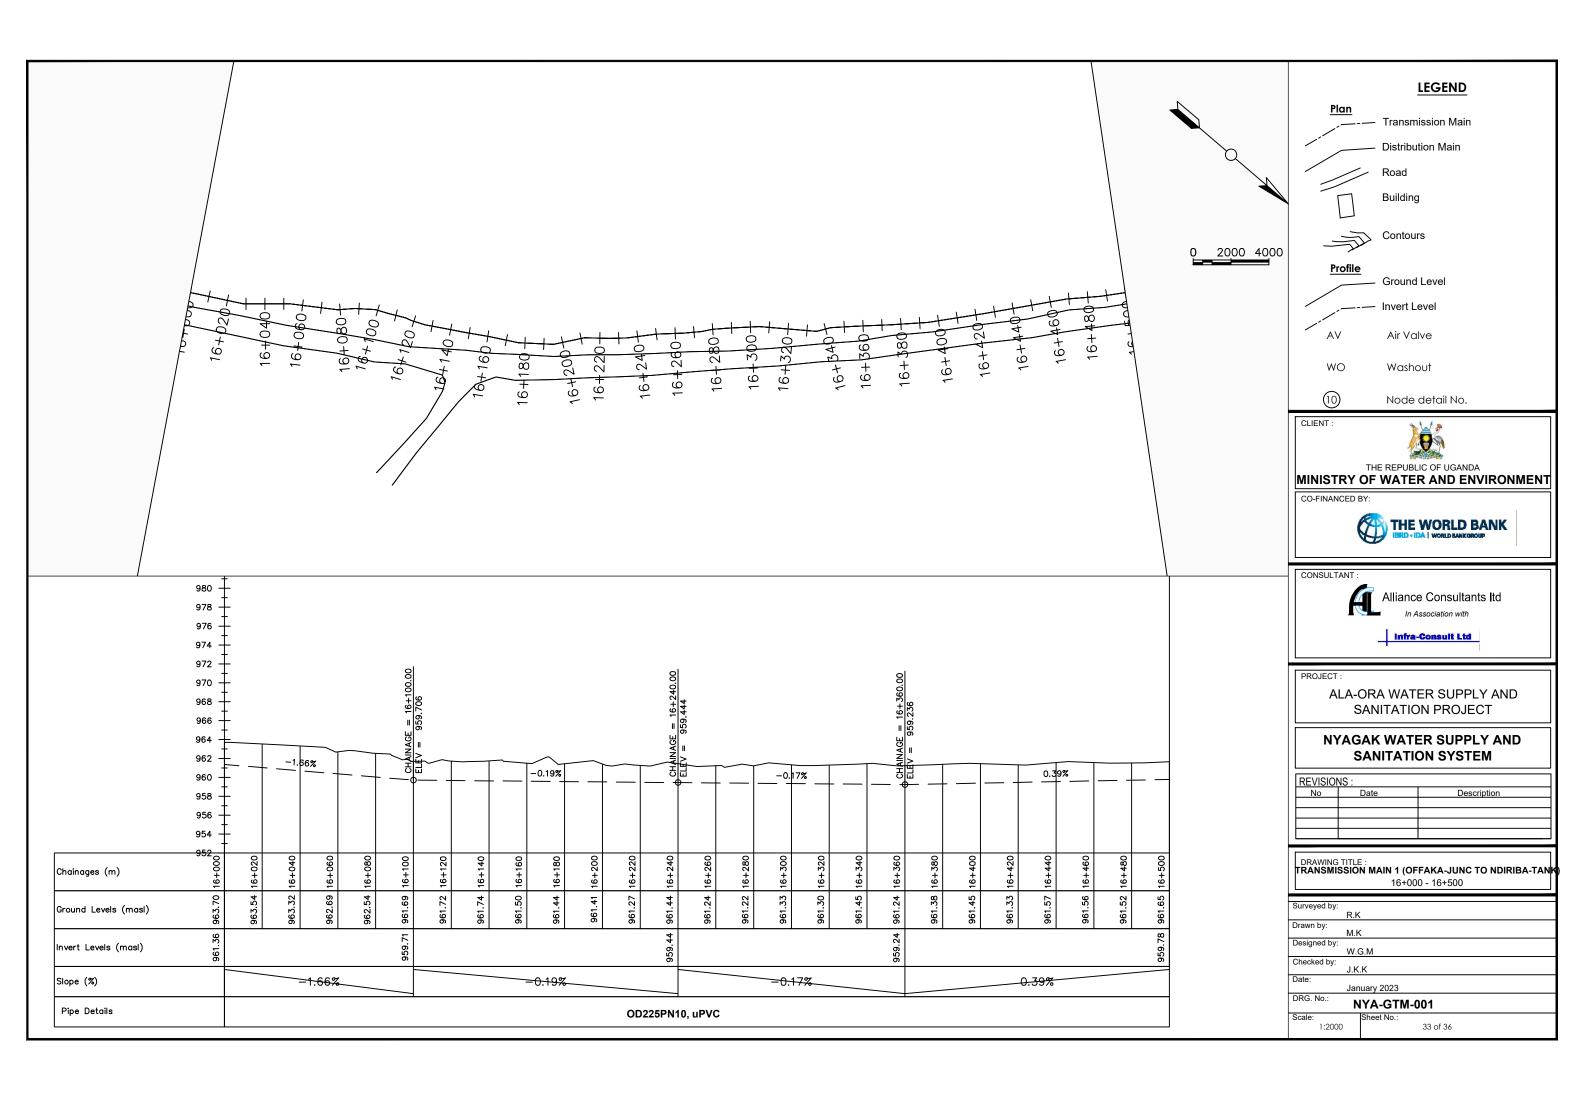


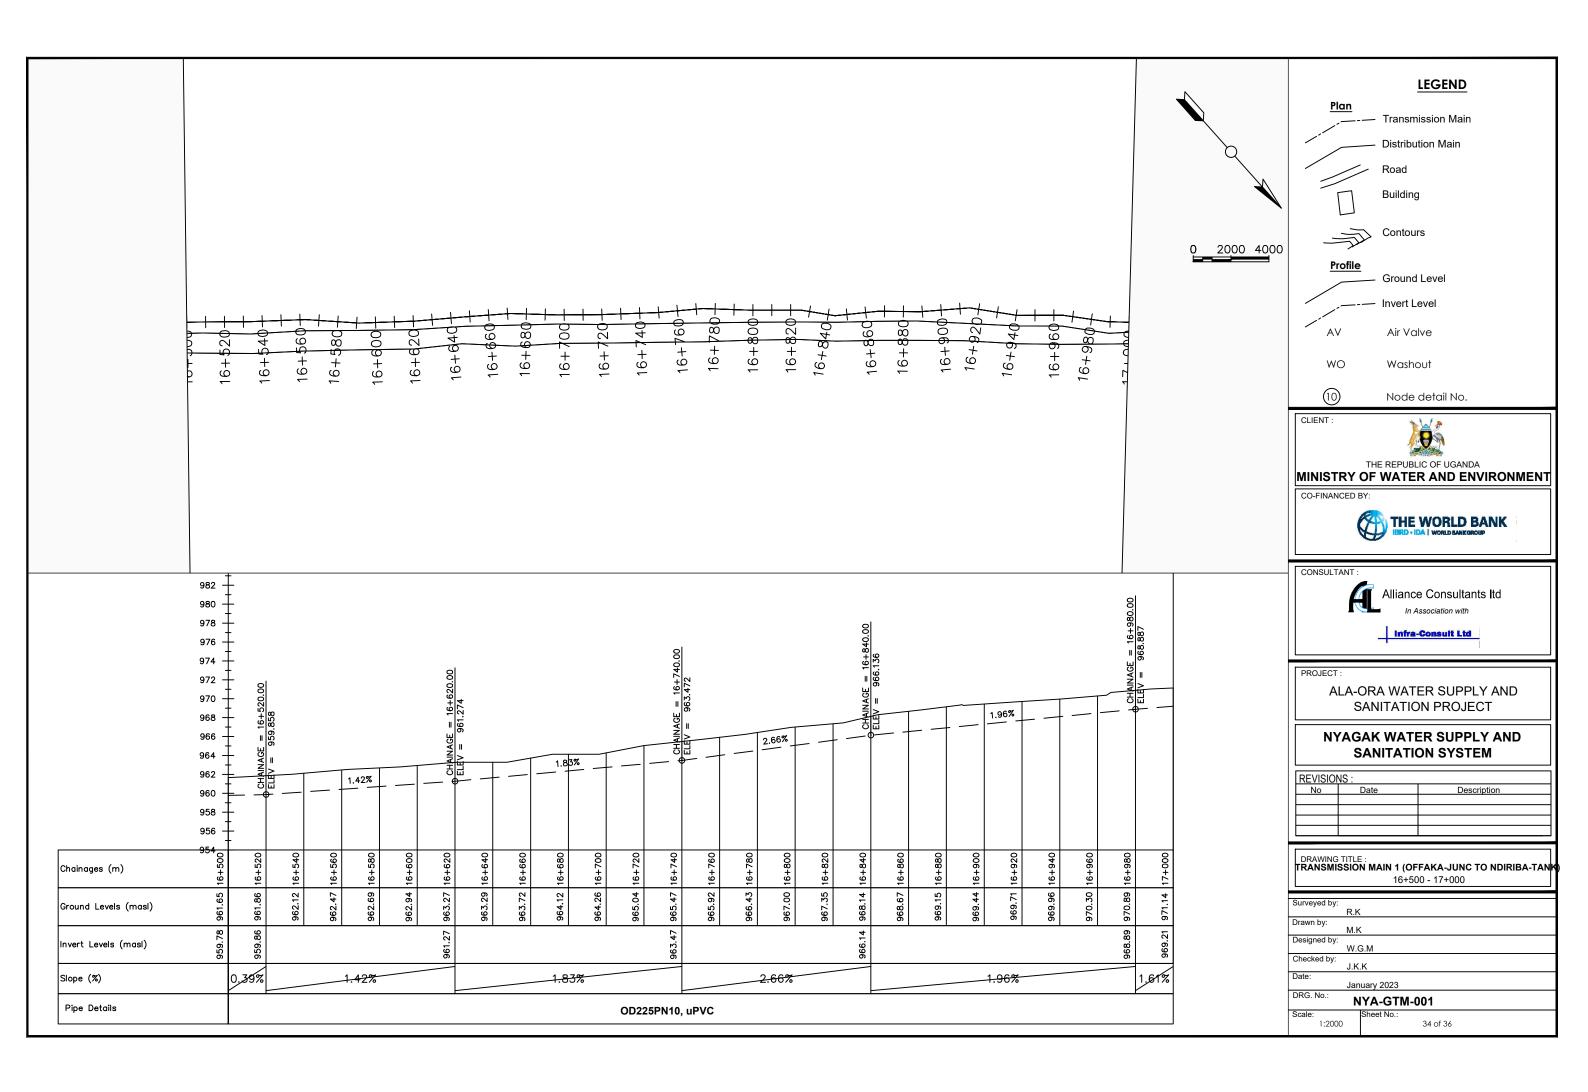


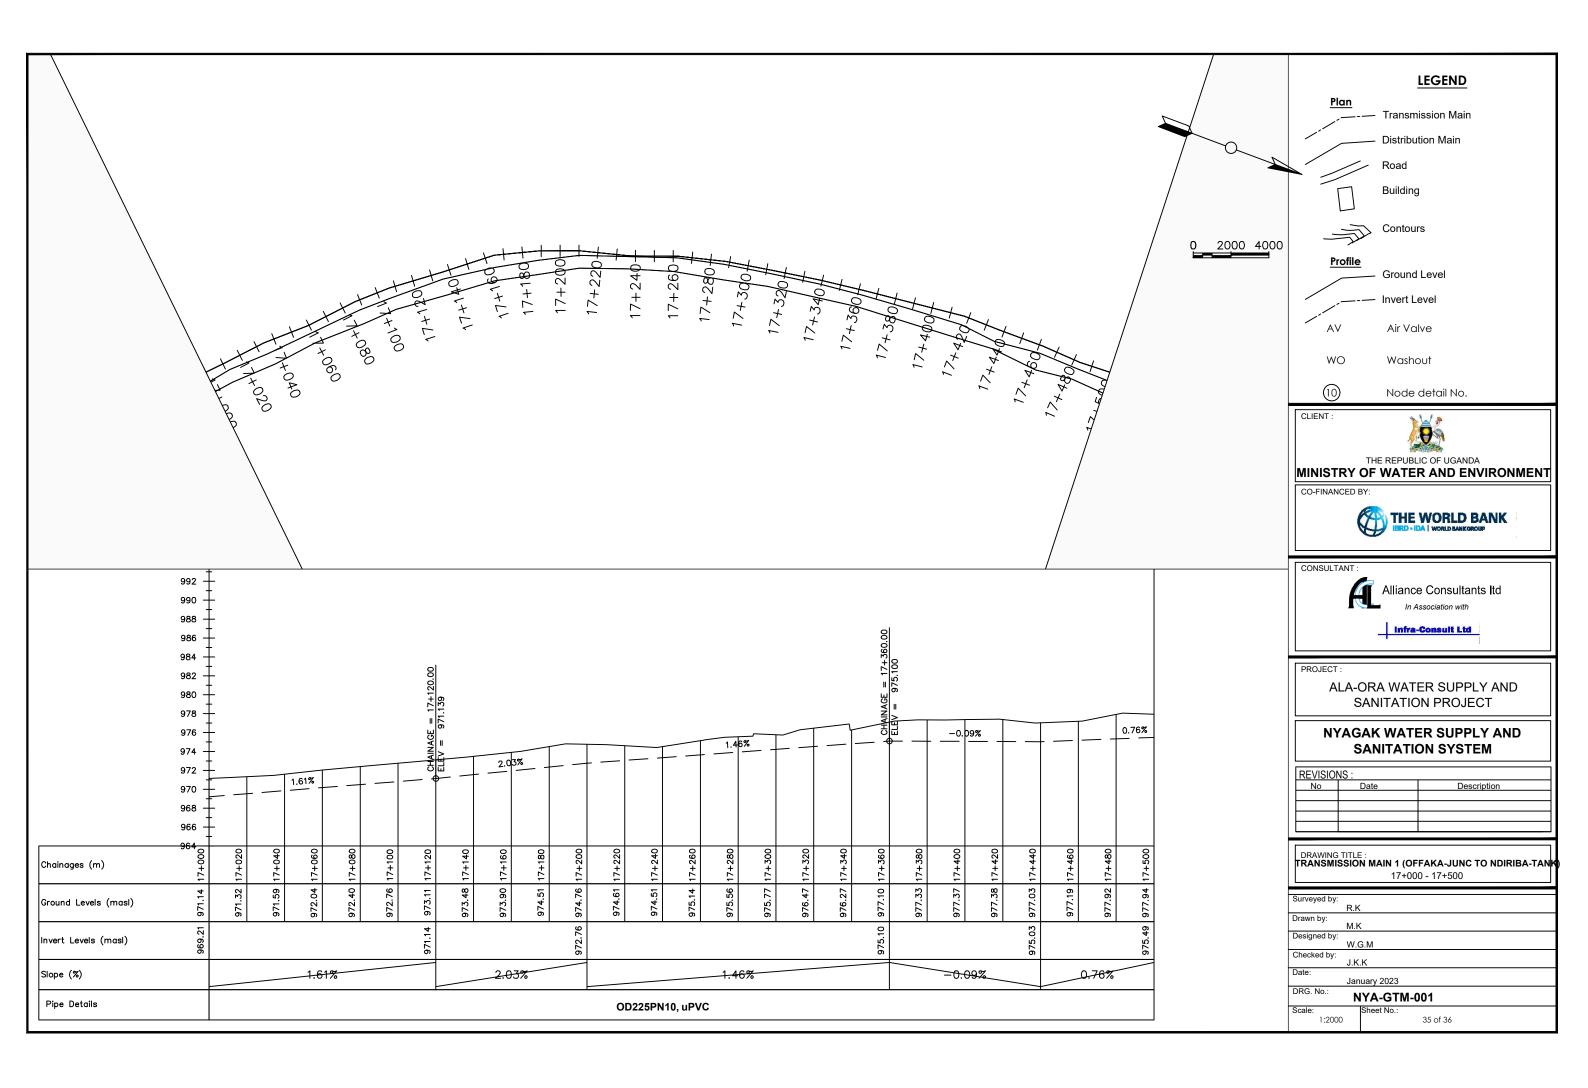


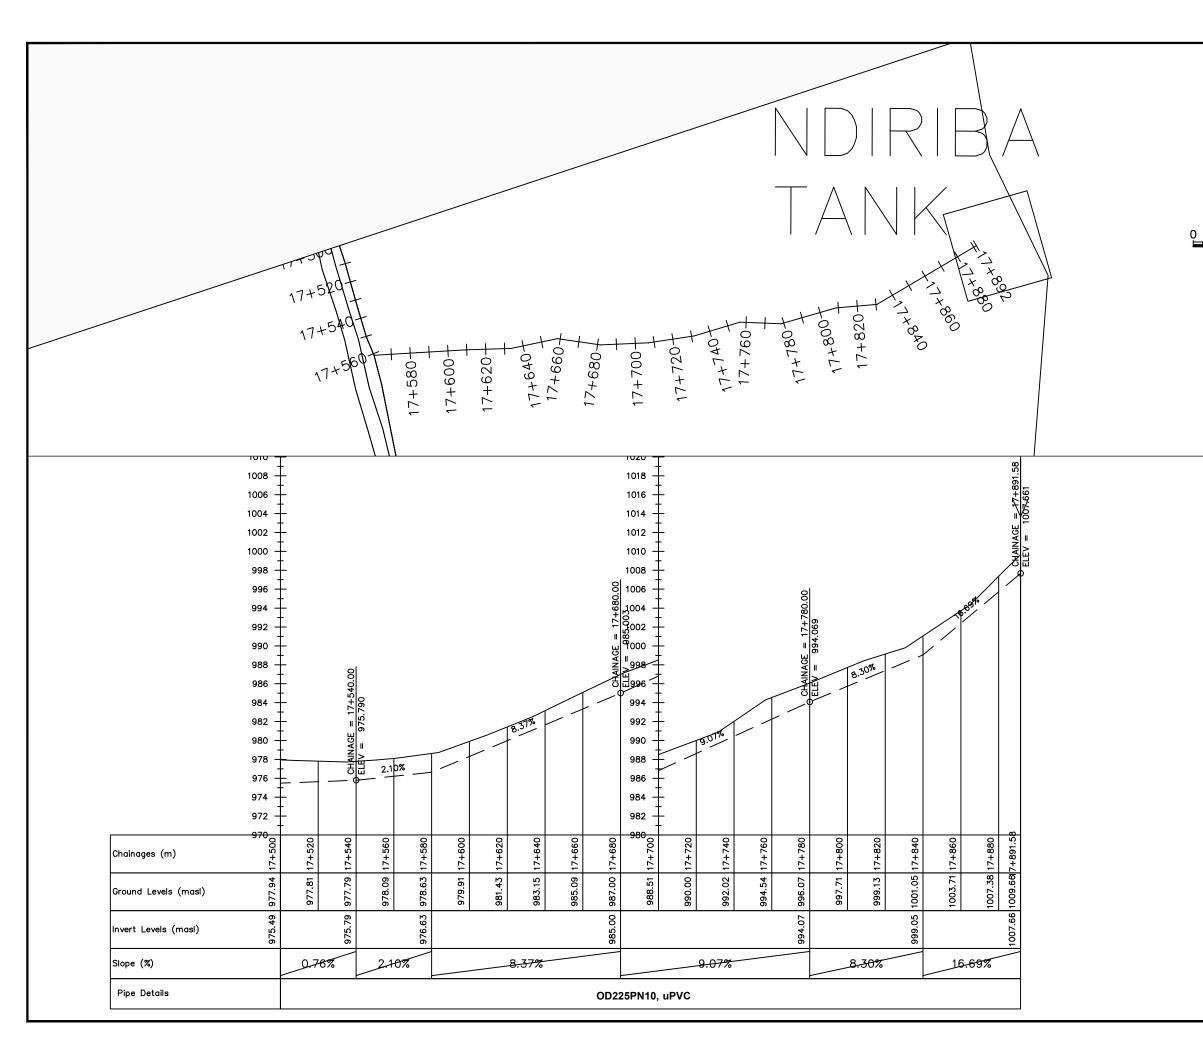



Ń		LEGEND
V	<u>Plan</u>	Transmission Main
Ţ		Distribution Main
9		- Road
		Building
N		u u u u u u u u u u u u u u u u u u u
2000 4000		Contours
	Profile	e Ground Level
		Invert Level
	AV	Air Valve
	wo	Washout
	(10)	Node detail No.
	CLIENT :	
	MINISTRY	THE REPUBLIC OF UGANDA OF WATER AND ENVIRONMEN
	CO-FINANCED	BY:
	CONSULTANT :	Alliance Consultants Itd In Association with
		ORA WATER SUPPLY AND SANITATION PROJECT
	-	SAK WATER SUPPLY AND SANITATION SYSTEM
	REVISIONS : No	Date Description
	DRAWING TITLE	E : N MAIN 1 (OFFAKA-JUNC TO NDIRIBA-TA 17+500 - 17+891.58
	Surveyed by:	/
	R.K Drawn by: M.k	
	Checked by:	G.M
	J.K Date:	K.K nuary 2023
	DPC No .	NYA-GTM-001
	Scale:	Sheet No.:

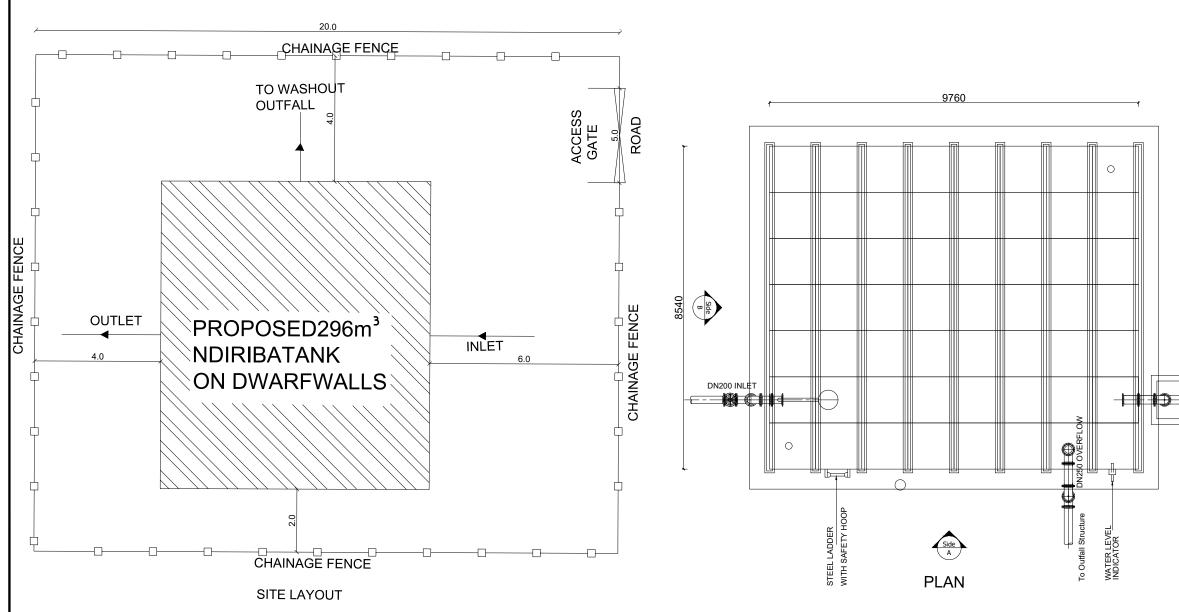

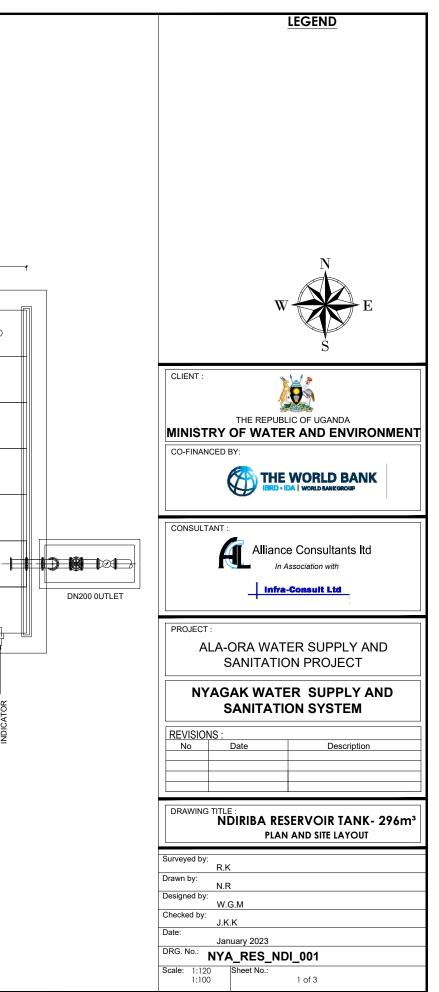


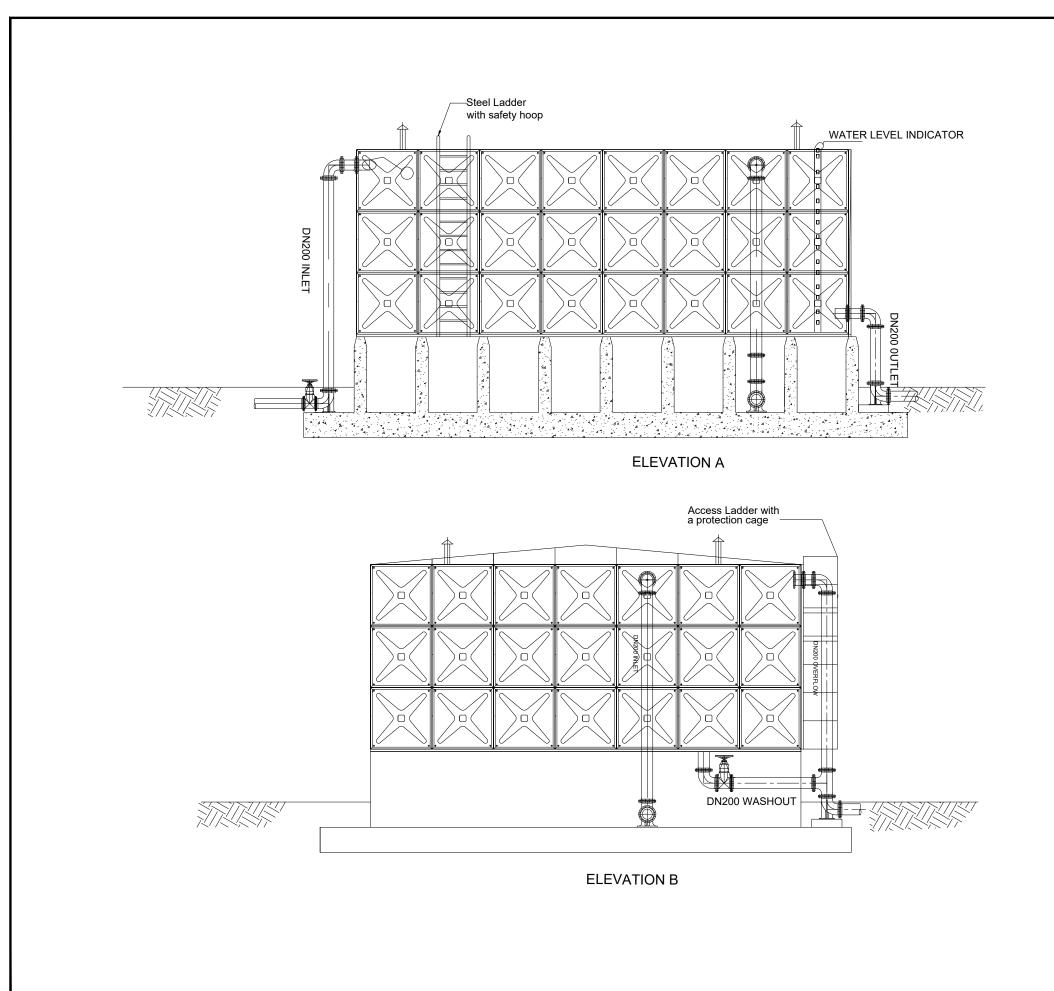


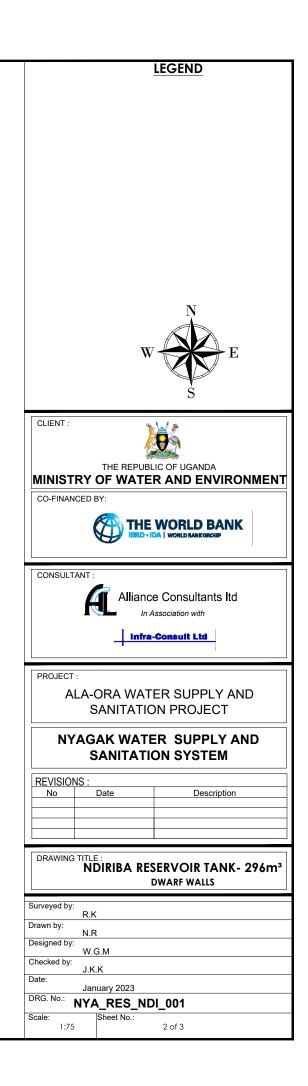


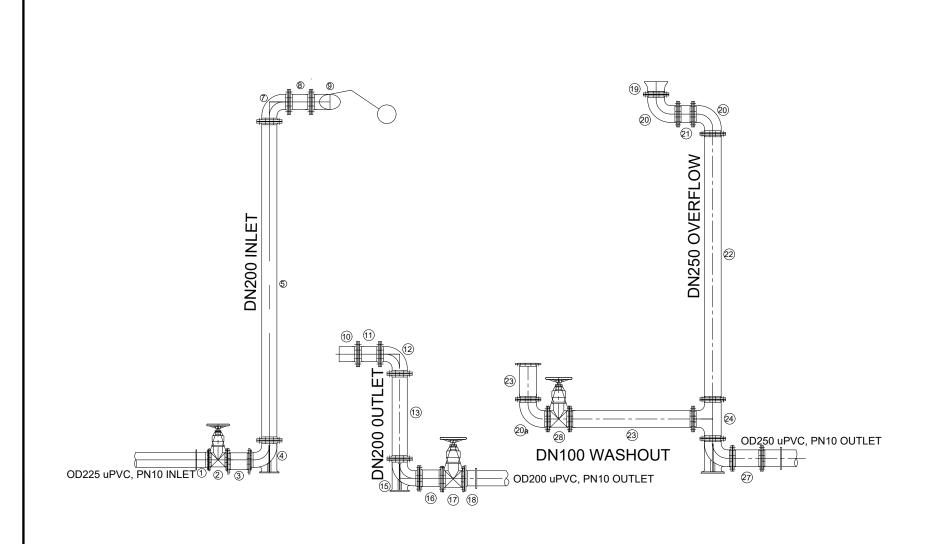



	+
INLET	
Flanged Adapter	DI
Flanged Gate Valve	CI
Flanged Pipe Piece, Length - 0.3m	DI
90° Flanged Duckfoot Bend	DI
Flanged Pipe, Length - 6.0m	DI
Flanged Pipe, Length n.e - 6.0m	DI
90° Flanged Bend	DI
Flanged Pipe Piece, Length - 0.2m	DI
Flanged Float Valve	CI
	SS
	DI
	DI
•	DI
	DI
	DI
	DI
	CI
Flanged Adapter	DI
I THE SECOND IN M. S. LAND D. COMPACT DESIGN COMPACT COMP	DI
-	DI
-	DI
5	DI
	DI
Flanged Adapter	DI
	Flanged Gate Valve Flanged Pipe Piece, Length - 0.3m 90° Flanged Duckfoot Bend Flanged Pipe, Length - 6.0m 90° Flanged Bend Flanged Pipe, Length n.e - 6.0m 90° Flanged Bend Flanged Float Valve OUTLET Flanged Strainer Flanged Strainer Flanged Pipe Piece, Length - 0.2m 90° Flanged Bend Flanged Pipe, Length n.e - 3.0m Flanged Pipe, Length - 6.0m 90° Flanged Duckfoot Bend Flanged Pipe Piece, Length - 0.3m Flanged Gate Valve Flanged Gate Valve Flanged Belmouth 90° Flanged Bend 90° Flanged Bend Flanged Bellmouth 90° Flanged Bend 90° Flanged Bend 90° Flanged Bend 90° Flanged Pipe, Length n.e - 0.2m Flanged Pipe Piece, Length n.e - 3.0m Flanged Pipe Piece, Length n.e - 3.0m Flanged Pipe Piece, Length n.e - 4.0m 90° Flanged Duckfoot Bend

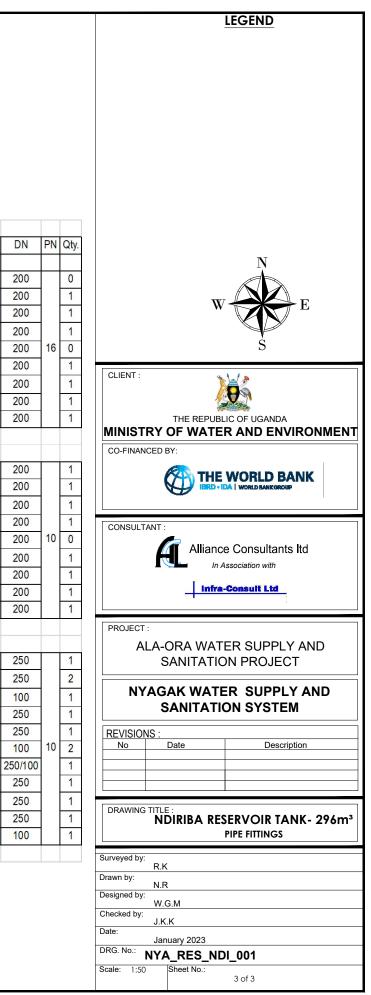

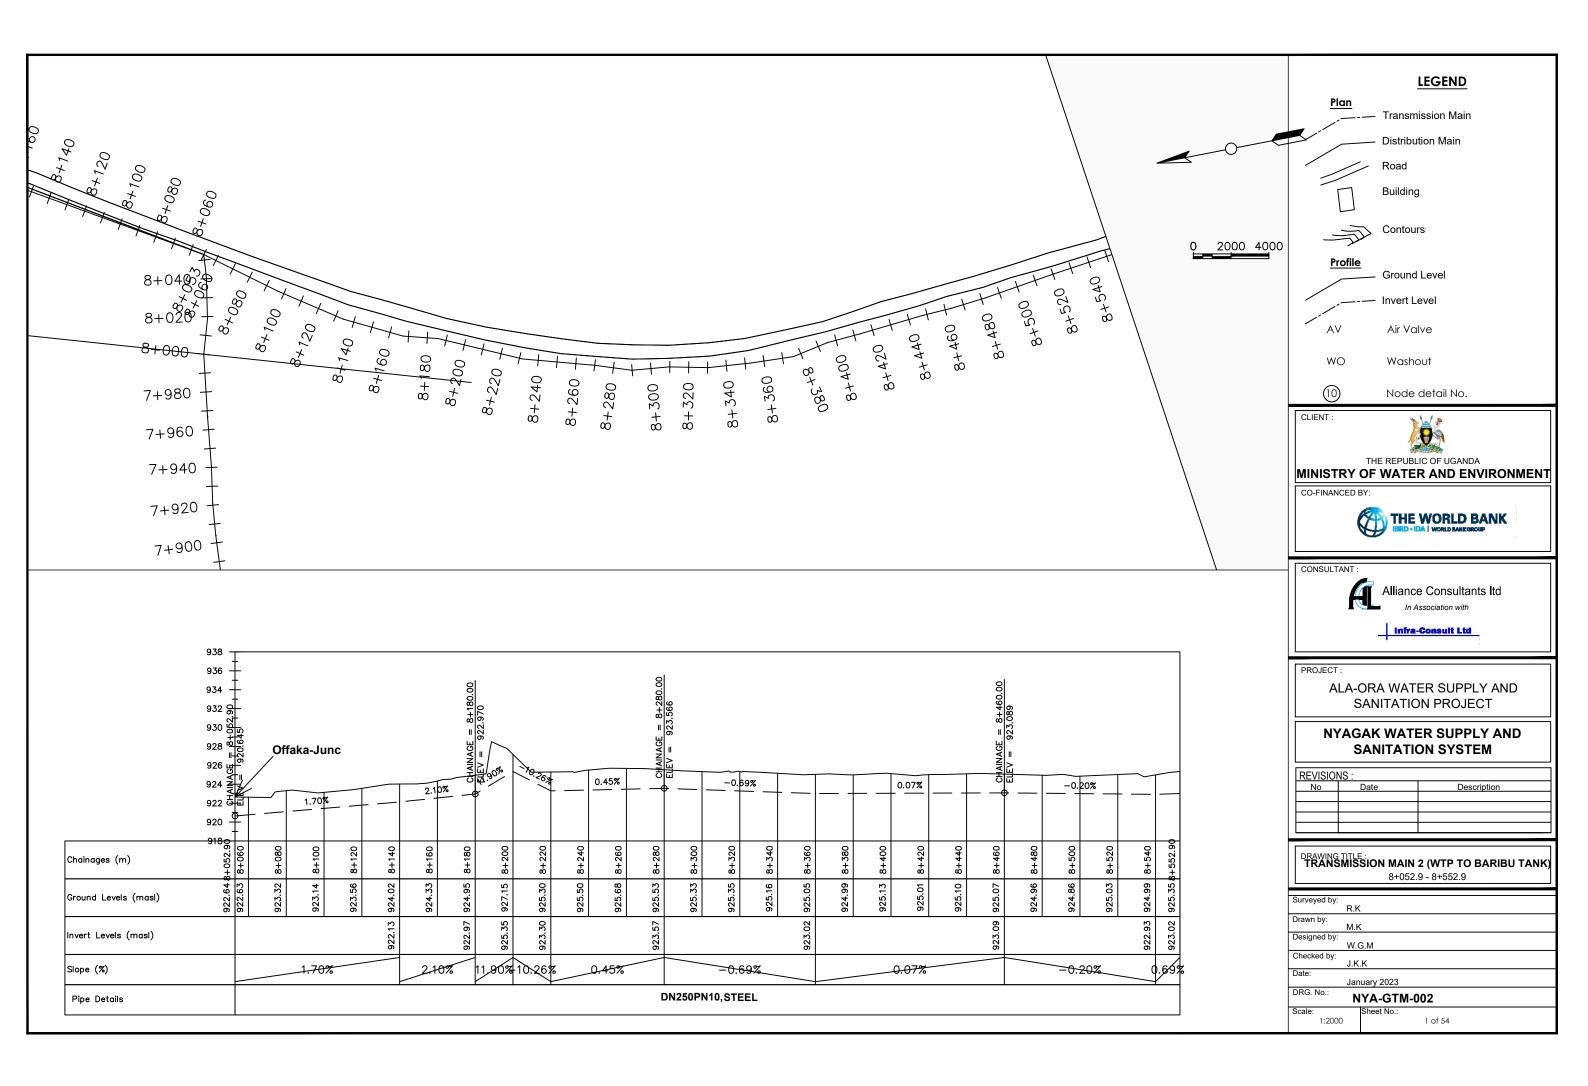


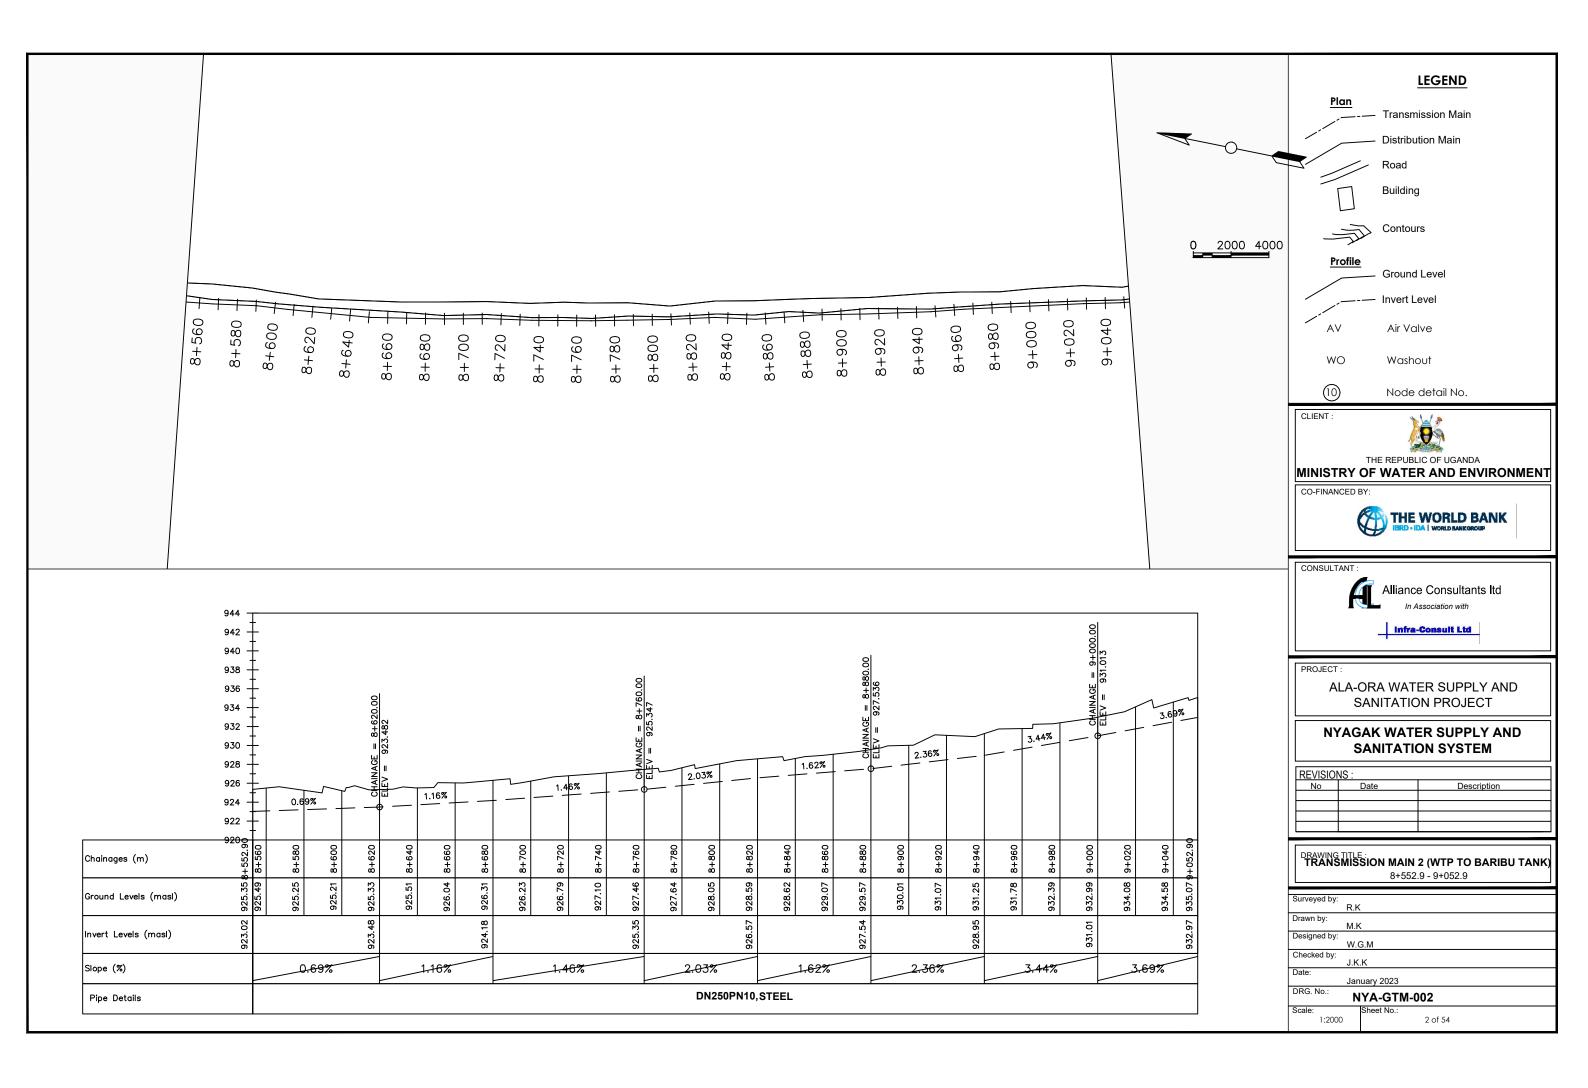


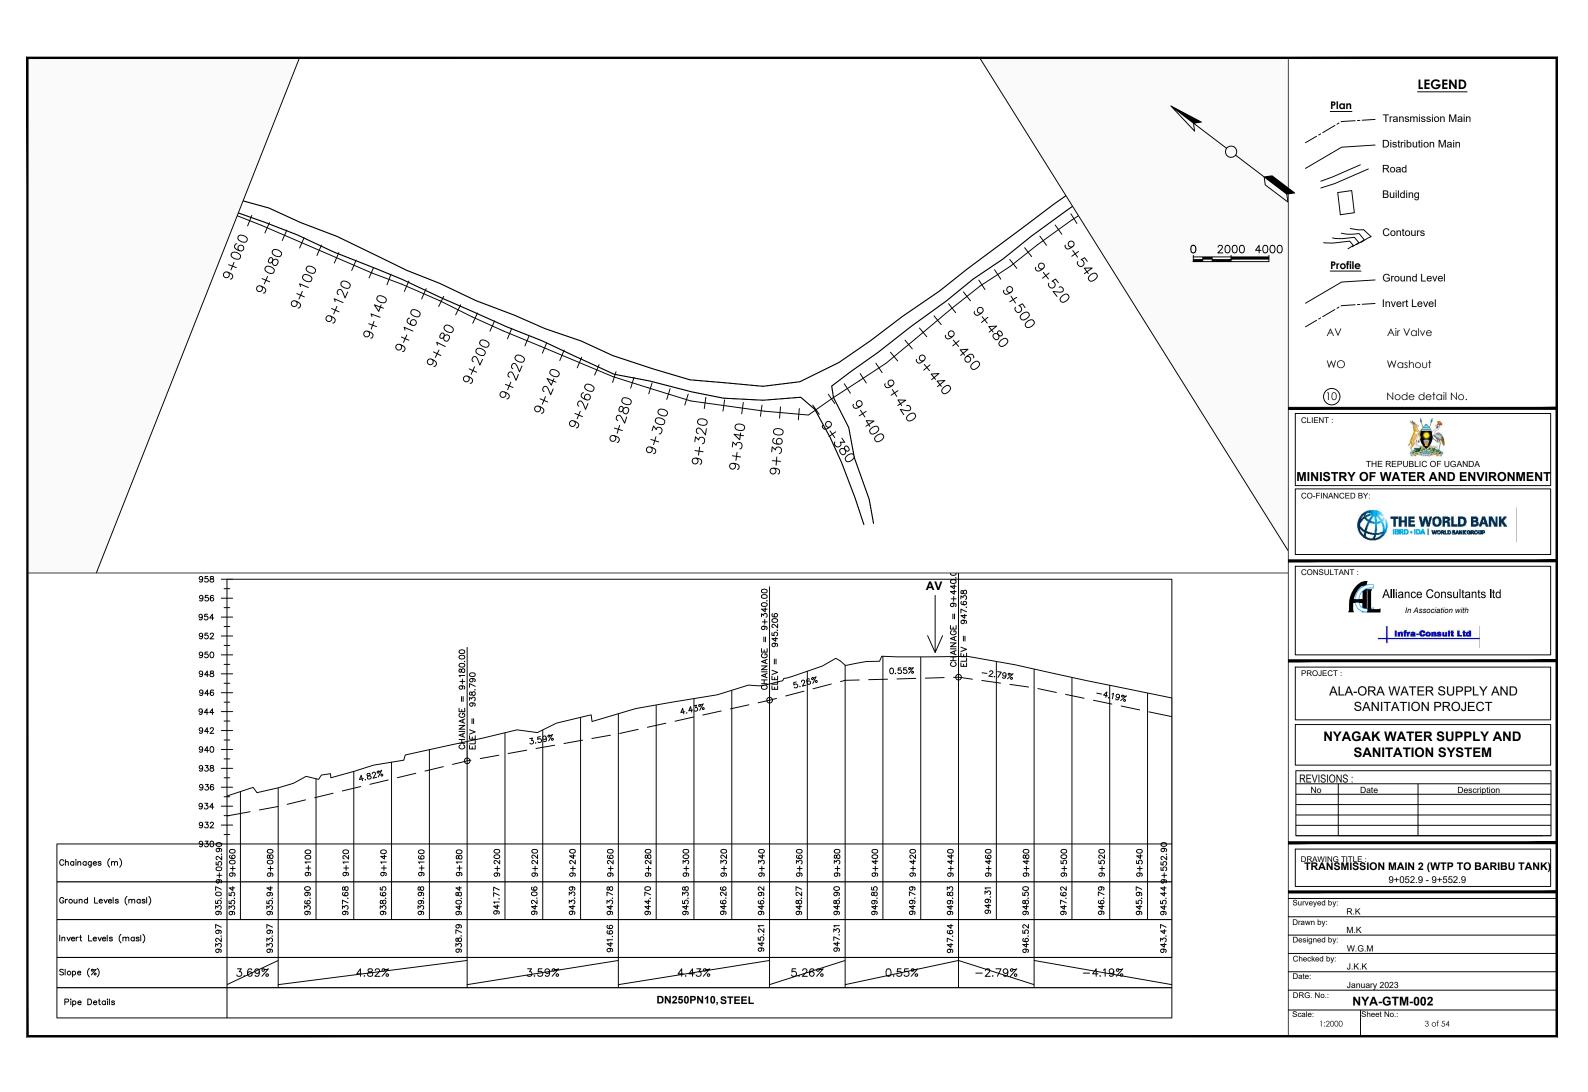

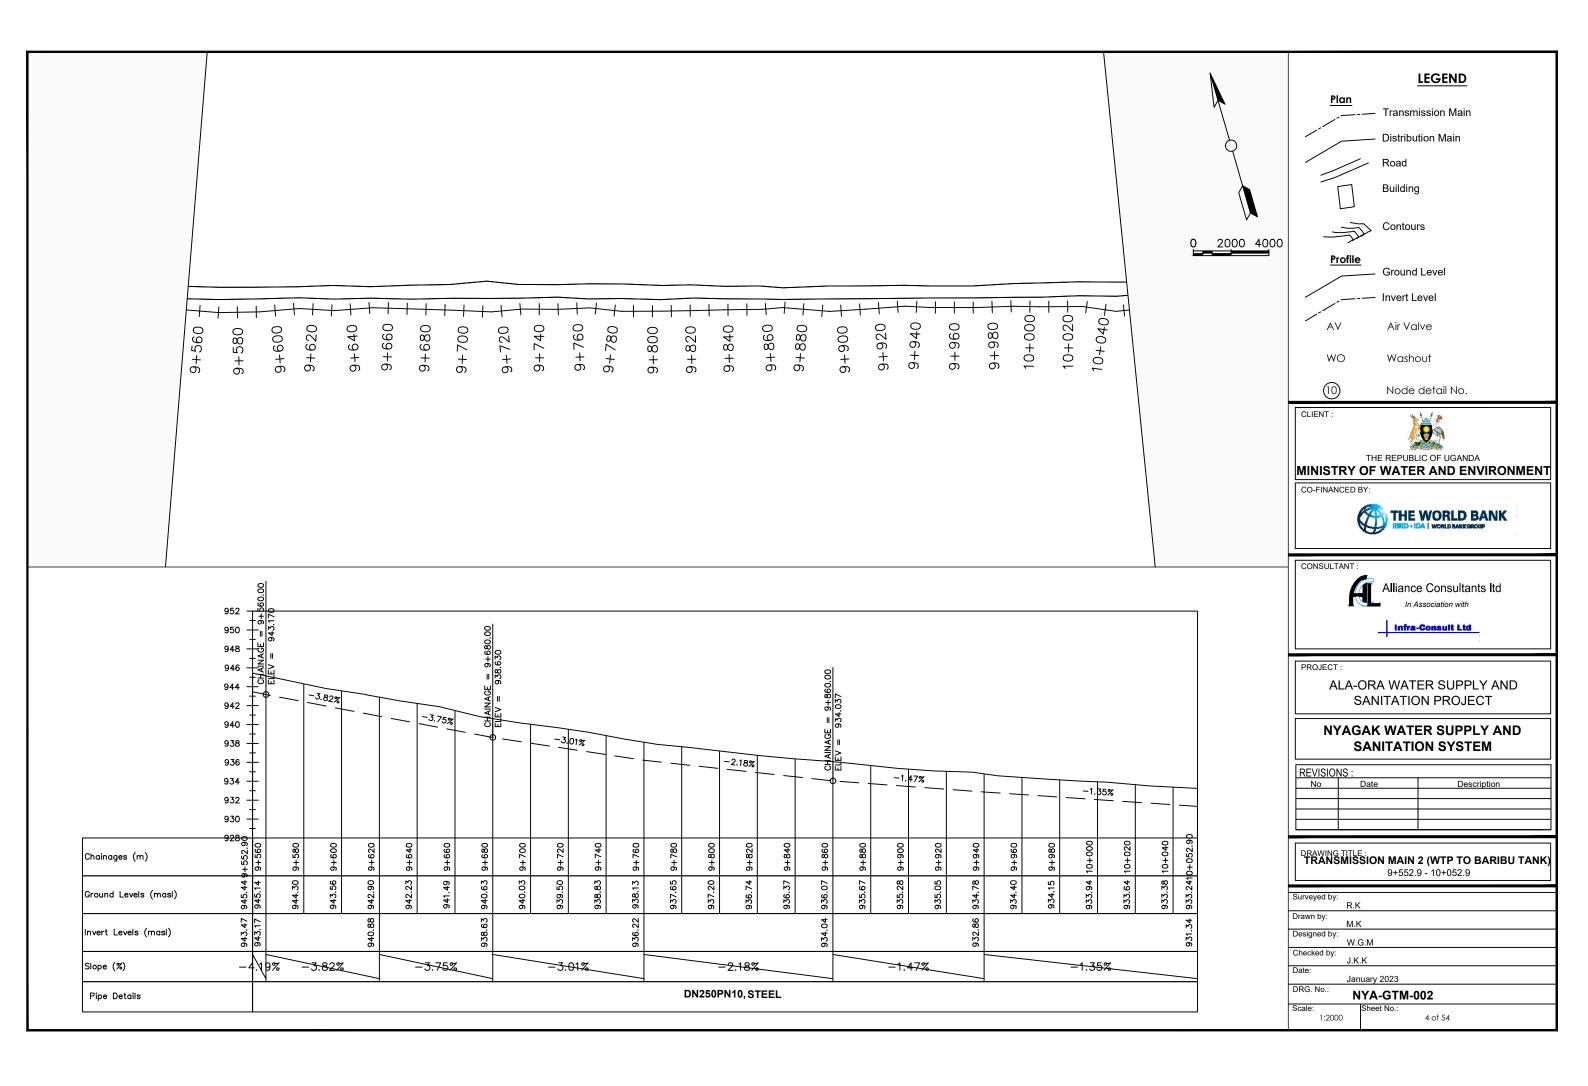


0 10+320+ 10+340+ 10+260+ 10+300+ 10+380+ 10+220+ 10+240+ 10+480+ 10+400+ 10+280-10+460+ 10+360-10+440-10+200-10+420-10+500-10+080-10+180-10+520-10+0601 10+160-10+540₇ 10+100-10+120-10+140-10+060.00 244 $\frac{1}{2} = \frac{10+200.00}{330.007}$ 8 938 CHÁINAGE = 10+36 ELEV = 928.571 31= CHAINAGE = 10+460.00ELFV = 925.356 936 INAGE 934 932 -0.88% 휤멾 -0.50% 930 -1.30% -3.22% 928 926 924 922 10+100 10+140 10+160 10+180 10+200 10+220 10+240 10+280 10+300 10+320 10+340 10+360 10+380 10+420 10+440 10+460 10+480 10+500 10+520 10+540 080 10+120 10+400 -260 +552. Chainages (m) ģ ÷ 933.2410 933.17 932.70 932.40 932.18 932.05 931.96 931.69 931.69 931.63 931.39 931.03 930.00 928.14 927.41 926.50 925.02 923.98 923.341 .92 78 70 4 928.82 .57 56 85 Ground Levels (masl) 932. 932. 930. 931 931. 929 925 931.34 931.24 921.39 930.01 929.61 5 36 <u>5</u> Invert Levels (masl) 925. 922 1.35% -4.83% Slope (%) -0.88% -0.50% =1.30% -3.22% -4.18% DN250PN10, STEEL Pipe Details

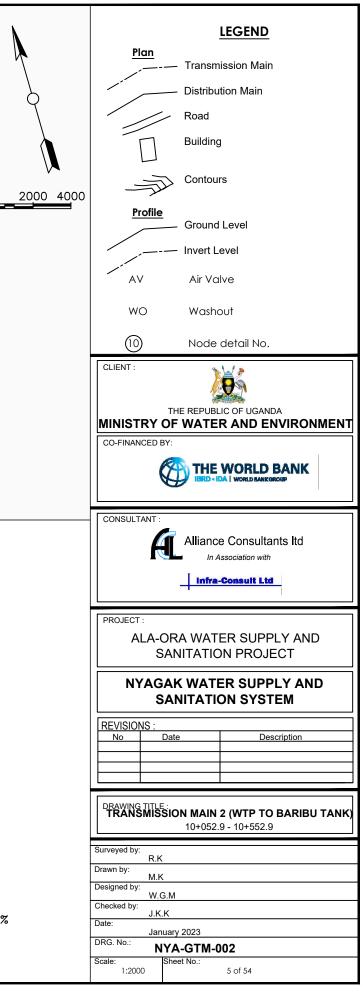


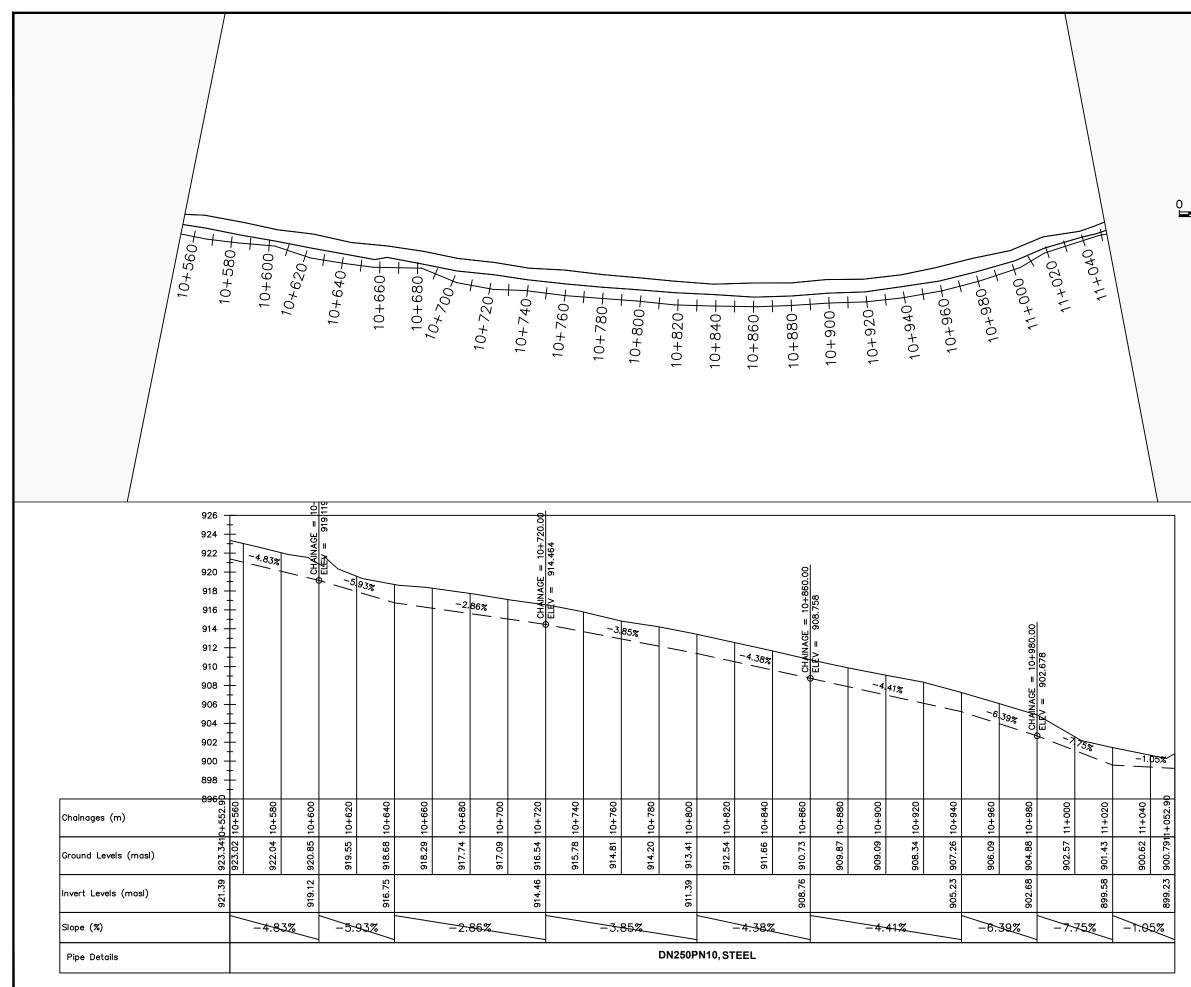


2000 4000	Plan Transmission Main Distribution Main Distribution Main Road Building Contours Profile Ground Level AV Air Valve WO Washout (1) Node detail No.
	CLIENT : THE REPUBLIC OF UGANDA MINISTRY OF WATER AND ENVIRONMENT CO-FINANCED BY: CO-FINANCED BY: THE WORLD BANK ISRD - IDA WORLD BANKCROUP CONSULTANT : Alliance Consultants Itd In Association with
	PROJECT : ALA-ORA WATER SUPPLY AND SANITATION PROJECT NYAGAK WATER SUPPLY AND SANITATION SYSTEM REVISIONS : No Date Description Date Description Date Description Description Burveyed by: R.K Drawn by:
	M.K Designed by: W.G.M Checked by: J.K.K Date: January 2023 DRG. No.: NYA-GTM-002 Scale: Sheet No.: 1:2000 6 of 54

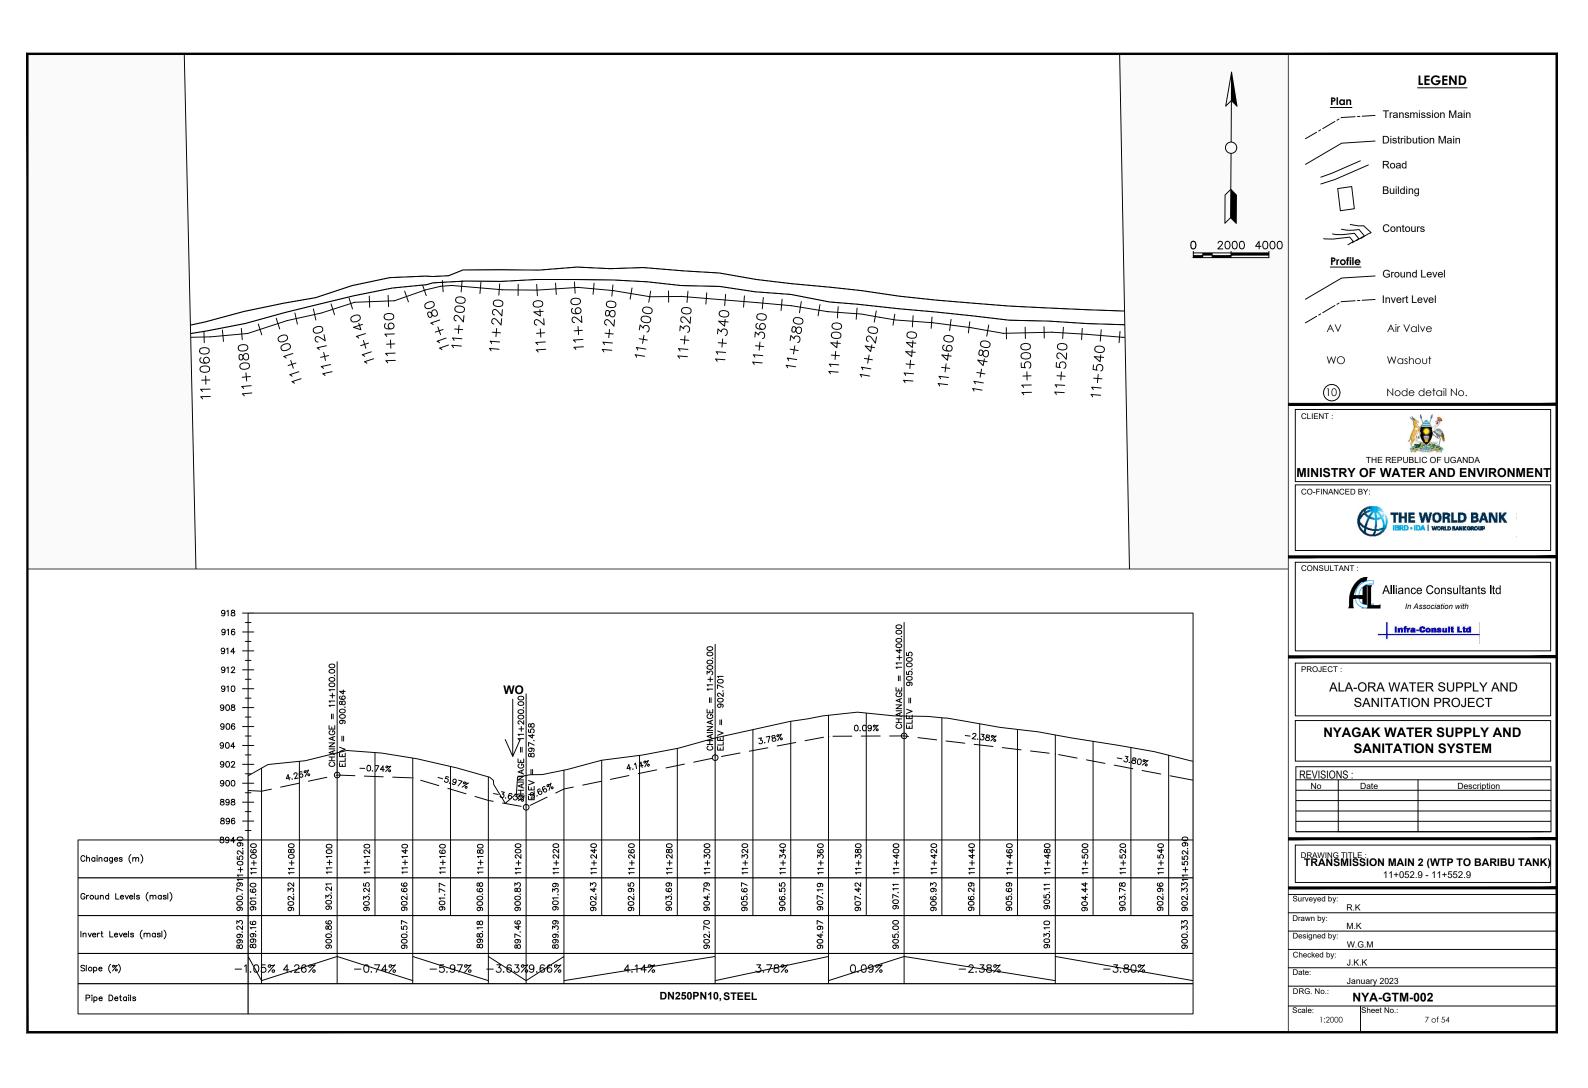



TRAN 2 to Anyiribu Jn 0 11+700-+11+800-11+640-11+740 11+940+ 11+680 11+760 11+780 -11+660 11+720 12+000-11+580-11+980-12+020-11+600 11+840-- 11+960 -12+040+ 11+620-11+560 11+860 11+820 11+880-11+900-11+920-80.00 ⁹¹² [운 <u>= 11+9</u> 910 = 11+8 900.589 $\begin{array}{rcl} CHAINAGE &= 11+720.00\\ ELEV &= 896.894 \end{array}$ 908 CHAINAGE ELEV = 9 906 CHAINAGE ELEV = 5 1.82% 904 1.32% 2.60% 902 2.95% 900 -3.55% 2.22% 898 -0.41% 896 894 +552.90 1+560 12+040 11+580 11+600 11+640 11+660 11+680 11+720 11+740 11+800 11+820 11+840 11+880 11+940 12+000 12+020 11+620 11+700 11+760 11+780 11+900 11+920 11+960 11+980 860 +052. Chainages (m) 902.331 902.10 900.30 899.20 898.79 898.72 901.47 901.99 904.25 904.87 904.92 906.271 25 8 900.31 900.67 53 902.91 28 904.67 .62 905.77 .25 .56 5 02 52 Ground Levels (masl) 898. 899. 902. 905 901 899 399 899 903 900.33 900.06 902.15 897.22 8 23 6 94 26 Invert Levels (masl) <u> 3</u>98. 302. 904 .8p% Slope (%) -3.55% -0.41% 2.22% 2.95% 2.60% 1.32% 1.82% DN250PN10, STEEL Pipe Details

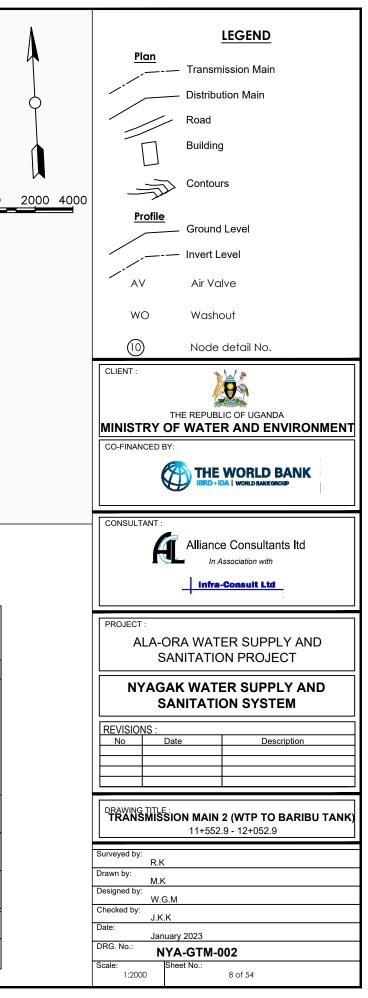

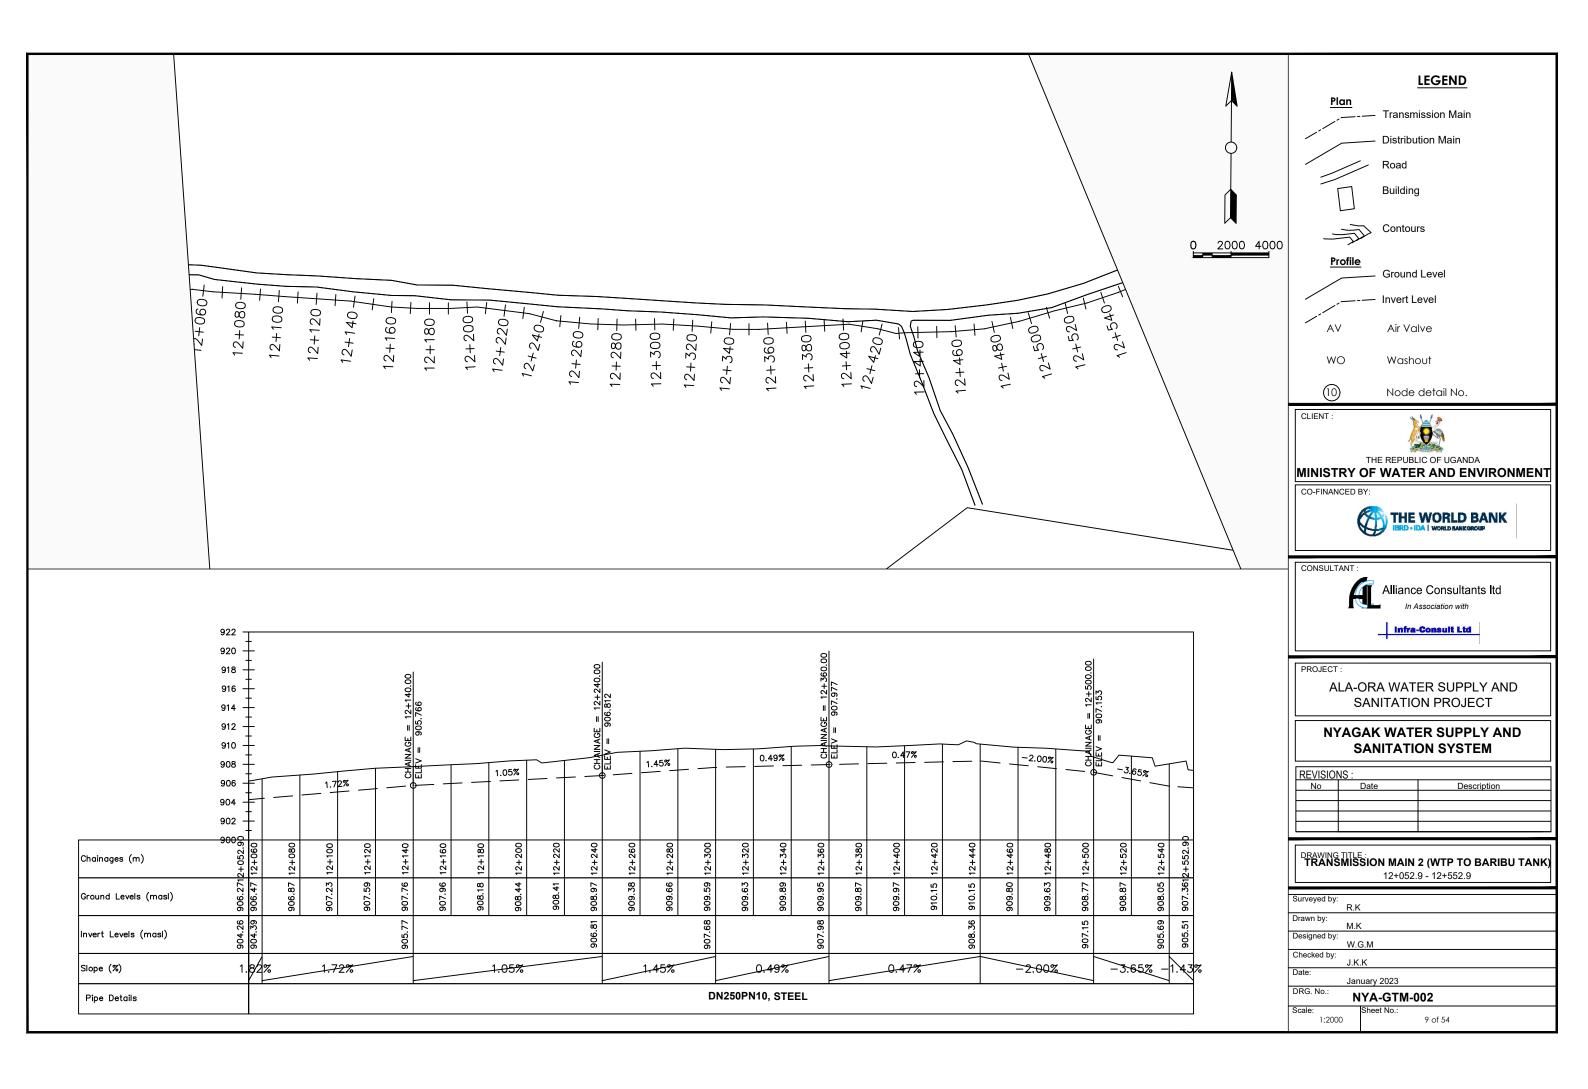


12+560+	12+600+12+620+12+620+1	12+640+ 12+660+ 12+680+	$12+700+ \\ + \\ 12+720+ \\ + \\ 12+740+ \\ + \\ + \\ + \\ + \\ + \\ + \\ + \\ + \\ + \\$	$12+760+\\12+780+\\12+800+\\12+800+\\12+800+\\12$	12+820+ 12+840+ 12+860+ 12+880+	$ \begin{array}{c} 12+920+\\ 12+940+\\ 12+960+\\ 12+9$	$ \begin{array}{c} 12+980+\\ 13+000+\\ 13+020+\\ 13+040+\\ 13+0$
904 - 902 - 900 - 898 - 896 - 894 - 892 - 892 - 890 - 888 - 888 -				" □ □ -2.94%	800 820 840 CHAINAGE = 12+860.00	250 168 <u>3.</u> 66家	960 980 000 020 040 040 040 CHÁNAGE = 13+040.00 52.90 ELEV = 889.643
Chainages (m) YG + + 	19 12+560 81 12+580 06 12+600	41 12+620 50 12+640 12 12+660	28 12+680 57 12+700 25 12+720	74 12+740 10 12+760 33 12+780	70 12+800 19 12+820 57 12+840 57 12+860	45 12+880 78 12+900 34 12+920 39 12+940	895.17 12+960 894.33 12+980 893.55 13+000 892.65 13+020 891.65 13+020 890.9915+052.90
	907.19 906.81 906.06	905.41 904.60 904.12	903.78 903.57 903.25	902.74 902.10 902.133	900.70 900.19 899.67 899.07	898.45 897.78 896.94 896.09	
Invert Levels (masl) ශ න	905.12	903.41	901.17	899.40	897.03	894.11	889.64 888.95
Slope (%)	-1.43% -4.26	6% -2.95%	-1.78%	-2.94%	-2.96%	-3.66%	-4.47% -5.37%
Pipe Details	1				DN250PN10,STEEL		

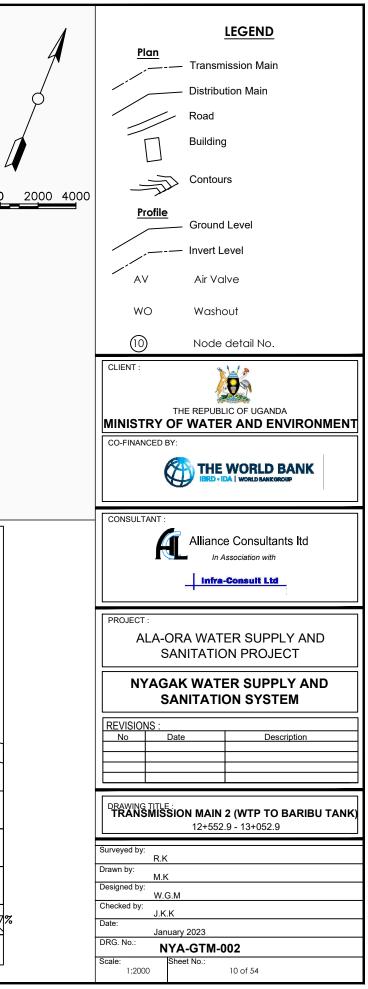


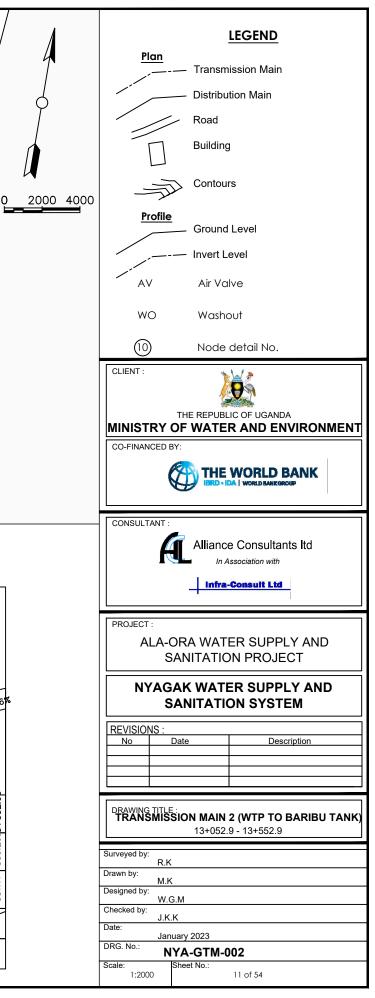


13+560+	13+600+	13+620+ 13+640+	13+6607	13+700+	13+720+ + 13+740+	13+760+	13+780+	13+820+	13+840+	13+860+		13+900+1			13+960+			14+020+1			0
906 - 904 - 902 - 900 - 898 - 896 - 894 - 892 - 890 - 888 - 886 - 888 -	884.55 13+580 1 1 1 1 884.55 13+580 4 4 1 1 884.55 13+580 4 4	885.28 13+600 ELEV = 885.89 13+620 13+620	884.76 886.77 13+640 887.74 13+660		888.14 890.09 13+720 CHMNAGE - 131770 00	890.83	891.52 13+760	892.20 13+780	892.94 13+800	894.33	892.96 894.97 13+860	895.50 13+880	3.25	897.07 13+920	895.57 897.31 13+940 CHAINAGE = 13+940.0	898.22 13+960	899.55 13+980	900.54 14+000	899.71 901.76 14+020	902.73 14+040	901.59 903.3314+052.9p
Slope (%)	88 5.06%	3.81%	88	4.22			3.	63%	89	2.9			_3.25	~~~~	89;		5.18	3%	89	5.729	

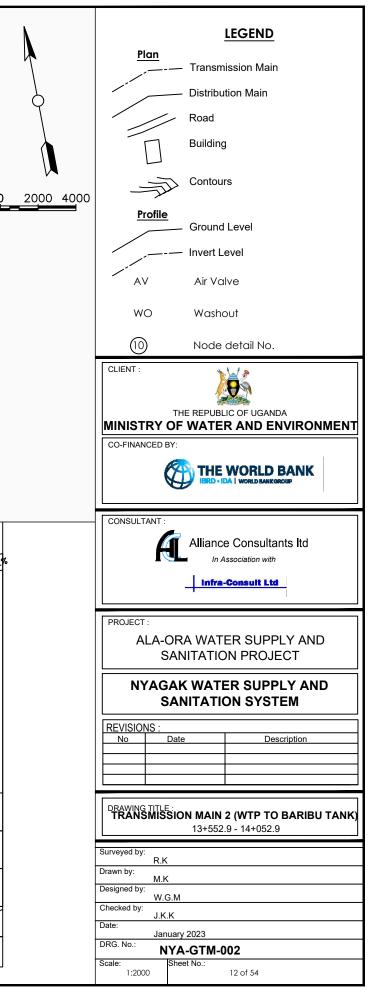



	14+060+ 14+080+ 14+080+	14+100+	14+120+	14+140+	14+160+	14+180 +	14+220+	14+240+	14+260+	14+280+	14+300+	14+320+	14+3407	14+380	14+400	14+420	14+440	14+460	14+480+		14+540		
	928 926 924 922							00.00						$\frac{1}{10000000000000000000000000000000000$				% CHAINAGE = 14+440	18.227	;%	2.56	 %	
	920 918 916 914 912 910 908 906 904 902	₽ ~		6.34% 07	40		32%	00 CHAINAGE = 14+200.00 ELEV = 909.533		64%09	80		3.79% -		2.67%						0	20	
Chainages (m)	920 918 916 914 912 910 908 906 904 902 9006	14+060 1/1	14+080 4 14+100	14+120	34 14+140	14+160	14+180	14+200	14+220 14+220 1	14+260		14+300	14+320	14+340	14+360 14+380	14+400	14+420	14+440	14+460	14+480	37 14+500	00 14+520	
Chainages (m) Ground Levels (masl)	920 918 916 914 912 910 908 906 904 902 9006	903.67 14+060 1 1 +	905.40 14+080	14+120	909.04		14+180	911.51 14+200		14+260	915.22			917.34 14+340		919.25 14+400	919.86 14+420	919.79 14+440		921.85 14+480	922.37 14+500	922.90	
	920 918 916 914 912 910 908 906 904 902 9006	903.67 14+060 1 1 +	14+080 4 14+100	14+120		14+160	14+180	14+200	14+220 14+220 1	14+260		14+300	14+320	14+340	14+360 14+380	14+400	919.86 14+420	14+440	14+460	14+480		920.88 922.90 14+520	

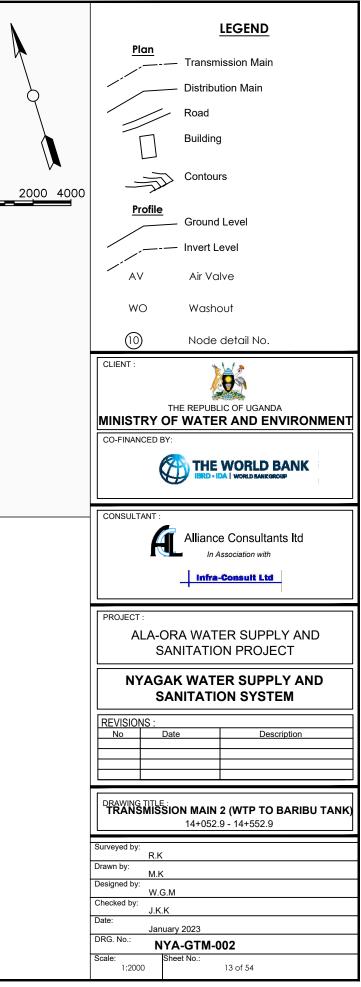


	14+560	14+580+	14+600+	14+620+	14+640+	14+660+	14+680+	14+700+	14+720+	14+740+	14+760	14+780+	14+800+	14+820+	14+840+	14+860+	14+880+	14+900+	14+920+	14+940+	14+960+	14+980+	15+000+	15+020+	15+040	
		946 - 944 -																								
		942 + 940 + 938 + 936 + 934 + 932 + 932 + 932 + 932 + 932 + 932 + 932 + 926 + 922 + 100 +	CHAINAGE = 14+ ELEV = 921.792	32%		3.12%		$fightheref{eq:eq:end_eq:end_eq:end_end_end_end_end_end_end_end_end_end_$	3.11%			3.18%	+ CHANNAGE = 14+ 780.00	Y ELEV = 928.367	3.4	4%			3.4	4%		$e^{\frac{1}{1}} = \frac{14+440.00}{12}$	5.24%			
Chainages (m)		923.6414+552.90 923.93 14+560	14+580					14+680			14+740	14+760		14+800					14+900	14+920				15+000		
Ground Levels (masl)		923.641 923.93	923.91			926.21			927.40			929.89		931.14	931.74	932.11		933.67	934.51	935.31	936.	9.37 01	938.04			
		921.63 921.79		922.72			924.59			926.46			928.37				931.12				933.88			937 N2		
Invert Levels (masl)		6 6																								

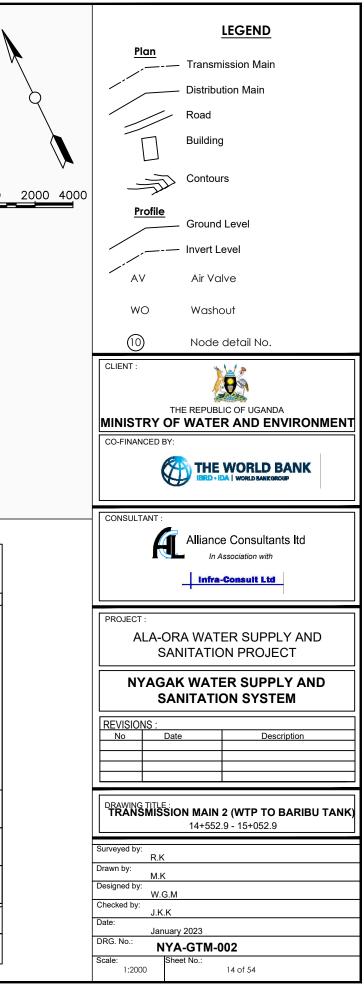


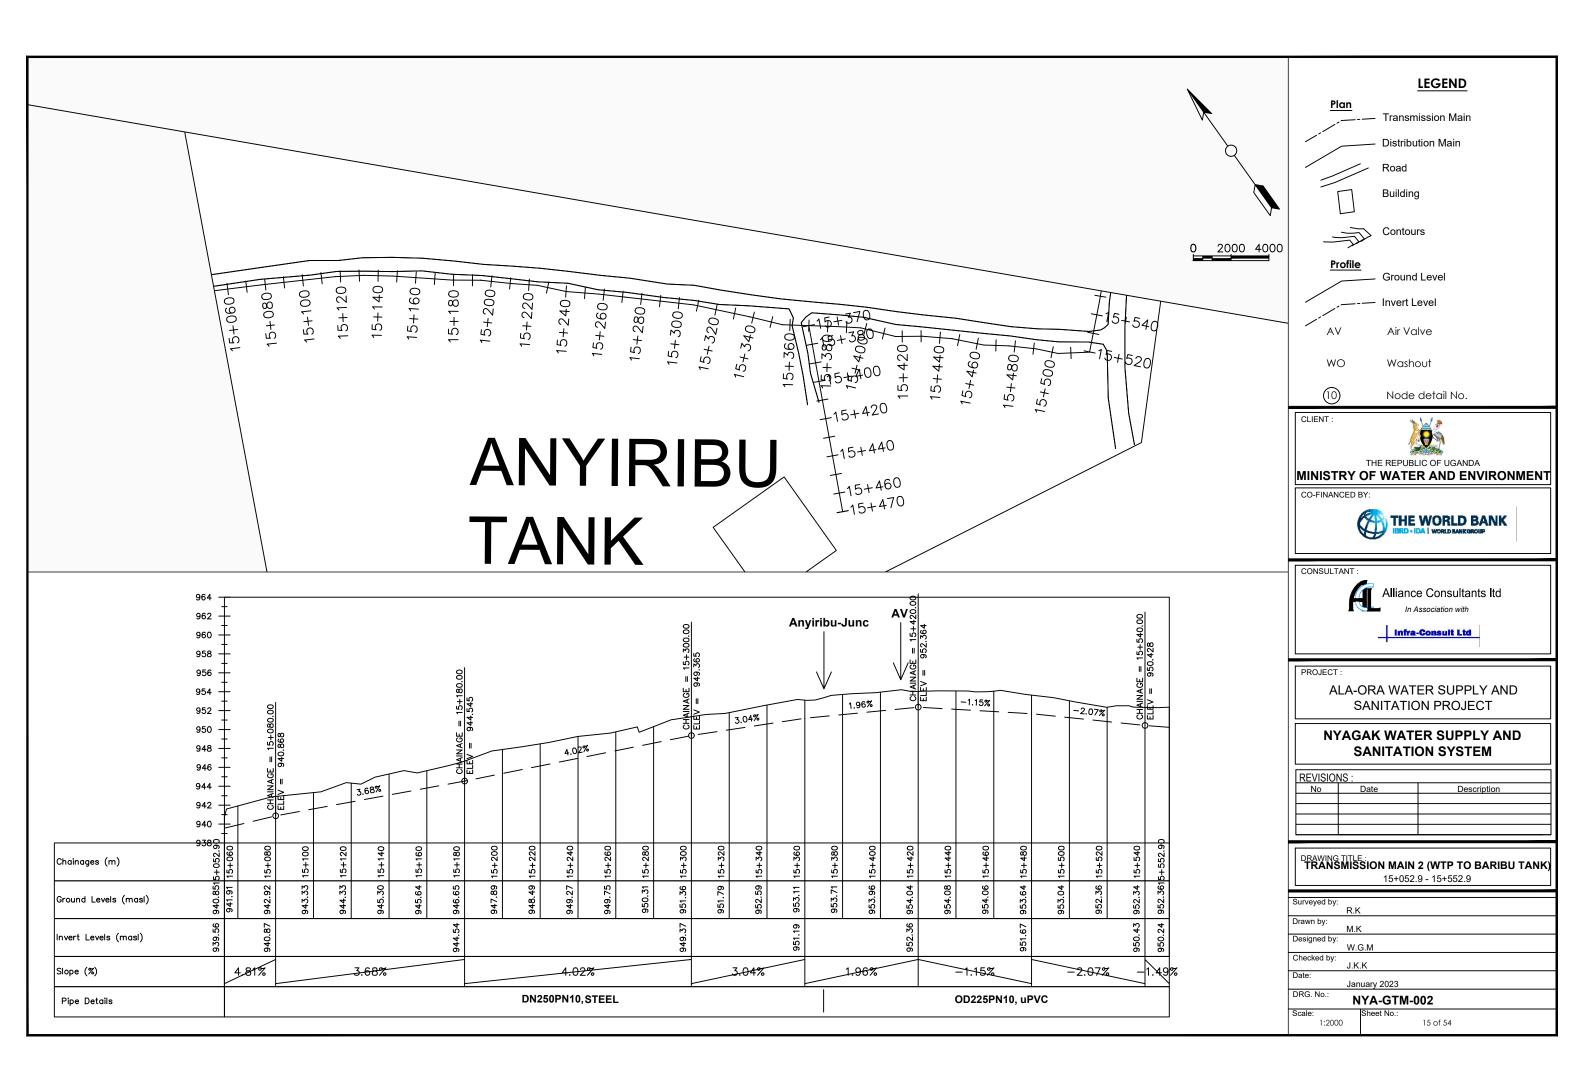


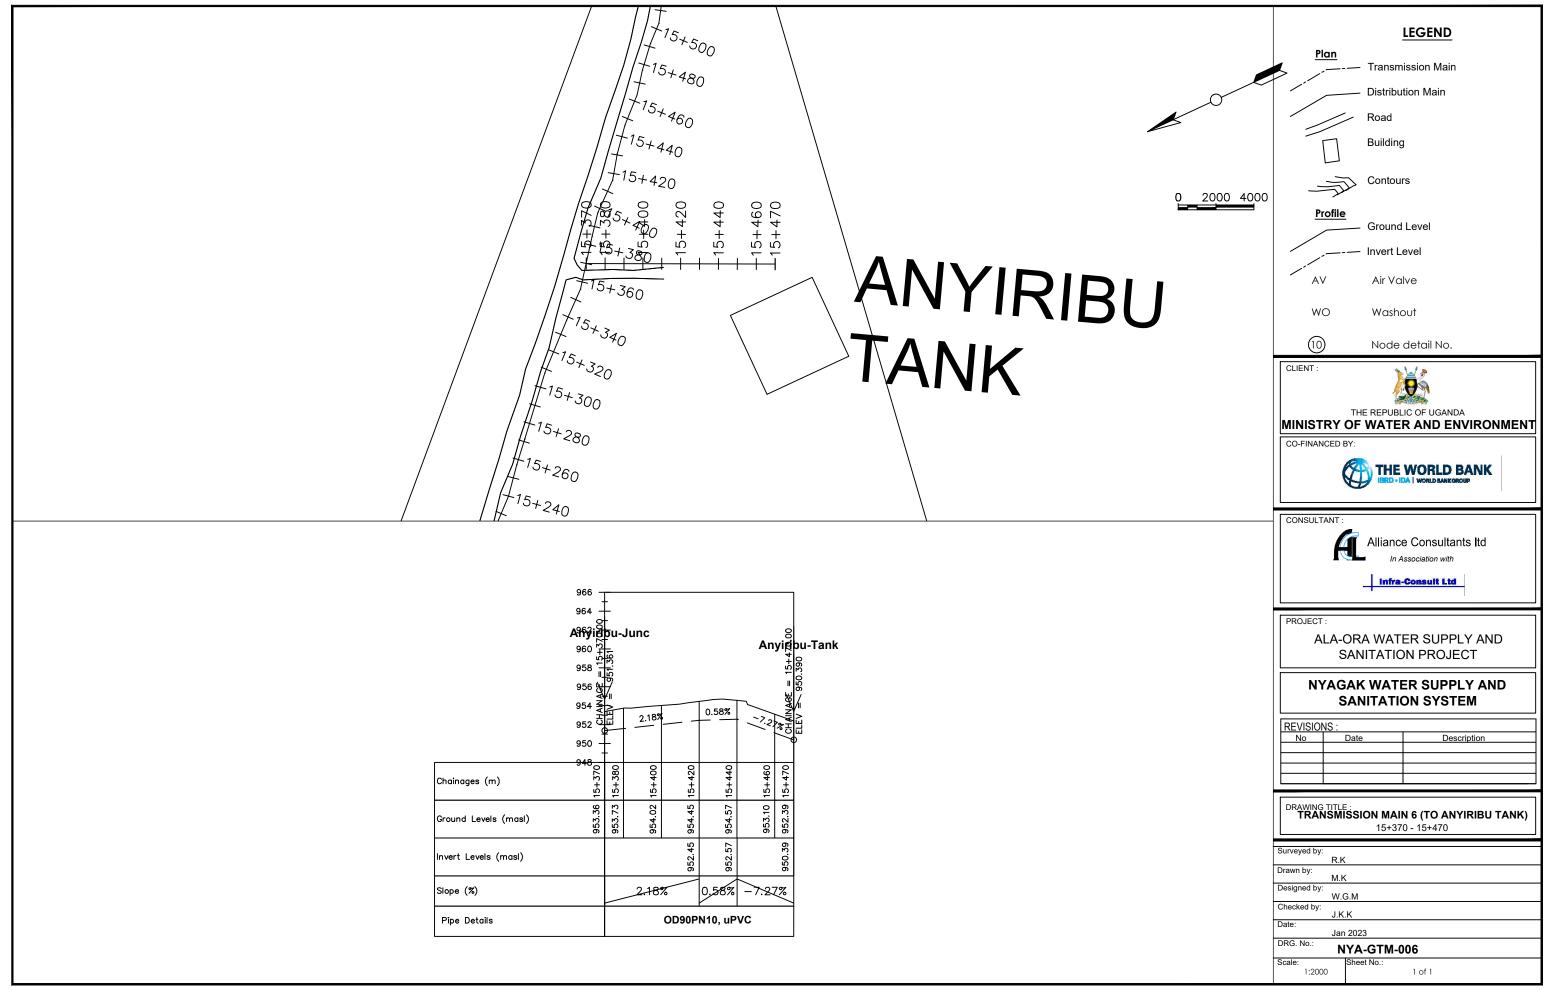


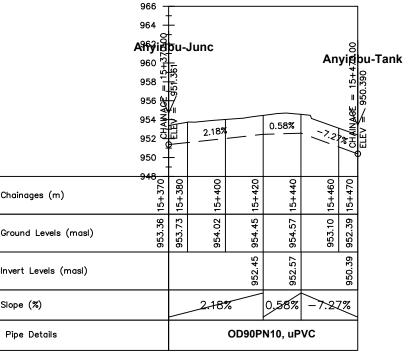



ANYIRIBU SUPPLY AREA

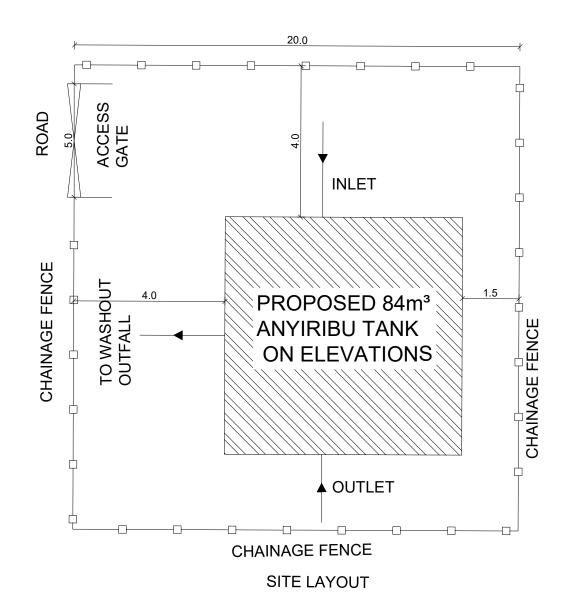

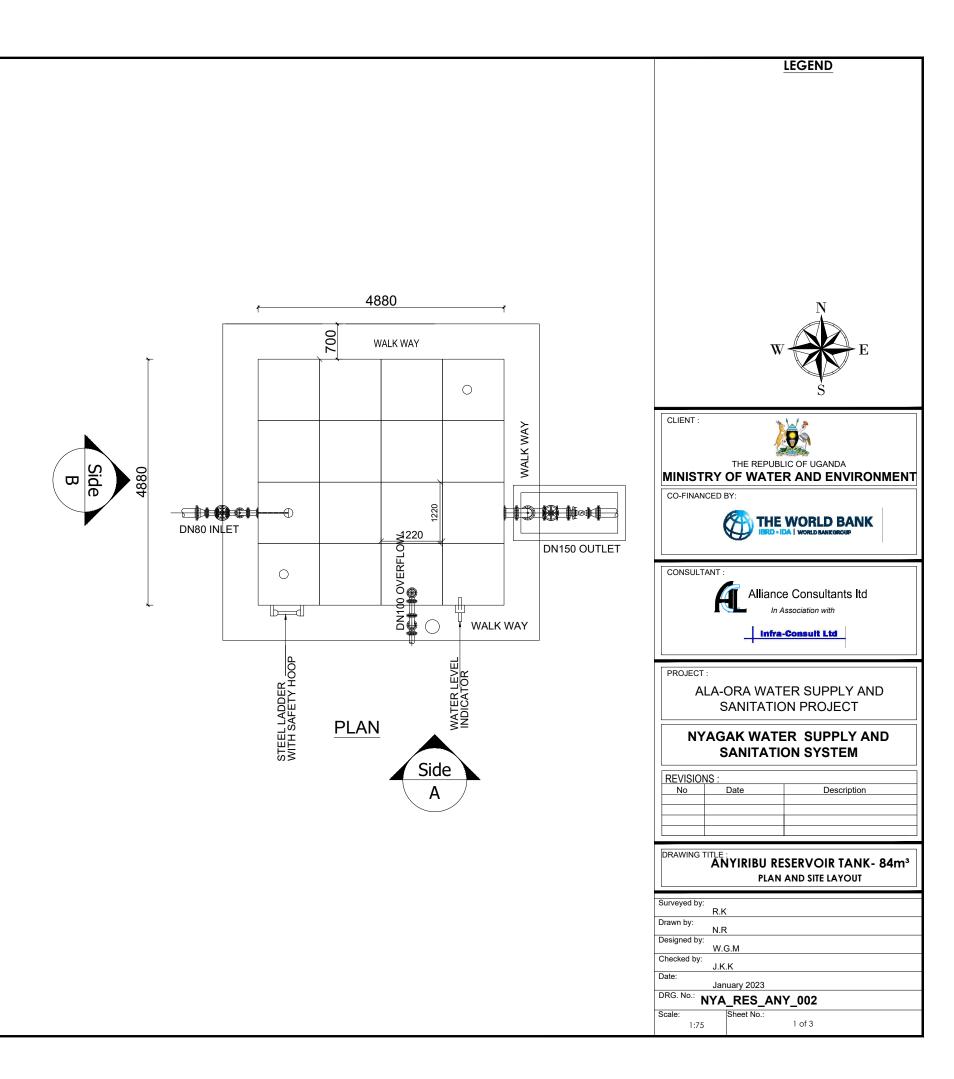

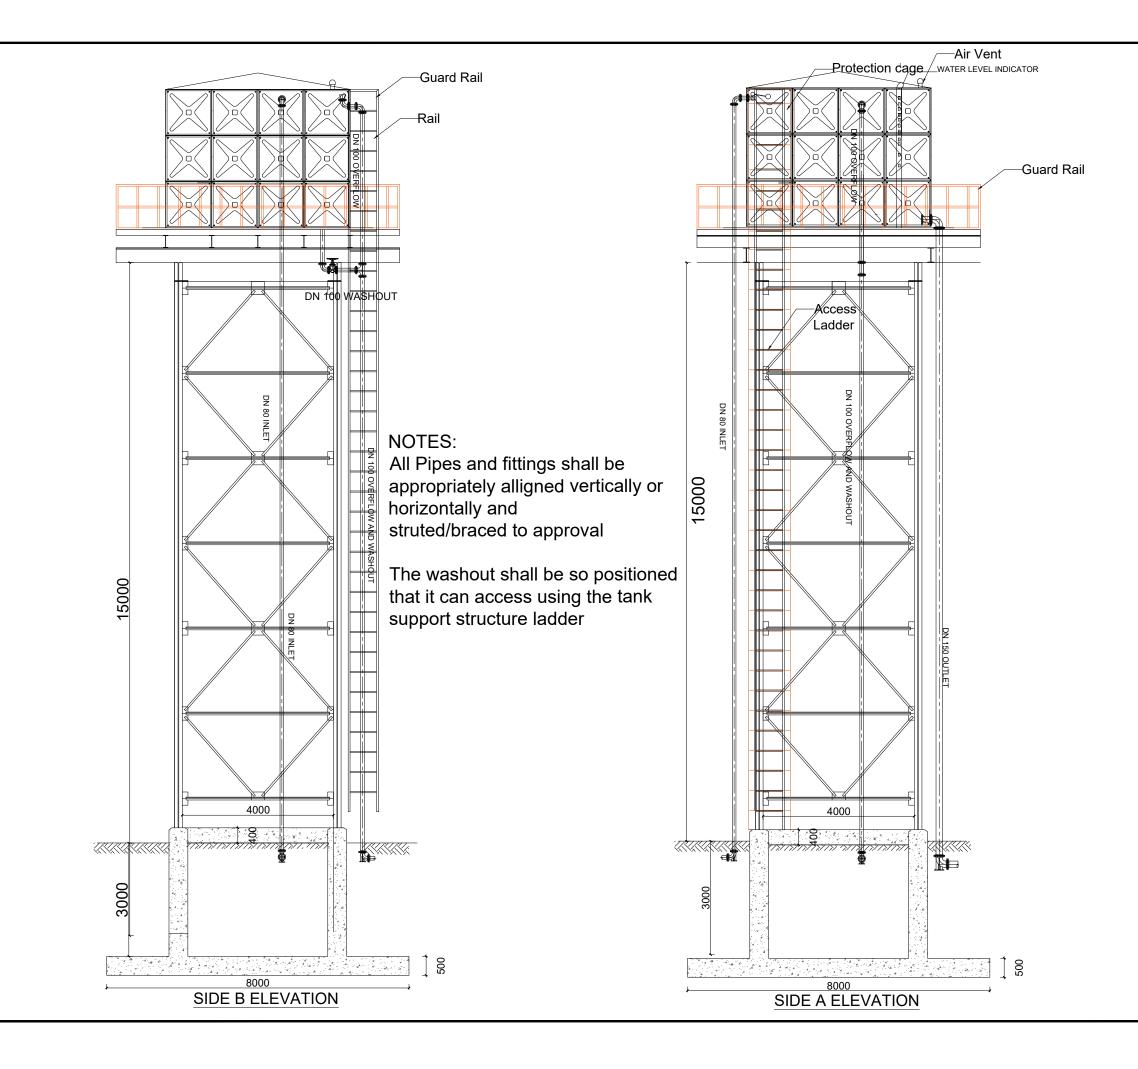

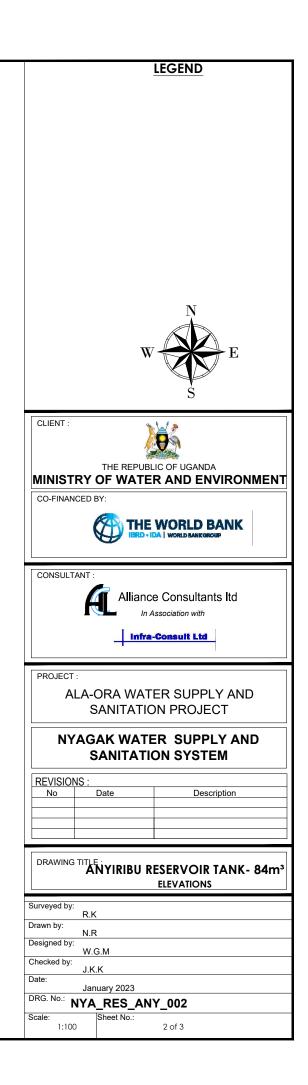

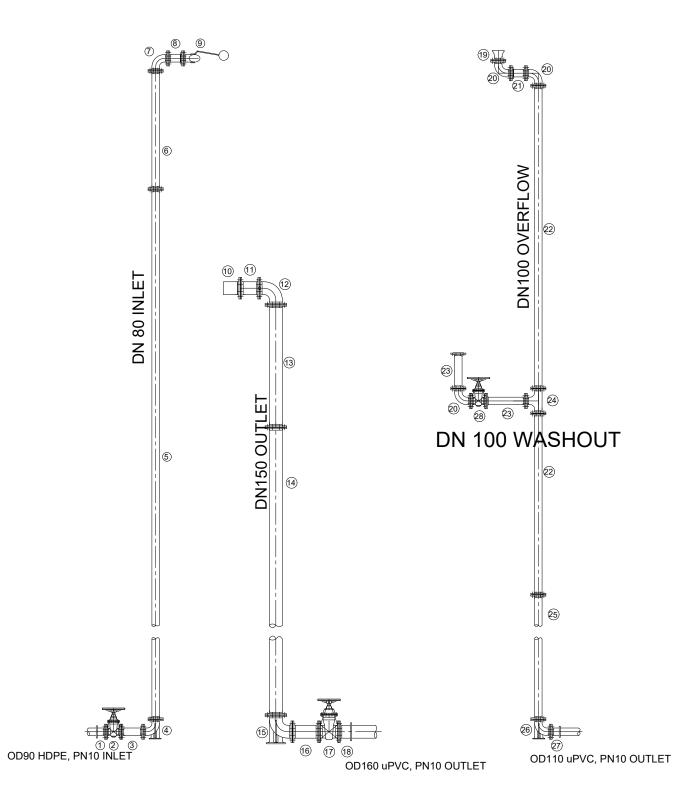



Mark	Description	Material	DN
	INLET		
1	Flanged Adapter	DI	80
2	Flanged Gate Valve	CI	80
3	Flanged Pipe Piece, Length - 0.3m	DI	80
4	90° Flanged Duckfoot Bend	DI	80
5	Flanged Pipe, Length - 6.0m	DI	80
6	Flanged Pipe, Length n.e - 2.0m	DI	80
7	90º Flanged Bend	DI	80
8	Flanged Pipe Piece, Length - 0.2m	DI	80
9	Flanged Float Valve	CI	80
	OUTLET		
10	Flanged Strainer	SS	15
11	Flanged Pipe Piece , Length - 0.2m	DI	150
12	90° Flanged Bend	DI	15
13	Flanged Pipe, Length n.e - 5.0m	DI	15
14	Flanged Pipe, Length - 6.0m	DI	15
15	90° Flanged Duckfoot Bend	DI	150
16	Flanged Pipe Piece, Length - 0.3m	DI	150
17	Flanged Gate Valve	CI	15
18	Flanged Adapter	DI	150
	WASHOUT & OVERFLOW		
19	Flanged Bellmouth	DI	10
20	90° Flanged Bend	DI	10
21	Flanged Pipe, Length n.e - 0.2m	DI	10
22	Flanged Pipe Piece, Length - 5.0m	DI	10
23	Flanged Pipe Piece, Length n.e - 1.0m	DI	10
24	Flanged Tee	DI	10
25	Flanged Pipe Piece, Length - 6.0m	DI	10
26	90° Flanged Duckfoot Bend	DI	10
27	Flanged Adapter	DI	10
28	Flanged Gate Valve	CI	10

	LEGEND
N PN Qty.	
0 1	
0 1	
0 1	Ν
0 1 1 0 10 3	WEE
0 1	
0 1	5
0 1	CLIENT :
0 1	
	THE REPUBLIC OF UGANDA
0 1	CO-FINANCED BY:
0 1	
0 1	
0 1	
0 1	CONSULTANT :
	Alliance Consultants Itd
i0 1 i0 1	In Association with
0 1	Infra-Consult Ltd
0 1	
· !	PROJECT :
	ALA-ORA WATER SUPPLY AND
0 1	SANITATION PROJECT
0 3	NYAGAK WATER SUPPLY AND
0 1	SANITATION SYSTEM
0 2	REVISIONS :
0 10 2 0 10 1 0 3	No Date Description
0 1	
0 1	DRAWING TITLE : ANYIRIBU RESERVOIR TANK- 84m ³
0 1	PIPE FITTINGS
0 1	
<u> </u>	Surveyed by: R.K
	Drawn by: N.R
	Designed by: W.G.M
	Checked by: J.K.K Date:
	January 2023
	DRG. No.: NYA_RES_ANY_002 Scale: 1:50 Sheet No.:
	3 of 3


NYAGAK COMMUNITY SUPPLY AREA



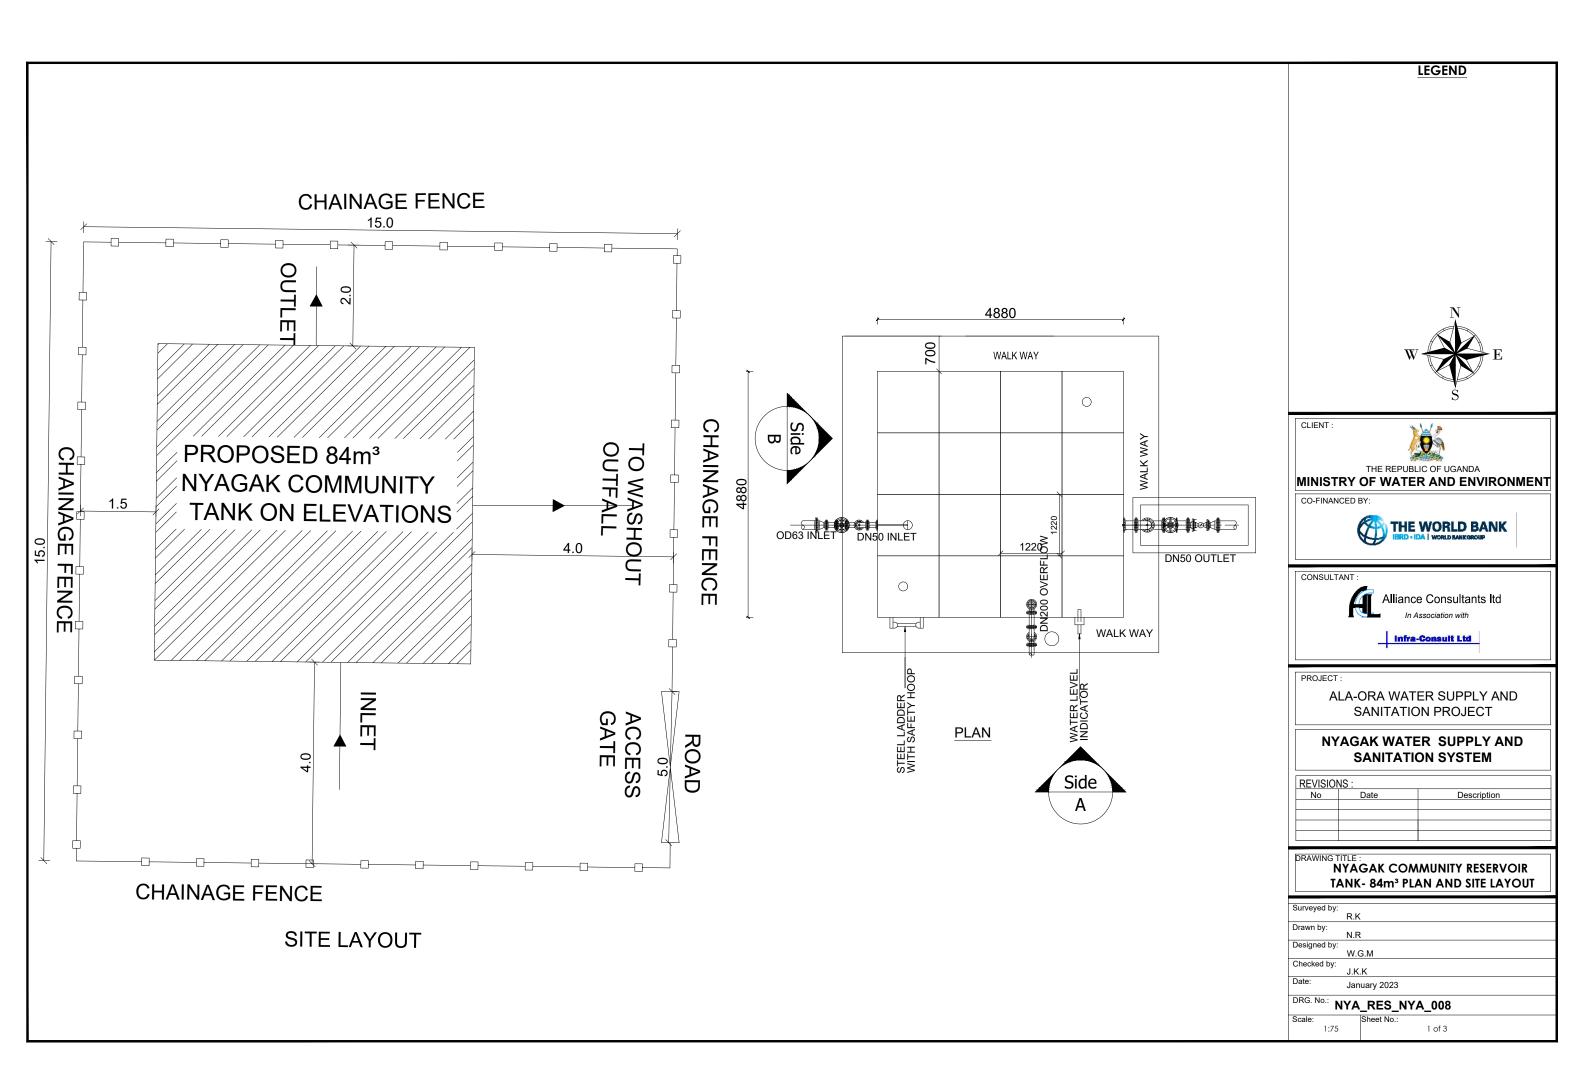

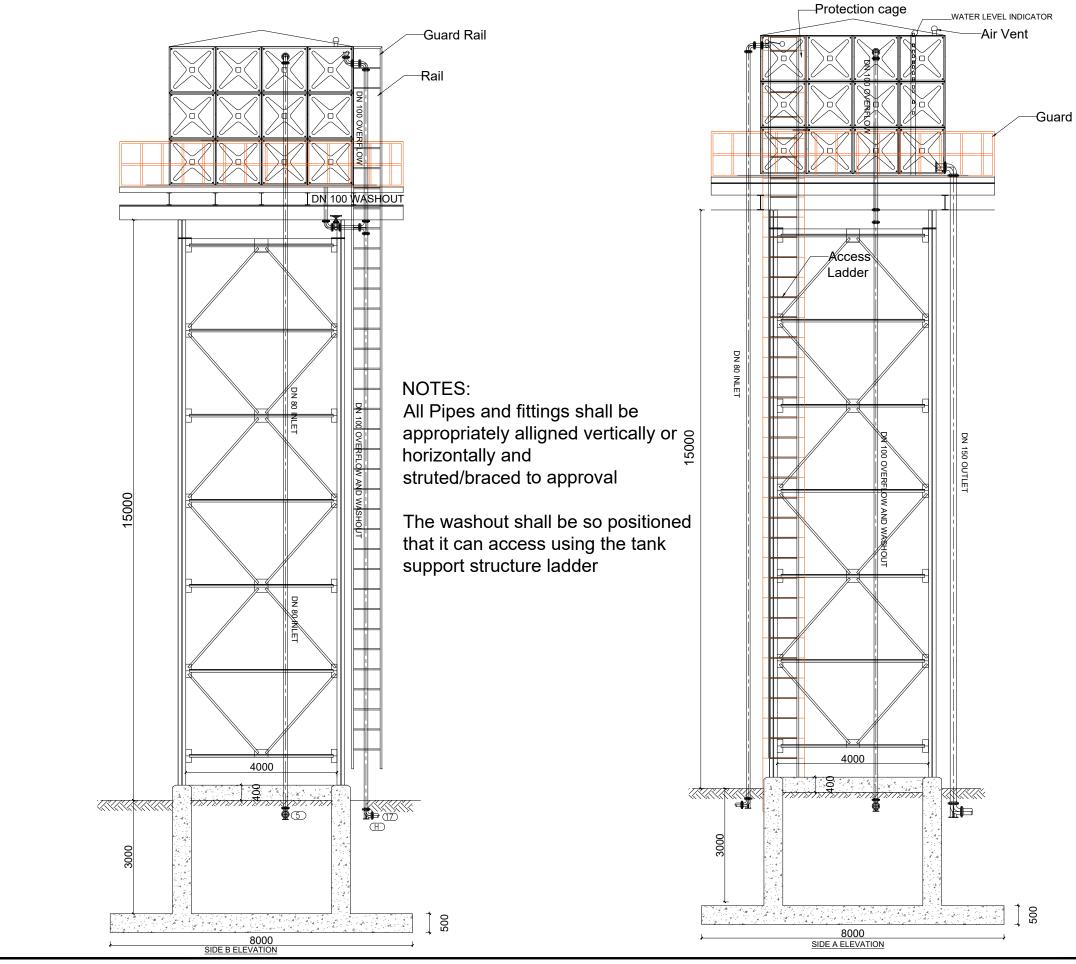


			LEGEND
Rail			
		W	N E S
	CLIENT :)	
		THE REPUBL	LIC OF UGANDA
	MINISTRY		R AND ENVIRONMENT
	CO-FINANCED	BY:	
	CONSULTANT	:	
	f		e Consultants Itd
		_ Infra	-Consult Ltd
	PROJECT :		
			ER SUPPLY AND ON PROJECT
			ER SUPPLY AND ON SYSTEM
	REVISIONS :		
	No	Date	Description
			MUNITY RESERVOIR
	INTAX		
	Surveyed by:		
	Surveyed by: R.ł Drawn by:	κ	
	Drawn by: N.F Designed by:	२	
	Checked by:	G.M	
	J.K Date:	(.К	
		nuary 2023	A 008
	Scale:	Sheet No.:	
	1:100		2 of 3

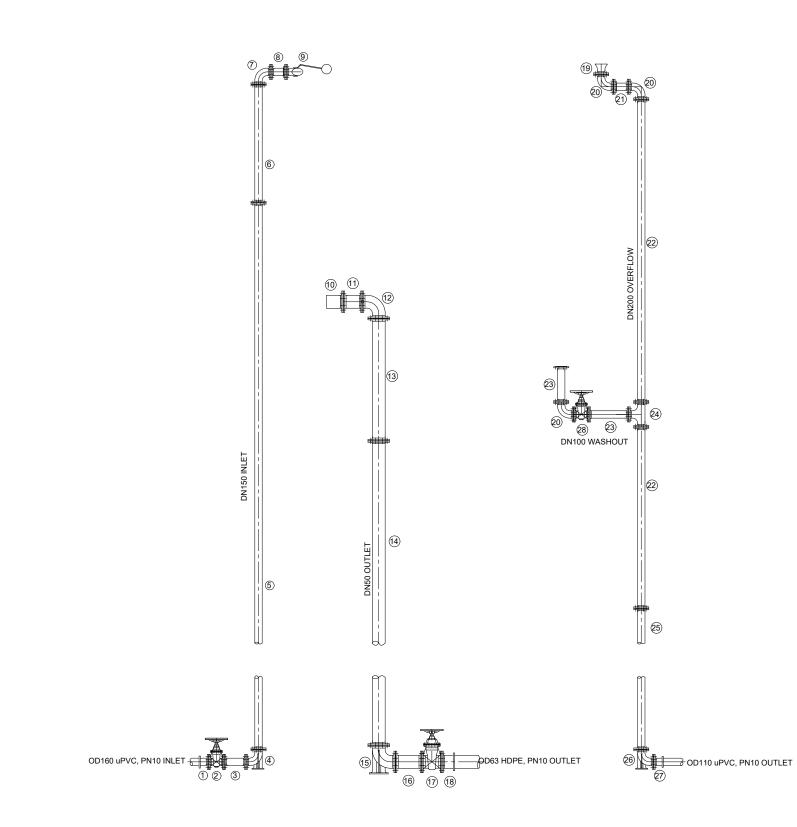

Mark	Description	Materia
	INLET	
1	Flanged Adapter	DI
2	Flanged Gate Valve	CI
3	Flanged Pipe Piece, Length - 0.3m	DI
4	90° Flanged Duckfoot Bend	DI
5	Flanged Pipe, Length - 6.0m	DI
6	Flanged Pipe, Length n.e - 2.0m	DI
7	90° Flanged Bend	DI
8	Flanged Pipe Piece, Length - 0.2m	DI
9	Flanged Float Valve	CI
	OUTLET	
10	Flanged Strainer	SS
11	Flanged Pipe Piece , Length - 0.2m	DI
12	90° Flanged Bend	DI
13	Flanged Pipe, Length n.e - 5.0m	DI
14	Flanged Pipe, Length - 6.0m	DI
15	90° Flanged Duckfoot Bend	DI
16	Flanged Pipe Piece, Length - 0.3m	DI
17	Flanged Gate Valve	CI
18	Flanged Adapter	DI
	WASHOUT & OVERFLOW	
19	Flanged Bellmouth	DI
20	90° Flanged Bend	DI
21	Flanged Pipe, Length n.e 0.2m	DI
22	Flanged Pipe Piece, Length - 5.0m	DI
23	Flanged Pipe Piece, Length n.e - 1.0m	DI
24	Flanged Tee	DI
25	Flanged Pipe Piece, Length - 6.0m	DI


	. tangea too	
25	Flanged Pipe Piece, Length - 6.0m	DI
26	90° Flanged Duckfoot Bend	DI
27	Flanged Adapter	DI
28	Flanged Gate Valve	CI

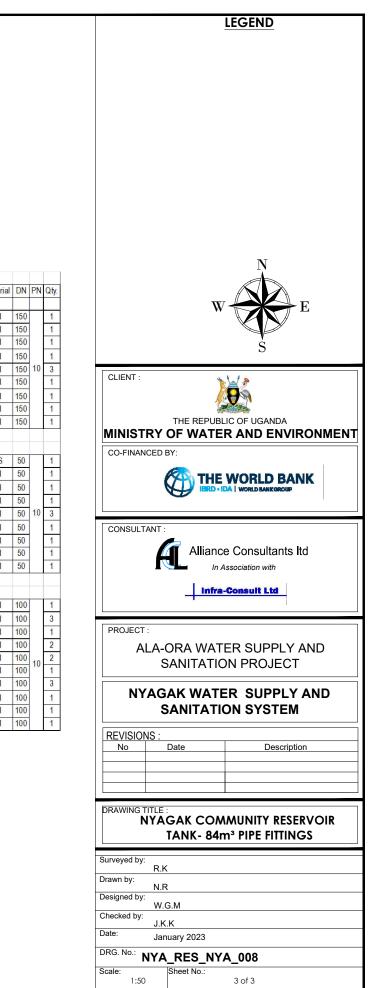


	NYA-GTM-001 - CH 14+720		SCHEDULE OF PIPEWORK & FIT	TTINGS		
OD2	25uPVCPN16 - OD225uPVCPN1	IO	DESCRIPTION	SIZE	QTY.	PN
		1	DI FLANGED ADAPTOR (MAXI TYPE OR SIMILAR)	225	1	16
		2	FLANGED COUPLER	225/225	1	16
	() (2) (3)	3	DI FLANGED ADAPTOR (MAXI TYPE OR SIMILAR)	225	1	16
OFFAKA TEE	DWG No CHAINAGE	NODE No.	7			
1	NYA-GTM-001 - CH 8+053	2	-			
	91 Zc		SCHEDULE OF PIPEWORK & FI	TTINGS		
		ITEM	DESCRIPTION	SIZE	QTY.	PN
		1.	CI ALL FLANGED TEE	300/250	1	16
		2.	DI FLANGED TAPER	300/225	1	16
		3	CI FLANGED GATE VALVE	225	1	16
	5	4	CI FLANGED GATE VALVE	250	1	16
		5	FLANGED COUPLER	300/225	1	16
		6	DI FLANGED ADAPTOR (MAXI TYPE OR SIMILAR)	225	1	16
		7	DI FLANGED ADAPTOR (MAXI TYPE OR SIMILAR)	300	1	16
		8	DI FLANGED ADAPTOR (MAXI TYPE OR SIMILAR)	250	1	16
NDIRIBA TANK	DWG No CHAINAGE	NODE No.				
1	NYA-GTM-001 - CH 17+892	3				
	OD 225 UPV <u>CPN10 -</u>		SCHEDULE OF PIPEWORK & FIT	TINGS		
		ITEM	DESCRIPTION	SIZE	QTY.	PN
		1.	DI END CAP	225	1	10
			SCHEDULE OF PIPEWO	ORK & FITT	INGS	
	DWG No CHAINAGE	NODE No.			SIZE	QTY.
2	NYA-GTM-002 - CH 15+370	4	1 DI FLANGED ADAPTOR (MAXI TYPE OR SIMILA	(R)	250	1
($\overline{1}$ (2) (3)		2 CI ALL FLANGED WYE	,	250/225	1
			3 END CAP		250/225	1
			4 CI FLANGED GATE VALVE		225	1
						-
DN250uPVC PN10			5 DI FLANGED ADAPTOR (MAXI TYPE OR SIMILA	(R)	75	1

LEGEND					
CLIENT :					
THE REPUBLIC OF UGANDA					
MINISTRY OF WATER AND ENVIRONMENT					
CO-FINANCED BY:					
CONSULTANT :					
Alliance Consultants Itd					
In Association with					
infra-Consult Ltd					
PROJECT :					
ALA-ORA WATER SUPPLY AND					
SANITATION PROJECT					
NYAGAK WATER SUPPLY AND					
SANITATION SYSTEM					
REVISIONS : No Date Description					
No Date Description					
Surveyed by:					
Surveyed by: R.K Drawn by: A.K					
Surveyed by: R.K Drawn by: A.K Designed by: W.G.M					
Surveyed by: R.K Drawn by: A.K Designed by: W.G.M Checked by: J.K.K					
Surveyed by: R.K Drawn by: A.K Designed by: W.G.M Checked by: J.K.K Date: January 2023					
Surveyed by: R.K Drawn by: A.K Designed by: W.G.M Checked by: J.K.K Date:					


STRUCTURAL DRAWINGS

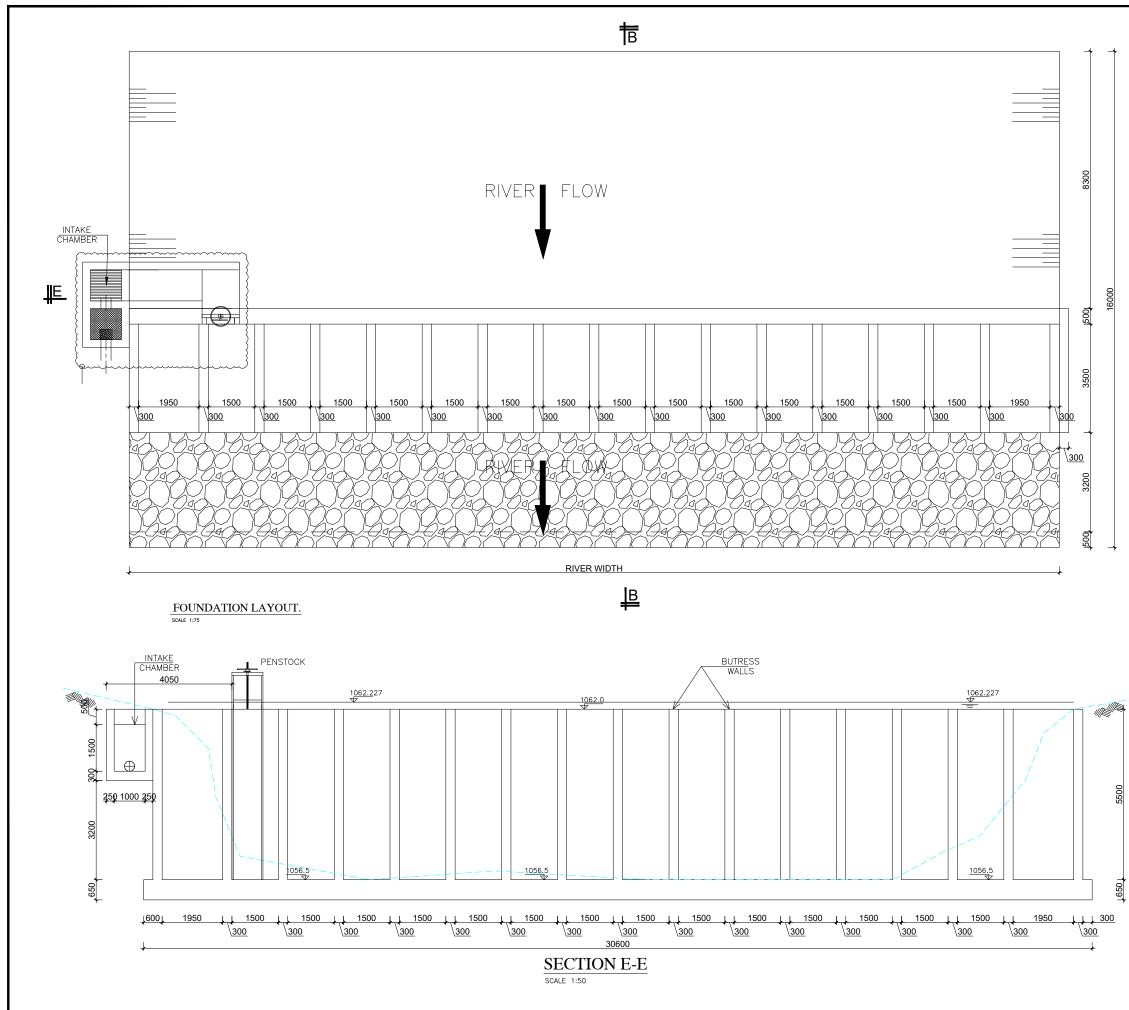


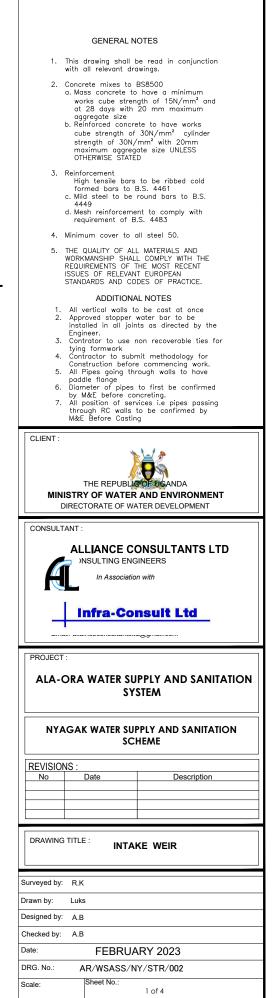



틔

650

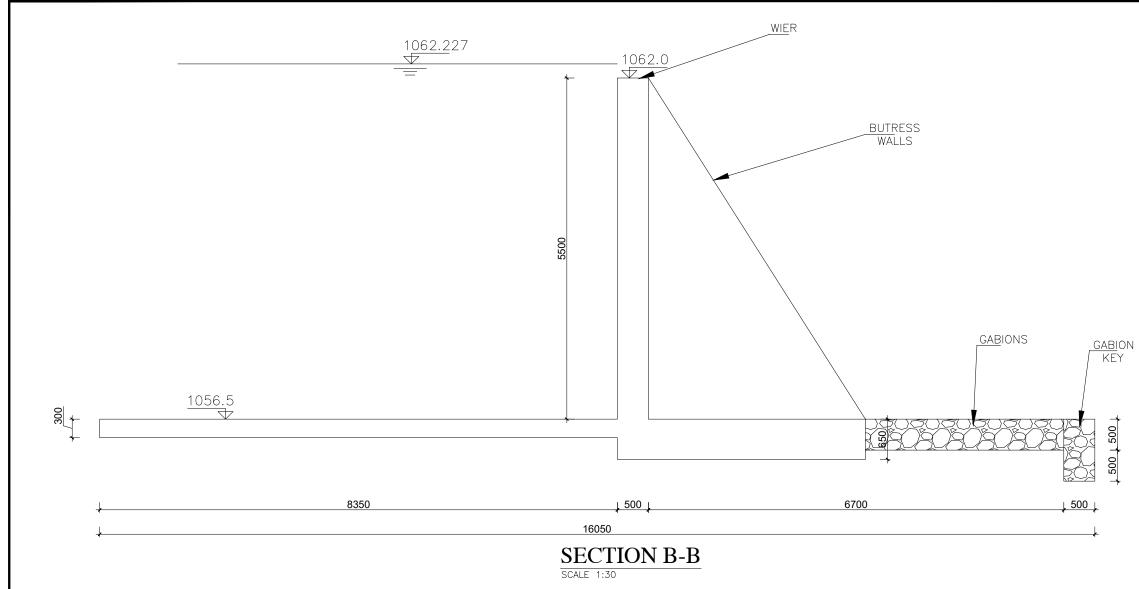


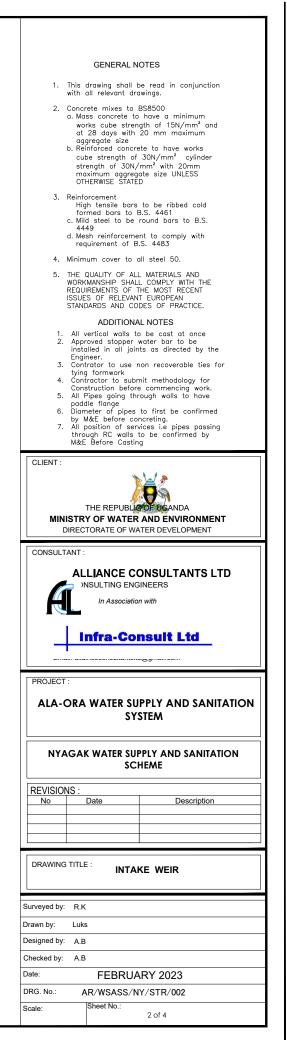


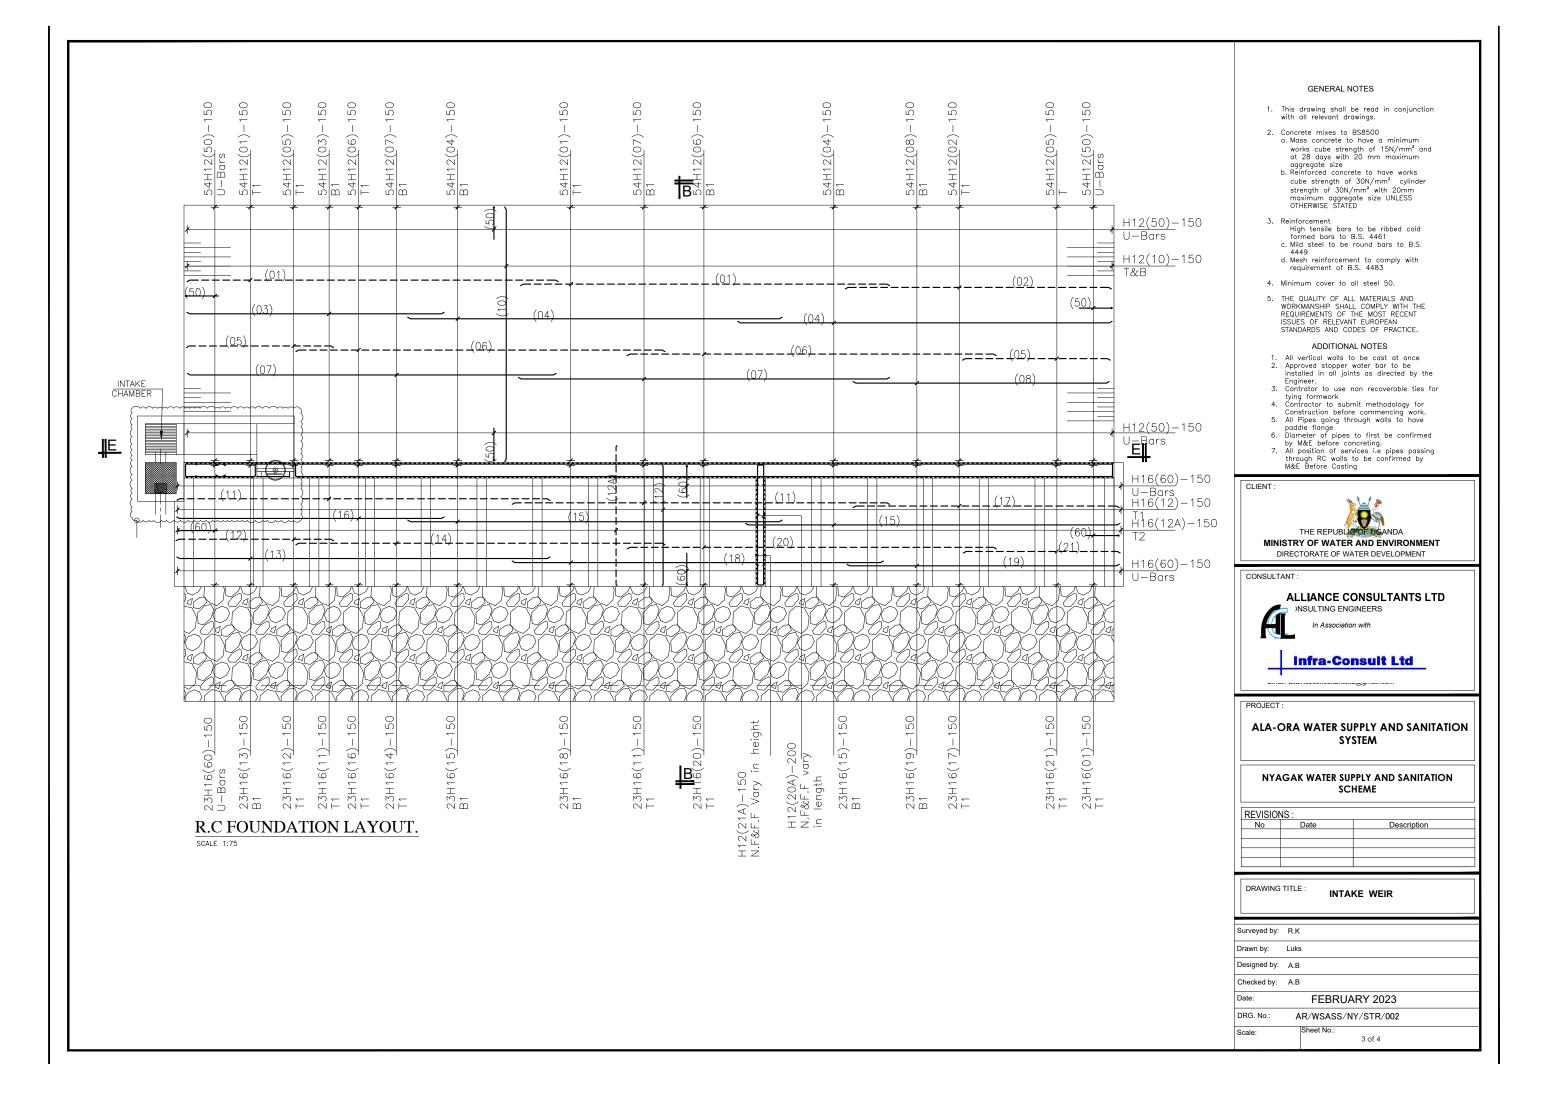


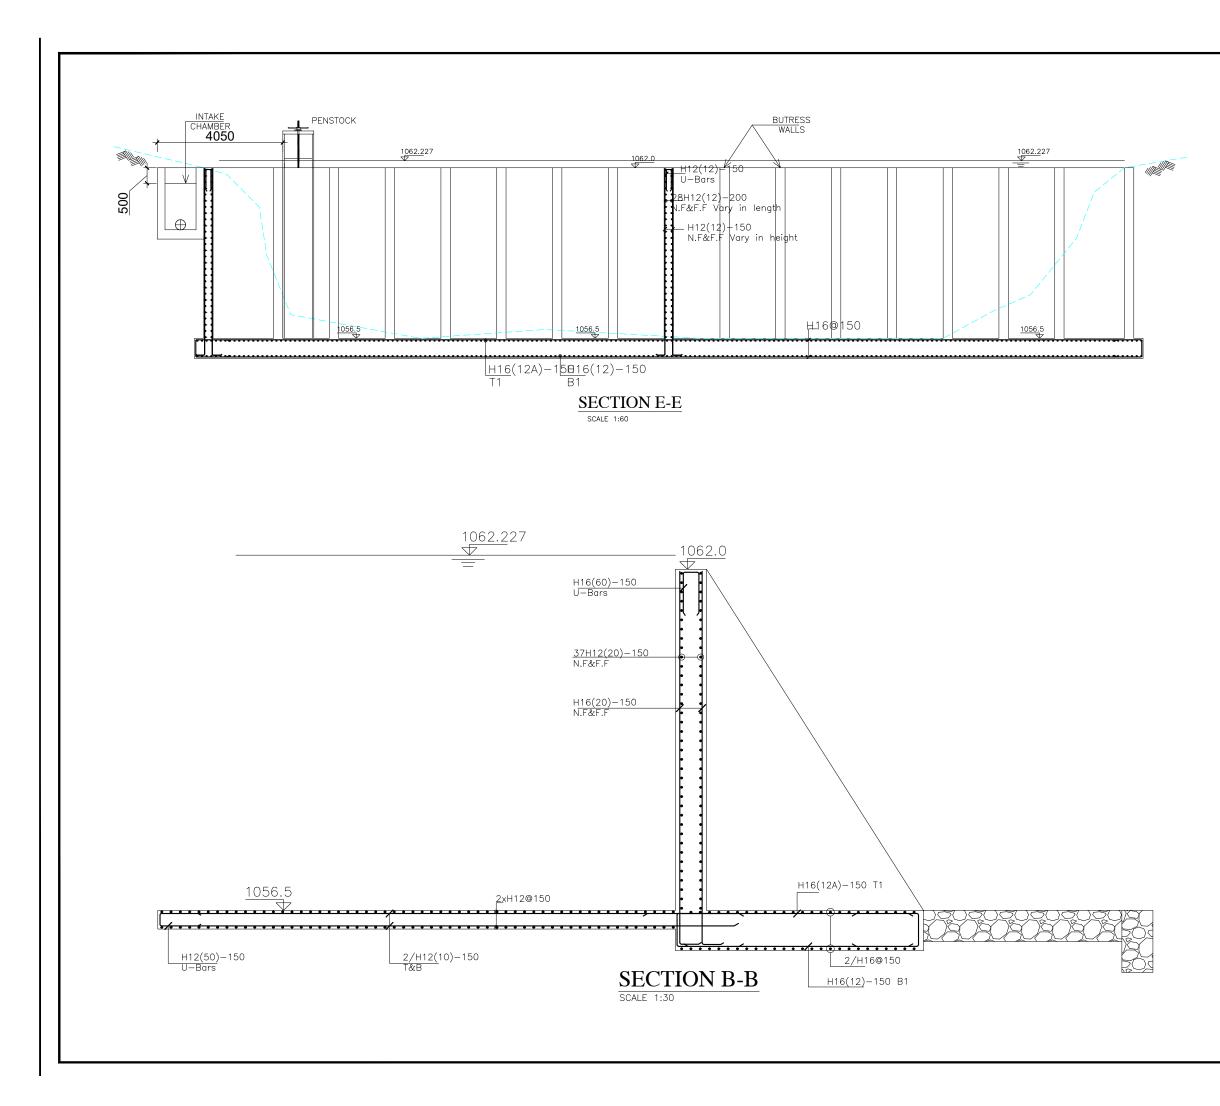





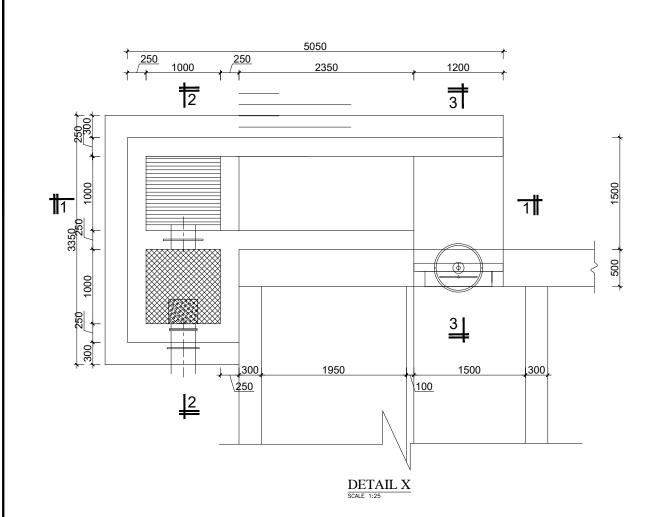


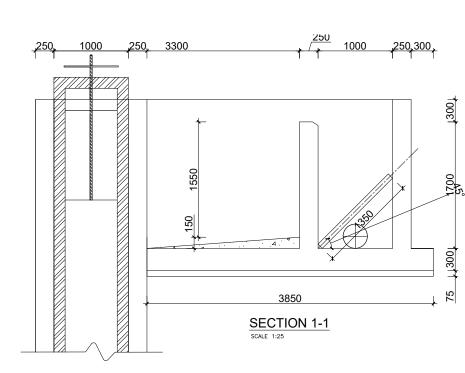


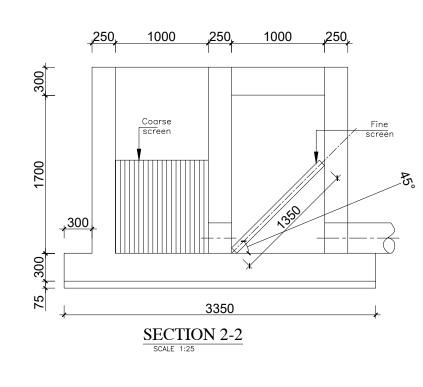


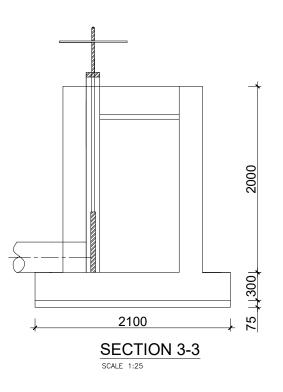


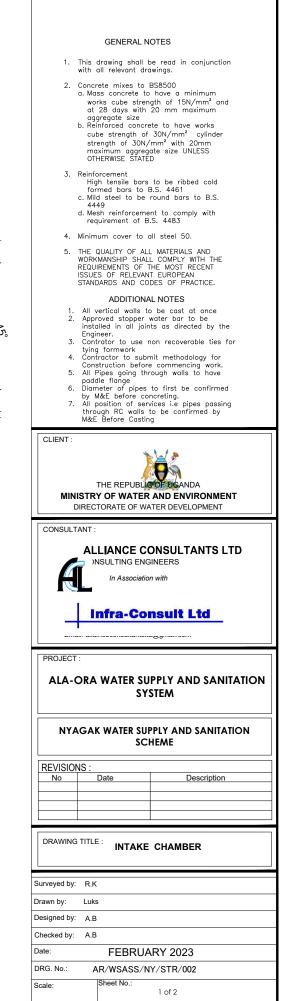


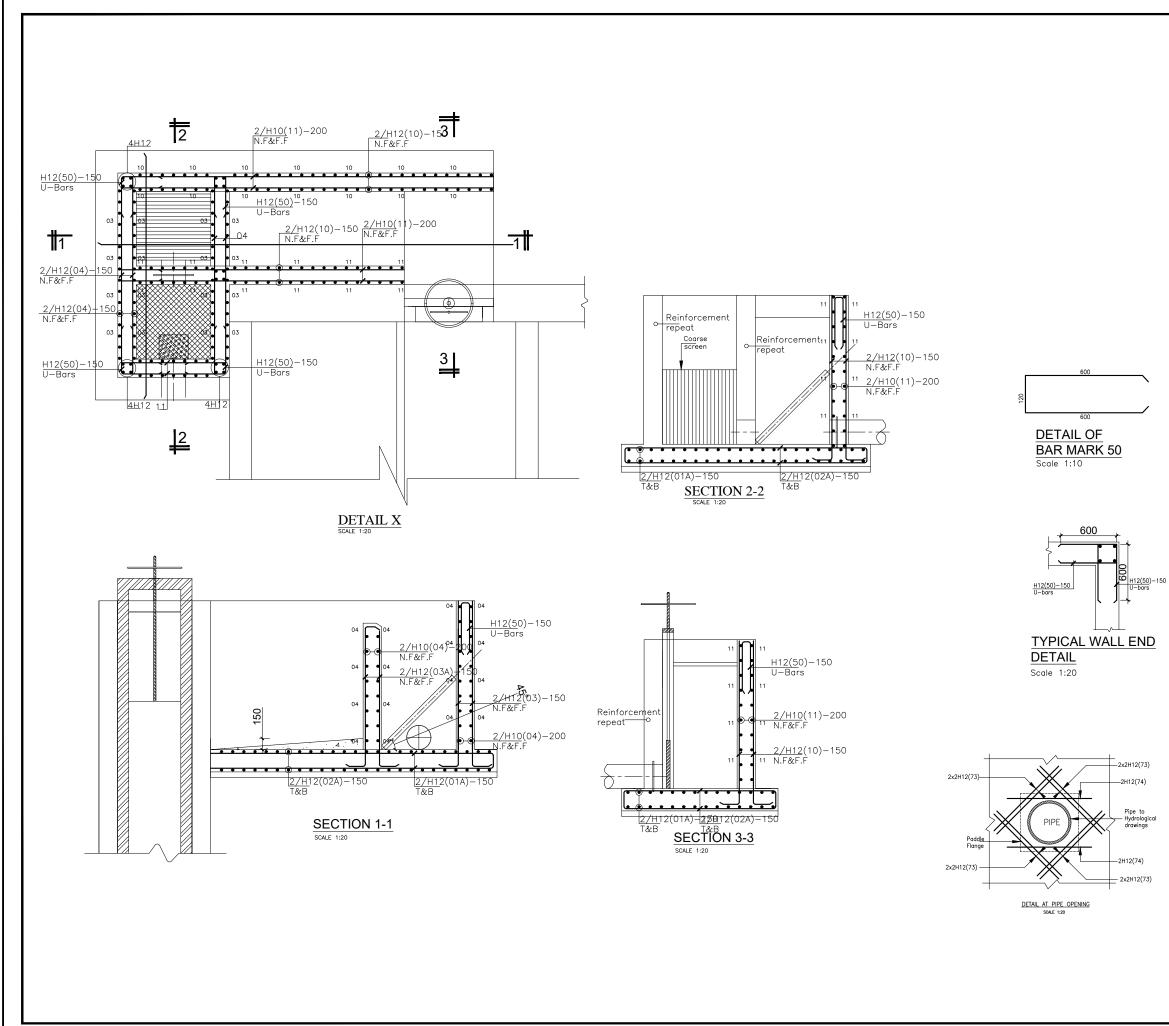


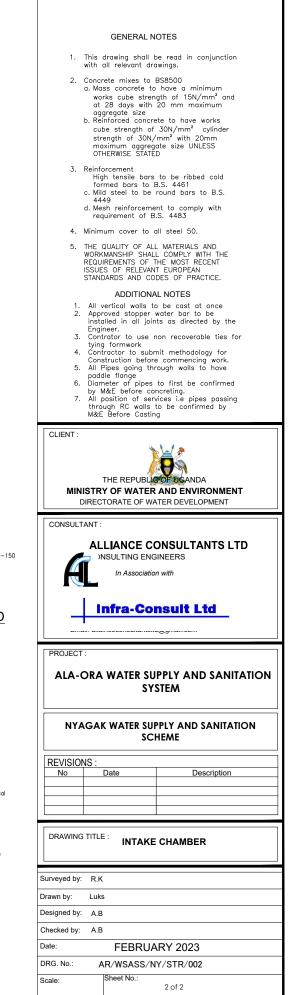


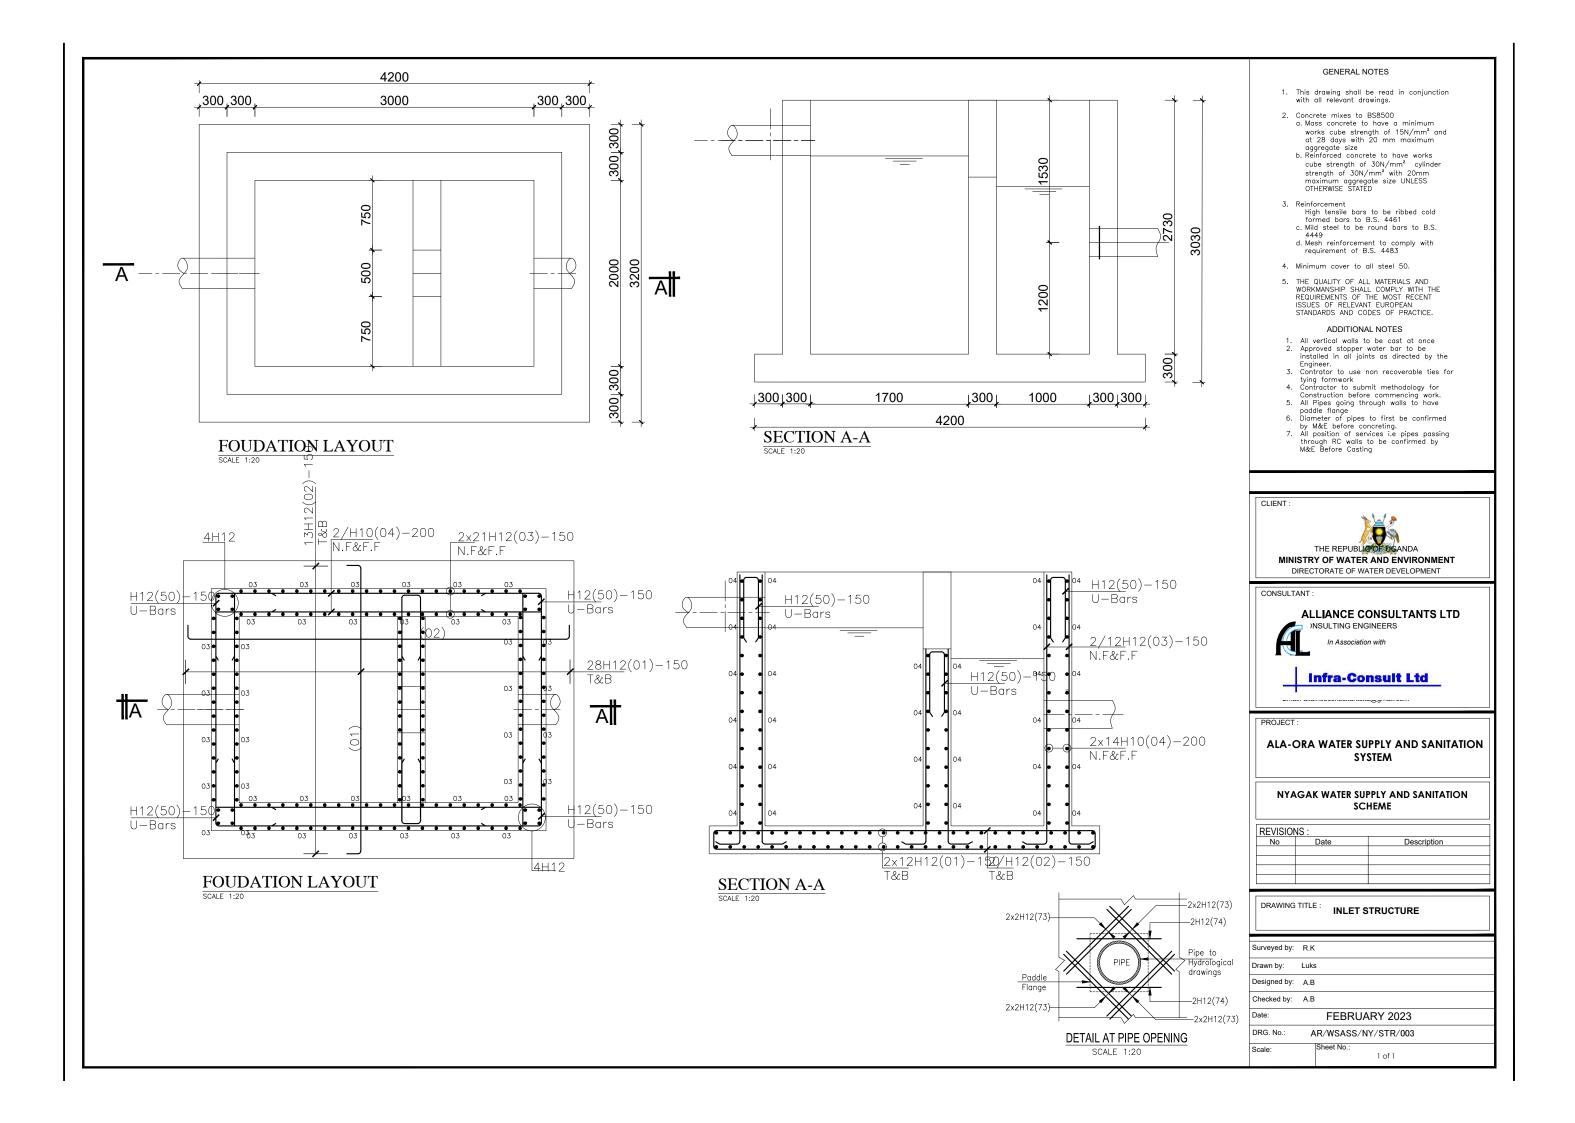


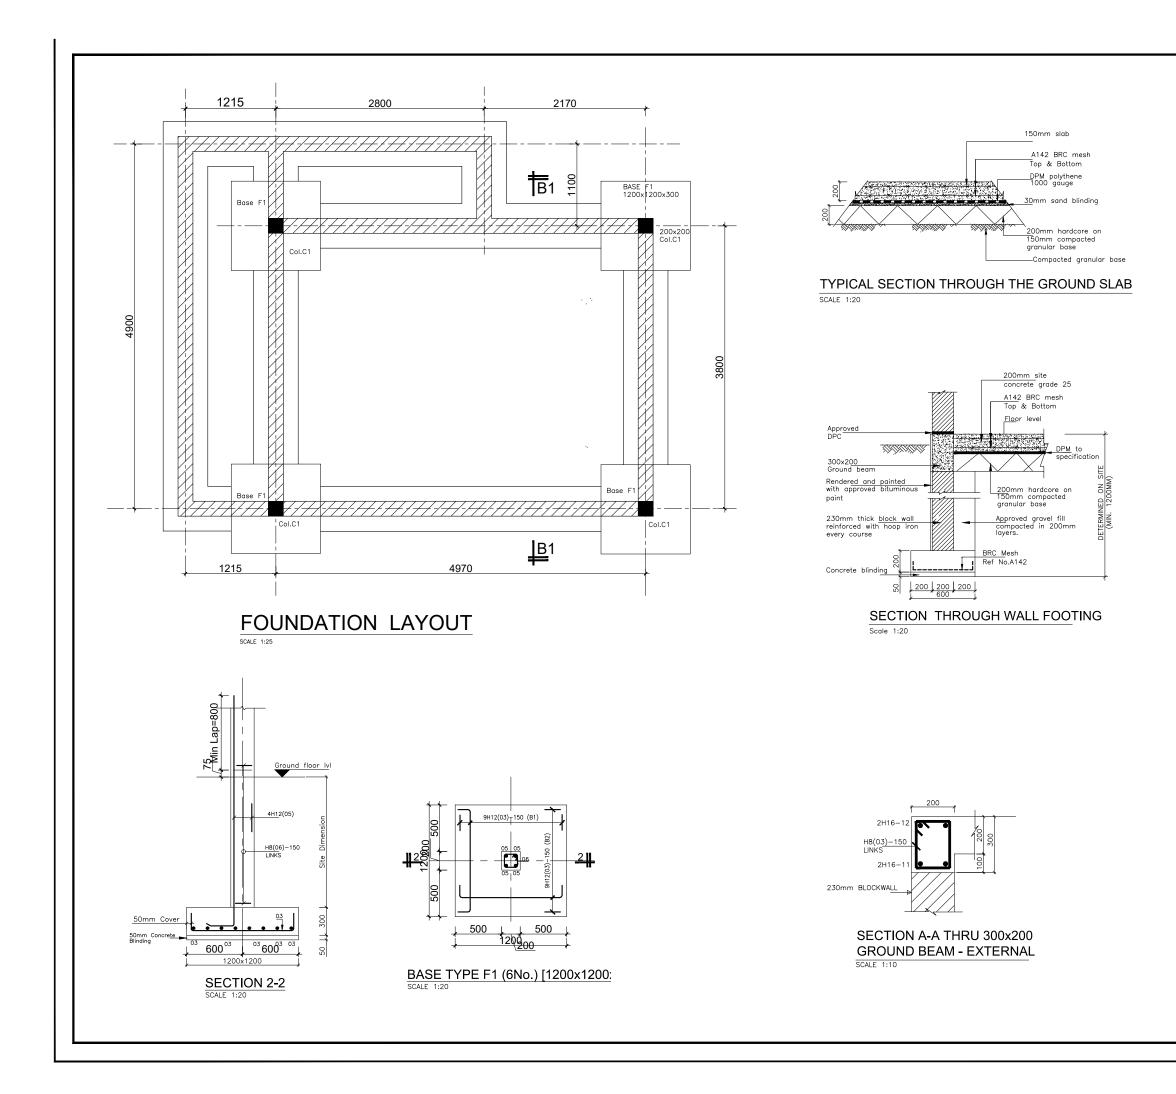


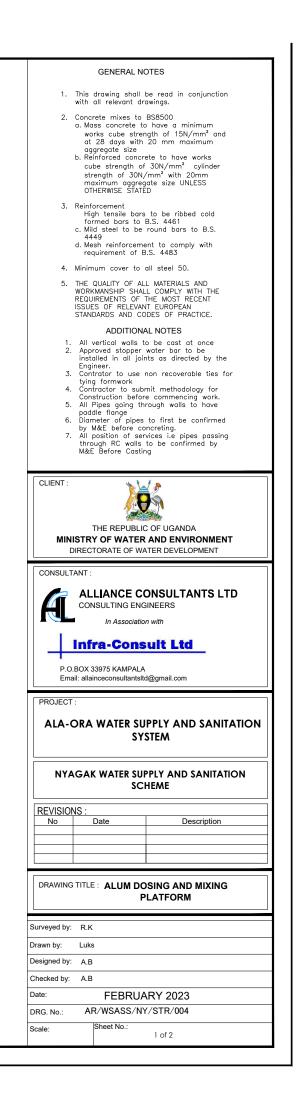

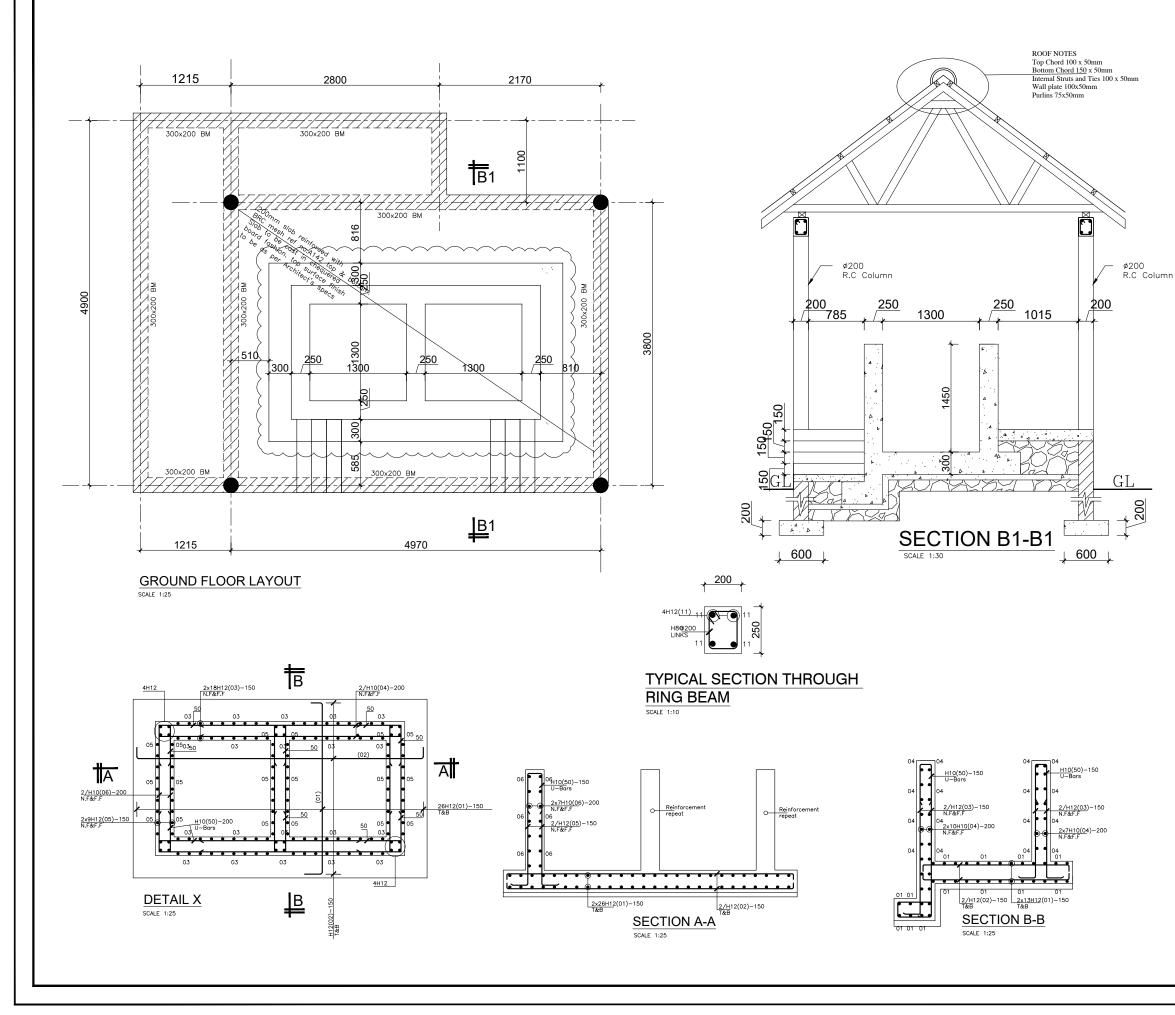


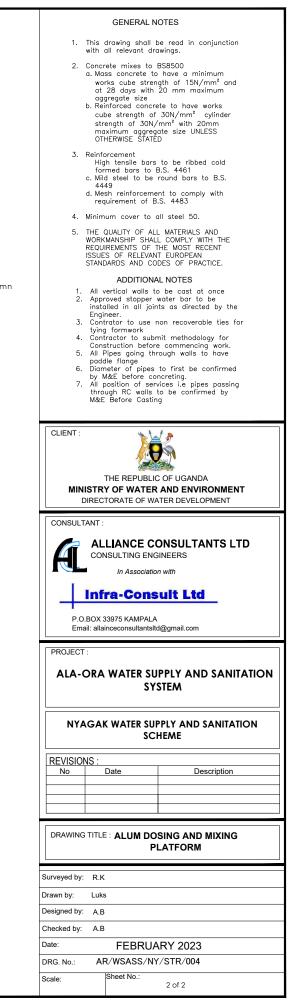

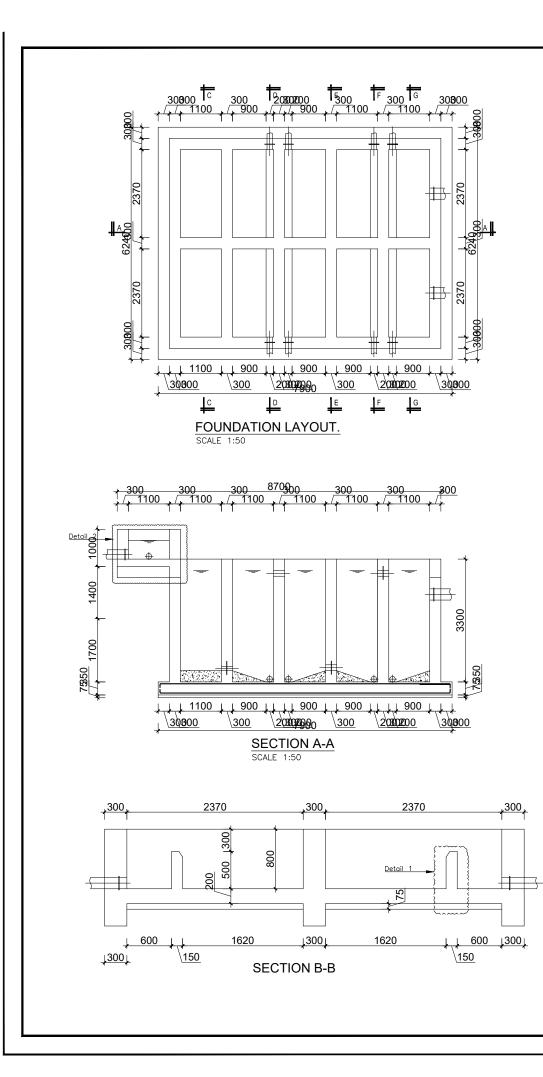


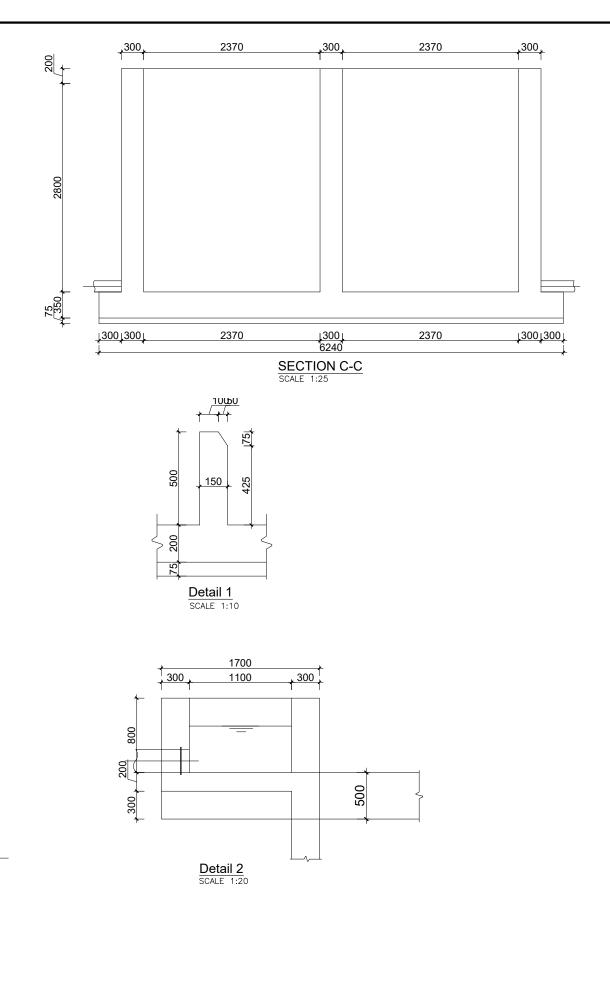



GENERAL	GENERAL NOTES			
	l be read in conjunction drawings.			
 with all relevant drawings. 2. Concrete mixes to BS8500 a. Mass concrete to have a minimum works cube strength of 15N/mm² and at 28 days with 20 mm maximum aggregate size b. Reinforced concrete to have works cube strength of 30N/mm² cylinder strength of 30N/mm³ with 20mm maximum aggregate size UNLESS OTHERWISE STATED 				
 Reinforcement High tensile bars to be ribbed cold formed bars to B.S. 4461 Mild steel to be round bars to B.S. 4449 Mesh reinforcement to comply with requirement of B.S. 4483 				
4. Minimum cover to all steel 50.				
5. THE QUALITY OF ALL MATERIALS AND WORKMANSHIP SHALL COMPLY WITH THE REQUIREMENTS OF THE MOST RECENT ISSUES OF RELEVANT EUROPEAN STANDARDS AND CODES OF PRACTICE.				
 All vertical walls to be cast at once Approved stopper water bar to be installed in all joints as directed by the Engineer. Contractor to use non recoverable ties for tying formwork Contractor to submit methodology for Construction before commencing work. All Pipes going through walls to have paddle flange Diameter of pipes to first be confirmed by M&E before concreting. All position of services i.e pipes passing through RC walls to be confirmed by M&E Before Casting 				
THE REPUBLIC OF UGANDA MINISTRY OF WATER AND ENVIRONMENT DIRECTORATE OF WATER DEVELOPMENT				
-	CONSULTANTS LTD			
ALLIANCE CONSULTING ET	ition with			
	NGINEERS tion with ISUIT Ltd			
ALLIANCE C CONSULTING EN In Associa Infra-Con P.O.BOX 33975 KAMPAI Email: allainceconsultant	NGINEERS tion with ISUIT Ltd			
ALLIANCE C CONSULTING EN In Associa P.O.BOX 33975 KAMPAI Email: allainceconsultant PROJECT : ALA-ORA WATER S	NGINEERS tion with ISUIT Ltd			
ALLIANCE C CONSULTING EN In Associa P.O.BOX 33975 KAMPAI Email: allainceconsultant PROJECT : ALA-ORA WATER S S	NGINEERS tion with ISUIT Ltd LA sltd@gmail.com SUPPLY AND SANITATION			
ALLIANCE C CONSULTING EN In Associa Infra-Con P.O.BOX 33975 KAMPAL Email: allainceconsultant PROJECT : ALA-ORA WATER S S NYAGAK WATER SUPPL REVISIONS :	NGINEERS Ition with Sulf Ltd LA Stid@gmail.com SUPPLY AND SANITATION YSTEM LY AND SANITATION SYSTEM			
ALLIANCE C CONSULTING EF In Associa P.O.BOX 33975 KAMPAI Email: allainceconsultant PROJECT : ALA-ORA WATER S NYAGAK WATER SUPPI	NGINEERS Ition with Sult Ltd Stid@gmail.com SUPPLY AND SANITATION YSTEM			
ALLIANCE C CONSULTING EN In Associa Infra-Con P.O.BOX 33975 KAMPAL Email: allainceconsultant PROJECT : ALA-ORA WATER S S NYAGAK WATER SUPPL REVISIONS :	NGINEERS Ition with Sulf Ltd LA Stid@gmail.com SUPPLY AND SANITATION YSTEM LY AND SANITATION SYSTEM			
ALLIANCE CONSULTING EN In Associa Infra-Con P.O.BOX 33975 KAMPAI Email: allainceconsultant PROJECT : ALA-ORA WATER SUPPI REVISIONS : NO Date	NGINEERS Ition with Sulf Ltd LA Stid@gmail.com SUPPLY AND SANITATION YSTEM LY AND SANITATION SYSTEM			
ALLIANCE CONSULTING EN In Associa Infra-Con P.O.BOX 33975 KAMPAI Email: allainceconsultant PROJECT : ALA-ORA WATER SUPPI REVISIONS : NO Date	NGINEERS tion with Sult Ltd LA stid@gmail.com UPPLY AND SANITATION YSTEM UY AND SANITATION SYSTEM Description			
ALLIANCE CONSULTING EN IN Associa Infra-Con P.O.BOX 33975 KAMPAI Email: allainceconsultant PROJECT : ALA-ORA WATER SUPPI ALA-ORA WATER SUPPI REVISIONS : No Date Date DRAWING TITLE : FLOC	NGINEERS tion with Sult Ltd LA stid@gmail.com UPPLY AND SANITATION YSTEM UY AND SANITATION SYSTEM Description			
ALLIANCE C CONSULTING EN In Associa Infra-Com P.O.BOX 33975 KAMPAI Email: allainceconsultant PROJECT : ALA-ORA WATER S NYAGAK WATER SUPPI REVISIONS : No Date DRAWING TITLE : FLOO	NGINEERS tion with Sult Ltd LA stid@gmail.com UPPLY AND SANITATION YSTEM UY AND SANITATION SYSTEM Description			
ALLIANCE C CONSULTING EF In Associa Infra-Con P.O.BOX 33975 KAMPAI Email: allainceconsultant PROJECT : ALA-ORA WATER S NYAGAK WATER SUPPI REVISIONS : NO Date Drawing TITLE : FLOO	NGINEERS tion with Sult Ltd LA stid@gmail.com UPPLY AND SANITATION YSTEM UY AND SANITATION SYSTEM Description			
ALLIANCE CONSULTING EN Infra-Con Infra-Con P.O.BOX 33975 KAMPAI Email: allainceconsultant PROJECT : ALA-ORA WATER SUPPI REVISIONS : No Date DRAWING TITLE : FLOOR Surveyed by: R.K Drawn by: Luks Designed by: A.B	NGINEERS tion with Sult Ltd LA stid@gmail.com UPPLY AND SANITATION YSTEM UPPLY AND SANITATION SYSTEM Description			
ALLIANCE CONSULTING EN Infra-Con Infra-Con P.O.BOX 33975 KAMPAI Email: allainceconsultant PROJECT : ALA-ORA WATER SUPPI REVISIONS : No Date DRAWING TITLE : FLOOR Surveyed by: R.K Drawn by: Luks Designed by: A.B	NGINEERS tion with Sulf Ltd LA sitd@gmail.com UPPLY AND SANITATION YSTEM Description CCULATOR JARY 2023			

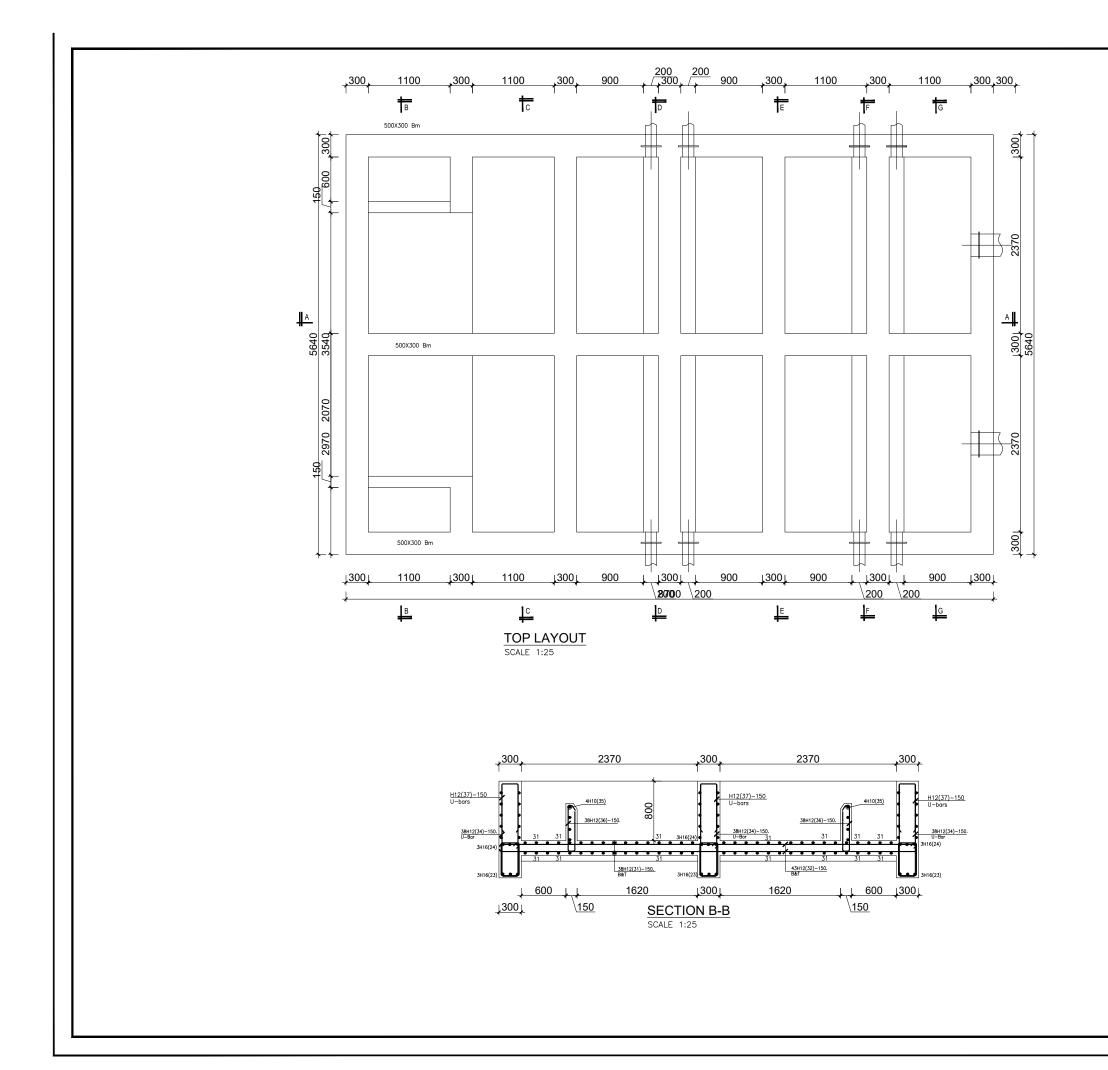


GENERAL NOTES						
		pe read in conjunction				
	all relevant dro rete mixes to	-				
 Concrete mixes to BS8500 Mass concrete to have a minimum works cube strength of 15N/mm² and 						
at	28 days with gregate size	20 mm maximum				
b. Re	inforced concre be strength of	ete to have works 30N/mm² cylinder				
str	ength of 30N/	'mm² with 20mm ate size UNLESS				
OT	HERWISE STATE	D				
3. Reinfo Hic	orcement ih tensile bars	to be ribbed cold				
High tensile bars to be ribbed cold formed bars to B.S. 4461 Mid etcal to be round bars to B.S.						
c. Mild steel to be round bars to B.S. 4449						
d. Mesh reinforcement to comply with requirement of B.S. 4483						
4. Minimum cover to all steel 50.						
WORK	MANSHIP SHAL	_ MATERIALS AND L COMPLY WITH THE				
	IREMENTS OF T S OF RELEVAN	THE MOST RECENT T EUROPEAN				
STAN	DARDS AND CO	DES OF PRACTICE.				
1. All y	ADDITIONA	L NOTES be cast at once				
2. App	roved stopper	water bar to be ts as directed by the				
Engi	neer.	non recoverable ties for				
tying	g formwork	nit methodology for				
Con	struction before	e commencing work. ough walls to have				
pada 6 Dian	dle flange	to first be confirmed				
by M 7. All p	M&E before co position of serv	vices i.e pipes passing to be confirmed by				
thro M&E	ugh RC walls Before Castin	to be confirmed by				
CLIENT :	* 1.	1				
		THE REPUBLIC OF UGANDA				
MINISTRY OF WATER AND ENVIRONMENT						
-		AND ENVIRONMENT				
-						
-		AND ENVIRONMENT				
CONSULTANT :	LIANCE CO	AND ENVIRONMENT ITER DEVELOPMENT				
CONSULTANT :	LIANCE CO	AND ENVIRONMENT ITER DEVELOPMENT				
CONSULTANT :	LIANCE CO	AND ENVIRONMENT ITER DEVELOPMENT				
	LIANCE CO	AND ENVIRONMENT ITER DEVELOPMENT				
	LIANCE CO NSULTING ENG In Associatio	AND ENVIRONMENT ITER DEVELOPMENT DNSULTANTS LTD INEERS n with				
	LIANCE CO NSULTING ENG	AND ENVIRONMENT ITER DEVELOPMENT				
	LIANCE CO NSULTING ENG In Associatio ra-Cons 33975 KAMPALA	AND ENVIRONMENT ITER DEVELOPMENT				
CONSULTANT : CONSULTANT : AL CON P.O.BOX : Email: alla	LIANCE CO NSULTING ENG In Associatio Fa - Cons 33975 KAMPALA inceconsultantsite	AND ENVIRONMENT ITER DEVELOPMENT				
DIREC CONSULTANT : CONSULTANT : AL CON P.O.BOX : Email: alla	LIANCE CC NSULTING ENG In Associatio ra-Cons 33975 KAMPALA inceconsultantsite WATER SU	AND ENVIRONMENT ITER DEVELOPMENT DNSULTANTS LTD INEERS In with Image: Substance of the second s				
CONSULTANT : CONSULTANT : AL CON P.O.BOX : Email: alla	LIANCE CC NSULTING ENG In Associatio ra-Cons 33975 KAMPALA inceconsultantsite WATER SU	AND ENVIRONMENT ITER DEVELOPMENT				
CONSULTANT : CONSULTANT : AL CON P.O.BOX : Email: alla	LIANCE CC NSULTING ENG In Associatio ra-Cons 33975 KAMPALA inceconsultantsite WATER SU	AND ENVIRONMENT ITER DEVELOPMENT DNSULTANTS LTD INEERS In with IneerS In with IneerS In with IneerS In with IneerS In with IneerS				
CONSULTANT : CONSULTANT : ALCON P.O.BOX : Email: alla PROJECT : ALA-ORA	LIANCE CC NSULTING ENG In Associatio ra-Cons 33975 KAMPALA inceconsultantsite	AND ENVIRONMENT ITER DEVELOPMENT DNSULTANTS LTD INEERS In with IneerS In with IneerS In with IneerS In with IneerS In with IneerS				
DIREC CONSULTANT : ALA-ORA	LIANCE CC NSULTING ENG In Associatio ra-Cons 33975 KAMPALA inceconsultantsite	AND ENVIRONMENT ITER DEVELOPMENT DNSULTANTS LTD INEERS n with INELT Ltd I@gmail.com PPLY AND SANITATION STEM				
	LIANCE CO NSULTING ENG In Associatio ra-Cons 33975 KAMPALA inceconsultantsite WATER SU SY:	AND ENVIRONMENT ITER DEVELOPMENT DNSULTANTS LTD INDEERS In with INDEERS INDEER				
DIREC CONSULTANT : ALA-ORA NYAGAK W/	LIANCE CO NSULTING ENG In Associatio ra-Cons 33975 KAMPALA inceconsultantsite WATER SU SY:	AND ENVIRONMENT ITER DEVELOPMENT DNSULTANTS LTD INEERS n with INELT Ltd I@gmail.com PPLY AND SANITATION STEM				
	LIANCE CO NSULTING ENG In Associatio ra-Cons 33975 KAMPALA inceconsultantsite WATER SU SY:	AND ENVIRONMENT ITER DEVELOPMENT DNSULTANTS LTD INDEERS In with INDEERS INDEER				
	LIANCE CO NSULTING ENG In Associatio ra-Cons 33975 KAMPALA inceconsultantsite WATER SU SY:	AND ENVIRONMENT ITER DEVELOPMENT DNSULTANTS LTD INDEERS In with INDEERS INDEER				
DIREC CONSULTANT : ALCON P.O.BOX : Email: alla PROJECT : ALA-ORA NYAGAK W/ REVISIONS : No	LIANCE CC NSULTING ENG In Associatio ra-Cons 33975 KAMPALA inceconsultantsite WATER SU SY: ATER SUPPLY Date	AND ENVIRONMENT ITER DEVELOPMENT DISULTANTS LTD INFERS IN with INFERS INFORMATION INFORMA				
	LIANCE CC NSULTING ENG In Associatio ra-Cons 33975 KAMPALA inceconsultantsite WATER SU SY: ATER SUPPLY Date	AND ENVIRONMENT ITER DEVELOPMENT DNSULTANTS LTD INNEERS In with INNEERS INNEER				
DIREC CONSULTANT : ALCON P.O.BOX : Email: alla PROJECT : ALA-ORA NYAGAK W/ REVISIONS : No EVISIONS :	LIANCE CC NSULTING ENG In Associatio ra-Cons 33975 KAMPALA inceconsultantsite WATER SU SY: ATER SUPPLY Date	AND ENVIRONMENT ITER DEVELOPMENT DISULTANTS LTD INDERS IN WITH INITE LTC INITE LTC INITE LTC INITE INITIALION INITE INITIALION				
DIREC CONSULTANT : ALCON P.O.BOX : Email: alla PROJECT : ALA-ORA NYAGAK W/ REVISIONS : No EVISIONS :	LIANCE CC NSULTING ENG In Associatio ra-Cons 33975 KAMPALA inceconsultantsite WATER SUPPLY Date	AND ENVIRONMENT ITER DEVELOPMENT DISULTANTS LTD INDERS IN WITH INITE LTC INITE LTC INITE LTC INITE INITIALION INITE INITIALION				
DIREC CONSULTANT : ALCON P.O.BOX : Email: alla PROJECT : ALA-ORA NYAGAK W/ REVISIONS : No DRAWING TITLE	LIANCE CO NSULTING ENG In Associatio ra-Cons 33975 KAMPALA inceconsultantsitu WATER SU SY: ATER SUPPLY	AND ENVIRONMENT ITER DEVELOPMENT DISULTANTS LTD INDERS IN WITH INITE LTC INITE LTC INITE LTC INITE INITIALION INITE INITIALION				
CONSULTANT : CONSULTANT : CONSULTANT : ALA-ORA NYAGAK W/ REVISIONS : No DRAWING TITLE Surveyed by: R.K	LIANCE CO IN Associatio IN Associa	AND ENVIRONMENT ITER DEVELOPMENT DISULTANTS LTD INDERS IN WITH INITE LTC INITE LTC INITE LTC INITE INITIALION INITE INITIALION				
DIREC CONSULTANT : ALCON P.O.BOX : Email: alla PROJECT : ALA-ORA NYAGAK W/ REVISIONS : No DRAWING TITLE Surveyed by: R.K Drawn by: Luke	LIANCE CO NSULTING ENC In Associatio ra-Cons 33975 KAMPALA WATER SUPPLY Date E : FLOCC	AND ENVIRONMENT ITER DEVELOPMENT DISULTANTS LTD INDERS IN WITH INITE LTC INITE LTC INITE LTC INITE INITIALION INITE INITIALION				
DIREC CONSULTANT : ALA-CON P.O.BOX : Email: alla PROJECT : ALA-ORA NYAGAK W/ REVISIONS : NO DRAWING TITLE Surveyed by: R.K Drawn by: Luka Designed by: A.B	LIANCE CO NSULTING ENC In Associatio ra-Cons 33975 KAMPALA WATER SU SY: ATER SUPPLY Date E FLOCC	AND ENVIRONMENT ITER DEVELOPMENT DISULTANTS LTD INDERS IN WITH INITE LTC INITE LTC INITE LTC INITE INITIALION INITE INITIALION				
DIREC CONSULTANT : ALCON P.O.BOX : Email: alla PROJECT : ALA-ORA NYAGAK W/ REVISIONS : No DRAWING TITLE Surveyed by: R.K Drawn by: Luka Designed by: A.B Date:	LIANCE CO NSULTING ENC In Associatio ra-Cons 33975 KAMPALA WATER SU SY: ATER SUPPLY Date E FLOCC	AND ENVIRONMENT ITER DEVELOPMENT DISULTANTS LTD INFERS IN WITH INITELTCI INITELICI INITELTCI INITELTCI INITELTCI IN				
CONSULTANT : CONSULTANT : ALA-CON P.O.BOX : Email: alla PROJECT : ALA-ORA NYAGAK W/ REVISIONS : No DRAWING TITLE Surveyed by: R.K Drawn by: Luka Designed by: A.B Checked by: A.B Date:	LIANCE CO IN Associatio IN Associatio IN Associatio IN Associatio IN Associatio IN ASSOCIATION IN ASSOC	AND ENVIRONMENT ITER DEVELOPMENT DISULTANTS LTD INFERS IN WITH INITELTCI INITELICI INITELTCI INITELTCI INITELTCI IN				

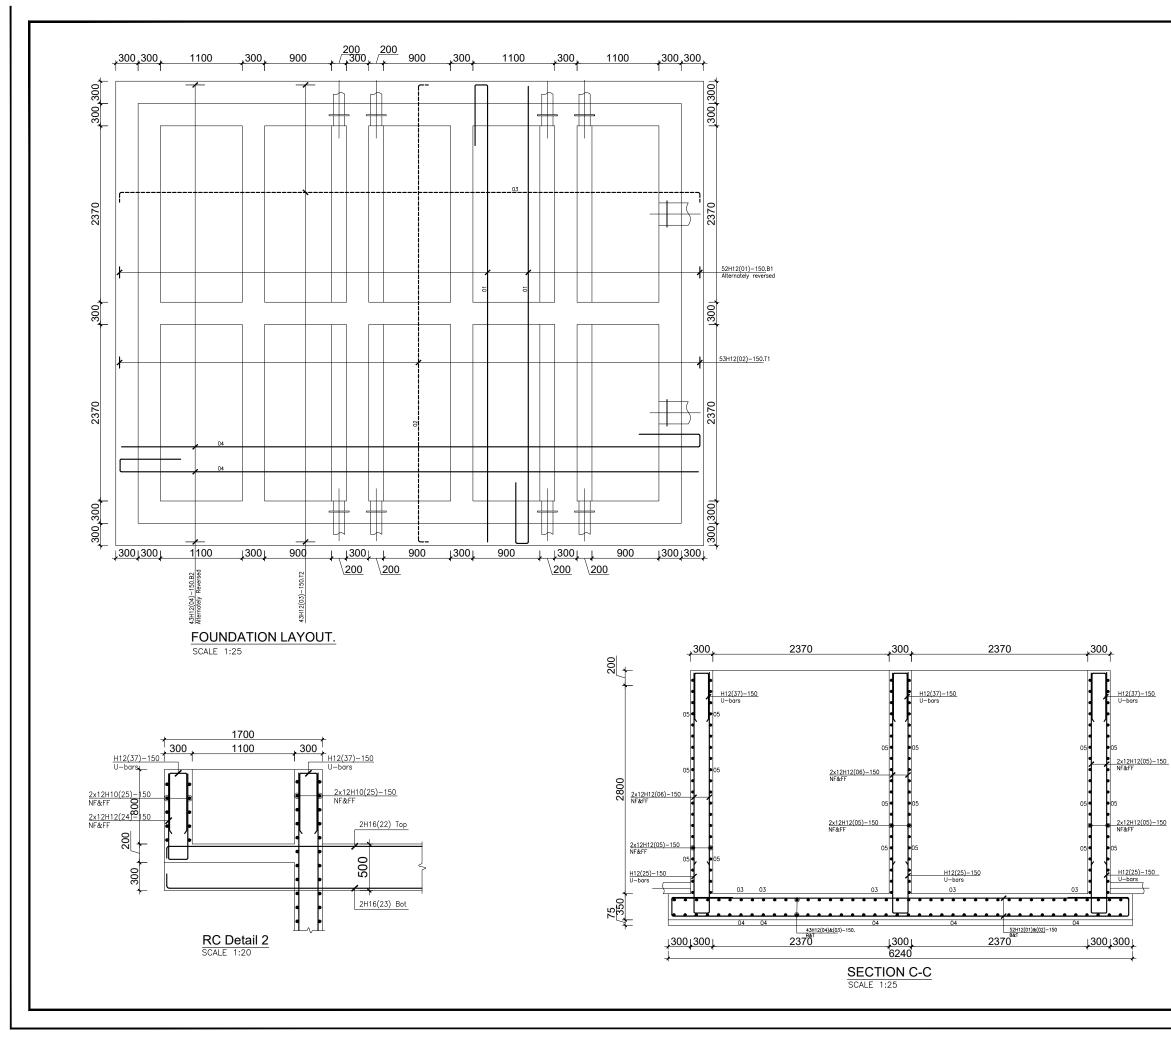


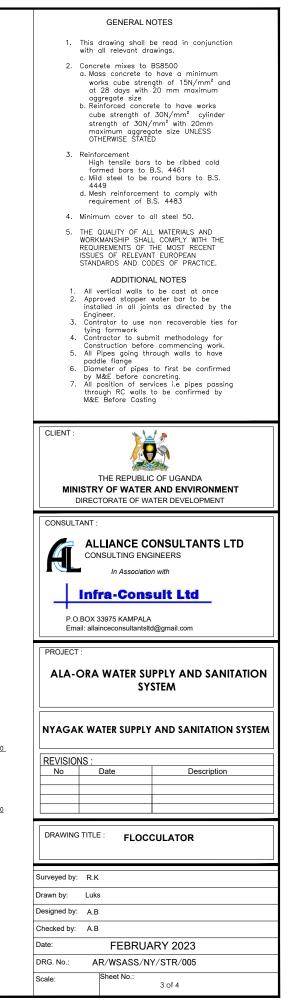

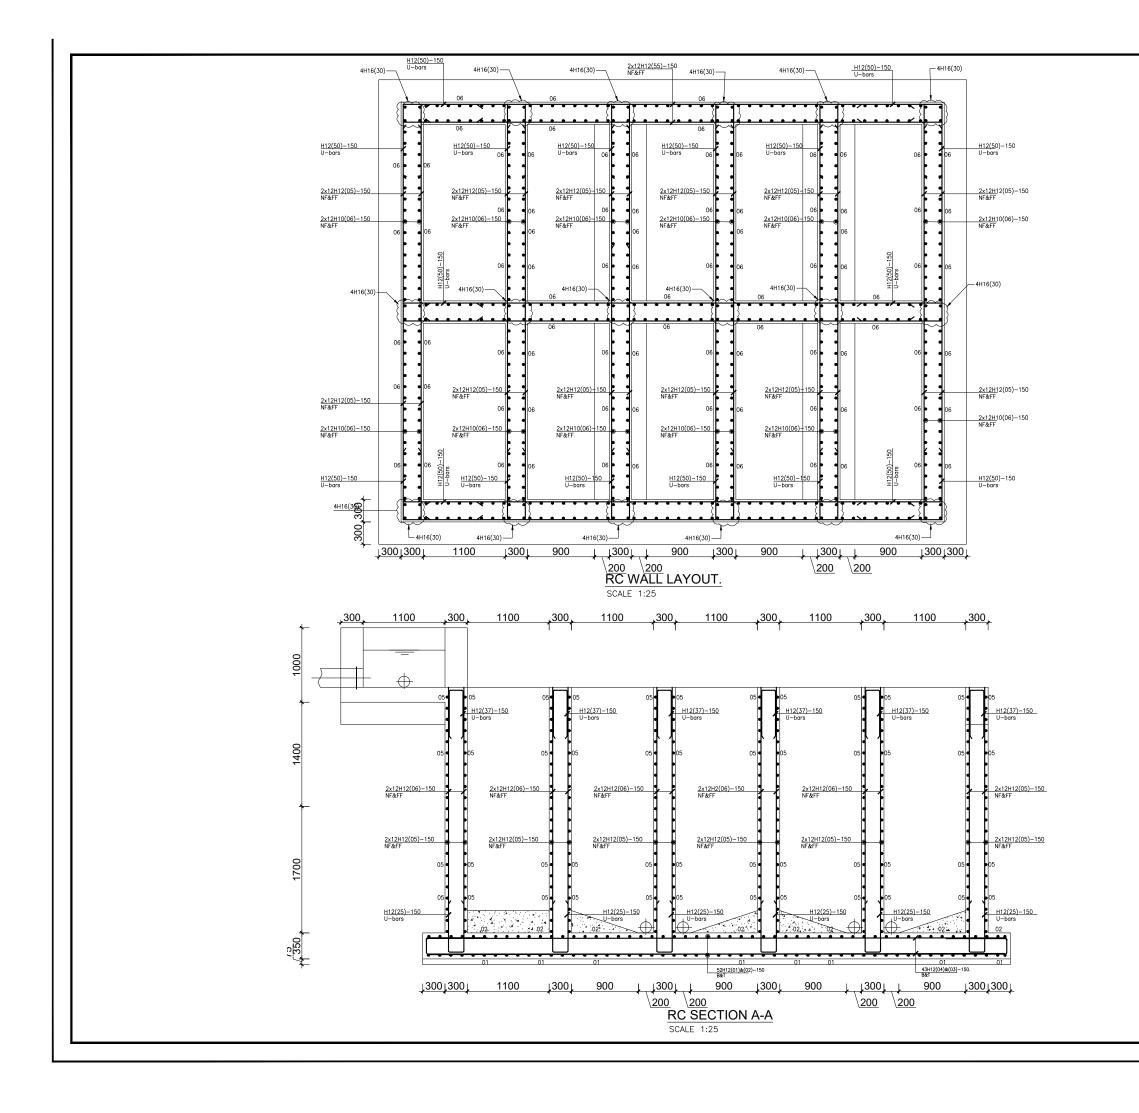


GENERAL NOTES				
	ig shall be read in conjunction evant drawings.			
 with all relevant drawings. 2. Concrete mixes to BS8500 a. Mass concrete to have a minimum works cube strength of 15N/mm² and at 28 days with 20 mm maximum aggregate size b. Reinforced concrete to have works cube strength of 30N/mm² cylinder strength of 30N/mm² with 20mm maximum aggregate size UNLESS OTHERWISE STATED 				
 Reinforcement High tensile bars to be ribbed cold formed bars to B.S. 4461 Mild steel to be round bars to B.S. 4449 Mesh reinforcement to comply with requirement of B.S. 4483 				
 Minimum cover to all steel 50. 				
 THE QUALITY OF ALL MATERIALS AND WORKMANSHIP SHALL COMPLY WITH THE REQUIREMENTS OF THE MOST RECENT ISSUES OF RELEVANT EUROPEAN STANDARDS AND CODES OF PRACTICE. 				
 All vertical walls to be cast at once Approved stopper water bar to be installed in all joints as directed by the Engineer. Contractor to use non recoverable ties for tying formwork Contractor to submit methodology for Construction before commencing work. All Pipes going through walls to have paddle flange Diameter of pipes to first be confirmed by M&E before concreting. All position of services i.e pipes passing through RC walls to be confirmed by M&E Before Casting 				
THE REPUBLIC OF UGANDA MINISTRY OF WATER AND ENVIRONMENT DIRECTORATE OF WATER DEVELOPMENT				
ALLIANCE CONSULTANTS LTD CONSULTING ENGINEERS In Association with				
	ING ENGINEERS			
P.O.BOX 33975	TING ENGINEERS Association with Consult Ltd KAMPALA			
P.O.BOX 33975	ING ENGINEERS Association with Consult Ltd			
PROJECT :	TING ENGINEERS Association with Consult Ltd KAMPALA			
PROJECT : ALA-ORA WA	TING ENGINEERS Association with Consult Ltd KAMPALA nsultantsItd@gmail.com			
PROJECT : ALA-ORA WATER REVISIONS :	TING ENGINEERS Association with Consult Ltd KAMPALA nsultantsltd@gmail.com TER SUPPLY AND SANITATION SYSTEM SUPPLY AND SANITATION SYSTEM			
PROJECT : ALA-ORA WATER	TING ENGINEERS Association with Consult Ltd KAMPALA nsultantsItd@gmail.com TER SUPPLY AND SANITATION SYSTEM			
PROJECT : ALA-ORA WATER REVISIONS :	TING ENGINEERS Association with Consult Ltd KAMPALA nsultantsltd@gmail.com TER SUPPLY AND SANITATION SYSTEM SUPPLY AND SANITATION SYSTEM			
PROJECT : ALA-ORA WATER REVISIONS :	TING ENGINEERS Association with Consult Ltd KAMPALA nsultantsltd@gmail.com TER SUPPLY AND SANITATION SYSTEM SUPPLY AND SANITATION SYSTEM			
CONSULT In P.O.BOX 33975 I Email: allaincecou PROJECT : ALA-ORA WA NYAGAK WATER REVISIONS : NO Date	TING ENGINEERS Association with Consult Ltd KAMPALA nsultantsltd@gmail.com TER SUPPLY AND SANITATION SYSTEM SUPPLY AND SANITATION SYSTEM Description			
CONSULT In P.O.BOX 33975 I Email: allaincecou PROJECT : ALA-ORA WA NYAGAK WATER REVISIONS : NO Date	TING ENGINEERS Association with Consult Ltd KAMPALA nsultantsltd@gmail.com TER SUPPLY AND SANITATION SYSTEM SUPPLY AND SANITATION SYSTEM Description			
CONSULT In CONSULT In CONSULT In CONSULT PROJECT: ALA-ORA WA REVISIONS: NO Date DRAWING TITLE: Surveyed by: R.K	TING ENGINEERS Association with Consult Ltd KAMPALA nsultantsltd@gmail.com TER SUPPLY AND SANITATION SYSTEM SUPPLY AND SANITATION SYSTEM Description			
CONSULT In CONSULT In CONSULT In CONSULT IN CONSULT PROJECT: ALA-ORA WA REVISIONS: NO Date CONSULT C	TING ENGINEERS Association with Consult Ltd KAMPALA nsultantsltd@gmail.com TER SUPPLY AND SANITATION SYSTEM SUPPLY AND SANITATION SYSTEM Description			
CONSULT In P.O.BOX 33975 I Email: allaincecou PROJECT : ALA-ORA WA REVISIONS : NO Date DRAWING TITLE : Surveyed by: R.K Drawn by: Luks Designed by: A.B Checked by: A.B	TING ENGINEERS Association with Consult Ltd KAMPALA nsultantsltd@gmail.com TER SUPPLY AND SANITATION SYSTEM SUPPLY AND SANITATION SYSTEM Description			
REVISIONS : NYAGAK WATER REVISIONS : NO Date Surveyed by: R.K Drawn by: Luks Designed by: A.B Date: FE	ING ENGINEERS Association with Consult Ltd KAMPALA nsultantsltd@gmail.com TER SUPPLY AND SANITATION SYSTEM SUPPLY AND SANITATION SYSTEM Description Description FLOCCULATOR EBRUARY 2023 ASS/NY/STR/005			

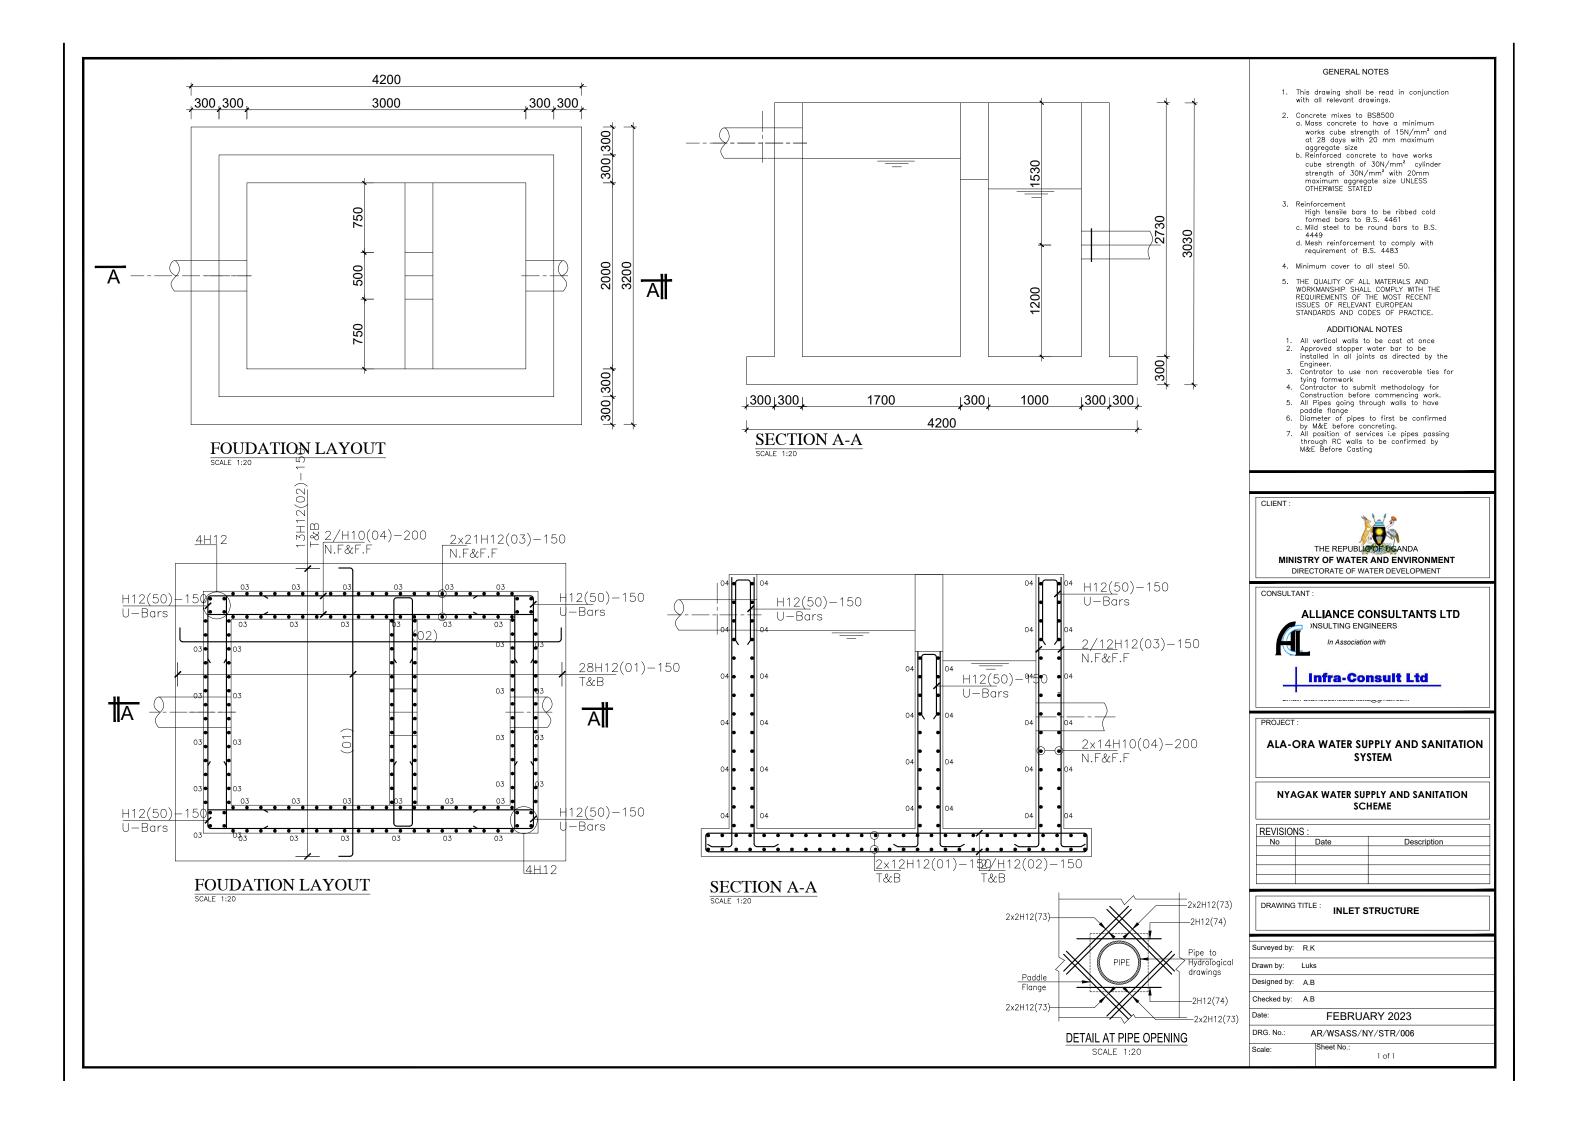

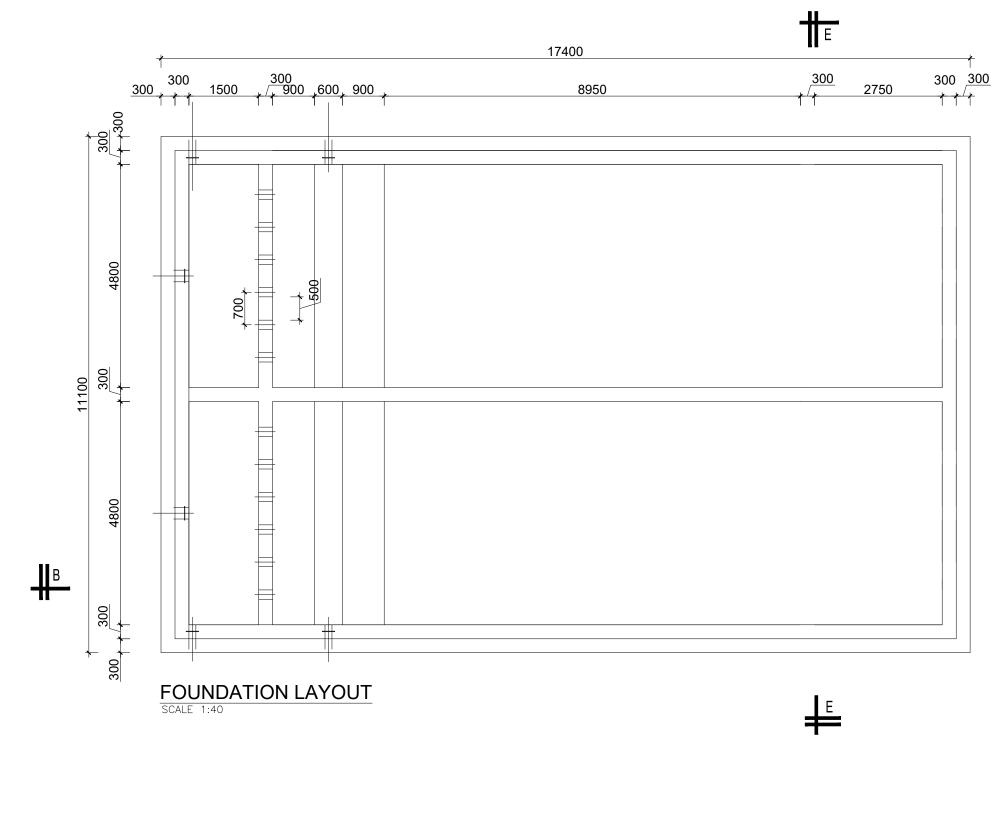



В


GENERAL NOTES				
 This drawing shall be read in conju with all relevant drawings. 	nction			
 Concrete mixes to BS8500 Mass concrete to have a minimum works cube strength of 15N/mm² at 28 days with 20 mm maximum aggregate size Reinforced concrete to have work cube strength of 30N/mm² with 20mm maximum aggregate size UNLESS OTHERWISE STATED 	' and m s ider			
 Reinforcement High tensile bars to be ribbed cc formed bars to B.S. 4461 Mild steel to be round bars to B 4449 Mesh reinforcement to comply wit requirement of B.S. 4483 	.S.			
4. Minimum cover to all steel 50.				
 THE QUALITY OF ALL MATERIALS AND WORKMANSHIP SHALL COMPLY WITH " REQUIREMENTS OF THE MOST RECEN ISSUES OF RELEVANT EUROPEAN STANDARDS AND CODES OF PRACTICE 	Т			
ADDITIONAL NOTES 1. All vertical walls to be cast at on 2. Approved stopper water bar to be installed in all joints as directed b Engineer. 3. Contrator to use non recoverable f tying formwork 4. Contractor to submit methodology Construction before commencing w 5. All Pipes going through walls to h paddle flange	y the ies for for ork. ave			
 Diameter of pipes to first be confiby M&E before concreting. All position of services i.e pipes pithrough RC walls to be confirmed M&E Before Casting 	rmed assing by			
THE REPUBLIC OF UGANDA MINISTRY OF WATER AND ENVIRON DIRECTORATE OF WATER DEVELOPME				
CONSULTANT :				
ALLIANCE CONSULTANT CONSULTING ENGINEERS	S LTD			
In Association with				
- 1				
P.O.BOX 33975 KAMPALA Email: allainceconsultantsltd@gmail.com				
PROJECT : ALA-ORA WATER SUPPLY AND SANITATION SYSTEM				
NYAGAK WATER SUPPLY AND SANITA	TION SYSTEM			
REVISIONS : No Date Descrip	ation			
DRAWING TITLE : SEDIMENTATION TANK				
Surveyed by: R.K				
Drawn by: Luks				
Designed by: A.B				
Checked by: A.B				
Date: FEBRUARY 2023				
DRG. No.: AR/WSASS/NY/STR/007				
Scale: Sheet No.:				

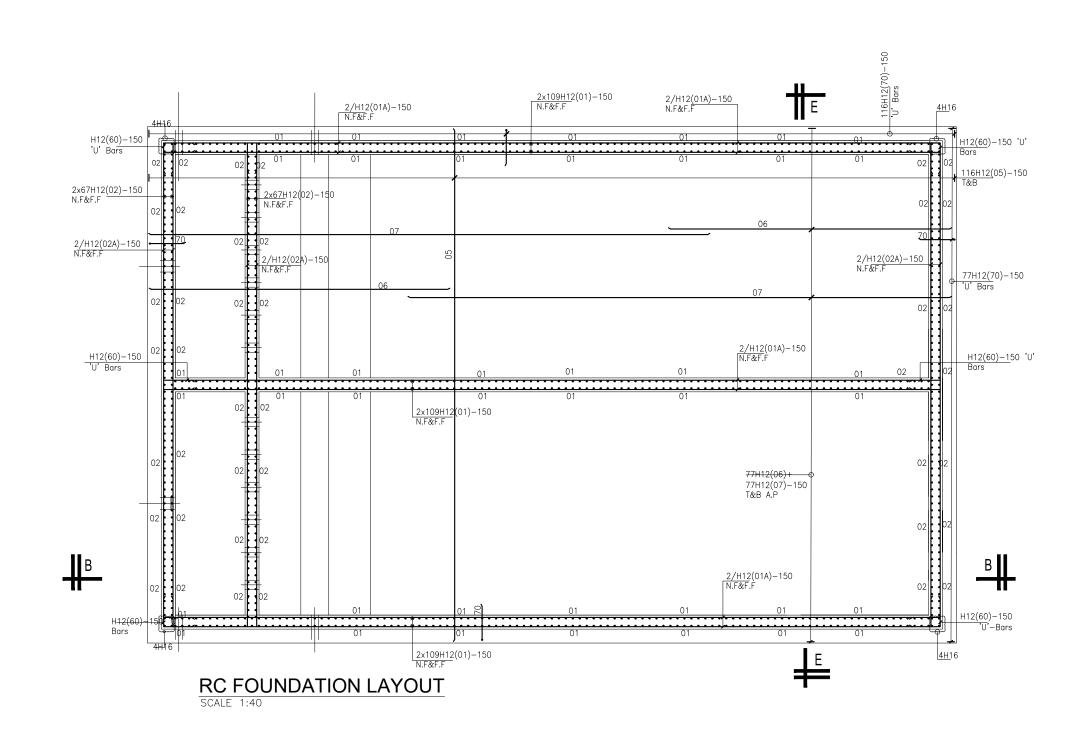



GENE	RAL NOTES
1. This drawing with all releve	shall be read in conjunction ant drawings.
a. Mass conce works cube at 28 days aggregate b. Reinforced cube strem strength of	concrete to have works gth of 30N/mm ² cylinder f 30N/mm ² with 20mm aggregate size UNLESS
3. Reinforcement High tensik formed ba c. Mild steel 4449 d. Mesh reinfo	
	er to all steel 50.
WORKMANSHIF REQUIREMENTS ISSUES OF RE	OF ALL MATERIALS AND > SHALL COMPLY WITH THE S OF THE MOST RECENT ELEVANT EUROPEAN ND CODES OF PRACTICE.
1. All vertical v 2. Approved sta installed in Engineer.	ITIONAL NOTES walls to be cast at once opper water bar to be oll joints as directed by the use non recoverable ties for ork
4. Contractor t Construction 5. All Pipes go paddle flang	o submit methodology for before commencing work. ing through walls to have e
by M&E befo	pipes to first be confirmed ore concreting. of services i.e pipes passing walls to be confirmed by Casting
CLIENT :	
MINISTRY OF W	PUBLIC OF UGANDA ATER AND ENVIRONMENT OF WATER DEVELOPMENT
	CE CONSULTANTS LTD IG ENGINEERS
I	onsult Ltd
P.O.BOX 33975 KA	
PROJECT :	
ALA-ORA WATE	R SUPPLY AND SANITATION
	SYSTEM
	SYSTEM
NYAGAK WATER SU	
REVISIONS :	JPPLY AND SANITATION SYSTEM
REVISIONS : No Date	JPPLY AND SANITATION SYSTEM
REVISIONS : No Date	JPPLY AND SANITATION SYSTEM Description
	JPPLY AND SANITATION SYSTEM Description
REVISIONS : No Date DRAWING TITLE : SEDI Surveyed by: R.K	JPPLY AND SANITATION SYSTEM Description
REVISIONS : No Date Drawing TITLE : Second Surveyed by: R.K Drawn by: Luks	JPPLY AND SANITATION SYSTEM Description
REVISIONS : No Date Drawing Title : SEDI Surveyed by: R.K Drawn by: Luks Designed by: A.B Checked by: A.B	JPPLY AND SANITATION SYSTEM Description
REVISIONS : No Date No Date Drawn by: R.K Drawn by: Luks Designed by: A.B Checked by: A.B Date: FEE	JPPLY AND SANITATION SYSTEM Description IMENTATION TANK

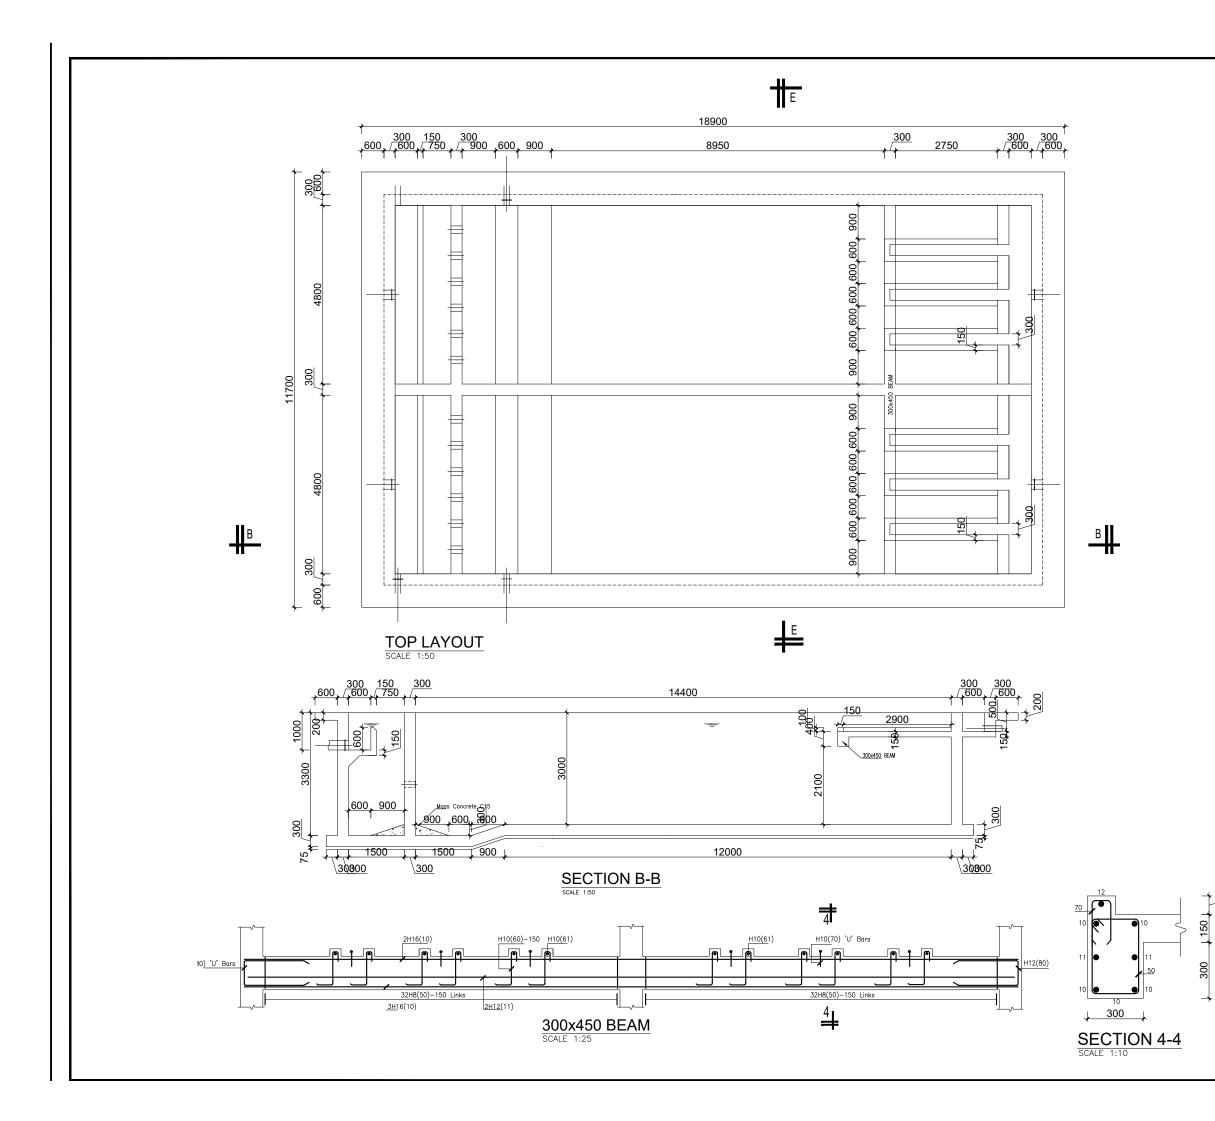

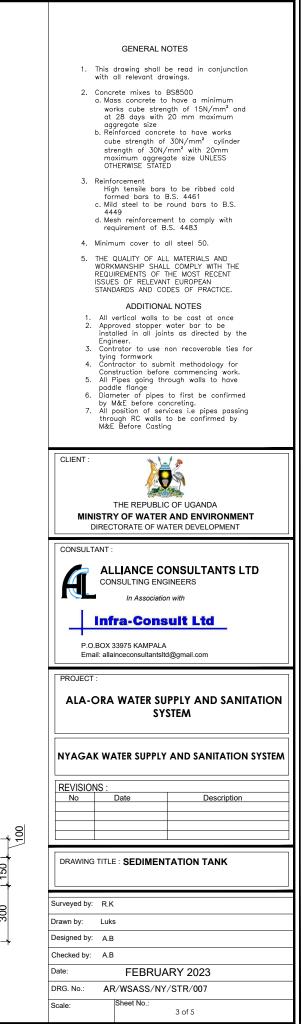


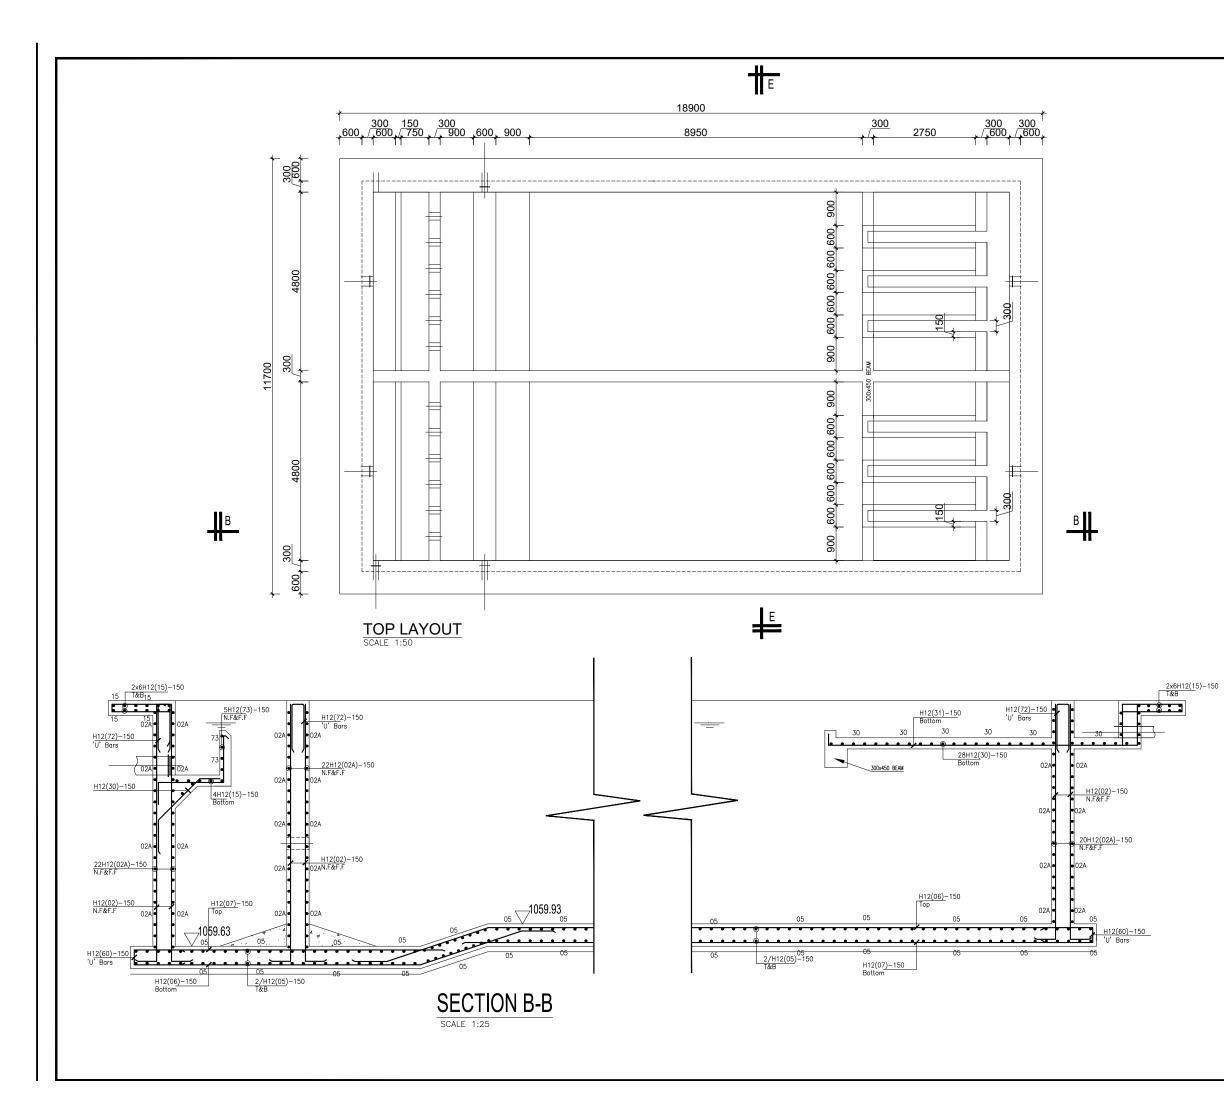

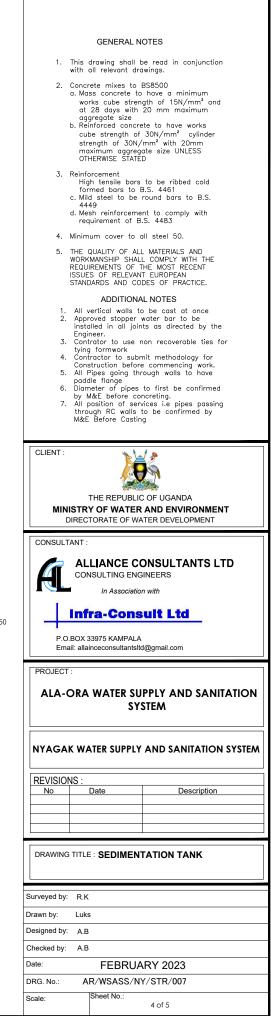


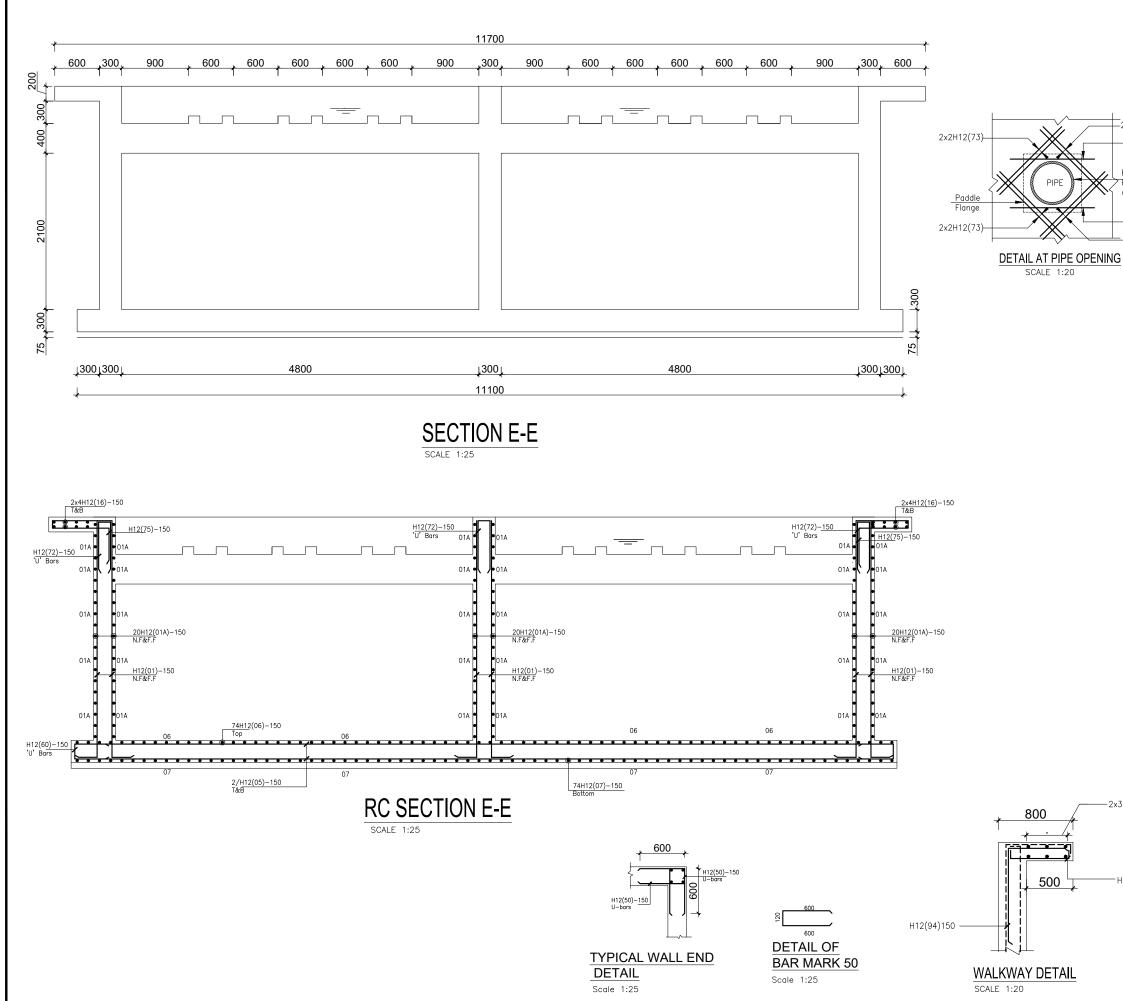


	GENERAL NOTES
	1. This drawing shall be read in conjunction
	with all relevant drawings. 2. Concrete mixes to BS8500 a. Mass concrete to have a minimum works cube strength of 15N/mm ² and at 28 days with 20 mm maximum aggregate size b. Reinforced concrete to have works cube strength of 30N/mm ² with 20mm
()	maximum aggregate size UNLESS OTHERWISE STATED
Pipe to > Hydrological drawings 2H12(74) 2x2H12(73) G	 Reinforcement High tensile bars to be ribbed cold formed bars to B.S. 4461 c. Mild steel to be round bars to B.S. 4449 d. Mesh reinforcement to comply with requirement of B.S. 4483 d. Minimum cover to all steel 50. THE QUALITY OF ALL MATERIALS AND WORKMANSHIP SHALL COMPLY WITH THE REQUIREMENTS OF THE WOST RECENT ISSUES OF RELEVANT EUROPEAN STANDARDS AND CODES OF PRACTICE. ADDITIONAL NOTES ADDI
	 All vertical walls to be cast at once Approved stopper water bar to be installed in all joints as directed by the Engineer. Contrator to use non recoverable ties for tying formwork Contractor to submit methodology for Construction before commencing work. All Pipes going through walls to have paddle flange Diameter of pipes to first be confirmed by M&E before concreting. All position of services i.e pipes passing through RC walls to be confirmed by M&E Before Casting
	CLIENT : THE REPUBLIC OF UGANDA MINISTRY OF WATER AND ENVIRONMENT DIRECTORATE OF WATER DEVELOPMENT
	CONSULTANT :
	ALLIANCE CONSULTANTS LTD CONSULTING ENGINEERS In Association with
	P.O.BOX 33975 KAMPALA Email: allainceconsultantsItd@gmail.com
	PROJECT :
	ALA-ORA WATER SUPPLY AND SANITATION SYSTEM
	NYAGAK WATER SUPPLY AND SANITATION SYSTEM
x3H12(92)150	REVISIONS : No Date Description
	DRAWING TITLE : SEDIMENTATION TANK
H12(93)150	Surveyed by: R.K
	Drawn by: Luks
	Designed by: A.B
	Checked by: A.B
	Date: FEBRUARY 2023
	DRG. No.: AR/WSASS/NY/STR/007 Scale: Sheet No.:
	Scale: 5 of 5

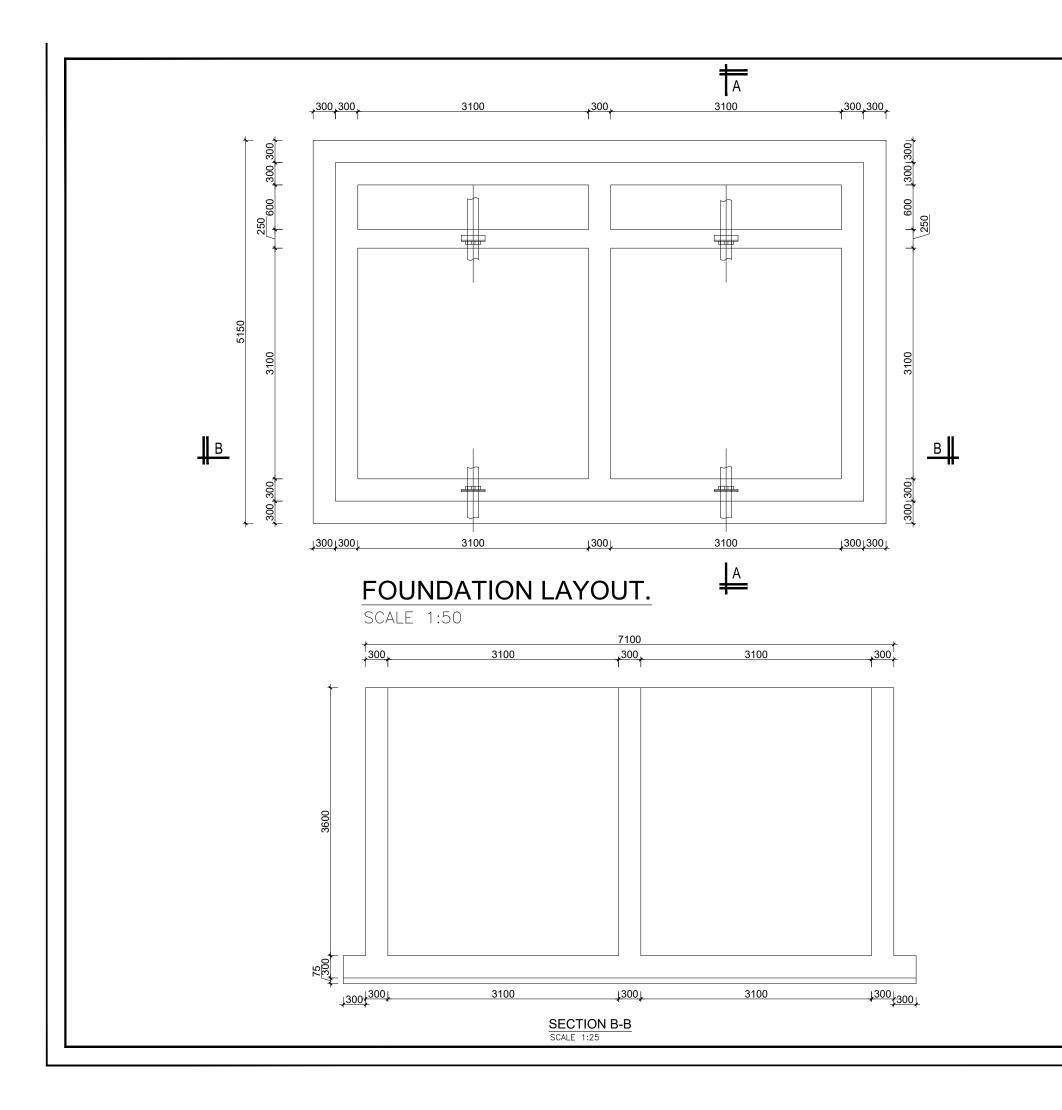


	GENERAL N	OTES
	drawing shall b all relevant dra	pe read in conjunction
	rete mixes to f	-
a. Ma	ss concrete to	have a minimum gth of 15N/mm² and
at	28 days with gregate size	20 mm maximum
b. Re	inforced concre	te to have works
str	be strength of ength of 30N/	mm² with 20mm
ma OT	aximum aggrege HERWISE STATEI	ate size UNLESS D
3. Reinf	orcement	
Hig for	gh tensile bars rmed bars to E	to be ribbed cold 3.S. 4461
c. Mil	d steel to be i 49	round bars to B.S.
d. Me rec	sh reinforceme puirement of B.	nt to comply with .S. 4483
	1um cover to c	
		_ MATERIALS AND
WORK REQU	MANSHIP SHALI	L COMPLY WITH THE THE MOST RECENT
	S OF RELEVAN DARDS AND COI	T EUROPEAN DES OF PRACTICE.
	ADDITIONA	L NOTES
	vertical walls to	be cast at once
inste	alled in all join	water bar to be ts as directed by the
3. Con		ion recoverable ties for
 Con 	g formwork tractor to subn	nit methodology for
5. All I	Pipes going thr	e commencing work. ough walls to have
6 Dian	dle flange neter of pipes	to first be confirmed
7. All	Not before cor position of serv	vices i.e pipes passing to be confirmed by
thro M&E	ugh RC walls t Before Castin	to be confirmed by g
CLIENT :	*	1 🔊
-	TORATE OF WA	
CONSULTANT :		
AL		DNSULTANTS LTD
AL	LIANCE CO	DNSULTANTS LTD
	LIANCE CO NSULTING ENG In Association	DNSULTANTS LTD INEERS n with
	LIANCE CO	DNSULTANTS LTD INEERS n with
	LIANCE CO NSULTING ENG In Association TA-CONS 33975 KAMPALA	DNSULTANTS LTD INEERS In with uit Ltd
P.O.BOX Email: alla	LIANCE CO NSULTING ENG In Association	DNSULTANTS LTD INEERS In with uit Ltd
	LIANCE CO NSULTING ENG In Association TA-CONS 33975 KAMPALA	DNSULTANTS LTD INEERS In with uit Ltd
PROJECT :	LIANCE CO NSULTING ENG In Association ra-Cons 33975 KAMPALA inceconsultantsltc	DNSULTANTS LTD INEERS In with UIT LTD I@gmail.com PPLY AND SANITATION
PROJECT :	LIANCE CO NSULTING ENG In Association ra-Cons 33975 KAMPALA inceconsultantsltc	DNSULTANTS LTD INEERS In with ult Ltd I@gmail.com
PROJECT :	LIANCE CO NSULTING ENG In Association ra-Cons 33975 KAMPALA inceconsultantsltc	DNSULTANTS LTD INEERS In with UIT LTD I@gmail.com PPLY AND SANITATION
PROJECT : ALA-ORA	LIANCE CO NSULTING ENG In Association ra-Cons 33975 KAMPALA 33975 KAMPALA 33975 KAMPALA WATER SU SYS	DNSULTANTS LTD INEERS In with UIT LTD I@gmail.com PPLY AND SANITATION
PROJECT : ALA-ORA	LIANCE CO NSULTING ENG In Association ra-Cons 33975 KAMPALA 33975 KAMPALA 33975 KAMPALA WATER SU SYS	DNSULTANTS LTD INEERS In with UIT Ltd I@gmail.com PPLY AND SANITATION STEM
PROJECT : ALA-ORA	LIANCE CO NSULTING ENG In Association TRA-CONS 33975 KAMPALA inceconsultantsite WATER SUPS ATER SUPPLY	DNSULTANTS LTD INEERS In with UIT Ltd I@gmail.com PPLY AND SANITATION STEM
ALCOL PROJECT : ALA-ORA NYAGAK W/ REVISIONS :	LIANCE CO NSULTING ENG In Association TRA-CONS 33975 KAMPALA inceconsultantsite WATER SUPS ATER SUPPLY	DNSULTANTS LTD INEERS In with UIT Ltd I@gmail.com SPPLY AND SANITATION STEM
REVISIONS :	LIANCE CO NSULTING ENG In Association TRA-CONS 33975 KAMPALA inceconsultantsite WATER SUPS ATER SUPPLY	DNSULTANTS LTD INEERS In with UIT Ltd I@gmail.com SPPLY AND SANITATION STEM
PROJECT: ALCORA PROJECT: ALA-ORA NYAGAK W/ REVISIONS: No	LIANCE CC NSULTING ENG In Association TRA-CONS 33975 KAMPALA inceconsultantsitc SYS ATER SUPPLY Date	DNSULTANTS LTD INEERS In with UIT Ltd I@gmail.com SPPLY AND SANITATION STEM
REVISIONS :	LIANCE CC NSULTING ENG In Association TRA-CONS 33975 KAMPALA inceconsultantsitc SYS ATER SUPPLY Date	DNSULTANTS LTD INEERS In with UIT Ltd I@gmail.com SPPLY AND SANITATION STEM
PROJECT: ALCORA PROJECT: ALA-ORA NYAGAK W/ REVISIONS: No	LIANCE CC NSULTING ENG In Association TRA-CONS 33975 KAMPALA inceconsultantsitc SYS ATER SUPPLY Date	DNSULTANTS LTD INEERS In with UIT Ltd I@gmail.com SPPLY AND SANITATION STEM
ALCOL P.O.BOX : Email: alla PROJECT : ALA-ORA NYAGAK W/ REVISIONS : No	ATER SUPPLY	DNSULTANTS LTD INEERS In with UIT Ltd I@gmail.com SPPLY AND SANITATION STEM
ALCOLOR POBOX Email: alla PROJECT : ALA-ORA NYAGAK W/ REVISIONS : No DRAWING TITLE	ATER SUPPLY	DNSULTANTS LTD INEERS In with UIT Ltd I@gmail.com SPPLY AND SANITATION STEM
ALCOL PROJECT : ALA-ORA NYAGAK W/ REVISIONS : No DRAWING TITLI Surveyed by: R.K Drawn by: Luk	LIANCE CC NSULTING ENG In Association TRA-CONS 33975 KAMPALA inceconsultantsite STATER SUPPLY Date E: FILTER S	DNSULTANTS LTD INEERS In with UIT Ltd I@gmail.com SPPLY AND SANITATION STEM
ALCOLORING TITLE	LIANCE CC NSULTING ENG In Association TRA-CONS 33975 KAMPALA inceconsultantsitc SYS ATER SUPPLY Date E: FILTER S S	DNSULTANTS LTD INEERS In with UIT Ltd I@gmail.com SPPLY AND SANITATION STEM
ALCOR P.O.BOX: P.O.BOX: Email: alla PROJECT : ALA-ORA NYAGAK W/ REVISIONS : No DRAWING TITLI Surveyed by: R.K Drawn by: Luk Designed by: A.E	ALIANCE CC NSULTING ENG In Association TRA-CONS 333975 KAMPALA inceconsultantsite WATER SUPPLY Date Date E FILTER S 3	DNSULTANTS LTD INEERS In with UIT Ltd I@gmail.com SPPLY AND SANITATION STEM
AL P.O.BOX: PROJECT: ALA-ORA NYAGAK REVISIONS: No DRAWING TITLI Surveyed by: R.K. Drawn by: Luk Designed by: A.E. Date: Date:	ALIANCE CC NSULTING ENG In Association TRA-CONS 333975 KAMPALA inceconsultantsite WATER SUPPLY Date Date E FILTER S 3	DISULTANTS LTD INEERS In with UIT LTD I@gmail.com PPLY AND SANITATION STEM Description Description
AL P.O.BOX: PROJECT: ALA-ORA NYAGAK REVISIONS: No DRAWING TITLI Surveyed by: R.K. Drawn by: Luk Designed by: A.E. Date: Date:	LIANCE CC NSULTING ENG In Association ra-Cons 333975 KAMPALA inceconsultantsite WATER SU ATER SUPPLY Date E: FILTER 5 5 5 5 5 5 5 5 5 5 5 5 5	DISULTANTS LTD INEERS In with UIT LTD I@gmail.com PPLY AND SANITATION STEM Description Description

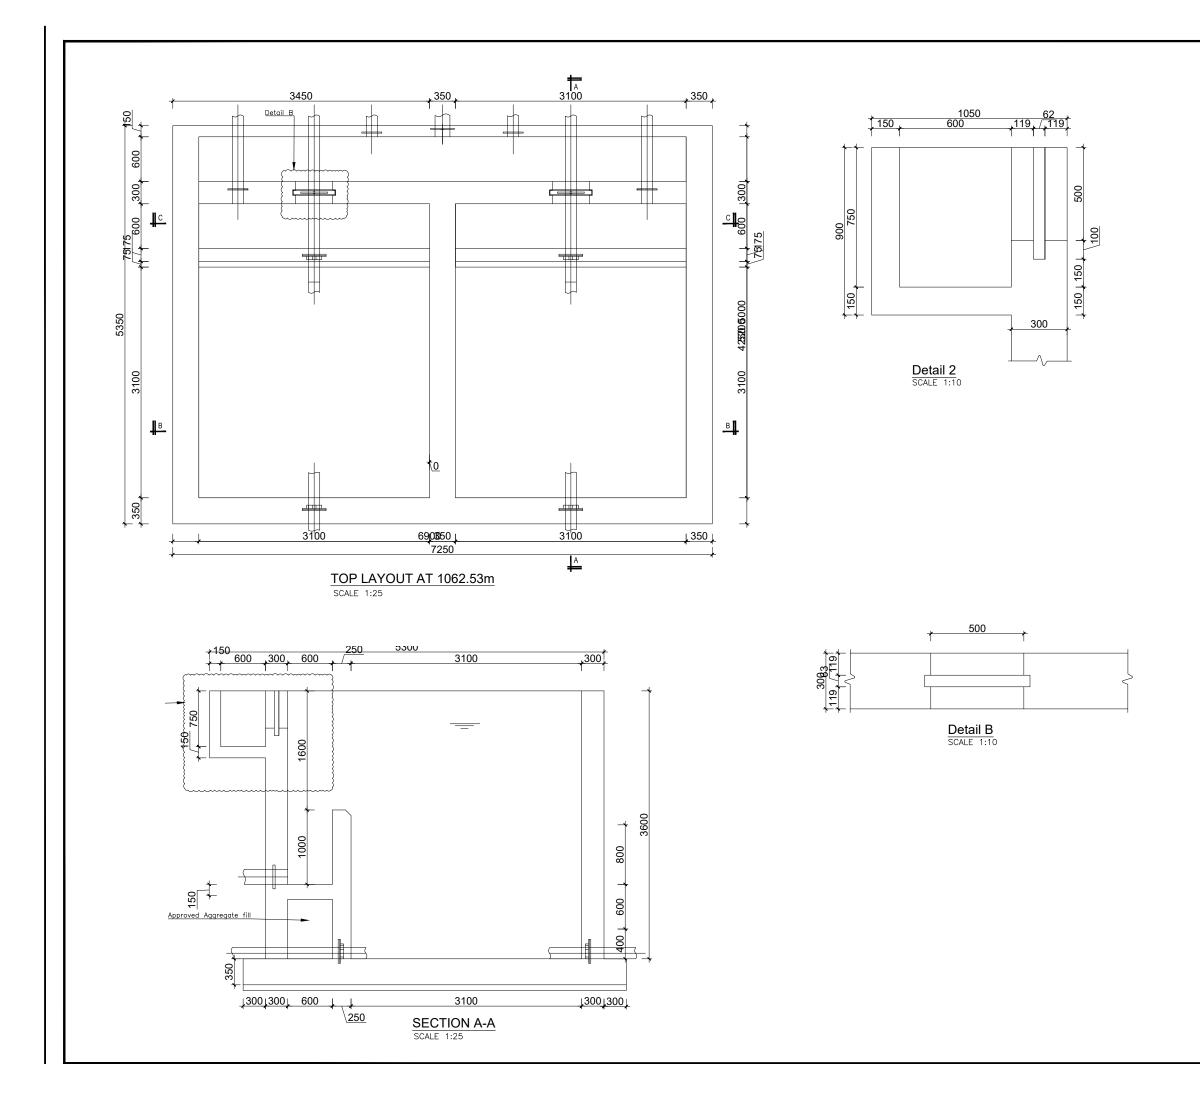


GENER	RAL NOTES
1. This drawing s with all releva	shall be read in conjunction Int drawings.
works cube at 28 days aggregate s b. Reinforced cube streng strength of	ete to have a minimum strength of 15N/mm ² and with 20 mm maximum size concrete to have works gth of 30N/mm ² cylinder 30N/mm ² with 20mm aggregate size UNLESS
3. Reinforcement High tensile formed bar c. Mild steel t 4449 d. Mesh reinfo	
	r to all steel 50.
WORKMANSHIP REQUIREMENTS ISSUES OF RE	OF ALL MATERIALS AND SHALL COMPLY WITH THE S OF THE MOST RECENT LEVANT EUROPEAN ND CODES OF PRACTICE.
 All vertical w 2. Approved sto installed in c Engineer. 	TIONAL NOTES valls to be cast at once pper water bar to be all joints as directed by the use non recoverable ties for vrk
4. Contractor to	b submit methodology for before commencing work. ng through walls to have
paddle flanae	pipes to first be confirmed pre concreting.
by M&L beta 7. All position o through RC M&E Before	of services i.e pipes passing walls to be confirmed by
CLIENT :	*
THE REF	PUBLIC OF UGANDA
	ATER AND ENVIRONMENT OF WATER DEVELOPMENT
CONSULTANT :	
CONSULTING	E CONSULTANTS LTD G ENGINEERS
	onsult Ltd
Infra-Co	
	MPALA
P.O.BOX 33975 KAN Email: allainceconsu	MPALA
P.O.BOX 33975 KAN Email: allainceconsu PROJECT : ALA-ORA WATE	IIPALA ItantsItd@gmail.com
P.O.BOX 33975 KAN Email: allainceconsu PROJECT : ALA-ORA WATE	IIPALA ItantsItd@gmail.com
P.O.BOX 33975 KAN Email: atlainceconsu PROJECT : ALA-ORA WATE NYAGAK WATER SU REVISIONS :	VIPALA Itantsitd@gmail.com
P.O.BOX 33975 KAN Email: atlainceconsu PROJECT : ALA-ORA WATE NYAGAK WATER SU REVISIONS :	IR SUPPLY AND SANITATION SYSTEM
P.O.BOX 33975 KAN Email: allainceconsu PROJECT : ALA-ORA WATE NYAGAK WATER SU REVISIONS : No Date	IR SUPPLY AND SANITATION SYSTEM
P.O.BOX 33975 KAN Email: allainceconsu PROJECT : ALA-ORA WATE NYAGAK WATER SU REVISIONS : No Date DRAWING TITLE : FILT	IR SUPPLY AND SANITATION SYSTEM
P.O.BOX 33975 KAN Email: allainceconsu PROJECT : ALA-ORA WATE NYAGAK WATER SU REVISIONS : No Date DRAWING TITLE : FILT Surveyed by: R.K	IR SUPPLY AND SANITATION SYSTEM
P.O.BOX 33975 KAN Email: allainceconsu PROJECT : ALA-ORA WATE NYAGAK WATER SU REVISIONS : No Date DRAWING TITLE : FILT Surveyed by: R.K Drawn by: Luks Designed by: A.B Checked by: A.B	IPPLA ItantsItd@gmail.com
P.O.BOX 33975 KAN Email: allainceconsu PROJECT : ALA-ORA WATE NYAGAK WATER SU REVISIONS : No Date DRAWING TITLE : FILT Surveyed by: R.K Drawn by: Luks Designed by: A.B Checked by: A.B Date: FEB	IR SUPPLY AND SANITATION SYSTEM

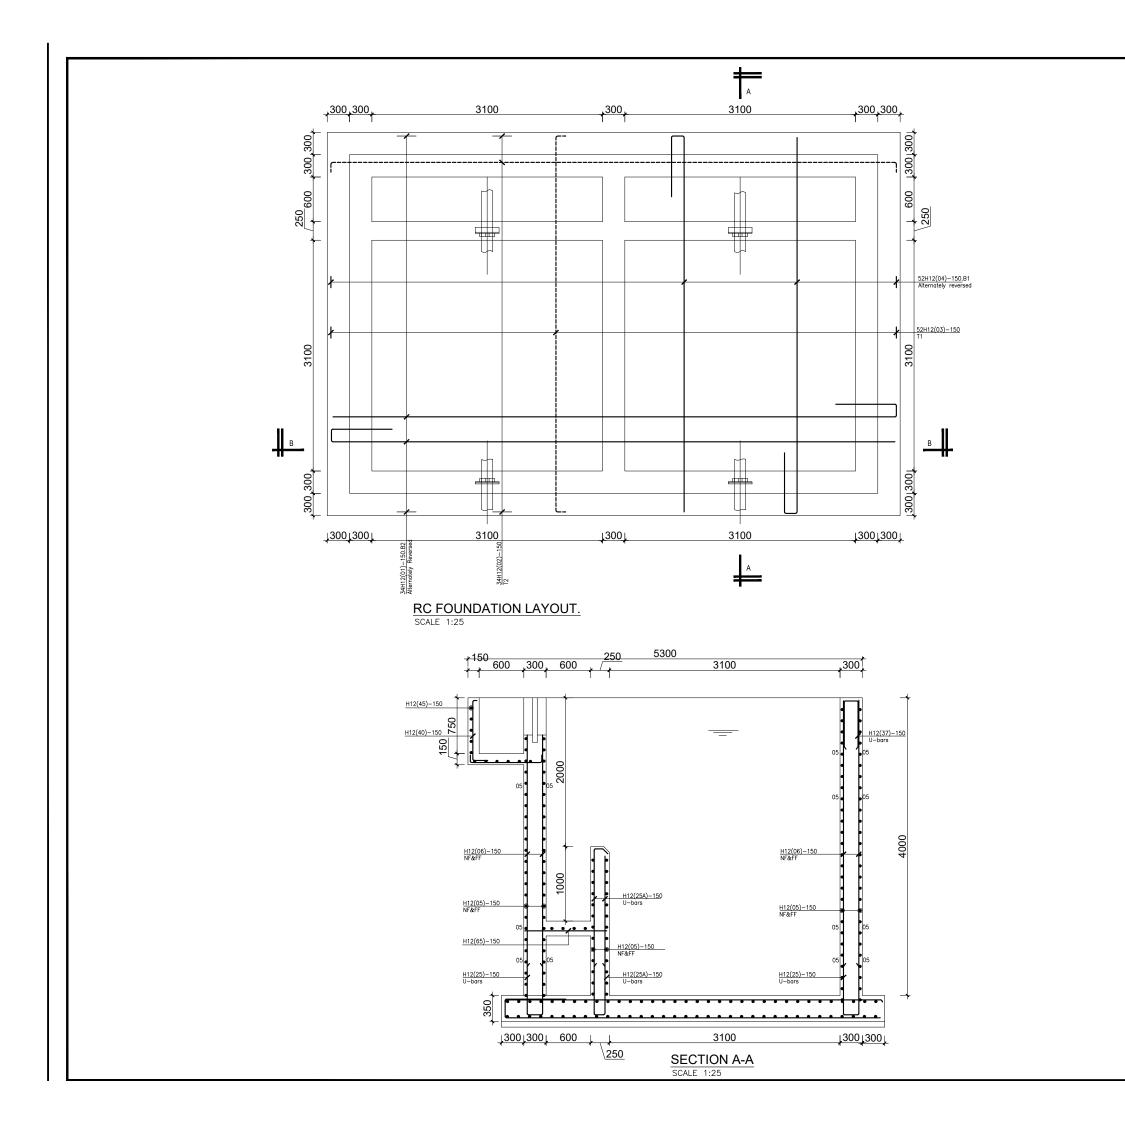


GENERAL NOTES
 This drawing shall be read in conjunction with all relevant drawings.
 Concrete mixes to BS8500 Mass concrete to have a minimum works cube strength of 15N/mm² and at 28 days with 20 mm maximum aggregate size Reinforced concrete to have works cube strength of 30N/mm² with 20mm maximum aggregate size UNLESS OTHERWISE STATED
 Reinforcement High tensile bars to be ribbed cold formed bars to B.S. 4461 c. Mild steel to be round bars to B.S. 4449 d. Mesh reinforcement to comply with requirement of B.S. 4483
4. Minimum cover to all steel 50.
 THE QUALITY OF ALL MATERIALS AND WORKMANSHIP SHALL COMPLY WITH THE REQUIREMENTS OF THE MOST RECENT ISSUES OF RELEVANT EUROPEAN STANDARDS AND CODES OF PRACTICE.
ADDITIONAL NOTES 1. All vertical walls to be cast at once 2. Approved stopper water bar to be installed in all joints as directed by the Engineer. 3. Contrator to use non recoverable ties for tying formwork
 Gentractor to submit methodology for Construction before commencing work. All Pipes going through walls to have paddle flange Diameter of pipes to first be confirmed by M&E before concreting. All position of services i.e pipes passing through RC walls to be confirmed by
through RC walls to be confirmed by M&E Before Casting
THE REPUBLIC OF UGANDA MINISTRY OF WATER AND ENVIRONMENT DIRECTORATE OF WATER DEVELOPMENT
CONSULTANT : ALLIANCE CONSULTANTS LTD CONSULTING ENGINEERS In Association with
Infra-Consult Ltd
P.O.BOX 33975 KAMPALA Email: allainceconsultantsItd@gmail.com
PROJECT : ALA-ORA WATER SUPPLY AND SANITATION SYSTEM
NYAGAK WATER SUPPLY AND SANITATION SYSTEM
REVISIONS : No Date Description
No Date Description Image: Description Image: Description Image: Description Image: Description Image: Descrint Image:
No Date Description Image: Description Image: Description <
No Date Description Image: Description Image: Description Image: Description Image: Description Image: Descrint Image:
No Date Description Image: Constraint of the second secon
No Date Description Image: Constraint of the second secon
No Date Description Image: Description Image: Description <

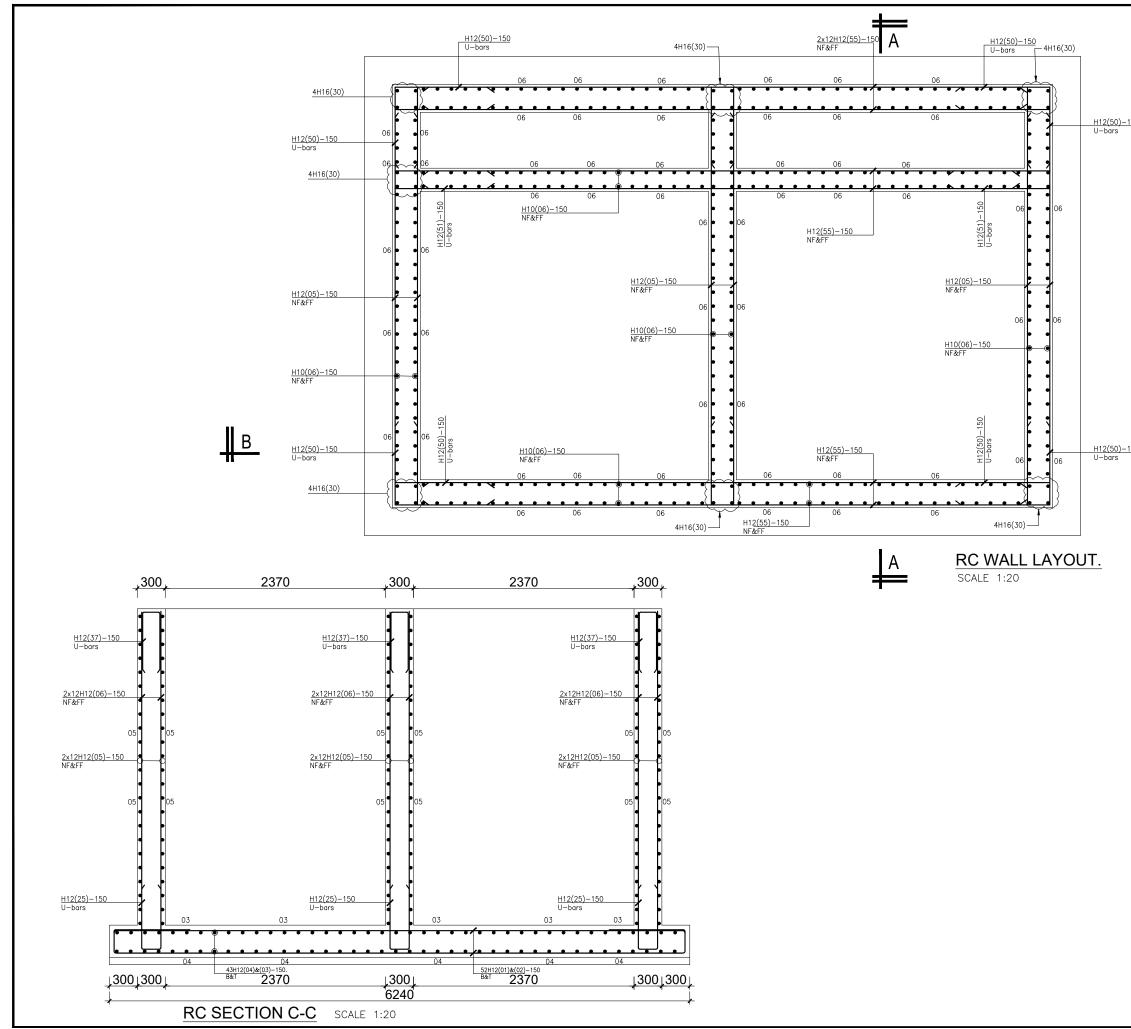



	GENERAL NOTES
	 This drawing shall be read in conjunction with all relevant drawings.
<u>150</u>	 Concrete mixes to BS8500 Mass concrete to have a minimum works cube strength of 15N/mm² and at 28 days with 20 mm maximum aggregate size Reinforced concrete to have works cube strength of 30N/mm² cylinder strength of 30N/mm² with 20mm maximum aggregate size UNLESS OTHERWISE STATED
	 Reinforcement High tensile bars to be ribbed cold formed bars to B.S. 4461 c. Mild steel to be round bars to B.S. 4449 d. Mesh reinforcement to comply with requirement of B.S. 4483
	4. Minimum cover to all steel 50.
	5. THE QUALITY OF ALL MATERIALS AND WORKMANSHIP SHALL COMPLY WITH THE REQUIREMENTS OF THE MOST RECENT ISSUES OF RELEVANT EUROPEAN STANDARDS AND CODES OF PRACTICE.
	ADDITIONAL NOTES 1. All vertical walls to be cast at once 2. Approved stopper water bar to be installed in all joints as directed by the Engineer. 3. Contrator to use non recoverable ties for
	 tying formwork 4. Contractor to submit methodology for Construction before commencing work. 5. All Pipes going through walls to have paddle flange 6. Diameter of pipes to first be confirmed by M&E before concreting. 7. All position of services i.e pipes passing
	through RC walls to be confirmed by M&E Before Casting
150	CLIENT:
	THE REPUBLIC OF UGANDA MINISTRY OF WATER AND ENVIRONMENT DIRECTORATE OF WATER DEVELOPMENT
	CONSULTANT :
	ALLIANCE CONSULTANTS LTD CONSULTING ENGINEERS
	Infra-Consult Ltd
	P.O.BOX 33975 KAMPALA Email: allainceconsultantsttd@gmail.com
	Email: allainceconsultantsItd@gmail.com PROJECT : ALA-ORA WATER SUPPLY AND SANITATION
	Email: allainceconsultantsItd@gmail.com PROJECT :
	Email: allainceconsultantsItd@gmail.com PROJECT : ALA-ORA WATER SUPPLY AND SANITATION
	Email: allainceconsultantsItd@gmail.com PROJECT : ALA-ORA WATER SUPPLY AND SANITATION SYSTEM
	Email: allainceconsultantsItd@gmail.com PROJECT : ALA-ORA WATER SUPPLY AND SANITATION SYSTEM NYAGAK WATER SUPPLY AND SANITATION SYSTEM REVISIONS :
	Email: allainceconsultantsItd@gmail.com PROJECT : ALA-ORA WATER SUPPLY AND SANITATION SYSTEM NYAGAK WATER SUPPLY AND SANITATION SYSTEM REVISIONS :
	Email: allainceconsultantsItd@gmail.com PROJECT : ALA-ORA WATER SUPPLY AND SANITATION SYSTEM NYAGAK WATER SUPPLY AND SANITATION SYSTEM REVISIONS : No Date Description
	Email: allainceconsultantsitd@gmail.com PROJECT : ALA-ORA WATER SUPPLY AND SANITATION SYSTEM NYAGAK WATER SUPPLY AND SANITATION SYSTEM REVISIONS : No Date Description Image: Description <
	Email: allainceconsultantsitd@gmail.com PROJECT : ALA-ORA WATER SUPPLY AND SANITATION SYSTEM NYAGAK WATER SUPPLY AND SANITATION SYSTEM REVISIONS : No Date Description Image: Description <
	Email: allainceconsultantsitd@gmail.com PROJECT : ALA-ORA WATER SUPPLY AND SANITATION SYSTEM NYAGAK WATER SUPPLY AND SANITATION SYSTEM REVISIONS : No Date Description Image: Description <
	Email: allainceconsultantsitd@gmail.com PROJECT : ALA-ORA WATER SUPPLY AND SANITATION SYSTEM NYAGAK WATER SUPPLY AND SANITATION SYSTEM REVISIONS : No Date Date Description Date Description DRAWING TITLE : FILTER Surveyed by: R.K Drawn by: Luks Designed by: A.B

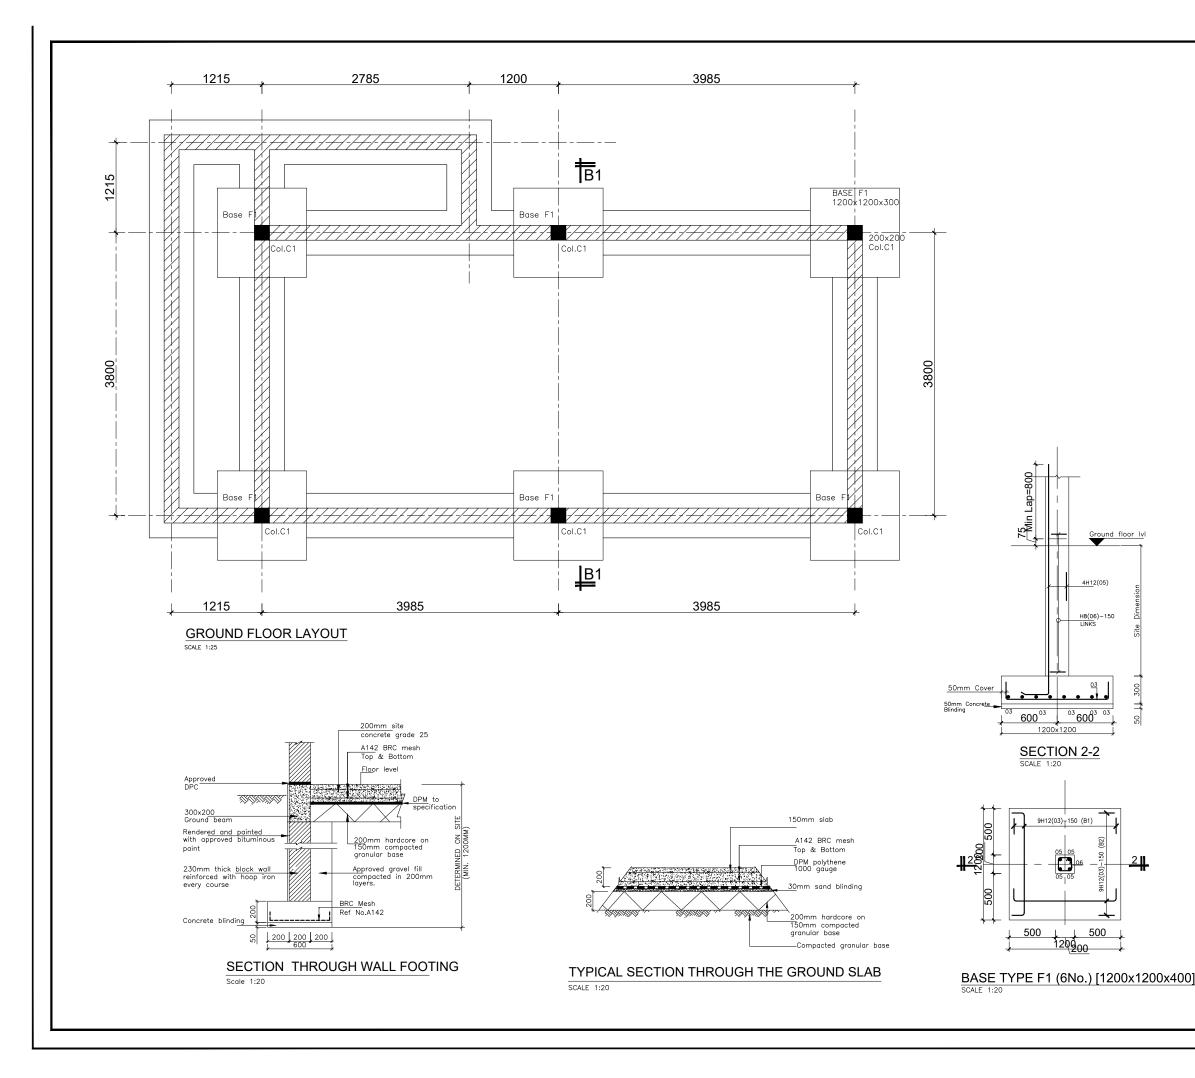





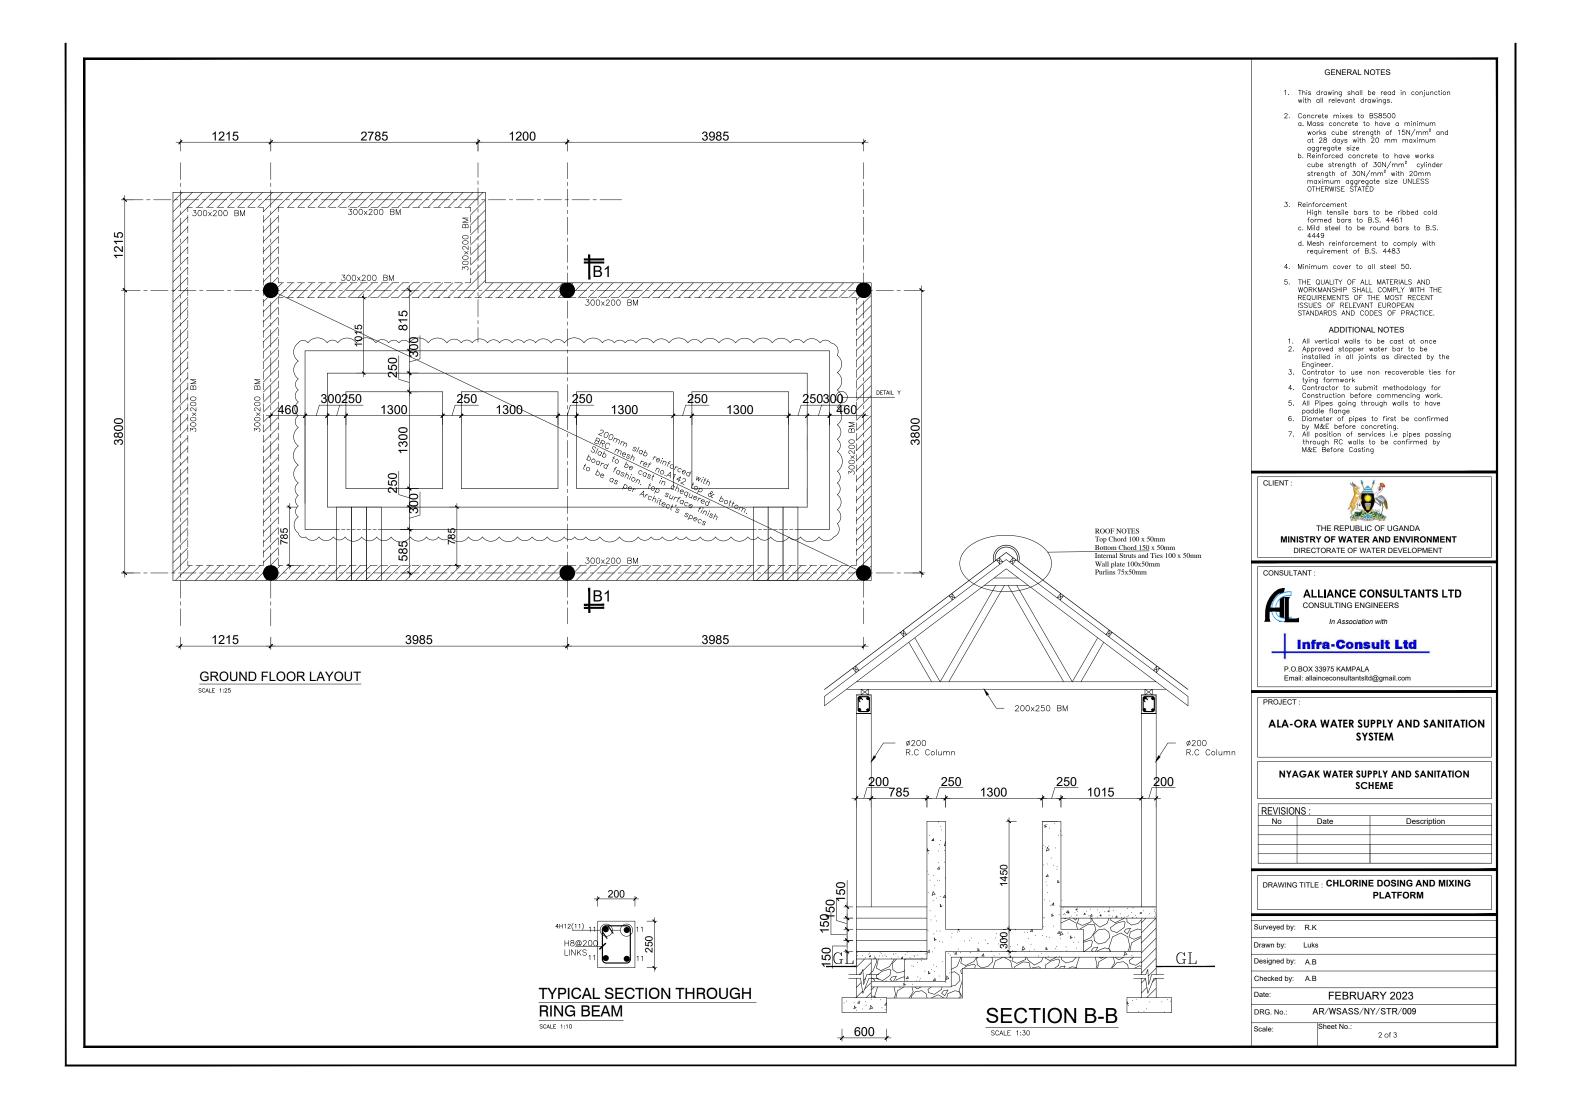


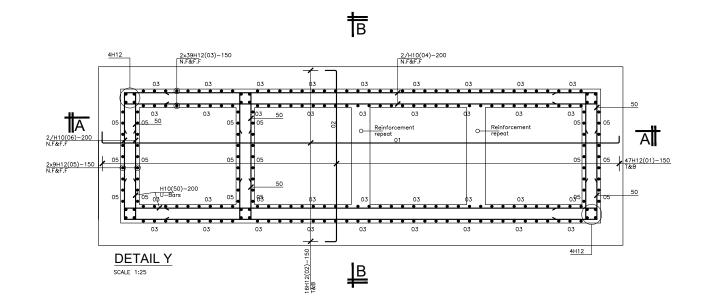


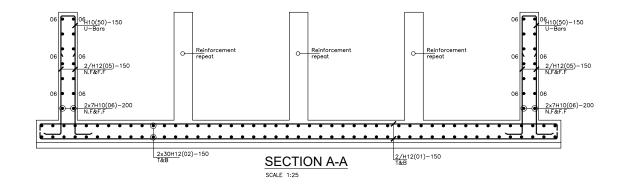


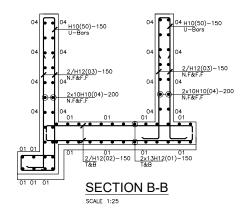


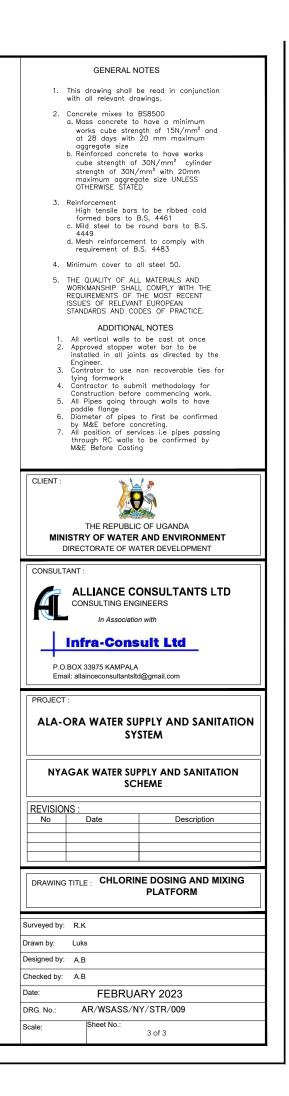

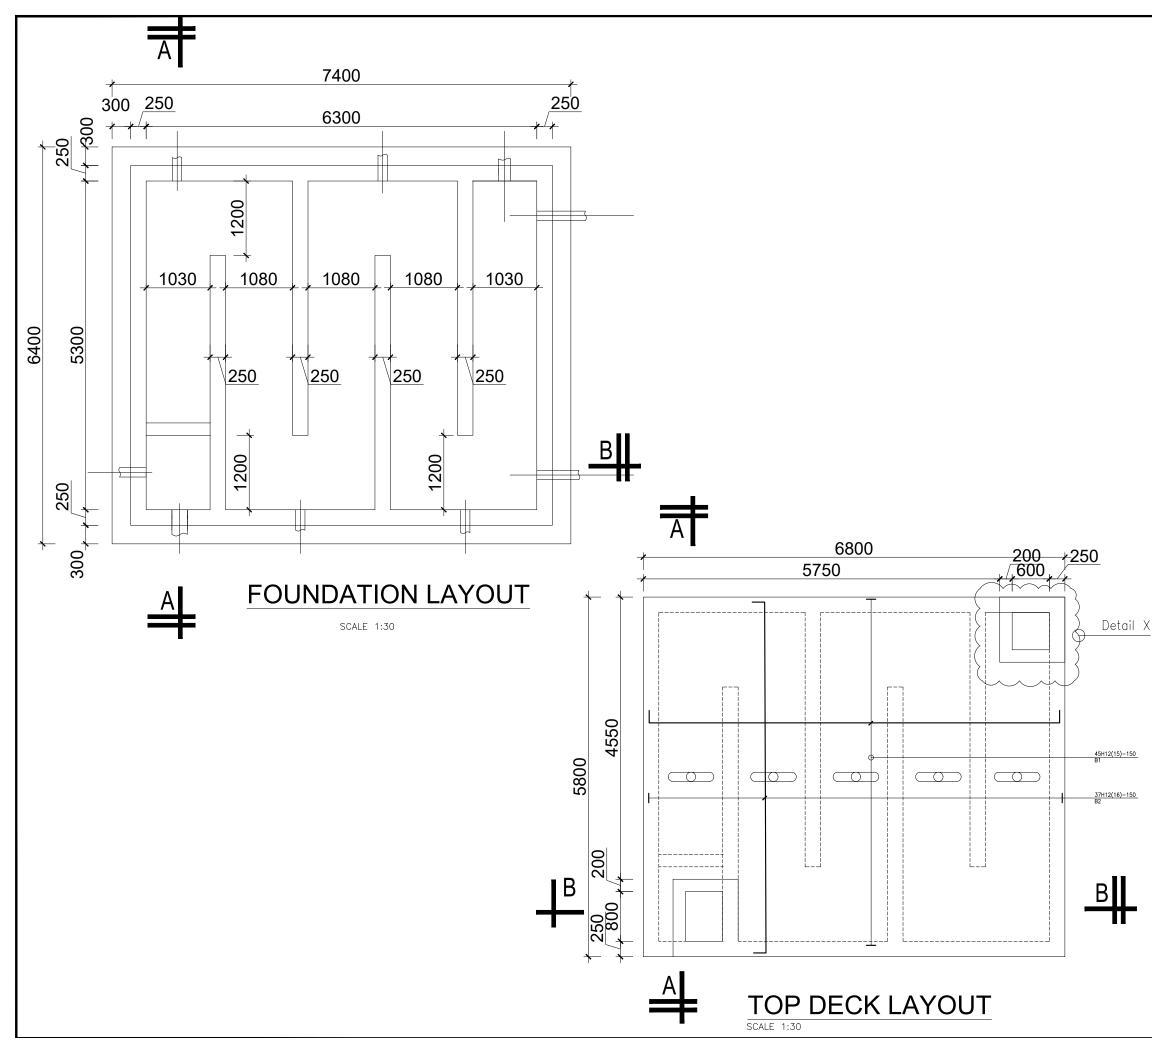


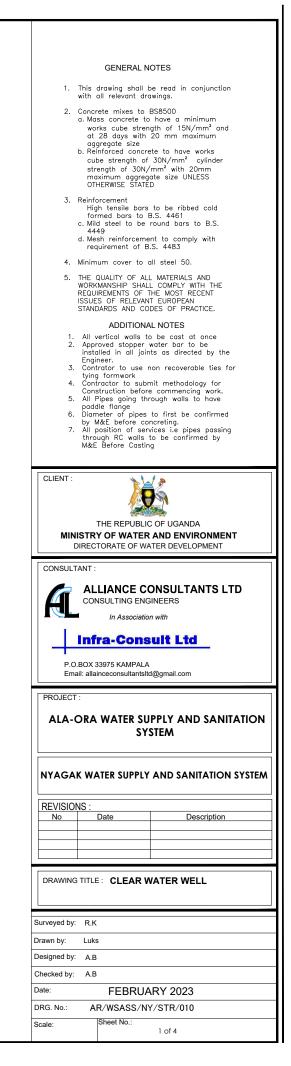

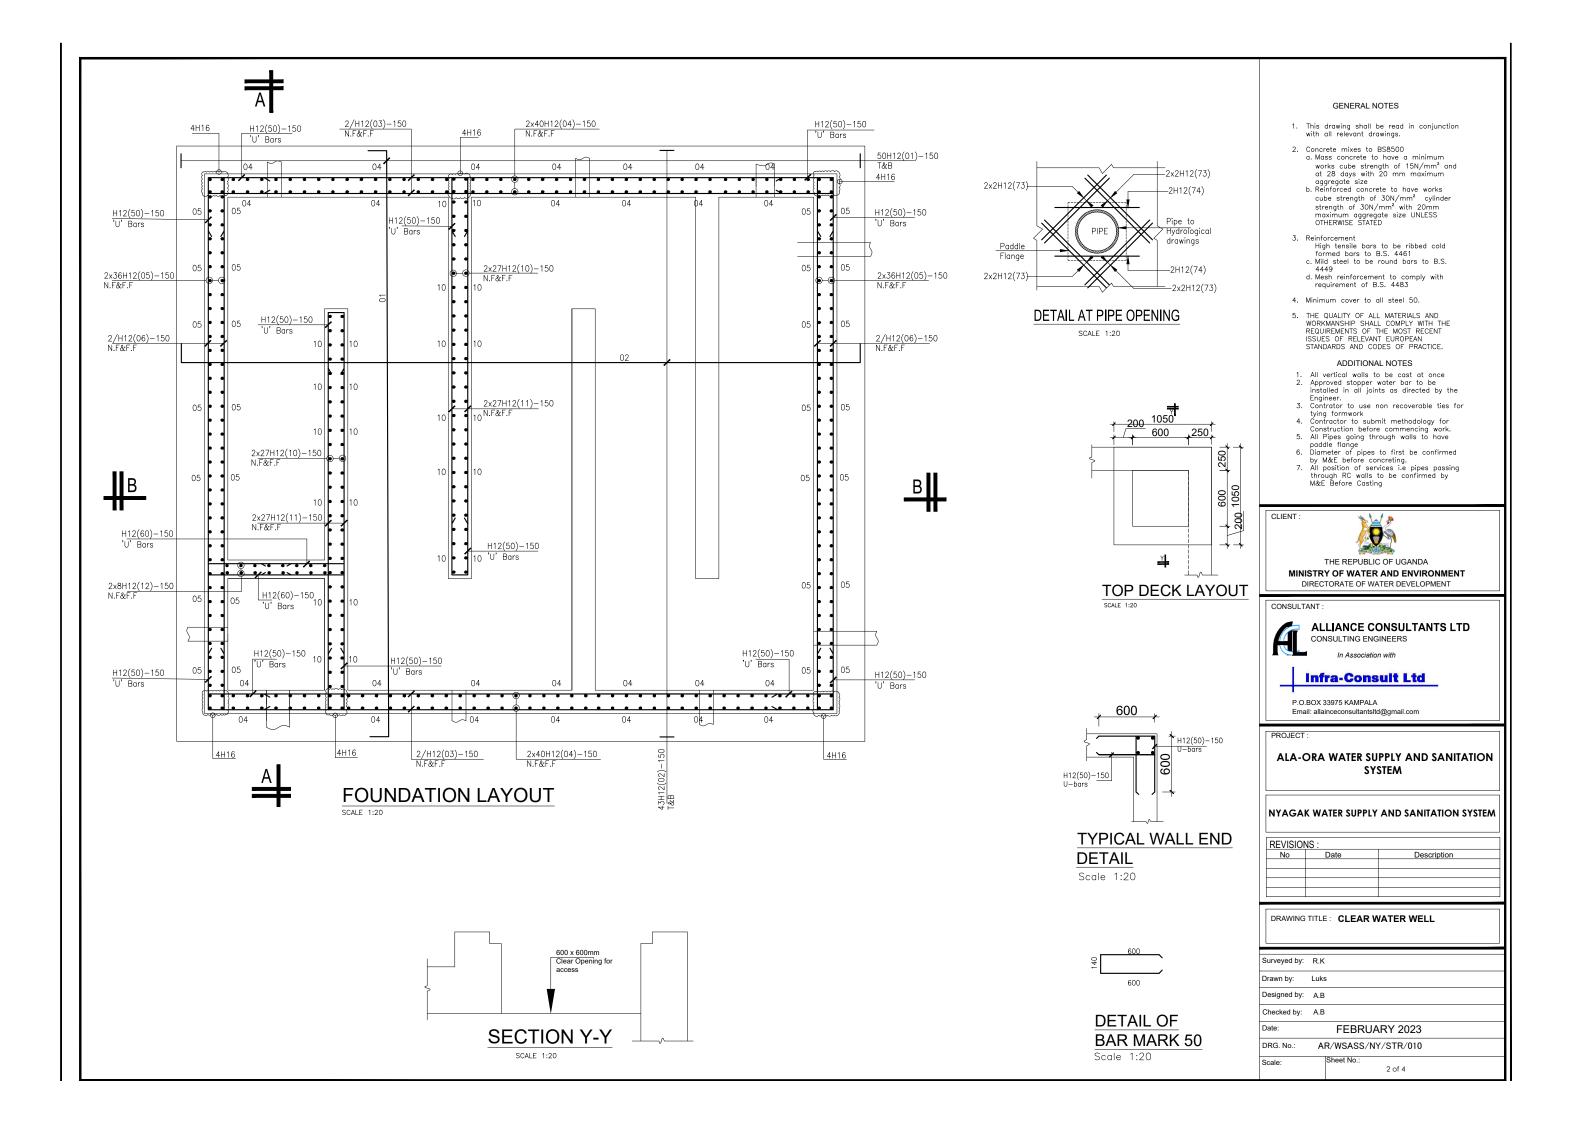


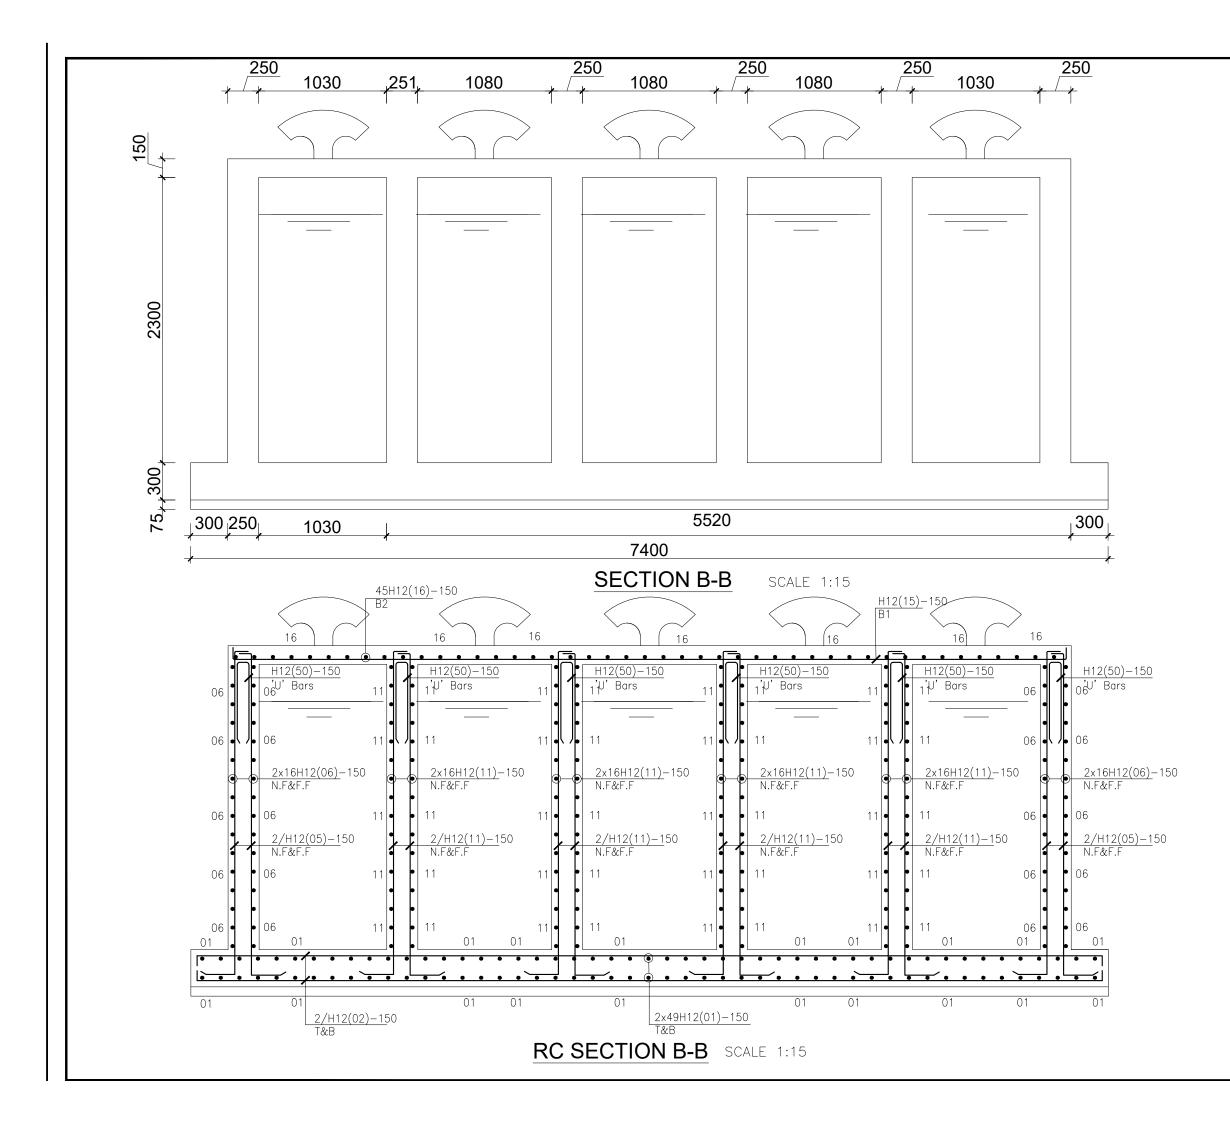



	GENERAL N	IOTES
1.	This drawing shall with all relevant dra	be read in conjunction awings.
2.	at 28 days with aggregate size b. Reinforced concre cube strength of) have a minimum gth of 15N/mm ² and 20 mm maximum ste to have works 30N/mm ² cylinder 'mm ² with 20mm
7	OTHERWISE STATE	D
3.	Reinforcement High tensile bars formed bars to c. Mild steel to be 4449 d. Mesh reinforceme requirement of B	ent to comply with
4.	Minimum cover to	
5.	THE QUALITY OF AL WORKMANSHIP SHAL REQUIREMENTS OF ISSUES OF RELEVAN STANDARDS AND CO	L MATERIALS AND L COMPLY WITH THE THE MOST RECENT IT EUROPEAN DES OF PRACTICE.
1. 2. 3.	Approved stopper installed in all joir Engineer.	o be cast at once
4. 5. 6. 7.	Contractor to subr Construction befor All Pipes going th paddle flange Diameter of pipes by M&F before co	mit methodology for e commencing work. rough walls to have to first be confirmed noreting. vices i.e pipes passing to be confirmed by 1g
CLIENT :	M&L Before Castir	ng
11	THE REPUBLIC IISTRY OF WATER	AND ENVIRONMENT
CONSUL	FANT :	
A	ALLIANCE CONSULTING END	
	Infra-Cons	ult Ltd
	.BOX 33975 KAMPALA ail: allainceconsultantslt	
	ORA WATER SU	IPPLY AND SANITATION STEM
		AND SANITATION SYSTEM
REVISIO No	NS : Date	Description
DRAWING	GTITLE: CLEAR V	VATER WELL
Surveyed by	R.K	
Drawn by:	Luks	
Designed by	A.B	
Checked by:		
Date:		ARY 2023
Date: DRG. No.:		ARY 2023 Y/STR/010
	FEBRUA	

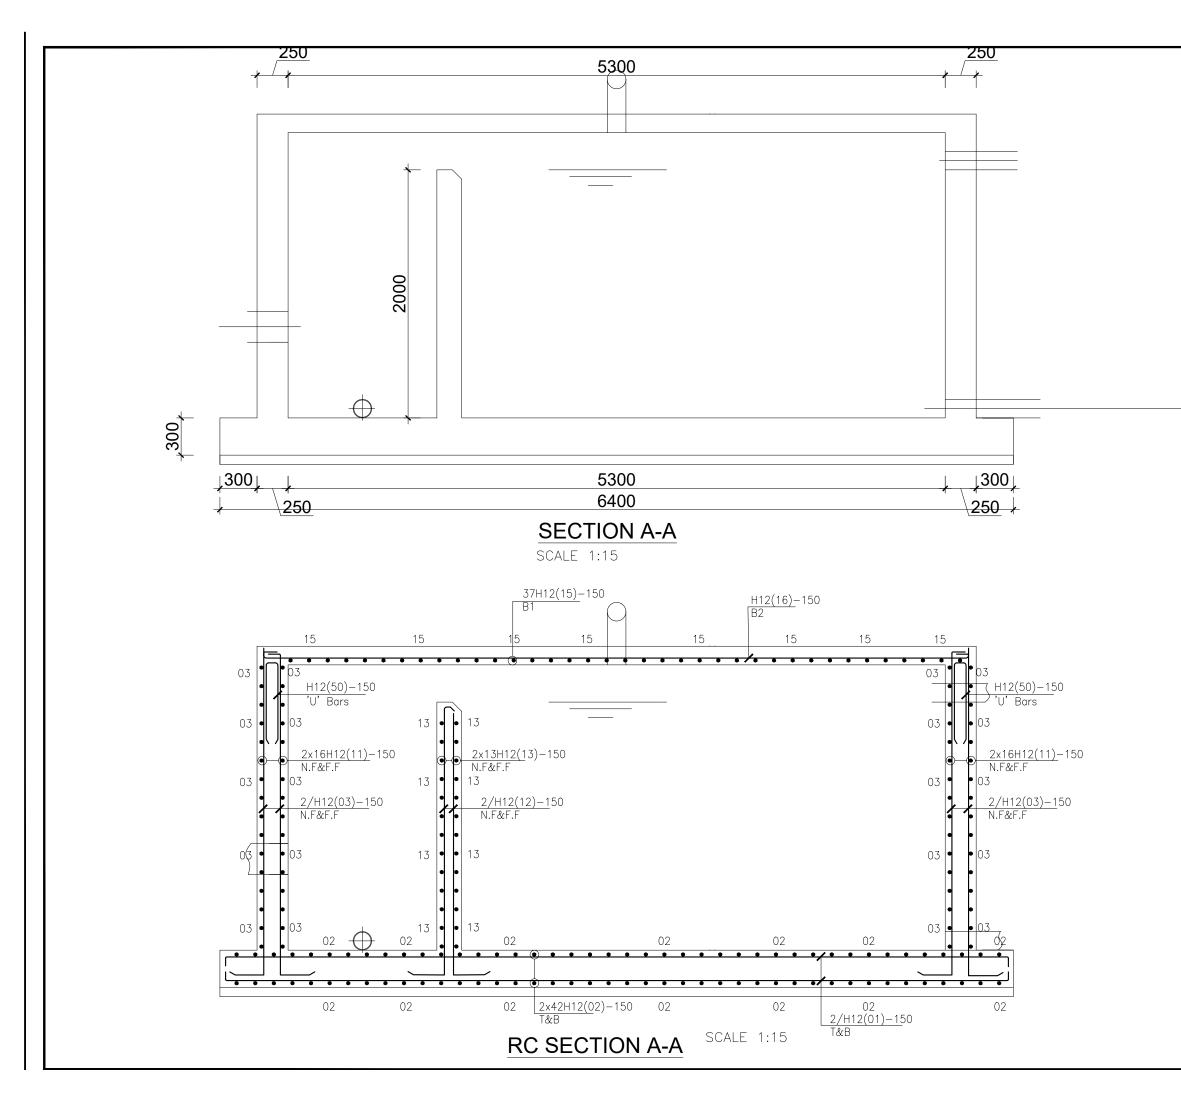


GENERAL NOTES	
 This drawing shall be read in conjunction with all relevant drawings. 	
 Concrete mixes to BS8500 Mass concrete to have a minimum works cube strength of 15N/mm² and at 28 days with 20 mm maximum aggregate size Reinforced concrete to have works cube strength of 30N/mm² with 20mm maximum aggregate size UNLESS OTHERWISE STATED 	
 Reinforcement High tensile bars to be ribbed cold formed bars to B.S. 4461 Mild steel to be round bars to B.S. 4449 Mesh reinforcement to comply with requirement of B.S. 4483 	
4. Minimum cover to all steel 50.	
5. THE QUALITY OF ALL MATERIALS AND WORKMANSHIP SHALL COMPLY WITH THE REQUIREMENTS OF THE MOST RECENT ISSUES OF RELEVANT EUROPEAN STANDARDS AND CODES OF PRACTICE.	
ADDITIONAL NOTES 1. All vertical walls to be cast at once 2. Approved stopper water bar to be installed in all joints as directed by the Engineer.	
 Contractor to use non recoverable ties for tying formwork Contractor to submit methodology for Construction before commencing work. All Pipes going through walls to have paddle flange Diameter of pipes to first be confirmed by M&E before concreting. All position of services i.e pipes passing through RC walls to be confirmed by M&E Before Casting 	
Mar before costing	
CLIENT : THE REPUBLIC OF UGANDA MINISTRY OF WATER AND ENVIRONMENT DIRECTORATE OF WATER DEVELOPMENT	
CONSULTANT : ALLIANCE CONSULTANTS LT CONSULTING ENGINEERS	D
In Association with	
P.O.BOX 33975 KAMPALA Email: allainceconsultantsItd@gmail.com	
PROJECT : ALA-ORA WATER SUPPLY AND SANITA SYSTEM	ATION
NYAGAK WATER SUPPLY AND SANITATION	SYSTEM
REVISIONS : No Date Description	
DRAWING TITLE : CLEAR WATER WELL	
Surveyed by: R.K	
Drawn by: Luks	
Designed by: A.B	
Checked by: A.B Date: EFBRIIARY 2023	
TEDROART 2023	
DRG. No.: AR/WSASS/NY/STR/010	
Scale: Sheet No.:	

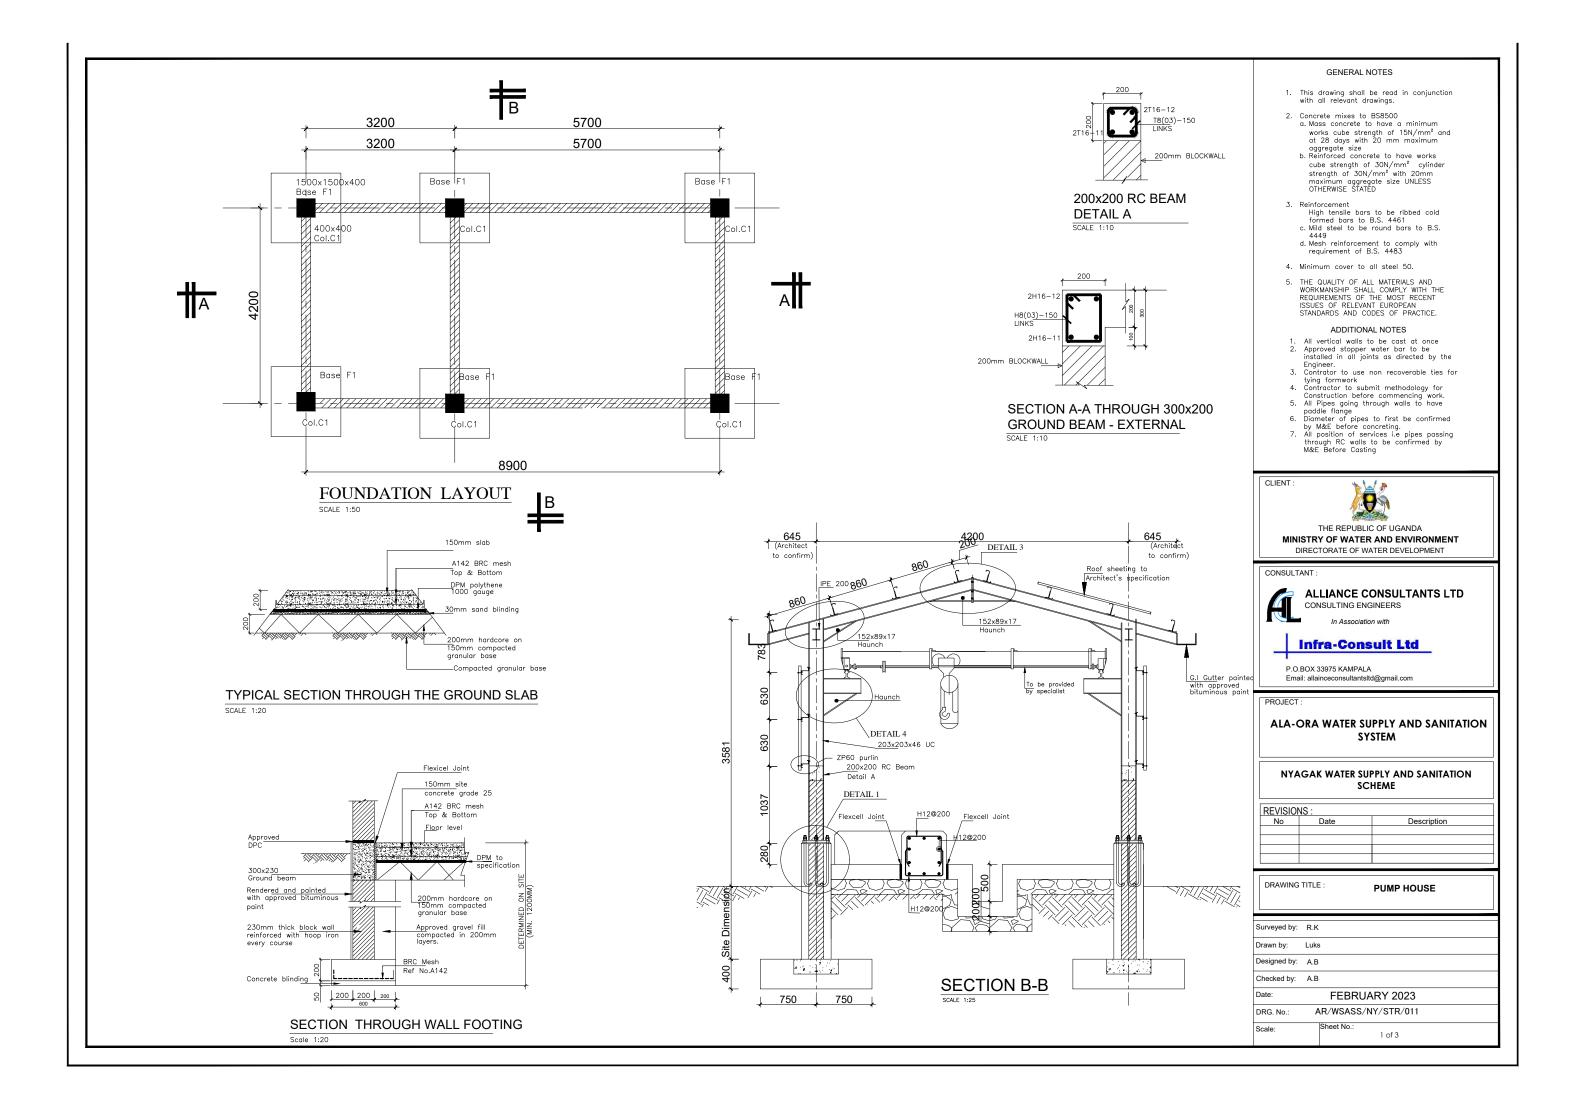


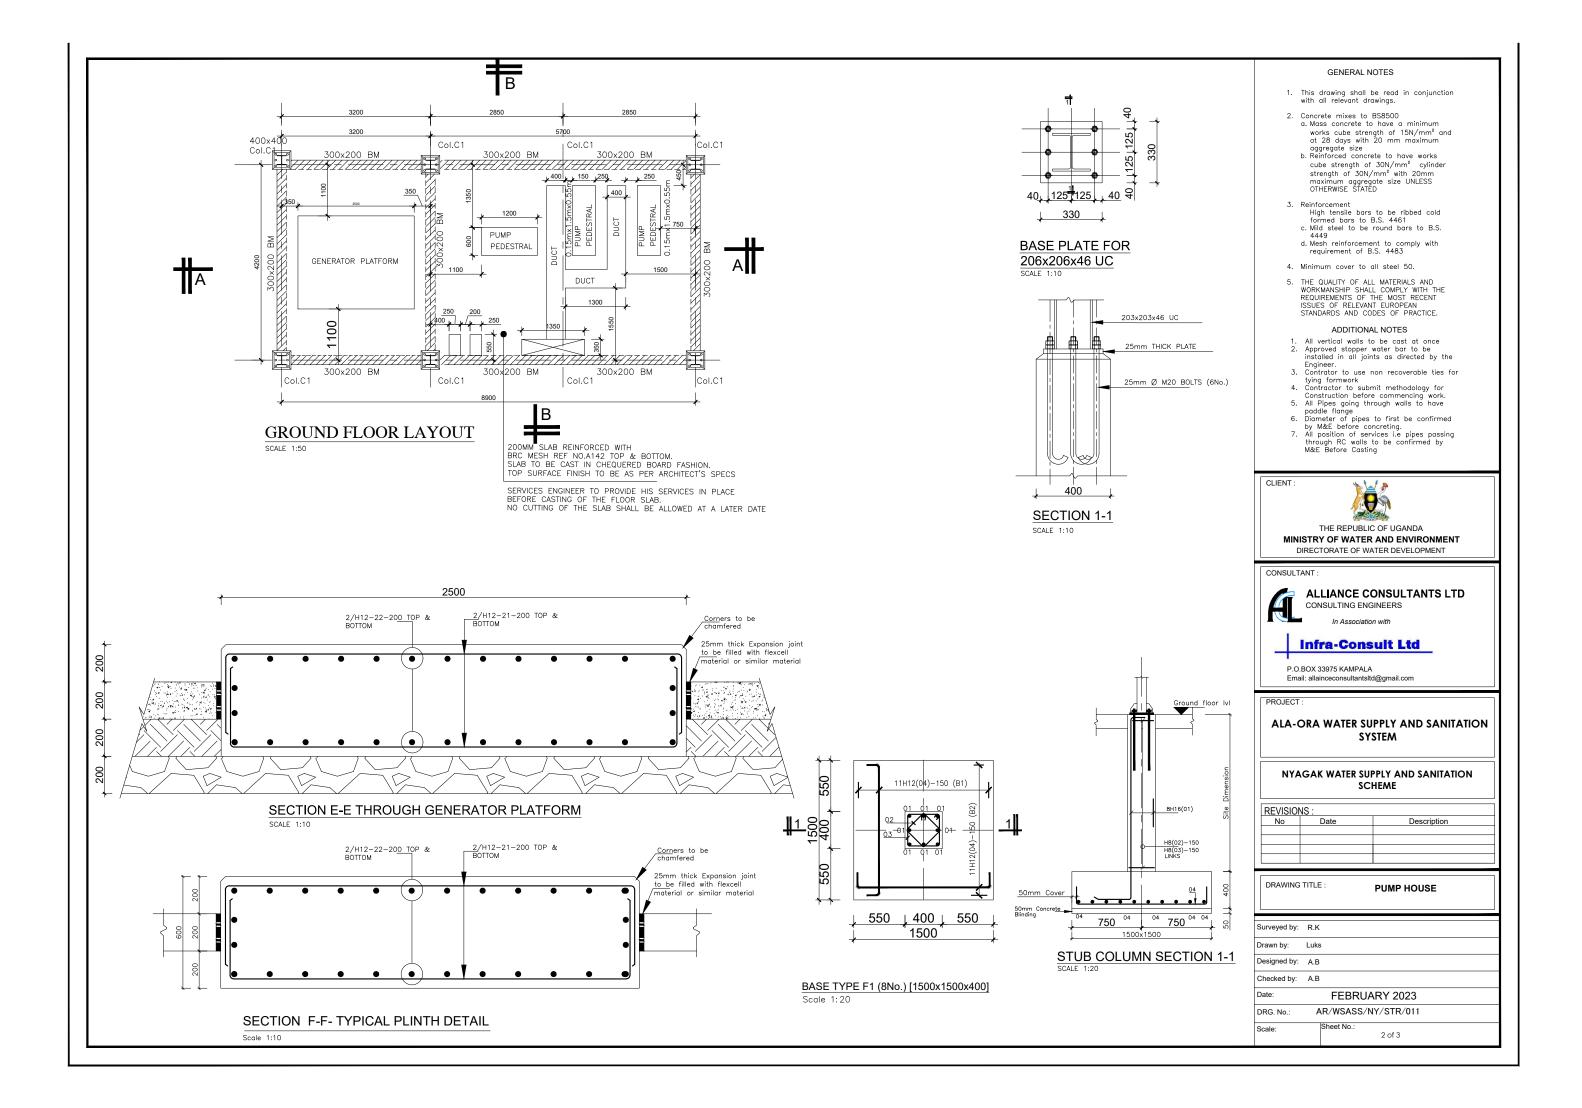

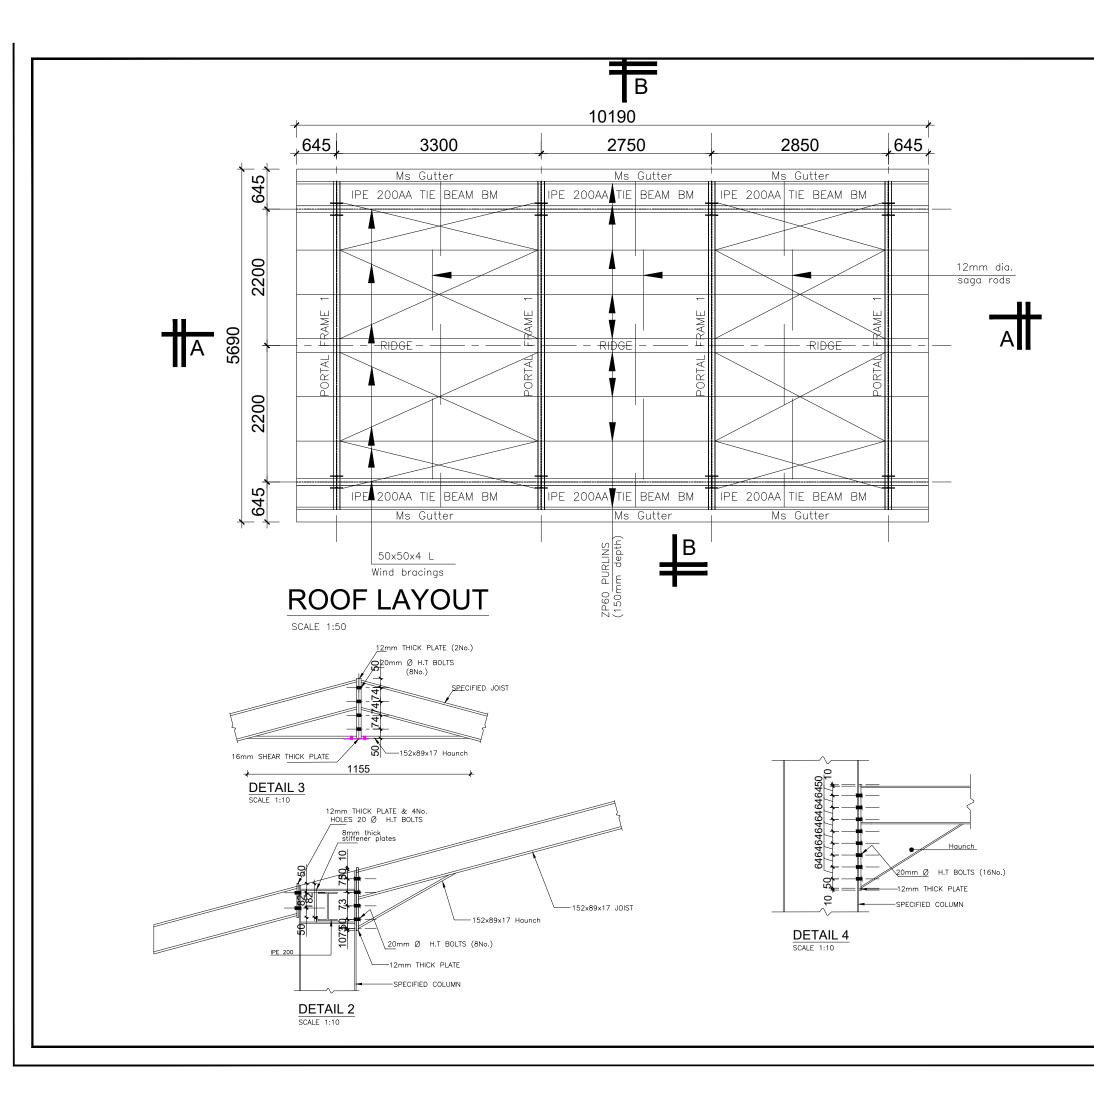


GENERAL N	IOTES
1. This drawing shall I with all relevant dra	be read in conjunction awinas.
2. Concrete mixes to	-
a. Mass concrete to	o have a minimum ngth of 15N/mm² and
at 28 days with aggregate size	20 mm máximum
b. Reinforced concre cube strength of	
strength of 30N/	mm² with 20mm
maximum aggreg OTHERWISE STATE	D
3. Reinforcement	to be ribbed cold
formed bars to	to be ribbed cold B.S. 4461
c. Mild steel to be 4449	
d. Mesh reinforceme requirement of B	ent to comply with I.S. 4483
4. Minimum cover to	all steel 50.
5. THE QUALITY OF AL	L MATERIALS AND L COMPLY WITH THE
REQUIREMENTS OF	THE MOST RECENT
ISSUES OF RELEVAN STANDARDS AND CO	
ADDITION	AL NOTES
1. All vertical walls to 2. Approved stopper	o be cast at once water bar to be
	nts as directed by the
	non recoverable ties for
Contractor to subr	mit methodology for e commencing work.
5. All Pipes going the paddle flange	rough walls to have
6 Diameter of pipes	to first be confirmed
7. All position of ser	vices i.e pipes passing to be confirmed by
M&E Before Castir	ig
CLIENT :	1 A
DIRECTORATE OF WATER	ATER DEVELOPMENT
CONSULTANT :	
CONSULTING ENG	
In Associatio	
Infra-Cons	suit Lta
P.O.BOX 33975 KAMPALA	
P.O.BOX 33975 KAMPALA Email: allainceconsultantslt	
Email: allainceconsultantslt PROJECT :	
Email: allainceconsultantslt PROJECT : ALA-ORA WATER SU	d@gmail.com
Email: allainceconsultantslt PROJECT : ALA-ORA WATER SU	d@gmail.com
Email: allainceconsultantsit	d@gmail.com IPPLY AND SANITATION STEM PPLY AND SANITATION HEME Description
Email: allainceconsultantsit	d@gmail.com
Email: allainceconsultantsit	d@gmail.com IPPLY AND SANITATION STEM PPLY AND SANITATION HEME Description
Email: allainceconsultantsit PROJECT : ALA-ORA WATER SU SY NYAGAK WATER SU SC REVISIONS : No Date	d@gmail.com IPPLY AND SANITATION STEM PPLY AND SANITATION HEME Description
Email: allainceconsultantsit PROJECT : ALA-ORA WATER SU SY NYAGAK WATER SU SC REVISIONS : No Date DRAWING TITLE :	d@gmail.com IPPLY AND SANITATION STEM PPLY AND SANITATION HEME Description
Email: allainceconsultantsit	d@gmail.com IPPLY AND SANITATION STEM PPLY AND SANITATION HEME Description
Email: allainceconsultantsit	d@gmail.com IPPLY AND SANITATION STEM PPLY AND SANITATION HEME Description
Email: allainceconsultantsit	d@gmail.com IPPLY AND SANITATION STEM DPLY AND SANITATION HEME Description PUMP HOUSE
Email: allainceconsultantsite PROJECT : ALA-ORA WATER SU SY NYAGAK WATER SU SY NYAGAK WATER SU SY NO Date DRAWING TITLE : DRAWING TITLE : Surveyed by: R.K Drawn by: Luks Designed by: A.B Checked by: A.B Date: FEBRUA DRG. No.: AR/WSASS/N	d@gmail.com IPPLY AND SANITATION STEM DPLY AND SANITATION HEME Description PUMP HOUSE
Email: allainceconsultantsit	d@gmail.com IPPLY AND SANITATION STEM DPLY AND SANITATION HEME Description PUMP HOUSE

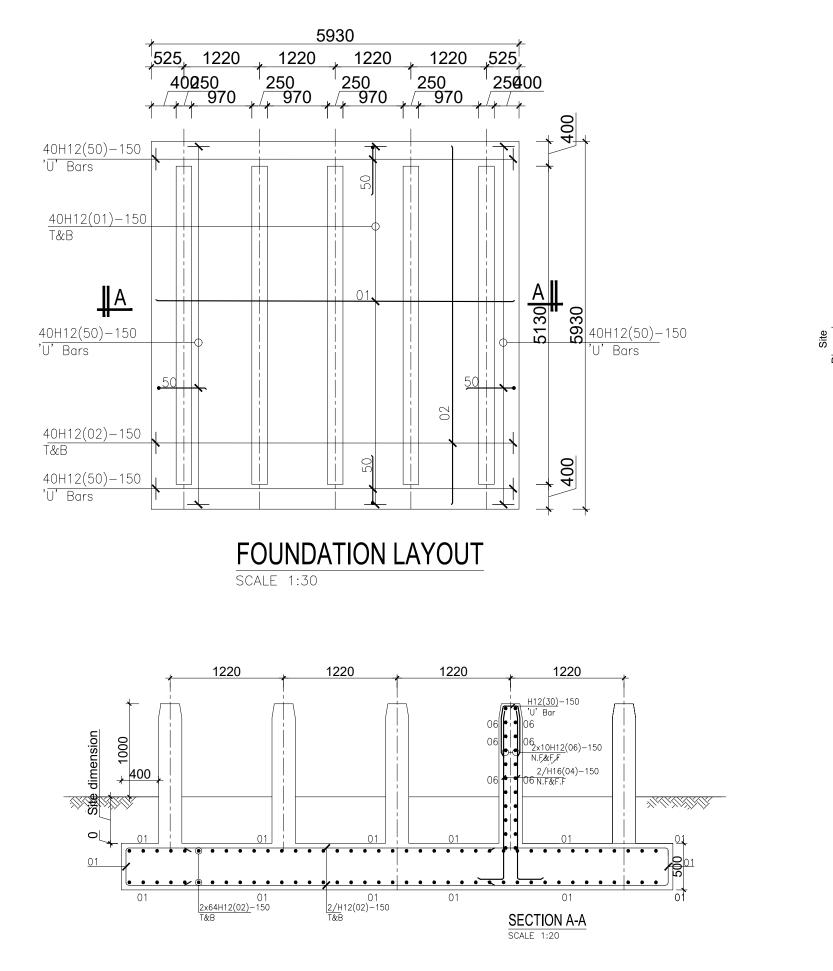

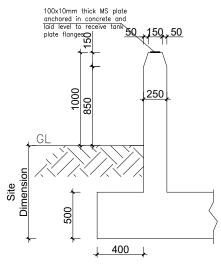


DWARF WALL DETAIL

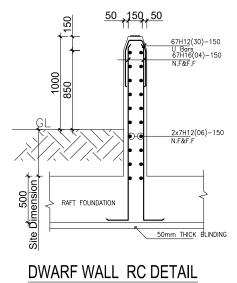


SCALE 1:20


GENERAL NOTES
 This drawing shall be read in conjunction with all relevant drawings.
 Concrete mixes to BS8500 Mass concrete to have a minimum works cube strength of 15N/mm² and at 28 days with 20 mm maximum aggregate size Reinforced concrete to have works cube strength of 30N/mm² cylinder strength of 30N/mm² with 20mm maximum aggregate size UNLESS OTHERWISE STATED
 Reinforcement High tensile bars to be ribbed cold formed bars to B.S. 4461 wild steel to be round bars to B.S. 4449 Mesh reinforcement to comply with requirement of B.S. 4483
4. Minimum cover to all steel 50.
5. THE QUALITY OF ALL MATERIALS AND WORKMANSHIP SHALL COMPLY WITH THE REQUIREMENTS OF THE MOST RECENT ISSUES OF RELEVANT EUROPEAN STANDARDS AND CODES OF PRACTICE.
ADDITIONAL NOTES 1. All vertical walls to be cast at once 2. Approved stopper water bar to be installed in all joints as directed by the Engineer. 3. Contrator to use non recoverable ties for tying formwork
 Contractor to submit methodology for Construction before commencing work. All Pipes going through walls to have paddle flange Diameter of pipes to first be confirmed by M&E before concreting. All position of services i.e pipes passing
through RC walls to be confirmed by M&E Before Casting
THE REPUBLIC OF UGANDA MINISTRY OF WATER AND ENVIRONMENT DIRECTORATE OF WATER DEVELOPMENT
CONSULTANT : ALLIANCE CONSULTANTS LTD CONSULTING ENGINEERS In Association with
Infra-Consult Ltd
P.O.BOX 33975 KAMPALA
Email: allainceconsultantsItd@gmail.com
PROJECT : ALA-ORA WATER SUPPLY AND SANITATION SYSTEM
NYAGAK WATER SUPPLY AND SANITATION SYSTEM
REVISIONS : No Date Description
DRAWING TITLE : BACKWASH 50m ³ TANK
Surveyed by: R.K
Drawn by: Luks
Designed by: A,B
Checked by: A.B Date: FEBRUARY 2023
DRG. No.: AR/WSASS/NY/STR/012
Scale: Sheet No.: 1 of 2

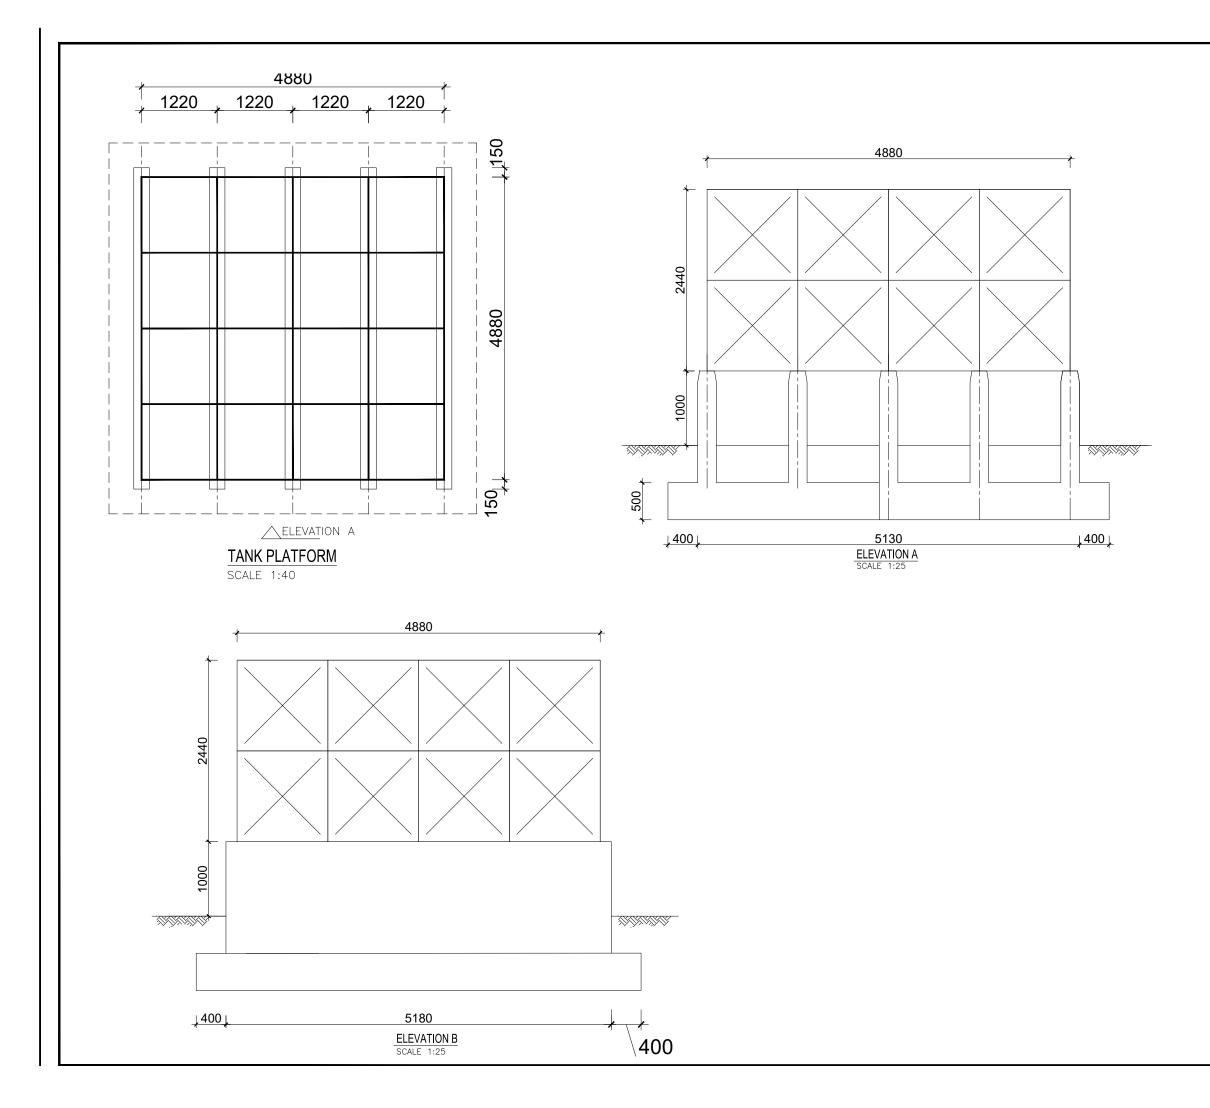


GENERAL NOTES
 This drawing shall be read in conjunction with all relevant drawings.
 Concrete mixes to BS8500 Mass concrete to have a minimum works cube strength of 15N/mm² and at 28 days with 20 mm maximum aggregate size Reinforced concrete to have works cube strength of 30N/mm² cylinder strength of 30N/mm² with 20mm moximum aggregate size UNLESS OTHERWISE STATED
 Reinforcement High tensile bars to be ribbed cold formed bars to B.S. 4461 c. Mild steel to be round bars to B.S. 4449 d. Mesh reinforcement to comply with requirement of B.S. 4483
4. Minimum cover to all steel 50.
5. THE QUALITY OF ALL MATERIALS AND WORKMANSHIP SHALL COMPLY WITH THE REQUIREMENTS OF THE MOST RECENT ISSUES OF RELEVANT EUROPEAN STANDARDS AND CODES OF PRACTICE.
ADDITIONAL NOTES 1. All vertical walls to be cast at once 2. Approved stopper water bar to be installed in all joints as directed by the Engineer. 3. Contractor to use non recoverable ties for tying formwork 4. Contractor to submit methodology for
 Construction before commencing work. All Pipes going through walls to have paddle flange Diameter of pipes to first be confirmed by M&E before concreting. All position of services i.e pipes passing through RC walls to be confirmed by M&E Before Casting
CLIENT :
THE REPUBLIC OF UGANDA
MINISTRY OF WATER AND ENVIRONMENT DIRECTORATE OF WATER DEVELOPMENT
CONSULTANT :
ALLIANCE CONSULTANTS LTD CONSULTING ENGINEERS
In Association with
Infra-Consult Ltd
P.O.BOX 33975 KAMPALA Email: allainceconsultantsItd@gmail.com
Email: allainceconsultantsItd@gmail.com PROJECT : ALA-ORA WATER SUPPLY AND SANITATION
Email: allainceconsultantsItd@gmail.com PROJECT : ALA-ORA WATER SUPPLY AND SANITATION SYSTEM
Email: allainceconsultantsItd@gmail.com PROJECT : ALA-ORA WATER SUPPLY AND SANITATION SYSTEM NYAGAK WATER SUPPLY AND SANITATION SYSTEA REVISIONS :
Email: allainceconsultantsItd@gmail.com PROJECT : ALA-ORA WATER SUPPLY AND SANITATION SYSTEM NYAGAK WATER SUPPLY AND SANITATION SYSTEA REVISIONS :
Email: allainceconsultantsItd@gmail.com PROJECT : ALA-ORA WATER SUPPLY AND SANITATION SYSTEM NYAGAK WATER SUPPLY AND SANITATION SYSTEA REVISIONS :
Email: allainceconsultantsitd@gmail.com PROJECT : ALA-ORA WATER SUPPLY AND SANITATION SYSTEM NYAGAK WATER SUPPLY AND SANITATION SYSTEA REVISIONS : No Date Description Image: Comparison of the system DRAWING TITLE : BACKWASH
Email: allainceconsultantsitd@gmail.com PROJECT : ALA-ORA WATER SUPPLY AND SANITATION SYSTEM NYAGAK WATER SUPPLY AND SANITATION SYSTEM REVISIONS : No Date Date Description Date Drawing TITLE : BACKWASH Surveyed by: R.K Drawn by: Luks
Email: allainceconsultantsitd@gmail.com PROJECT : ALA-ORA WATER SUPPLY AND SANITATION SYSTEM NYAGAK WATER SUPPLY AND SANITATION SYSTEA REVISIONS : No Date Date Description Date Description Date Description Surveyed by: R.K Drawn by: Luks Designed by: A.B
Email: allainceconsultantsitd@gmail.com PROJECT : ALA-ORA WATER SUPPLY AND SANITATION SYSTEM NYAGAK WATER SUPPLY AND SANITATION SYSTEM REVISIONS : No Date Date Description Description DRAWING TITLE : BACKWASH 50m ³ TANK Surveyed by: R.K Drawn by: Luks Designed by: A.B Checked by: A.B
Email: allainceconsultantsitd@gmail.com PROJECT : ALA-ORA WATER SUPPLY AND SANITATION SYSTEM NYAGAK WATER SUPPLY AND SANITATION SYSTEM REVISIONS : No Date Date Description Description Date Description Drawn by: Luks Designed by: A.B Checked by: A.B

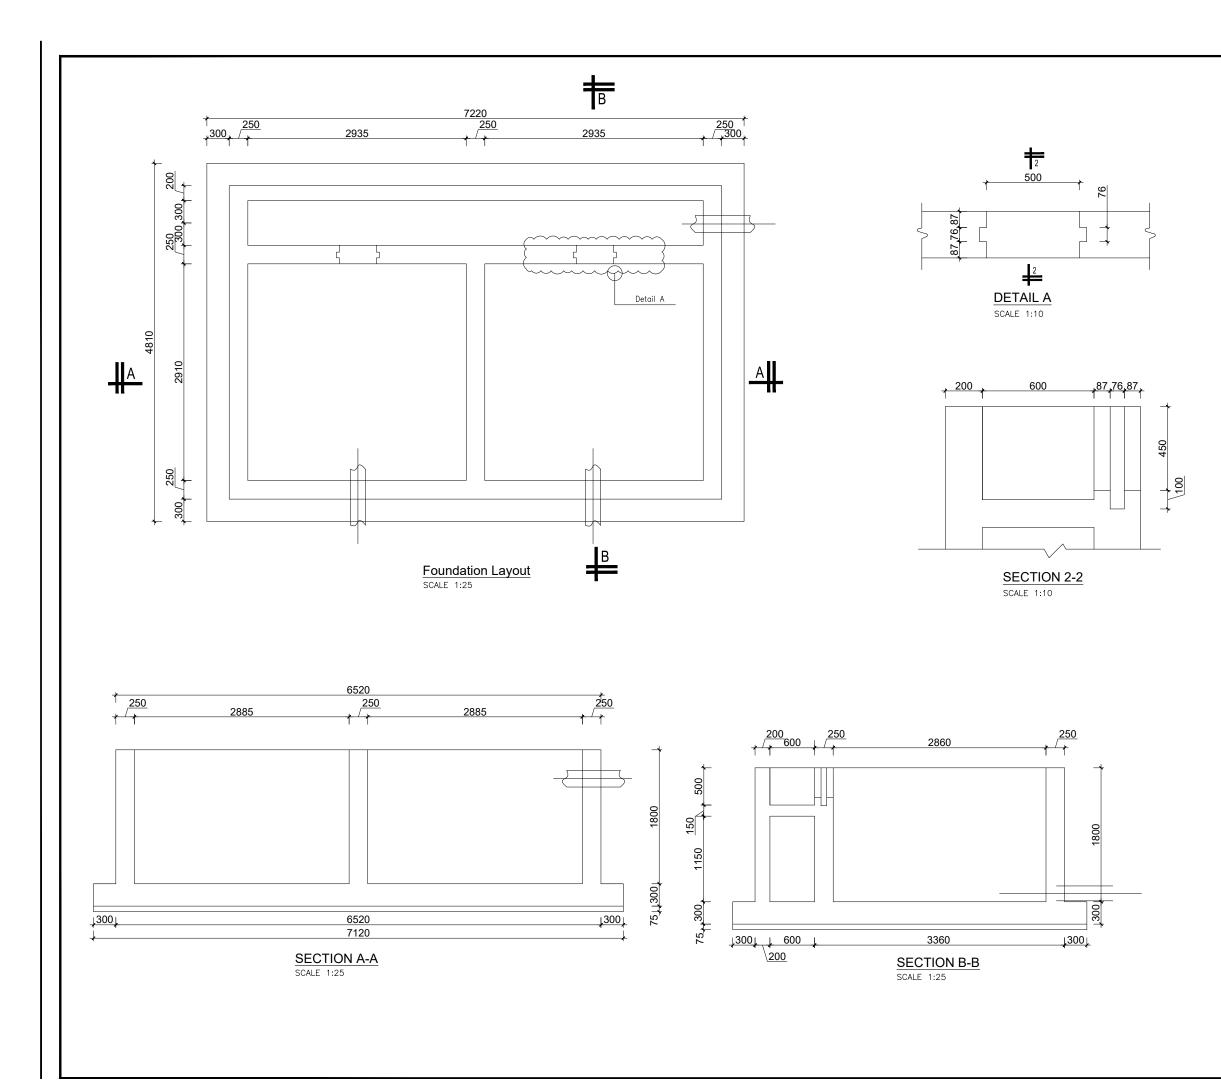



	GENERAL NOTES
1.	This drawing shall be read in conjunction with all relevant drawings.
2.	Concrete mixes to BS8500 a. Mass concrete to have a minimum works cube strength of 15N/mm ² and at 28 days with 20 mm maximum aggregate size b. Reinforced concrete to have works cube strength of 30N/mm ² cylinder strength of 30N/mm ² with 20mm maximum aggregate size UNLESS OTHERWISE STATED
3.	Reinforcement High tensile bars to be ribbed cold formed bars to B.S. 4461 c. Mild steel to be round bars to B.S. 4449 d. Mesh reinforcement to comply with requirement of B.S. 4483
4.	Minimum cover to all steel 50.
5.	THE QUALITY OF ALL MATERIALS AND WORKMANSHIP SHALL COMPLY WITH THE REQUIREMENTS OF THE MOST RECENT ISSUES OF RELEVANT EUROPEAN STANDARDS AND CODES OF PRACTICE.
1. 2. 3. 4. 5. 6. 7.	installed in all joints as directed by the Engineer. Contrator to use non recoverable ties for tying formwork Contractor to submit methodology for Construction before commencing work. All Pipes going through walls to have paddle flange Diameter of pipes to first be confirmed by M&E before concreting.
	THE REPUBLIC OF UGANDA INSTRY OF WATER AND ENVIRONMENT DIRECTORATE OF WATER DEVELOPMENT
CONSULT	ALLIANCE CONSULTANTS LTD CONSULTING ENGINEERS
	In Association with
	Infra-Consult Ltd
	Infra-Consult Ltd D.BOX 33975 KAMPALA ail: allainceconsultantsItd@gmail.com
Em PROJECT	9.BOX 33975 KAMPALA ail: allainceconsultantsItd@gmail.com
PROJECT	D.BOX 33975 KAMPALA ali: allainceconsultantsItd@gmail.com
PROJECT	D.BOX 33975 KAMPALA ali: allainceconsultantsItd@gmail.com
PROJECT ALA- NYAGA REVISIO	DBOX 33975 KAMPALA ali: allainceconsultantsItd@gmail.com
	DBOX 33975 KAMPALA ali: allainceconsultantsItd@gmail.com
	D.BOX 33975 KAMPALA all: allalinceconsultantsItd@gmail.com
	D.BOX 33975 KAMPALA all: allalinceconsultantsItd@gmail.com
Em PROJECT ALA- NYAGA REVISIO No DRAWING	DBOX 33975 KAMPALA ali: allainceconsultantsItd@gmail.com
Em PROJECT ALA- NYAGA REVISIO No DRAWING Surveyed by: Drawn by:	D.BOX 33975 KAMPALA ali: allalinceconsultantsItd@gmail.com
Em PROJECT ALA NYAGA REVISIO No DRAWINC Surveyed by: Drawn by:	D.BOX 33975 KAMPALA ali: allalinceconsultantsItd@gmail.com
Em PROJECT ALA NYAGA REVISIO No DRAWING Drawn by: Designed by: Checked by:	D.BOX 33975 KAMPALA all: allalinceconsultantsItd@gmail.com

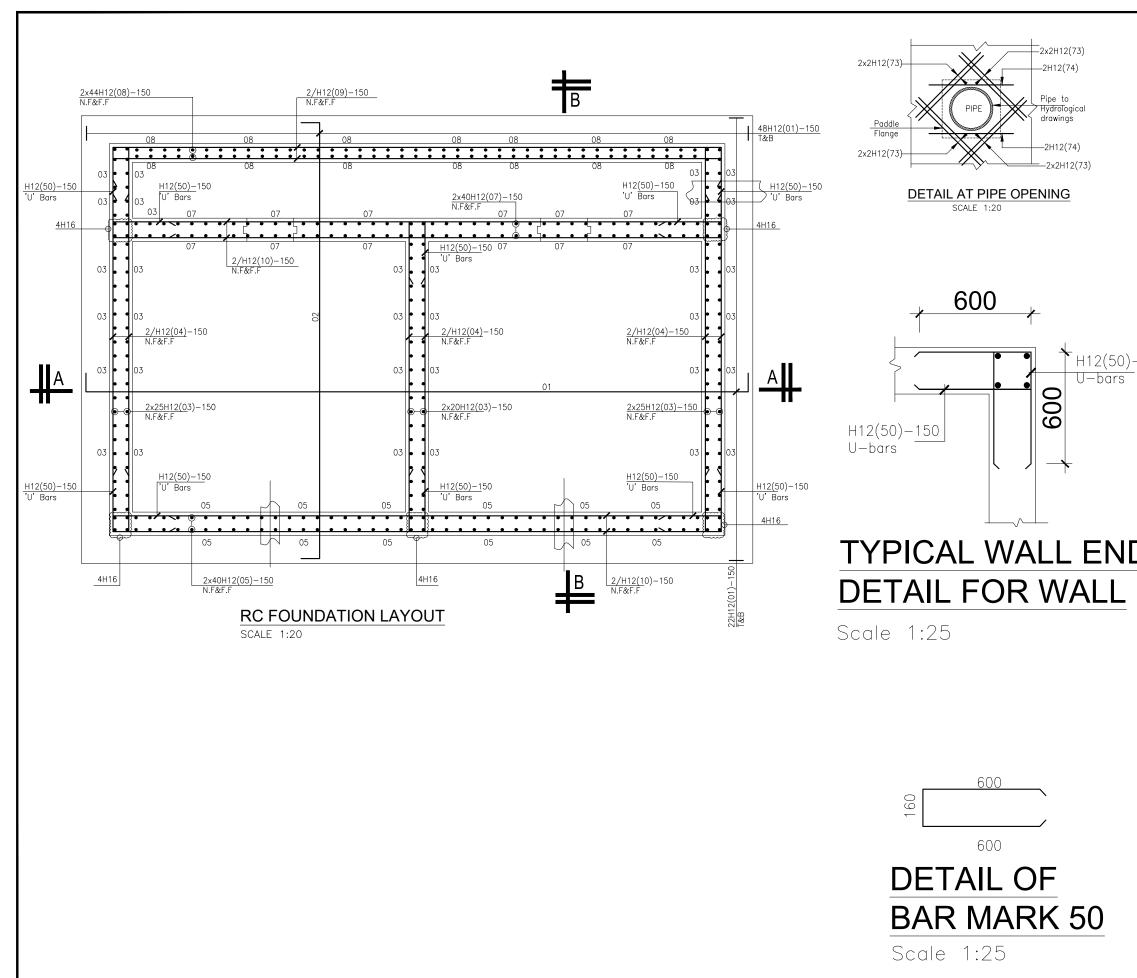


	GENERAL NOTES
	 This drawing shall be read in conjunction with all relevant drawings.
	 Concrete mixes to BS8500 Mass concrete to have a minimum works cube strength of 15N/mm² and at 28 days with 20 mm maximum aggregate size Reinforced concrete to have works cube strength of 30N/mm² with 20mm maximum aggregate size UNLESS OTHERWISE STATED
	 Reinforcement High tensile bars to be ribbed cold formed bars to B.S. 4461 c. Mild steel to be round bars to B.S. 4449 d. Mesh reinforcement to comply with requirement of B.S. 4483
	4. Minimum cover to all steel 50.
	5. THE QUALITY OF ALL MATERIALS AND WORKMANSHIP SHALL COMPLY WITH THE REQUIREMENTS OF THE MOST RECENT ISSUES OF RELEVANT EUROPEAN STANDARDS AND CODES OF PRACTICE.
- 150	 ADDITIONAL NOTES All vertical walls to be cast at once Approved stopper water bar to be installed in all joints as directed by the Engineer. Contractor to use non recoverable ties for tying formwork Contractor to submit methodology for Construction before commencing work. All Pipes going through walls to have paddle flange Diameter of pipes to first be confirmed by M&E before concreting. All points of services i.e pipes passing through RC walls to be confirmed by M&E Before Casting
	CLIENT :
	THE REPUBLIC OF UGANDA
	MINISTRY OF WATER AND ENVIRONMENT DIRECTORATE OF WATER DEVELOPMENT
	CONSULTANT :
	ALLIANCE CONSULTANTS LTD CONSULTING ENGINEERS
	In Association with
	Infra-Consult Ltd
	P.O.BOX 33975 KAMPALA Email: allainceconsultantsltd@gmail.com
	PROJECT :
	ALA-ORA WATER SUPPLY AND SANITATION SYSTEM
	NYAGAK WATER SUPPLY AND SANITATION SYSTEM
	REVISIONS : No Date Description
	DRAWING TITLE : SLUDGE DRYING BEDS
	DRAWING TITLE : SLUDGE DRYING BEDS
	Surveyed by: R.K Drawn by: Luks
	Surveyed by: R.K Drawn by: Luks Designed by: A.B
	Surveyed by: R.K Drawn by: Luks
	Surveyed by: R.K Drawn by: Luks Designed by: A.B Checked by: A.B

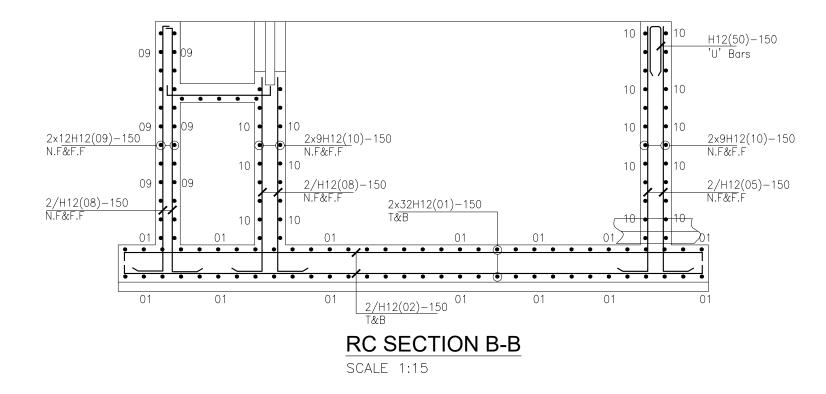


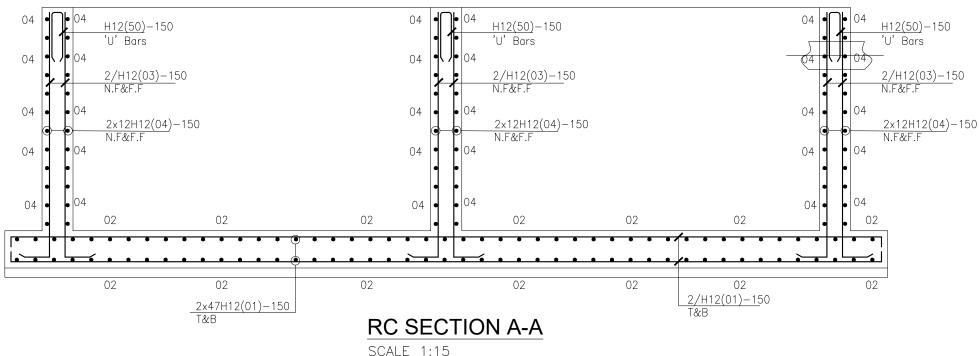

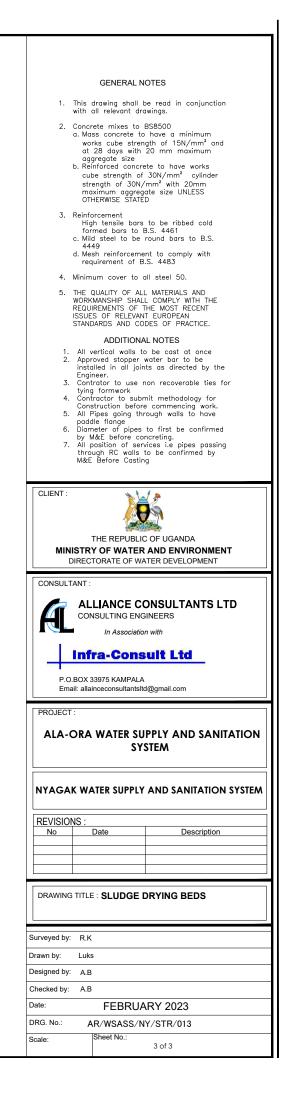

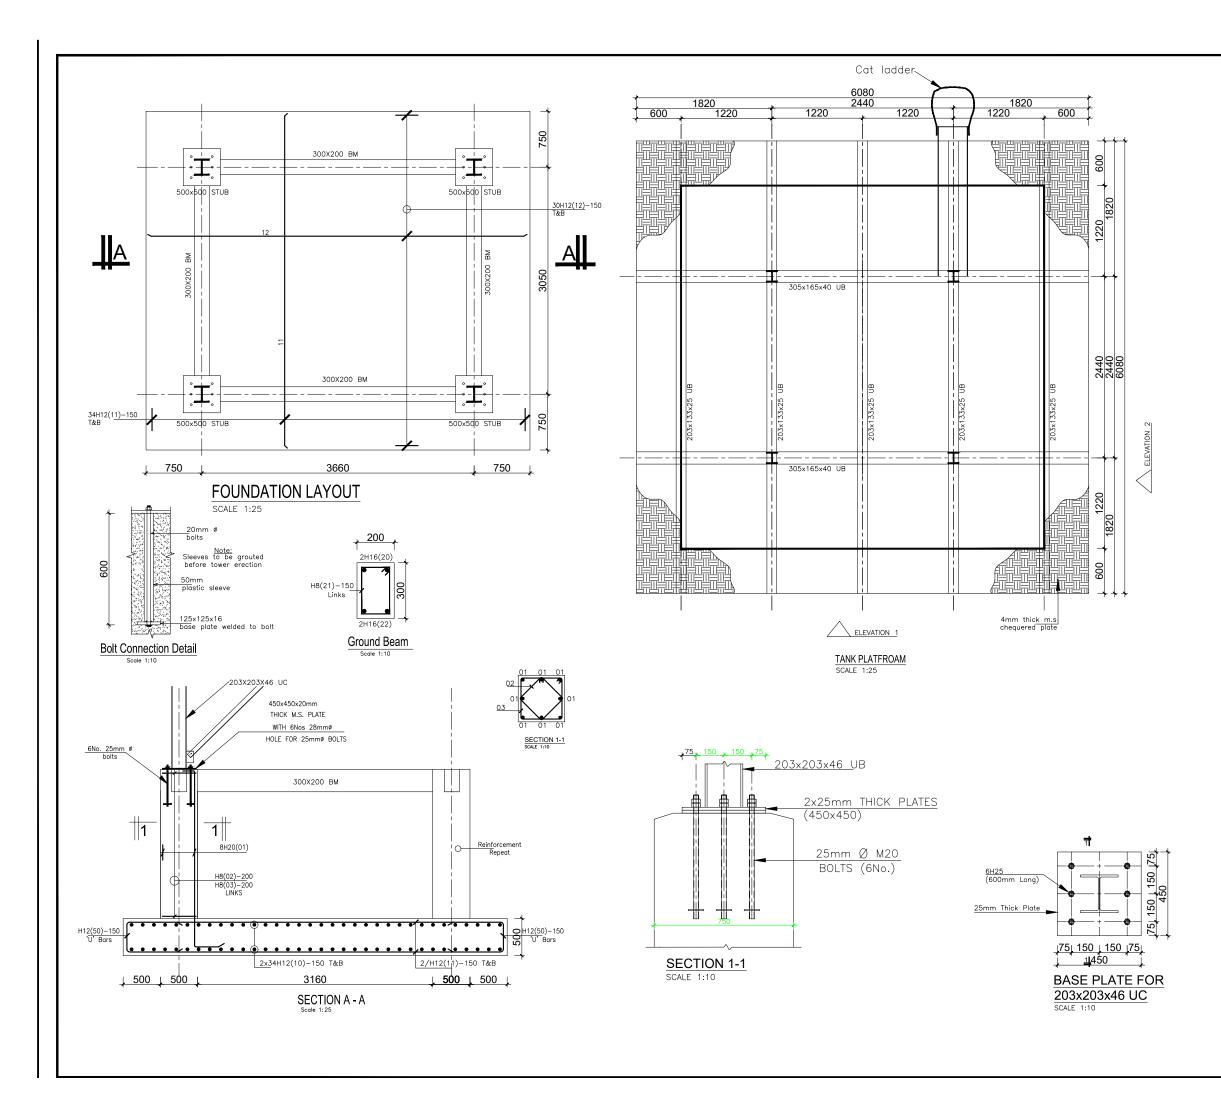


	GENERAL N	IOTES
1.	This drawing shall with all relevant dra	be read in conjunction awings.
2.	Concrete mixes to a. Mass concrete to works cube strer at 28 days with aggregate size b. Reinforced concre cube strength of strength of 30N/ maximum aggreg	BS5500 b have a minimum ogth of 15N/mm ² and 20 mm maximum ete to have works 30N/mm ² cylinder 'mm ² with 20mm ate size UNLESS
3.	OTHERWISE STATE Reinforcement	D to be ribbed cold
	 c. Mild steel to be 4449 d. Mesh reinforceme requirement of B 	round bars to B.S. ent to comply with
4.	Minimum cover to	
5.	THE QUALITY OF AL WORKMANSHIP SHAL REQUIREMENTS OF ISSUES OF RELEVAN STANDARDS AND CO	L MATERIALS AND L COMPLY WITH THE THE MOST RECENT IT EUROPEAN IDES OF PRACTICE.
1.2	Approved stopper	o be cast at once
3.	Contrator to use tying formwork Contractor to subr	non recoverable ties for mit methodology for e commencing work.
6.	paddle flange	rough walls to have to first be confirmed
7.	by M&E before co	ncreting. vices i.e pipes passing to be confirmed by
CLIENT :	X	
		C OF UGANDA
11	DIRECTORATE OF WA	
CONSUL	TANT :	
A	ALLIANCE CONSULTING END	
	Infra-Cons	
).BOX 33975 KAMPALA ail: allainceconsultantsIt	
PROJEC	Γ:	
ALA-		IPPLY AND SANITATION STEM
NYAGA	K WATER SUPPLY	AND SANITATION SYSTEM
REVISIC No	NS : Date	Description
DRAWIN), ANYIRIBU & NYAGAK
	IN	TAKE COMMUNITY 84m ³ Tank
Surveyed by	R.K	
Drawn by:	Luks	
Designed by	A.B	
Checked by:		
Date:		ARY 2023
Date: DRG. No.:		ARY 2023 Y/STR/017
	FEBRUA	

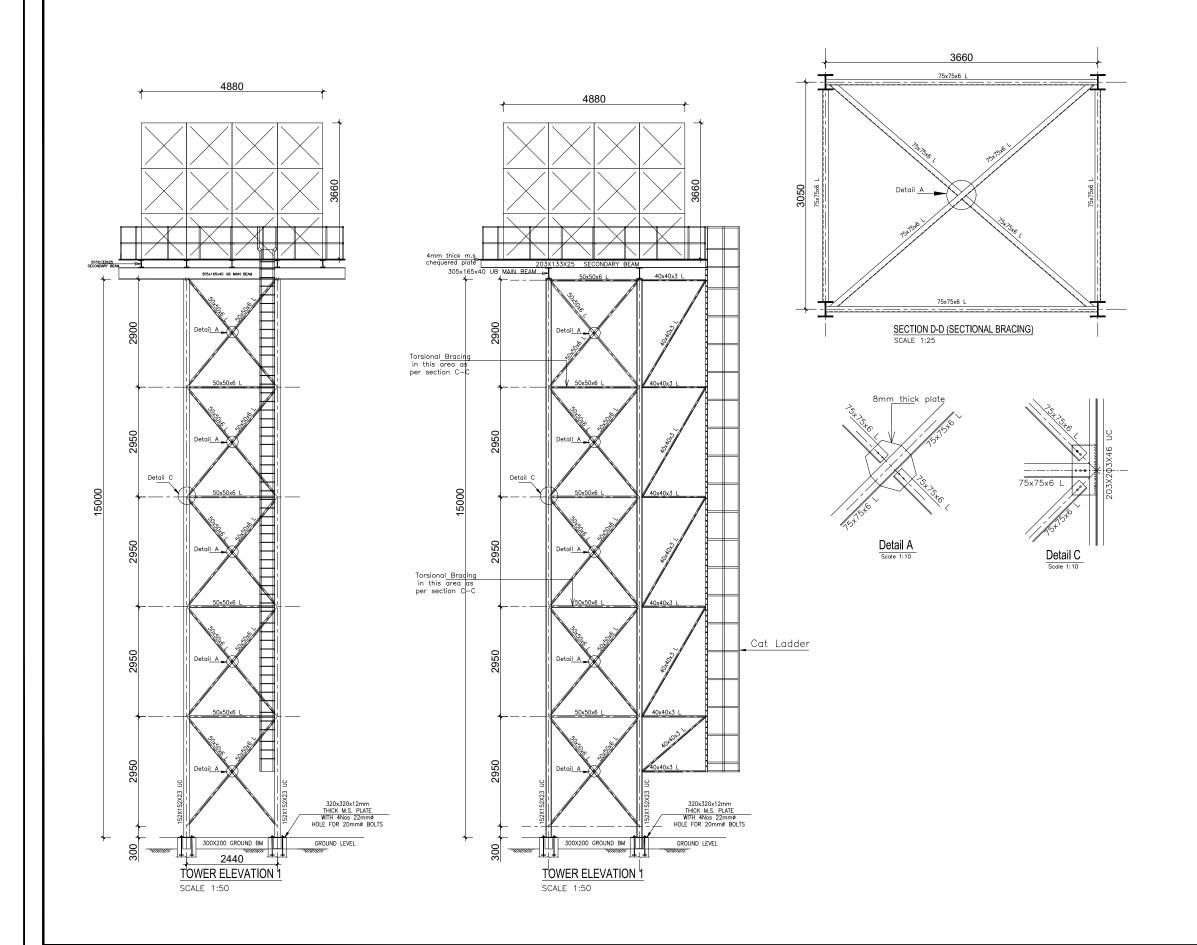

	GENERAL N	OTES
	This drawing shall t vith all relevant dro	be read in conjunction awings.
c	aggregate size . Reinforced concre	have a minimum gth of 15N/mm ² and 20 mm maximum ste to have works 30N/mm ² cylinder mm ² with 20mm ate size UNLESS
c	Reinforcement High tensile bars formed bars to f 5. Mild steel to be 4449 d. Mesh reinforceme requirement of B	to be ribbed cold 3.S. 4461 round bars to B.S. nt to comply with S. 4483
4. N	linimum cover to a	all steel 50.
V F IS	THE QUALITY OF ALI VORKMANSHIP SHAL REQUIREMENTS OF 1 SSUES OF RELEVAN STANDARDS AND CO	L COMPLY WITH THE THE MOST RECENT T EUROPEAN
1. 2. 3.	Engineer.	b be cast at once
4.	tying formwork Contractor to subr Construction before All Pipes going thr paddle flange Diameter of pipes	nit methodology for e commencing work. rough walls to have to first be confirmed
7.	by M&E before co All position of sen through RC walls M&E Before Castin	vices i.e pipes passing to be confirmed by
		C OF UGANDA AND ENVIRONMENT NTER DEVELOPMENT
CONSULTA	NT ·	
A		
	nfra-Cons	
	3OX 33975 KAMPALA I: allainceconsultantslt	
	ORA WATER SU SY:	PPLY AND SANITATION STEM
	WATER SUPPLY	AND SANITATION SYSTEM
	<u>.</u> .	
REVISION No	<u>S :</u> Date	Description
	-	Description
		Description , ANYIRIBU & NYAGAK TAKE COMMUNITY 84m ³ Tank
No		D , ANYIRIBU & NYAGAK TAKE COMMUNITY
		D , ANYIRIBU & NYAGAK TAKE COMMUNITY
DRAWING T	Date TITLE : OGOKC IN R.K Luks	D , ANYIRIBU & NYAGAK TAKE COMMUNITY
No DRAWING Surveyed by: Drawn by: Designed by: Checked by:	Date TITLE : OGOKC IN R.K Luks A.B A.B	9 , ANYIRIBU & NYAGAK TAKE COMMUNITY 84m ³ Tank
No DRAWING DRAWING Surveyed by: Drawn by: Designed by: Checked by: Date:	Date TITLE : OGOKC IN R.K Luks A.B A.B FEBRUA	ANYIRIBU & NYAGAK TAKE COMMUNITY 84m ³ Tank
No DRAWING Surveyed by: Drawn by: Designed by: Checked by:	Date TITLE : OGOKC IN R.K Luks A.B A.B FEBRUA	ANYIRIBU & NYAGAK TAKE COMMUNITY 84m ³ Tank

9590 64H12(50)-150 'U' Bars 20 100x10mm thick MS plate anchored in concrete and laid level to receive tank 50, 150, 50 plate flanges <u>72H12(01)-150</u> T&B 72H12(50)-150 'U' Bars 72H12(50)-150 'U' Bars 250 2000 10060 10860 Site <u>Dimens</u>ion 64H12(02)-150 T&B 500 A A ↓ 400 ↓ DWARF WALL DETAIL SCALE 1:20 400 50 64H12(50)—150 'U' Bars _L' FOUNDATION LAYOUT SCALE 1:50 <u>50 150 50</u> 150 67H12(30)-150 U Bars 67H16(04)-150 N.F&F.F 1000 1220 1220 1220 1220 1220 1220 1220 2x7H12(06)-150 N.F&F.F 2(30)-150 500 Site Dimension dimension 1000 RAFT FOUNDATION <u>2x10H12(</u>06)-150 N.F&F.F N.S. 400 50mm THICK BLINDING 06 2/H16(04)-150 + 400 01 01 01 01 01 01 DWARF WALL RC DETAIL 010 92 SCALE 1:20

	GENERAL N	OTES
1.	This drawing shall with all relevant dra	pe read in conjunction awings.
2.	aggregate size b. Reinforced concre cube strength of	have a minimum gth of 15N/mm ² and 20 mm maximum ste to have works 30N/mm ² cylinder mm ² with 20mm ate size UNLESS
3.	Reinforcement High tensile bars formed bars to c. Mild steel to be 4449 d. Mesh reinforceme requirement of B	to be ribbed cold 3.S. 4461 round bars to B.S. ent to comply with
4.	Minimum cover to	all steel 50.
5.	THE QUALITY OF AL WORKMANSHIP SHAL REQUIREMENTS OF ISSUES OF RELEVAN STANDARDS AND CO	L COMPLY WITH THE THE MOST RECENT T EUROPEAN
1. 2. 3. 4. 5. 6. 7.	Approved stopper installed in all joir Engineer. Contractor to use in tying formwork Construction befor Construction befor All Pipes going th paddle flange Diameter of pipes by M&E before co All position of ser	b be cast at once water bar to be tts as directed by the non recoverable ties for nit methodology for e commencing work. rough walls to have to first be confirmed noreting. vices i.e pipes passing to be confirmed by
		C OF UGANDA AND ENVIRONMENT ATER DEVELOPMENT
CONSULT	ANT :	
A	CONSULTING ENG	
	In Associatio	
	Infra-Cons	
	.BOX 33975 KAMPALA ail: allainceconsultantsIt	
	ORA WATER SU SY	PPLY AND SANITATION STEM AND SANITATION SYSTEM
REVISIO	NS :	
No	Date	Description
L	1	
D		DIRIBA m ³ Tank
DRAWING		m°Tank
	296	m° Tank
DRAWING Surveyed by: Drawn by:	296	m° Tank
Surveyed by:	296 R.K Luks	т" Тапк
Surveyed by: Drawn by: Designed by: Checked by:	296 R.K Luks A.B A.B	
Surveyed by: Drawn by: Designed by: Checked by: Date:	296 R.K Luks A.B FEBRUA	ARY 2023
Surveyed by: Drawn by: Designed by: Checked by:	296 R.K Luks A.B A.B	ARY 2023

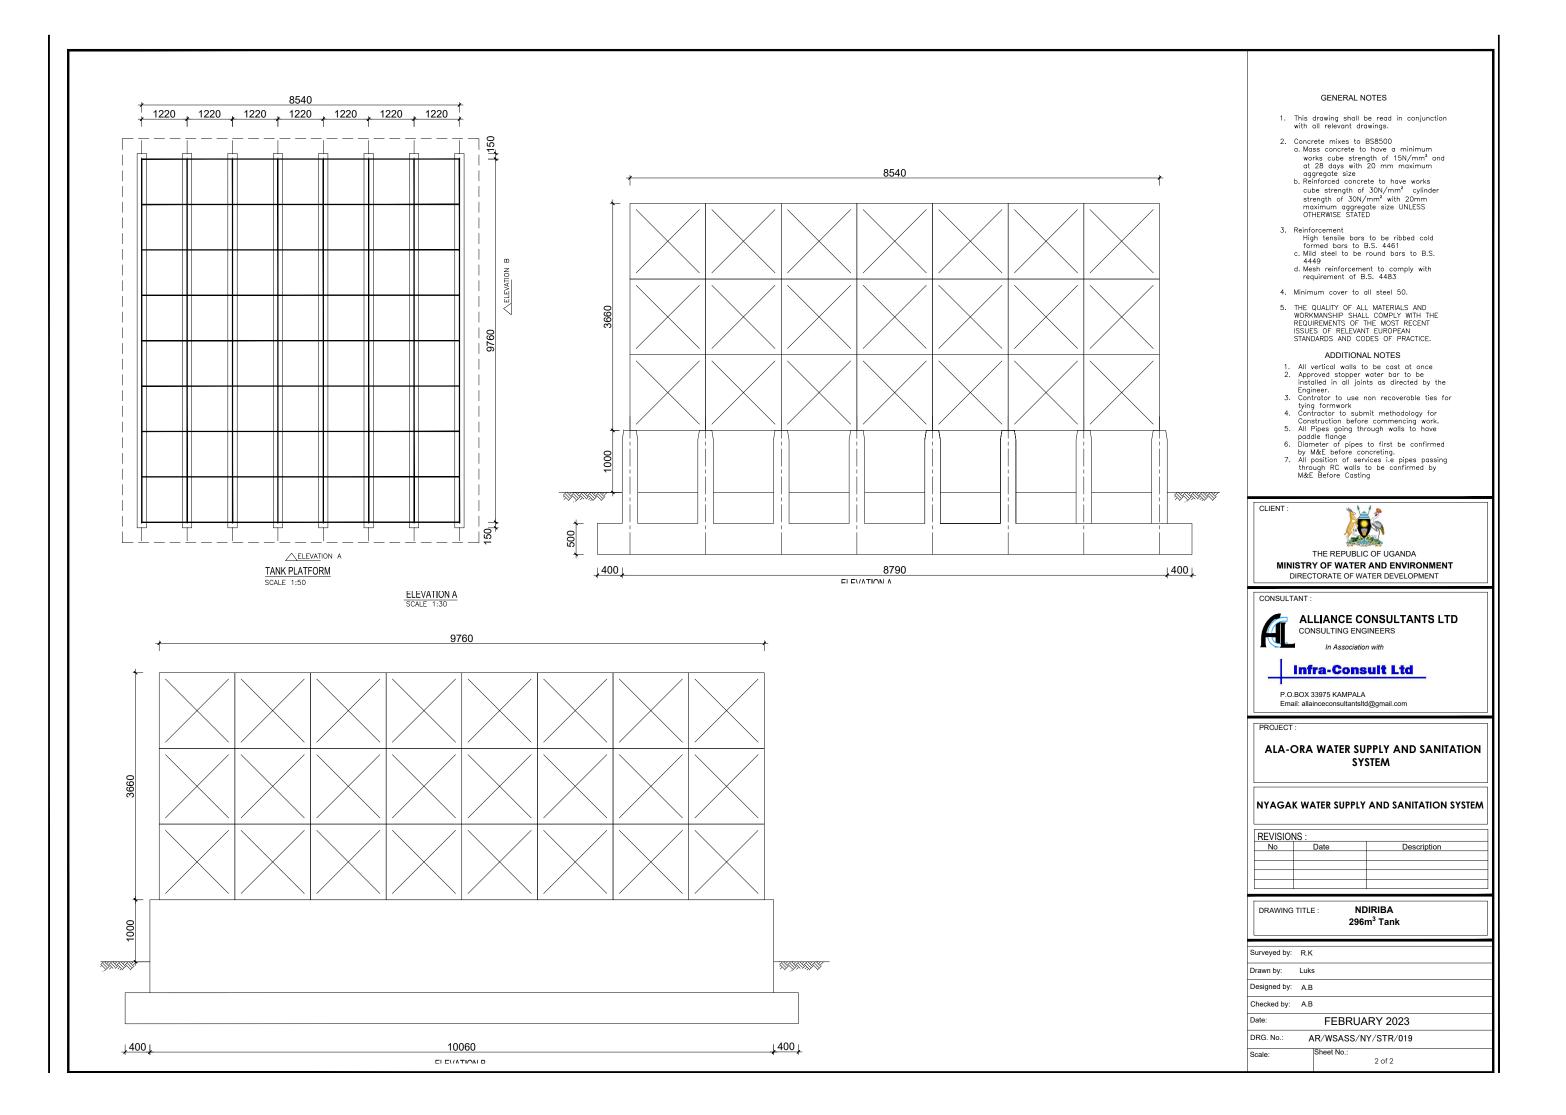

GENERAL NOTES FOR STANDARD DETAIL DRAWINGS

- 1. Unless flexibility is otherwise provided, where pipes enter or leave concrete structures, or anchor blocks, flexible joints are to be provided as shown.
- 2. Anchor block designs are based on the following ground conditions.
 - Dry soil density: 1800 kg/m 3
 - Submerged soil density: 1090 kg/m
 - Angle of internal friction: 30°
 - Passive resistance factor: 3
 - Where considerably better ground conditions, such as rock, are encountered, the dimensions of anchor blocks may be reduced. Supporting calculations for any reduced size anchor blocks must be submitted to the Project Manager 48 hours before construction of the particular anchor block commences and maybe concreted only after his approval.
- 3. Bases and thrust faces of anchor blocks are to be cast against undisturbed ground, or against blinding cast against undisturbed ground.
- 4. Pipe work joints as shown for the water supply details are diagrammatic only.
- 5. The following notes apply to reinforced concrete chambers.
 - a. Concrete in walls and base and cover slab 2 Characteristic strength (N/mm): 30

Maximum aggregate size (mm): 20

Cement type: SR 3

Minimum cement content (kg/m): 330 3

- Maximum cement content (kg/m): 400
- Maximum free water/cement ratio: 0.47
- b. Concrete in blinding 2

Characteristic strength (N/mm): 1030

- Maximum aggregate size (mm): 40
- Cement type: SR 3
- Minimum cement content (kg/m): 230
- c. Cover to reinforcement 40mm unless positioned centrally
 - Minimum reinforcement lap 300 mm
 - For details of step irons see Standard Detail Ala-ora-SD-009
 - Corners of rectangular openings to have T8 bars 500 mm long set diagonally
- 6. All dimensions are in millimeters unless shown otherwise.
- 7. Do not scale dimensions from standard Detail drawings.

1. References

All engineering Drawings shall be read in conjunction with Specifications.Any discrepancies should be reported to the Supervising Engineer.

- 2. Dimensions
- All dimensions are in millimeters (unless stated otherwise)
- 3. Foundations

Foundations have been designed on bearing pressure of 200 KN/m² foundation depth to be determined by engineer prior to placing minimum foundation depth to be 1000mm below floor concrete. Level or 600 mm below Splash Apron level whichever is critical maximum allowable fill below ground slab = 500 mm

4. Block work

All Load bearing block walls to be constructed from solid block characteristic compression strength complying of 5.0 N/mm Min. with BS 5620 Part1 1978 Structural use of Unreinforced Masonry Mortar to conform to mortar designation (iii) of Table 1 BS 5620 Part1

5. Concrete

PROPOSED USE	GRADE	PERMITT AGGRE	GATES	MAX. SIZE AGGREGATES	WORK	
		COARSE	FINE	AGOILOAILO		
Reinforced conc. (including ground bearing slab)	C 25	BS 882	BS 882	20mm	Med (75)	
Concrete containing no embedded metal	C 15	BS 882	BS 882	40mm	Med (75)	
Blinding Concrete	C 7.5	BS 882	BS 882	20mm	Med (75)	
Concrete in minor elements e.g lintels	C 25	BS 882	BS 882	10mm	Med (75)	

COVER

LOCATION	COVER
To Mesh in ground slab	30mm
Columns (cover to links)	25mm
Slabs (cover to main bars)	25mm
Foundations	50mm
Top and bottom slides	75mm

6. Joints

Movement joints to be at a maximum 9.0m centres. Joint positions as indica drg. Joint in salb to be carried through walls to underside of ring beam

7. Wall ties

Provide masonry anchors every 2 courses using galvanised. Mild steel deb to BS 1243 . 1978


8. Reinforcement

- Reinforcement to be in accordance with consulting engineer's specification. R - - - - - Denotes round mild steel bars
 - T - - Denotes high yield bond strength bars.

NOTES


- 1. All dimensions in mm unless otherwise stated
- 2. Where it is stated " Site Dimension " the measurement is to be determ site.

	LEGEND
	CLIENT :
KABILITY	
	THE REPUBLIC OF UGANDA
dium	MINISTRY OF WATER AND ENVIRONMENT
)	CO-FINANCED BY:
dium	
)	IDED • ILLA WORLD BARKGROUP
dium	CONSULTANT :
)	Alliance Consultants Itd
dium)	In Association with
,	Infra-Consult Ltd
	PROJECT :
	ALA-ORA WATER SUPPLY AND
	SANITATION PROJECT
	NYAGAK WATER SUPPLY AND
	SANITATION SYSTEM
atad cr	REVISIONS : No Date Description
ated on	
ond ties	
	DRAWING TITLE : STANDARD DRAWINGS General Notes
	Surveyed by: R.K
	Drawn by: N.R Designed by:
	W.G.M Checked by:
	J.K.K Date:
nined on	January 2023 DRG. No.: ALA-ORA-SD-000
	Scale: Sheet No.: 1:120 1 of 1

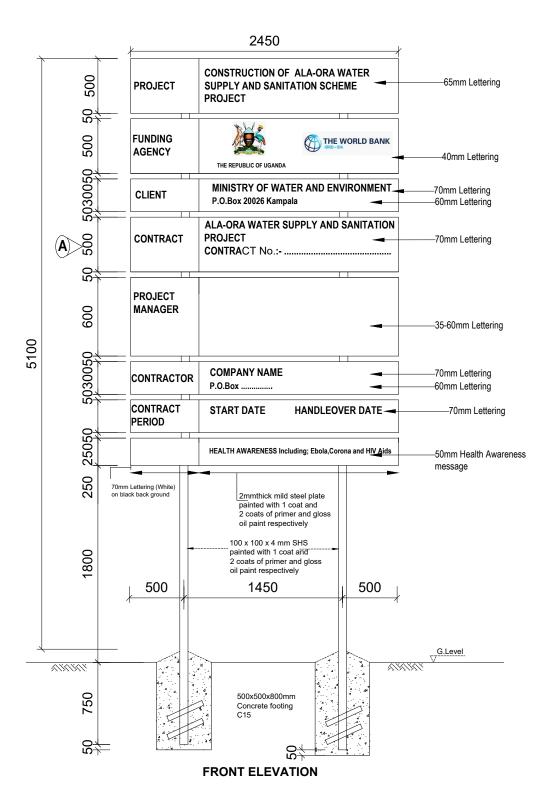


NOTES


- Project Signboards are to be double faced
- The Plates to be printed white and Words to be in black include all Logos.

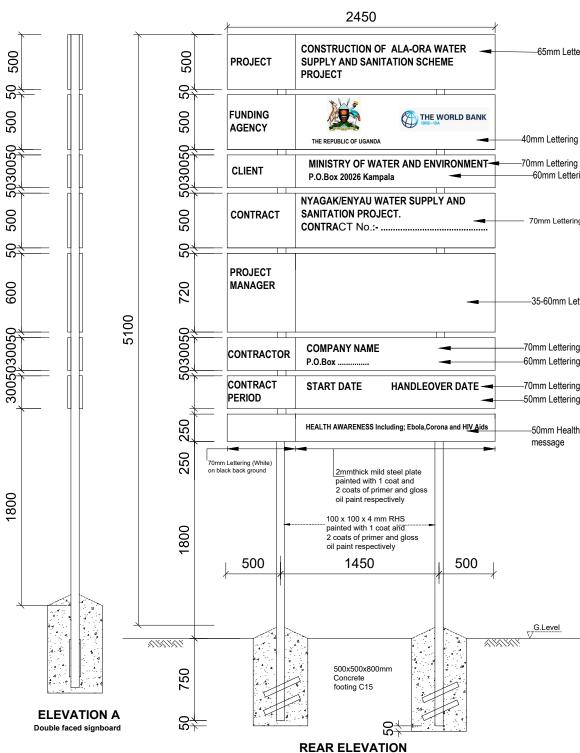


	LEGEND
ering	
_	
g g ring	
ng	
ettering	
g g	CLIENT : THE REPUBLIC OF UGANDA MINISTRY OF WATER AND ENVIRONMENT
g h Awareness	CO-FINANCED BY:
	CONSULTANT : Alliance Consultants Itd
	In Association with
	PROJECT : ALA-ORA WATER SUPPLY AND SANITATION PROJECT NYAGAK WATER SUPPLY AND SANITATION SYSTEM
	PROJECT : ALA-ORA WATER SUPPLY AND SANITATION PROJECT NYAGAK WATER SUPPLY AND
	PROJECT : ALA-ORA WATER SUPPLY AND SANITATION PROJECT NYAGAK WATER SUPPLY AND SANITATION SYSTEM
	Infra-Consult Ltd PROJECT : ALA-ORA WATER SUPPLY AND SANITATION PROJECT NYAGAK WATER SUPPLY AND SANITATION SYSTEM REVISIONS : No Date Design Board
	Infra-Consult Ltd PROJECT : ALA-ORA WATER SUPPLY AND SANITATION PROJECT NYAGAK WATER SUPPLY AND SANITATION SYSTEM REVISIONS : No Date Date Description Drawing TITLE : STANDARD DRAWINGS Sign Board Surveyed by: R.K Drawn by: N.R Designed by: N.R

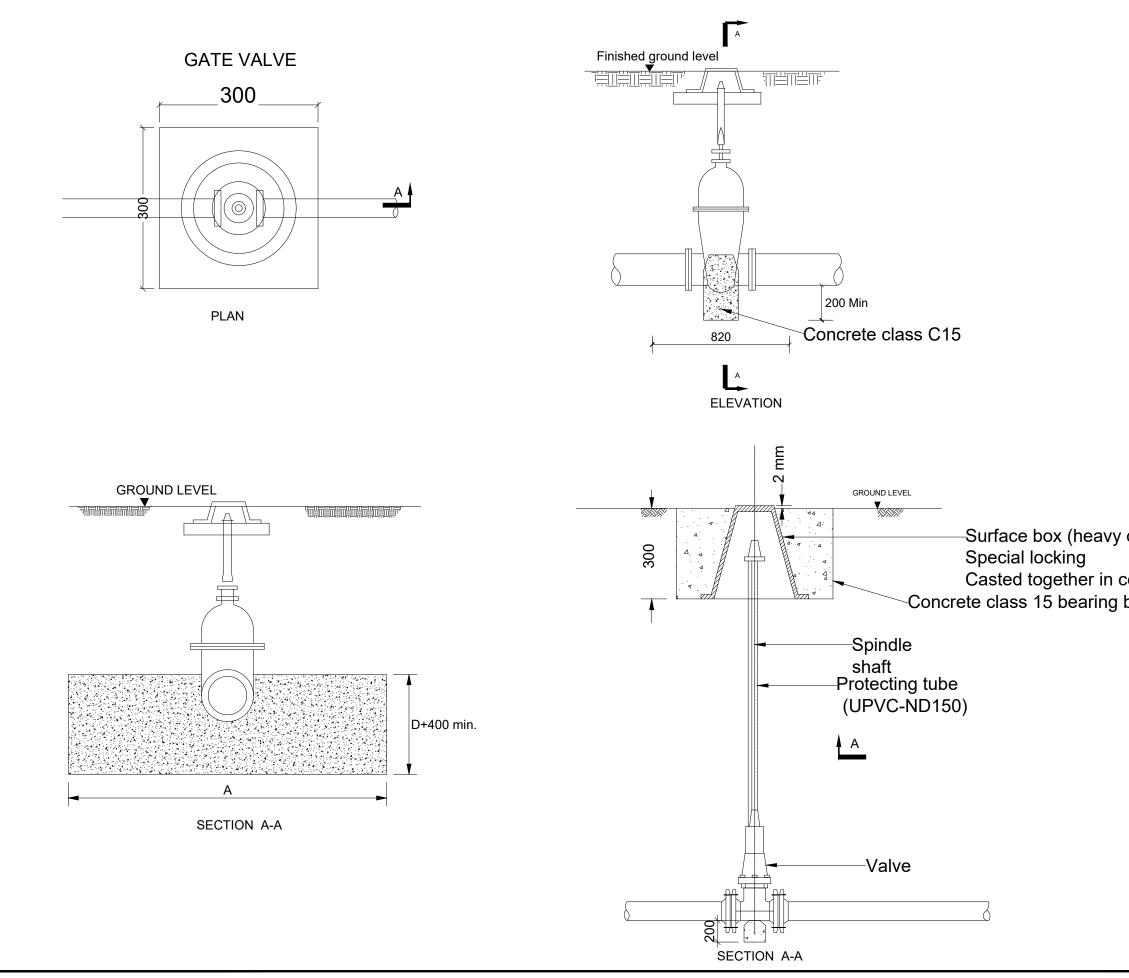



	LEGEND						
	CLIENT :						
	THE REPUBLIC OF UGANDA MINISTRY OF WATER AND ENVIRONMENT CO-FINANCED BY:						
/ duty type)	CONSULTANT : Alliance Consultants Itd						
concrete	In Association with						
block	PROJECT :						
	ALA-ORA WATER SUPPLY AND SANITATION PROJECT						
	NYAGAK WATER SUPPLY AND SANITATION SYSTEM						
	REVISIONS : No Date Description						
	DRAWING TITLE : STANDARD DRAWINGS Gate Valve and Surface Box						
	Surveyed by:						
	R.K Drawn by: N.R						
	Designed by: W.G.M						
	Checked by: J.K.K Date:						
	DRG. No.: ALA-ORA-SD-002						
	Scale: Sheet No.: 1:120 1 of 1						

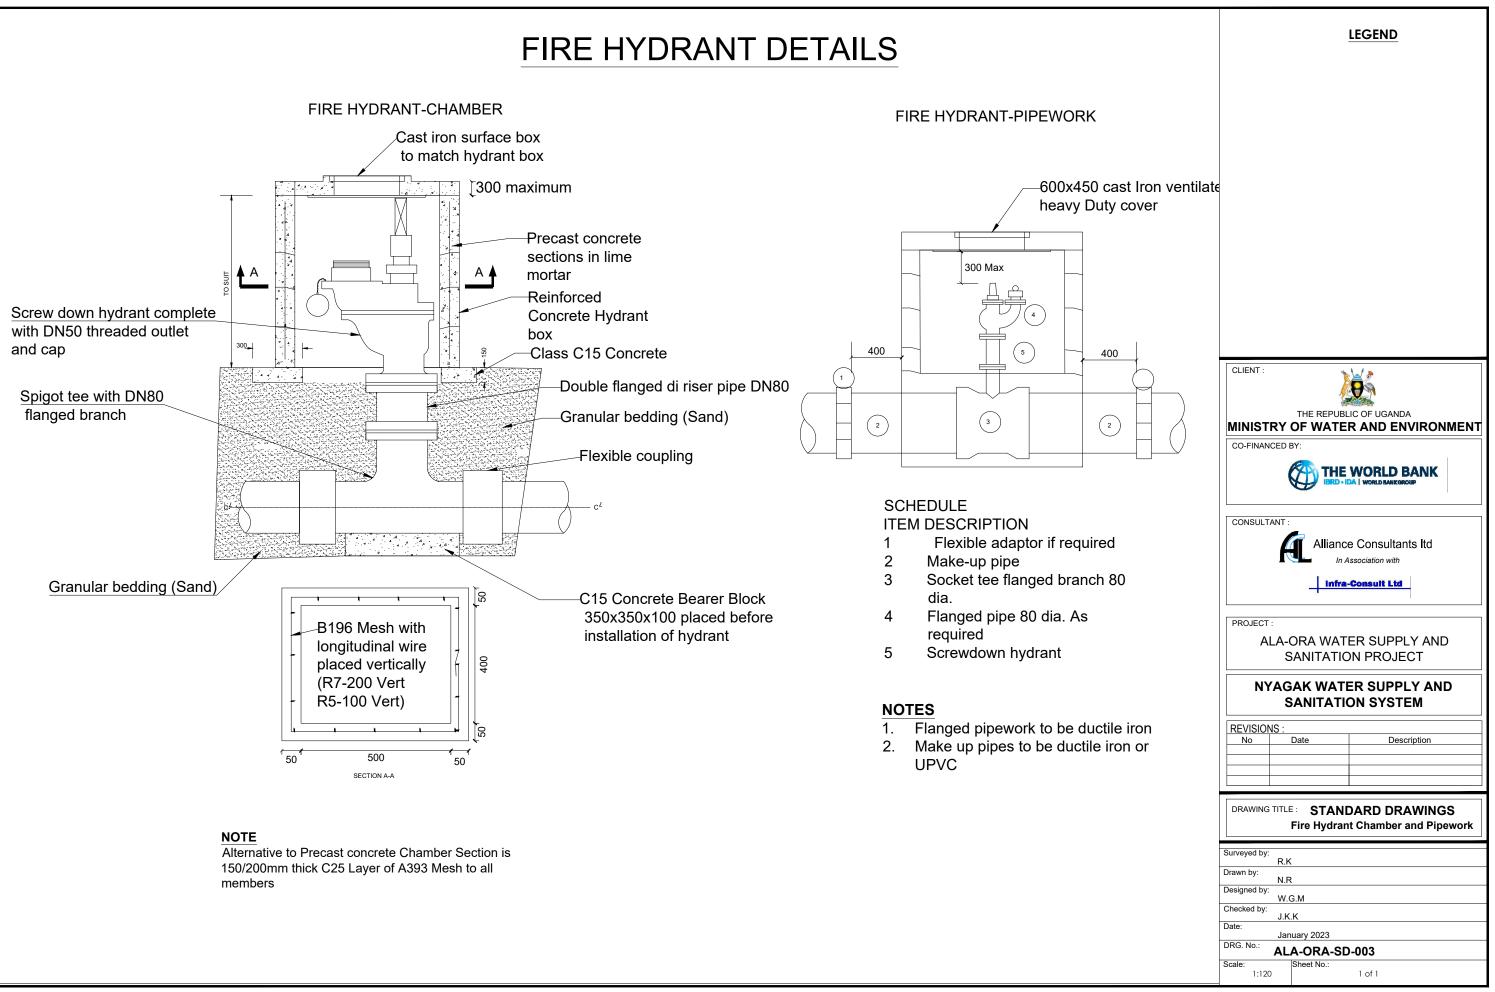

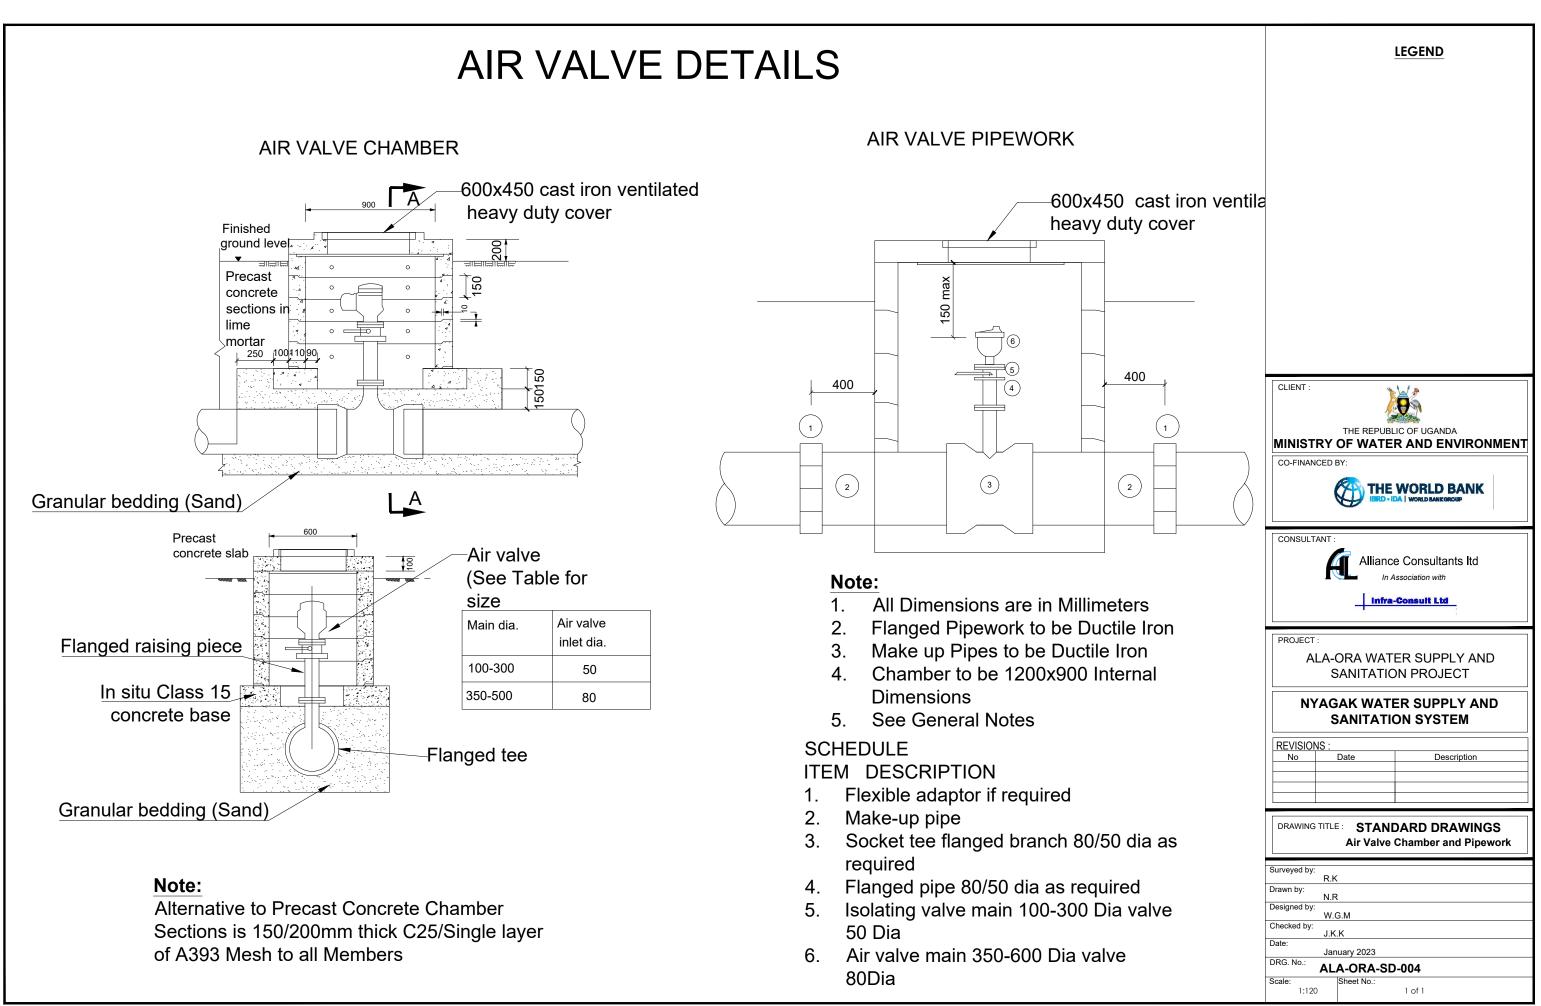


WASHOUT CHAMBER

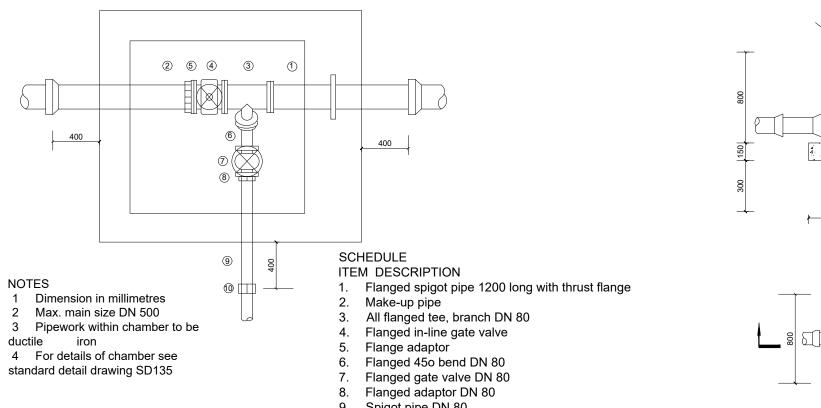

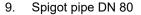


10. Flexible adaptor if required

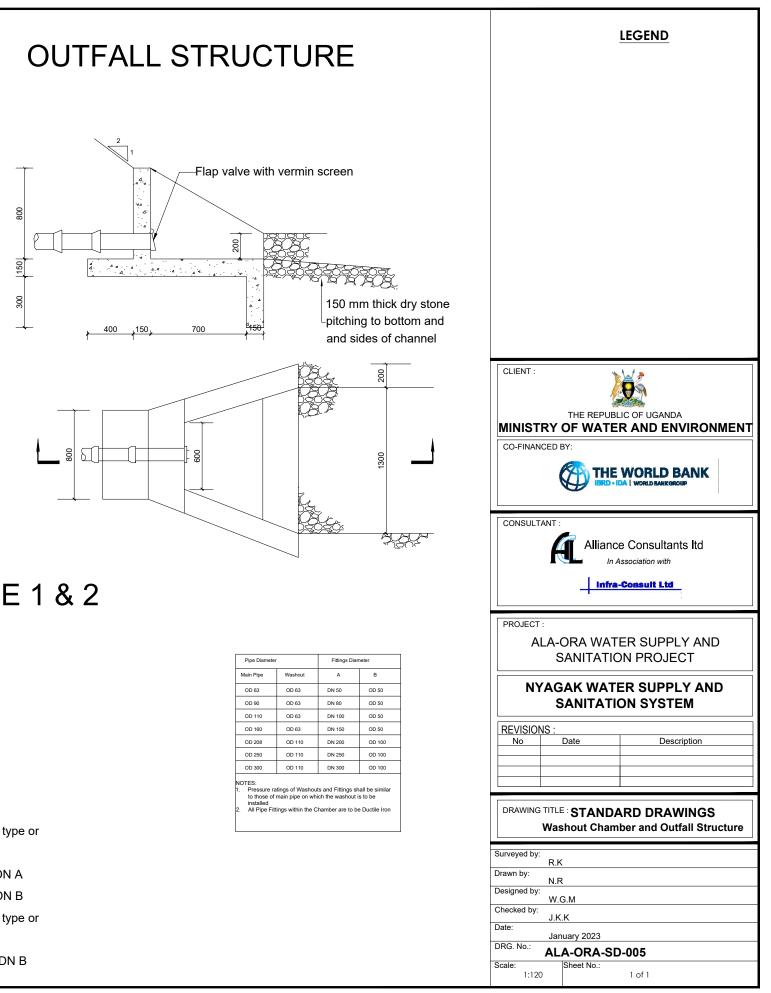


WASHOUT DETAILS TYPE 1 & 2


WO TYPE 1

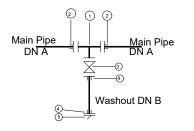


1 1No CI Flanged Tee DN A/B (2) 2No DI Flange Adaptor, Maxi type or similar type DN A ③ 1No CI Flanged Gate Valve DN A (4)1No DI Flange Adaptor, Maxi type or similar DN B (5) 1 No. D1 Flanged Flap Valve DN B

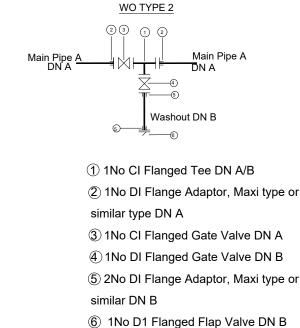

Pipe Diamete	ır	Fittings Diameter				
Main Pipe	Washout	A	В			
OD 63	OD 63	DN 50	OD 50			
OD 90	OD 63	DN 80	OD 50			
OD 110	OD 63	DN 100	OD 50			
OD 160	OD 63	DN 150	OD 50			
OD 208	OD 110	DN 200	OD 100			
OD 250	OD 110	DN 250	OD 100			
OD 300	OD 110	DN 300	OD 100			

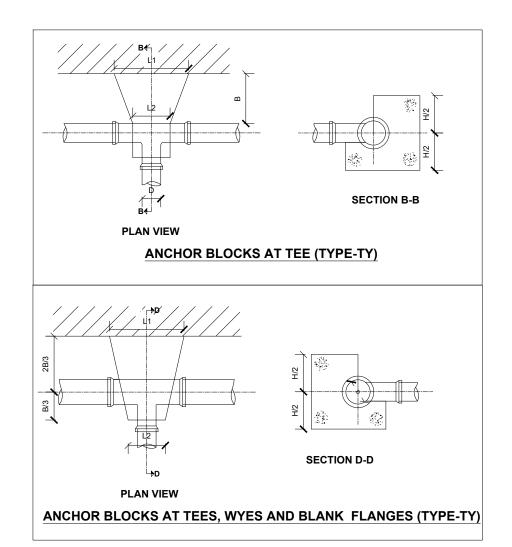


TEES (TYPE-TY)					TEES (TYPE-TY)						
BRANCH SIZE	TEST PRESSURE					BRANCH SIZE	TEST PRESSURE				
ND (mm)	m	L1 m	L2 m	Вm	Hm	ND (mm)	m	L1 m	L2 m	Вm	Hm
	250	0.40	0.20	0.40	0.30		250	0.50	0.25	0.50	0.40
	225	0.40	0.20	0.40	0.30		225	0.50	0.25	0.50	0.40
50	180	0.40	0.20	0.40	0.30	80	180	0.50	0.25	0.50	0.40
	135	0.40	0.20	0.40	0.30		135	0.50	0.25	0.50	0.40
	90	0.40	0.20	0.40	0.30		90	0.50	0.25	0.50	0.40
BRANCH SIZE	TEST PRESSURE					BRANCH SIZE	TEST PRESSURE				
ND (mm)	m	L1 m	L2 m	Вm	Hm	ND (mm)	m	L1 m	L2 m	Вm	Hm
	250	0.60	0.30	0.60	0.50	150	250	0.70	0.40	0.60	0.50
	225	0.60	0.30	0.60	0.50		225	0.70	0.40	0.60	0.50
100	180	0.60	0.30	0.60	0.50		180	0.70	0.40	0.60	0.50
	135	0.60	0.30	0.60	0.50		135	0.70	0.40	0.60	0.50
	90	0.60	0.30	0.60	0.50		90	0.70	0.40	0.60	0.50

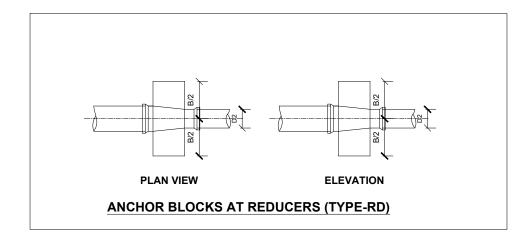

RE	DUCERS (TYI	PE-RD))		RE	DUCERS (TY	PE-RI))		RE	DUCERS (TY	PE-RD))	
NOMINAL DIAMETER	TEST PRESSURE				NOMINAL DIAMETER	TEST PRESSURE				NOMINAL DIAMETER	TEST PRESSURE			
mm	m	Lm	Вm	Hm	mm	m	Lm	Вm	Hm	mm	m	Lm	Вm	Hm
	250	0.35	0.50	0.55		250	0.40	0.70	0.45		250	0.40	0.75	0.55
	225	0.35	0.50	0.50		225	0.40	0.70	0.45		225	0.40	0.70	0.55
100/80	180	0.35	0.50	0.45	150/80	180	0.40	0.65	0.40	100/150	180	0.40	0.60	0.50
	135	0.35	0.50	0.40		135	0.40	0.60	0.40		135	0.40	0.60	0.45
	90	0.35	0.50	0.40		90	0.40	0.60	0.40		90	0.40	0.60	0.40

		LEGEND	
CLIENT :)	9	
MINISTRY		LIC OF UGANDA R AND ENVIRONN	IENT
CO-FINANCED E			
		WORLD BANK	
CONSULTANT :	Allianc	e Consultants Itd	
		Ssociation with	
PROJECT :	-		
		ER SUPPLY AND ON PROJECT	
		ER SUPPLY AND ON SYSTEM	
REVISIONS :	Date	Description	
DRAWING TITLE	STANDA Ancho	RD DRAWINGS or Block Details	
Surveyed by: R.K			
Drawn by: N.R Designed by:			
W.C Checked by:			
J.K. Date:	K uary 2023		
DRG No .	A-ORA-S	0-006	
Scale: 1:120	Sheet No.:	1 of 3	


	VEF	VERTICAL BENDS - DEPRESSIONS (TYPE-DV)											
NOMINAL DIAMETER	TEST PRESSURE		45° B	BEND		:	22½°	BEND			11¼°	BEND)
mm	m	L1 m	L2 m	Вm	Hm	L1 m	L2 m	Вm	Hm	L1 m	L2 m	Вm	Нm
	250	0.40	0.16	0.30	0.50	0.40	0.16	0.30	0.50	0.40	0.16	0.20	0.50
80	225	0.40	0.16	0.27	0.50	0.40	0.16	0.30	0.50	0.40	0.16	0.20	0.50
	180	0.40	0.16	0.30	0.50	0.40	0.16	0.30	0.50	0.40	0.16	0.20	0.50
	135	0.40	0.16	0.30	0.50	0.40	0.16	0.30	0.50	0.40	0.16	0.20	0.50
	90	0.40	0.16	0.30	0.50	0.40	0.16	0.30	0.50	0.40	0.16	0.20	0.50

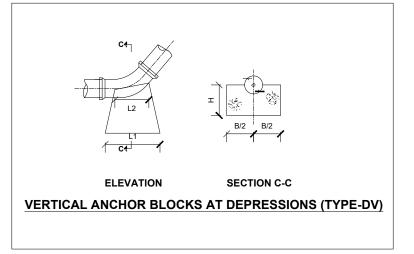

NOMINAL DIAMETER	TEST PRESSURE		45° E	BEND			22½°	BEND)		11¼°	BEND)
mm	m	L1 m	L2 m	Вm	Hm	L1 m	L2 m	Вm	Hm	L1m	L2m	Вm	Hm
	250	0.80	0.30	0.40	0.55	0.70	0.30	0.30	0.55	0.50	0.30	0.30	0.55
	225	0.70	0.30	0.40	0.55	0.60	0.30	0.30	0.55	0.50	0.30	0.30	0.55
150	180	0.70	0.30	0.40	0.55	0.50	0.30	0.30	0.55	0.50	0.30	0.30	0.55
	135	0.70	0.30	0.40	0.55	0.50	0.30	0.30	0.55	0.40	0.30	0.30	0.55
	90	0.70	0.30	0.40	0.55	0.40	0.30	0.30	0.55	0.40	0.30	0.30	0.55

NOMINAL DIAMETER	TEST PRESSURE		45° E	BEND			22½°	BEND)		11¼°	BEND)
mm	m	L1 m	L2 m	Вm	Hm	L1 m	L2 m	Вm	Hm	L1 m	L2m	Вm	Hm
	250	0.40	0.20	0.30	0.50	0.40	0.20	0.30	0.50	0.40	0.20	0.20	0.50
	225	0.40	0.20	0.30	0.50	0.40	0.20	0.30	0.50	0.40	0.20	0.20	0.50
100	180	0.40	0.20	0.30	0.50	0.40	0.20	0.30	0.50	0.40	0.20	0.20	0.50
	135	0.40	0.20	0.30	0.50	0.40	0.20	0.30	0.50	0.40	0.20	0.20	0.50
	90	0.40	0.20	0.30	0.50	0.40	0.20	0.30	0.50	0.40	0.20	0.20	0.50


				н	ORIZ	ΟΝΤΑ	L BEN	IDS (T	YPE-	HB)							
NOMINAL DIAMETER	TEST PRESSURE		90° E	BEND			45° E	BEND			22½°	BEND)		11¼°	BEND)
mm	m	L1 m	L2 m	Вm	Hm	L1 m	L2 m	Вm	Hm	L1 m	L2 m	Вm	Hm	L1m	L2m	Вm	Hm
	250	1.00	0.24	0.35	0.50	0.60	0.24	0.30	0.40	0.50	0.24	0.20	0.20	0.40	0.24	0.20	0.20
	225	0.60	0.24	0.35	0.40	0.50	0.24	0.25	0.30	0.40	0.24	0.20	0.20	0.30	0.24	0.20	0.20
80	180	0.60	0.24	0.35	0.30	0.50	0.24	0.23	0.25	0.40	0.24	0.20	0.20	0.30	0.24	0.20	0.20
	135	0.60	0.24	0.35	0.30	0.50	0.24	0.20	0.20	0.40	0.24	0.20	0.20	0.30	0.24	0.20	0.20
	90	0.60	0.24	0.35	0.20	0.50	0.24	0.20	0.20	0.40	0.24	0.20	0.20	0.30	0.24	0.20	0.20

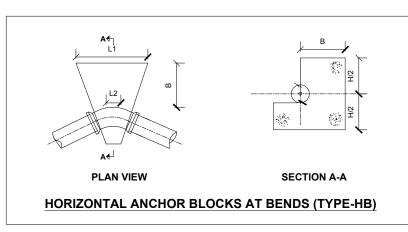

		22½°	BEND)		11¼°	BEND)	NOMINAL DIAMETER	TEST PRESSURE		90° E	BEND			45° E	BEND			22⅓°	BEND)		11¼°	BEND)
m	L1 m	L2 m	Bm	Hm	L1m	L2m	Bm	Hm	mm	m	L1 m	L2 m	Bm	Hm	L1 m	L2 m	Вm	Hm	L1 m	L2 m	Вm	Hm	L1m	L2 m	Bm	Hm
										250	1.00	0.30	0.35	0.50	0.80	0.30	0.80	0.80	0.80	0.30	0.60	0.60	0.60	0.30	0.60	0.60
.80	0.80	0.45	0.70	0.70	0.60	0.45	0.60	0.60		225	0.90	0.30	0.30	0.40	0.60	0.30	0.80	0.80	0.80	0.30	0.60	0.60	0.60	0.30	0.60	0.60
.80	0.80	0.45	0.70	0.70	0.60	0.45	0.60	0.60	100	180	0.60	0.30	0.25	0.30	0.60	0.30	0.80	0.80	0.80	0.30	0.60	0.60	0.60	0.30	0.60	0.60
.80	0.80	0.45	0.70	0.70	0.60	0.45	0.60	0.60		135	0.60	0.30	0.25	0.30	0.60	0.30	0.80	0.80	0.60	0.30	0.60	0.60	0.60	0.30	0.60	0.60
.80	0.60	0.45	0.70	0.70	0.60	0.45	0.60	0.60		90	0.60	0.30	0.20	0.20	0.60	0.30	0.80	0.80	0.60	0.30	0.60	0.60	0.60	0.30	0.60	0.60
.80	0.60	0.45	0.70	0.70	0.60	0.45	0.60	0.60	L	1	1	1	I	1	1	1		1		1		[[[L	L

NOMINAL DIAMETER	TEST PRESSURE		90° E	BEND	-		45° E	BEND			221⁄2°	BEND			11¼°	BEND)
mm	m	L1 m	L2 m	Вm	Hm	L1 m	L2 m	Вm	Hm	L1 m	L2 m	Вm	Hm	L1m	L2m	Вm	Hm
	250	1.20	0.45	0.80	0.80	0.80	0.45	0.80	0.80	0.80	0.45	0.70	0.70	0.60	0.45	0.60	0.60
	225	1.20	0.45	0.80	0.80	0.80	0.45	0.80	0.80	0.80	0.45	0.70	0.70	0.60	0.45	0.60	0.60
150	180	1.00	0.45	0.80	0.80	0.80	0.45	0.80	0.80	0.80	0.45	0.70	0.70	0.60	0.45	0.60	0.60
	135	1.00	0.45	0.60	0.60	0.80	0.45	0.80	0.80	0.60	0.45	0.70	0.70	0.60	0.45	0.60	0.60
	90	1.00	0.45	0.60	0.60	0.60	0.45	0.80	0.80	0.60	0.45	0.70	0.70	0.60	0.45	0.60	0.60

		LEGEND
CLIENT :)	
		IC OF UGANDA
CO-FINANCED E		R AND ENVIRONMENT
CONSULTANT :	5	
		e Consultants Itd
	Infra	Consult Ltd
PROJECT :		
		ER SUPPLY AND
		ER SUPPLY AND ON SYSTEM
REVISIONS :	Date	Description
DRAWING TITLE		RD DRAWINGS Block Details
Surveyed by: R.K		
Drawn by: N.R		
Designed by: W.C Checked by:	G.M	
J.K.		
DRG No .	uary 2023 A-ORA-SD	0-006
Scale: 1:120	Sheet No.:	2 of 3
20		

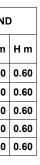

NOMINAL DIAMETER	TEST PRESSURE	45	5° BEN	ID	221	∕₂° BE	ND	11	∕₄° BE	ND
mm	m	Lm	Вm	Hm	Lm	Вm	Hm	Lm	Вm	Нn
	250	1.40	0.70	0.80	1.20	0.70	0.80	1.20	0.70	0.8
	225	1.20	0.70	0.80	1.20	0.70	0.80	1.20	0.70	0.8
100	180	1.20	0.70	0.80	1.20	0.70	0.80	1.20	0.70	0.8
	135	1.20	0.70	0.80	1.20	0.70	0.80	1.20	0.70	0.8
	90	1.20	0.70	0.80	1.20	0.70	0.80	1.20	0.70	0.8
	VE	RTIC	AL BE	NDS	(TYPE	-CV)				
NOMINAL DIAMETER	TEST PRESSURE	45	5° BEN	ID	22 ¹	∕₂° BE	ND	11	∕₄° BE	ND
mm	m	Lm	Вm	Hm	Lm	Вm	Hm	Lm	Вm	Нr
	250	1.40	0.70	0.80	1.20	0.70	0.80	1.20	0.70	0.8
	225	1.20	0.70	0.80	1.20	0.70	0.80	1.20	0.70	0.8
80	180	1.20	0.70	0.80	1.20	0.70	0.80	1.20	0.70	0.8
	135	1.20	0.70	0.80	1.20	0.70	0.80	1.20	0.70	0.8
	90	1.20	0.70	0.80	1.20	0.70	0.80	1.20	0.70	0.8

Anchor blocks to be constructed from unreinforced concrete class 20. 1.


2. Concrete to be casted and undisturbed soil, where disturbed soil around the anchor blocks either to be removed and filled with concrete before pressure testing, or soil to be compacted to not less than 95% max. dry density before the mass is pressure tested.

3. 11¹/₄° bends to be used for bends >=6° and =<16°


4. Anchor blocks to be cast to leave all pipe joints free.

5. Shuttered surfaces to be suitable to receive backfill or further concrete framework suitable to precast loss of ground fibrated.

6. The p.v.c bends shall be covered with three layers of polythene sheeting before concreteing.

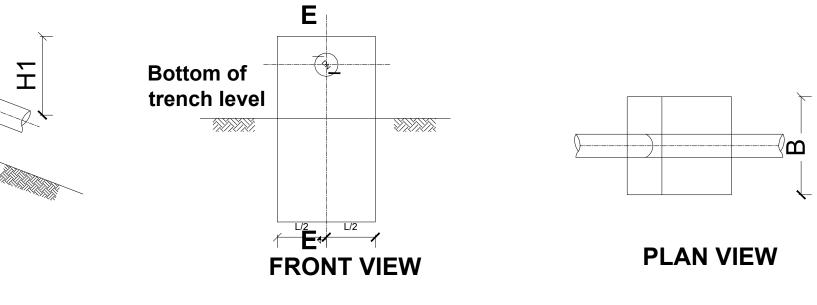


ANCHOR BLOCKS ON GRADIENTS (TYPE-GD)

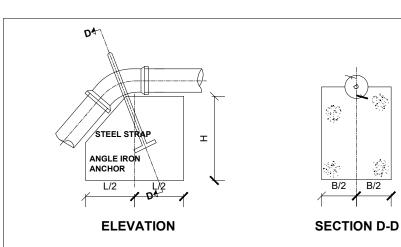

VERTICAL ANCHOR BLOCKS AT CRESTS


1

NOMINAL DIAMETER	TEST PRESSURE	45	5° BEN	ND	221	∕₂° BE	ND	11	∕₄° BE	ND
mm	m	Lm	Вm	Hm	Lm	Вm	Hm	Lm	Вm	Hm
	250	1.70	1.10	0.80	1.30	0.90	0.80	1.00	0.70	0.60
	225	1.50	1.10	0.80	1.20	0.80	0.80	1.00	0.70	0.60
150	180	1.50	1.10	0.70	1.10	0.80	0.80	1.00	0.70	0.60
	135	1.40	0.90	0.70	1.00	0.70	0.80	1.00	0.70	0.60
	90	1.20	0.80	0.60	0.90	0.70	0.80	1.00	0.70	0.60

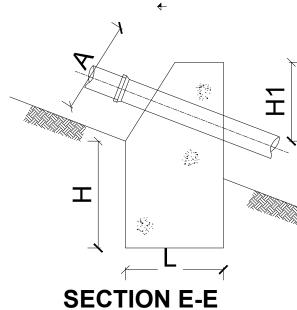

	LEGEND
CLIENT :	
THE REPUBL	LIC OF UGANDA
MINISTRY OF WATE	R AND ENVIRONMENT
CO-FINANCED BY:	
CONSULTANT :	
	e Consultants Itd
	Association with
	Jonstant Lta
PROJECT :	
	ER SUPPLY AND
	ER SUPPLY AND
	ON SYSTEM
REVISIONS :	Description
No Date	Description
	ARD DRAWINGS or Block Details
Anch Surveyed by:	
Anch Surveyed by: R.K Drawn by: N.R	
Anch Surveyed by: R.K Drawn by: N.R Designed by: W.G.M	
Anch Surveyed by: R.K Drawn by: N.R Designed by: W.G.M Checked by: J.K.K	
Anch Surveyed by: R.K Drawn by: N.R Designed by: W.G.M Checked by: J.K.K Date: January 2023	
Anch Surveyed by: R.K Drawn by: N.R Designed by: W.G.M Checked by: J.K.K Date:	or Block Details

TRENCHING AND BACKFILLING DETAILS

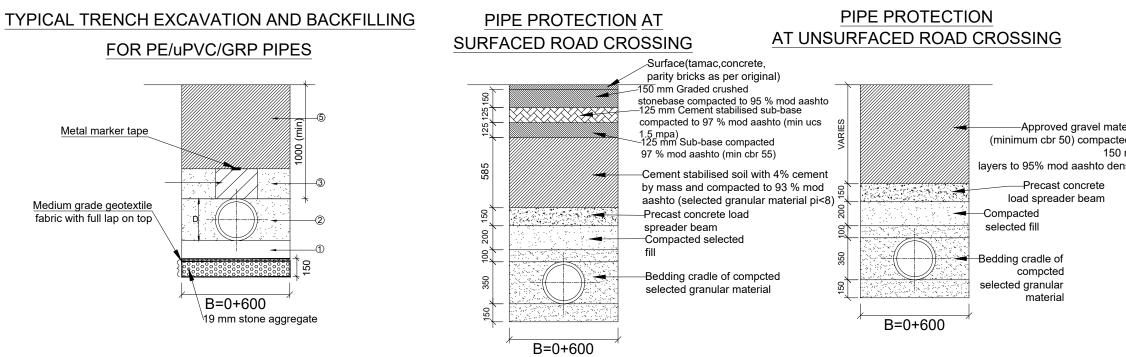

NOTES:

1. Minimum and normal trench width are defined as normal pipe diameter plus 600 mm.

2. The backfill around the pipe from the trench bottom to the crown of the pipe shall be carried out in layers whose depth shall not exceed 75 mm nor half the nominal pipe diameter whichever is the lesser.

3. The bedding required is selected by the engineer according to :

(i) Depth of cover

(ii) Diameter of pipe

(iii)Type of vehicle loading

(iv) Type of soil

4. The embedment specifies the degree of compaction required in order to fulfill design requirements.

5. In general, the method of attaining the required compaction will be ascertained as follows : (i) The engineer's representative will identify, classify and agree the soil type of

embedment material available from the trench.

(ii) The site soil type will be compared with those on the material description chart [see table 1]

(iii) The compaction method required is then selected from the compaction chart for the appropriate soil type and class of embedment [see table 2]

6. not all soils are given in table 1. it should be noted that :

(i) Fined grained soils with high plasticity may not be used as backfill

(ii)Fined grained soils with low plasticity may be condemned for use as backfill if t contractor has difficulty in attaining the required compaction.

7. Where site material is condemned, imported material shall be used. this shall be a w soil from fines upto 20 mm gravel or as approved by the engineer's representative.

8. Where some doubt exists as to the compactibility of the soil as defined above, recourble made to the modified proctor density test. the site and laboratory tests shall be carrie tests 14 b and 12 respectively to ssrn 601 the contractor shall include in his rates for bac with available soil.

9. If stones or rock are present, imported bedding material of min. 150 mm thick shall b as approved by the engineer's representative. at designated road crossings the beddin have a minimum thickness of 150 mm.

10. The backfill shall be placed in layers as defined above, each layer shall be rammed small vibratory rammer. the required number of passes of the rammer is given in table 2 event 90% mpd shall be achieved. only when there is 300 mm cover over the pipe may compacting equipment

11. Be used. the remainder of the backfill shall be suitably compacted in keeping with the reinstatement of the ground to be carried out. this shall be agreed upon with the engine representative.

12. Ferrous pipes shall be wrapped in polyethylene sleeving as corrosion protection wh directed by the engineer's representative. soil tests shall be carried out in advance of pi to ascertain requirements.

13. All dimensions are in millimetres unless stated otherwise.

	LEGEND		
erial d in mm sity	CLIENT :		
	THE REPUBLIC OF UGANDA MINISTRY OF WATER AND ENVIRONMENT CO-FINANCED BY: THE WORLD BANK INFORMATION INFORMATION INFORMATIO		
the	CONSULTANT :		
vell graded Irse shall ed out to ackfilling	CONSULTANT : Alliance Consultants Itd In Association with		
be required ng shall	PROJECT : ALA-ORA WATER SUPPLY AND SANITATION PROJECT		
l with a 2. in any ⁄ heavier	NYAGAK WATER SUPPLY AND SANITATION SYSTEM		
he eer's	No Date Date Description		
nen and as ipe laying	DRAWING TITLE : STANDARD DRAWINGS Trenching,Road Crossing and Backfilling Details		
	Surveyed by: R.K		
	Drawn by: N.R Designed by: W.G.M Checked by: J.K.K Date: Image: Checked by:		
	Date: January 2023 DRG. No.: ALA-ORA-SD-007		
	ALA-UKA-SD-007 Scale: Sheet No.: 1:120 1 of 2		
	1.120 1.012		

TYPICAL TRENCH EXCAVATION 2ND BACKFILLING FOR FERROUS PIES 150 (min)300 (min) Backfill as specified ackfill compacted to 90 % MDD

B=0+600

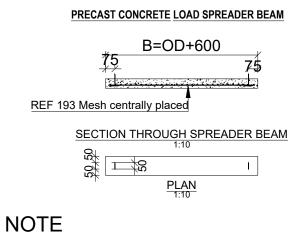


TABLE 1 : MATERIAL DESCRIPTION CHART		
SOIL TYPE	DESCRIPTION	GROUP SYMBOL
A	Angular, crushed rock negligible fines	-
В	Well graded gravel-sand mixtures few fines	GW
С	Fine Gravel,No fines	GP
D	Gravel-Sand Mix,upto 15% Fines	GF


TABLE 2 : COMPACTION CHART				
% MPD	SOIL TYPE	COMPACTIC	ON METHOD	
		Thickness of Layer (mm)	No. of Passes	
	A AND B	150	1	
90	С	150	2	
	D	75	2	

Horizontal directional drilling must be 2. undertaken where specified to the engineer's approval.

Where required by local authorities, a

concrete pipe or culvert must be used

instead of a concrete spreader beam.

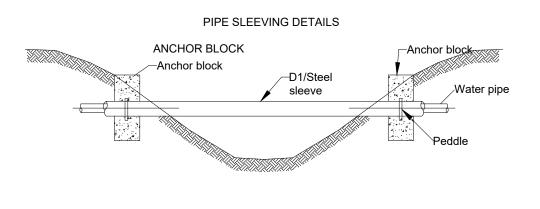


1.

LEGEND :


D pipe outside diameter approved

- 1. Granular bedding material (10 - 20 mm size) compacted in 50 mm layers to a thickness of 100 mm or as directed by the engineer's representative.
- 2. Approved granular bedding material compacted in layers as per note 2. careful tamp the pipe should be maintained to ensure equal pressure on both sides of the beddin
- 3. Approved granular bedding material compacted in shallow layers to a maximum of a,b,c and 75 mm thick type d.
- As in above, but excessive tamping to be avoided. 4.
- 5. Normal backfill material properly rammed in layers. not exceeding 150 mm thick.
- Approved granular backfill material compacted to 90 % mpd in layers as per note 2. 6.


	LEGEND
	CLIENT :
	THE REPUBLIC OF UGANDA
	MINISTRY OF WATER AND ENVIRONMENT
	CO-FINANCED BY:
	THE WORLD BANK
	CONSULTANT :
	Alliance Consultants Itd
	infra-Consult Ltd
	PROJECT :
	ALA-ORA WATER SUPPLY AND SANITATION PROJECT
	NYAGAK WATER SUPPLY AND SANITATION SYSTEM
	REVISIONS :
	No Date Description
ping on either	
ıg.	
150 mm thick	DRAWING TITLE : STANDARD DRAWINGS Trenching,Road Crossing and Backfilling Details
	Surveyed by:
	R.K Drawn by:
	N.R Designed by: W.G.M
	Checked by: J.K.K Date:
	January 2023
	ALA-ORA-SD-007 Scale: Sheet No.:
	1:120 2 of 2

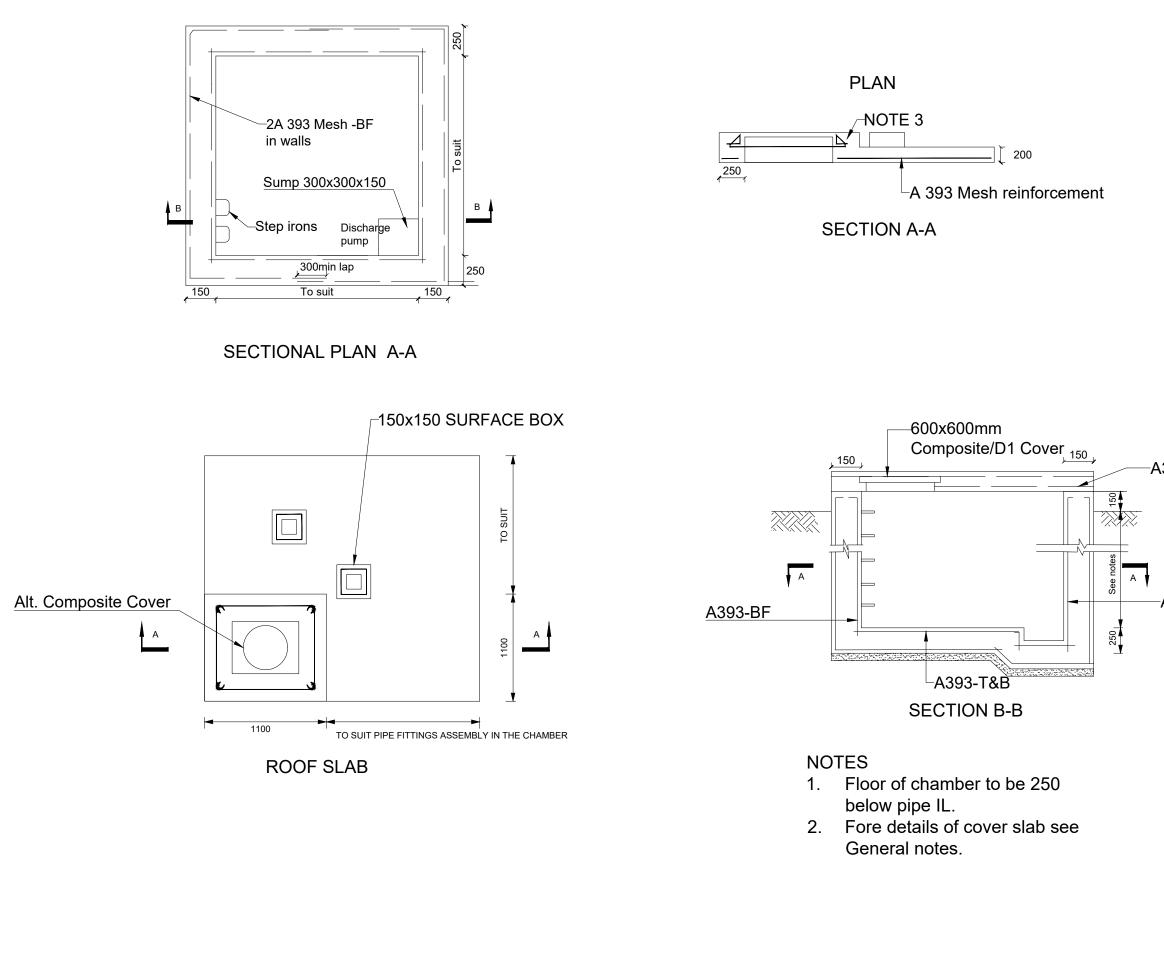


	LEGEND		
	CLIENT :		
	THE REPUBLIC OF UGANDA MINISTRY OF WATER AND ENVIRONMENT		
	CO-FINANCED BY:		
	THE WORLD BANK		
.393	IBRD - IDA WORLD BANKGROUP		
	CONSULTANT :		
	Alliance Consultants Itd		
	Infra-Consult Ltd		
A393-BF			
//000-Di	PROJECT : ALA-ORA WATER SUPPLY AND		
	SANITATION PROJECT		
	NYAGAK WATER SUPPLY AND		
	SANITATION SYSTEM		
	REVISIONS : No Date Description		
	Reinforcement Details for Washout/Gate Valve Chamber and Roof Slab Details		
	Surveyed by:		
	R.K Drawn by:		
	N.R Designed by: W.G.M		
	Checked by: J.K.K Date:		
	January 2023		
	ALA-ORA-SD-008 Scale: Sheet No.:		
	1:120 1 of 1		

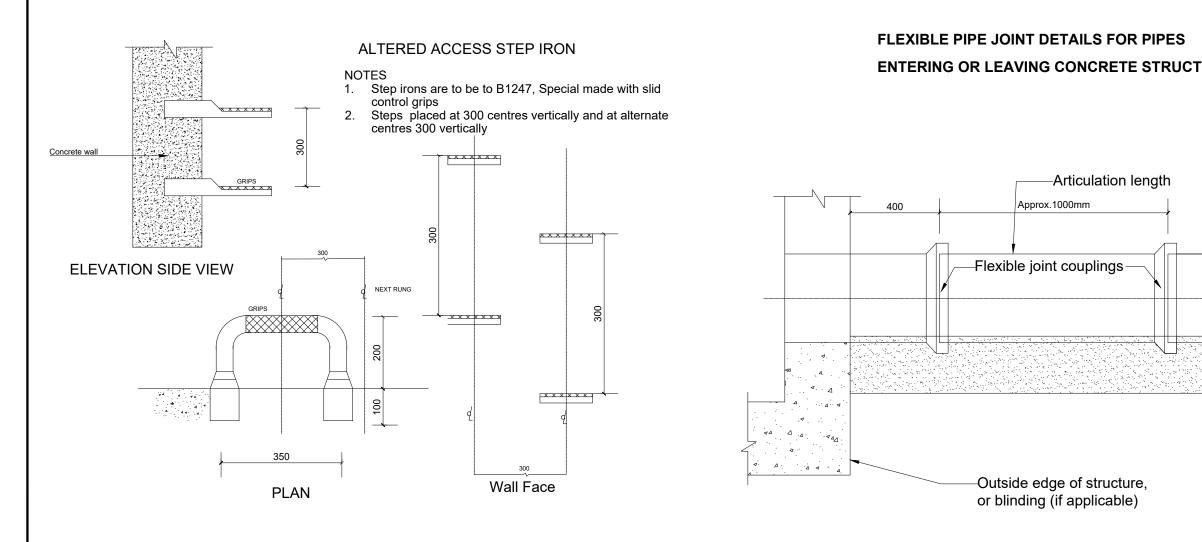


	LEGEND		
URES			
	CLIENT :		
	THE REPUBLIC OF UGANDA		
	CO-FINANCED BY:		
	CONSULTANT :		
	Alliance Consultants Itd		
	In Association with		
	Infra-Consult Ltd		
	PROJECT :		
	ALA-ORA WATER SUPPLY AND		
	SANITATION PROJECT		
	NYAGAK WATER SUPPLY AND		
	SANITATION SYSTEM		
	No Date Description		
	DRAWING TITLE : STANDARD DRAWINGS		
	Step Iron and Flexible Pipe Joint Details		
	Surveyed by: R.K Drawn by:		
	N.R Designed by: W.G.M		
	Checked by: J.K.K		
	Date: January 2023 DRG. No.:		
	ALA-ORA-SD-009 Scale: Sheet No.:		
	1:120 1 of 1		

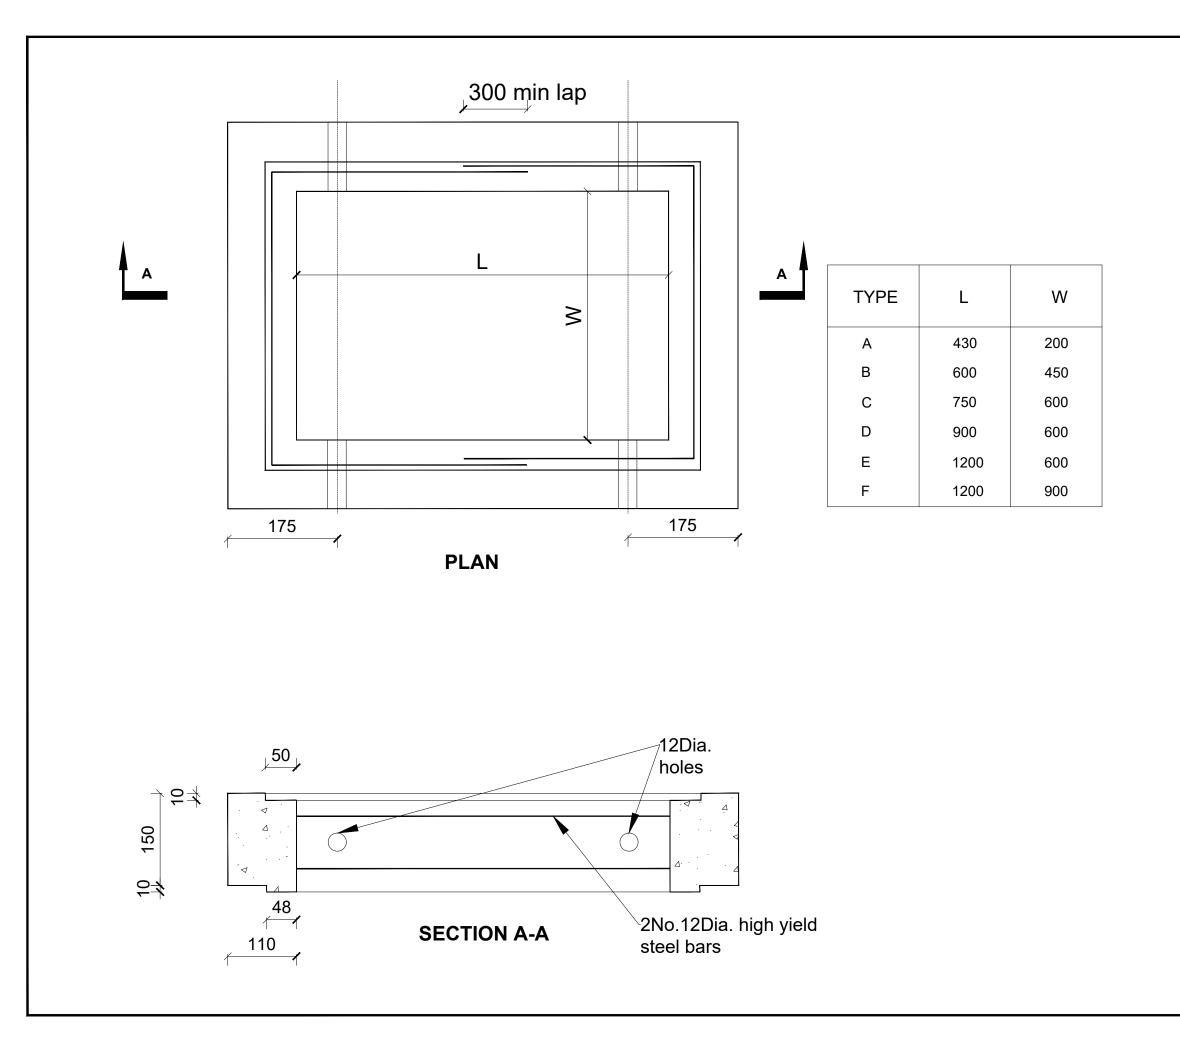

	LEGEND	
CLIENT :		
	9 1	
	IC OF UGANDA R AND ENVIRONMENT	
CO-FINANCED BY:		
THE		
iBRD - II	DA WORLD BANKGROUP	
CONSULTANT :		
CONSULTANT :		
Alliance	e Consultants Itd	
	ssociation with	
PROJECT :	ssociation with Consult Ltd	
PROJECT : ALA-ORA WAT	Consult Ltd	
PROJECT : ALA-ORA WAT SANITATIC	ER SUPPLY AND N PROJECT	
PROJECT : ALA-ORA WAT SANITATIO	Consult Ltd	
PROJECT : ALA-ORA WAT SANITATIO NYAGAK WATE SANITATIO	ER SUPPLY AND N PROJECT ER SUPPLY AND N SYSTEM	
PROJECT : ALA-ORA WAT SANITATIO	ER SUPPLY AND N PROJECT	
PROJECT : ALA-ORA WAT SANITATIO NYAGAK WATE SANITATIO	ER SUPPLY AND N PROJECT ER SUPPLY AND N SYSTEM	
PROJECT : ALA-ORA WAT SANITATIO NYAGAK WAT SANITATIO REVISIONS : No Date	ER SUPPLY AND ON PROJECT ER SUPPLY AND DN SYSTEM	
	ER SUPPLY AND ON PROJECT ER SUPPLY AND DN SYSTEM	
Alliance In A In A Infre PROJECT : ALA-ORA WAT SANITATIC NYAGAK WAT SANITATIC REVISIONS : No Date DRAWING TITLE : STANDA Precast Chambe	SSOCIATION WITH Consult Ltd ER SUPPLY AND ON PROJECT ER SUPPLY AND ON SYSTEM Description RD DRAWINGS	
Alliance In A In A Infre PROJECT : ALA-ORA WAT SANITATIC NYAGAK WAT SANITATIC REVISIONS : NO Date DRAWING TITLE : STANDA Precast Chambe Surveyed by: R.K Drawn by: N.R	SSOCIATION WITH Consult Ltd ER SUPPLY AND ON PROJECT ER SUPPLY AND ON SYSTEM Description RD DRAWINGS	
Alliance In A Infra- Infra-	SSOCIATION WITH Consult Ltd ER SUPPLY AND ON PROJECT ER SUPPLY AND ON SYSTEM Description RD DRAWINGS	
Alliance Infra- Infran Infra- Infra- Infra- Infra- Infra- Infr	SSOCIATION WITH Consult Ltd ER SUPPLY AND ON PROJECT ER SUPPLY AND ON SYSTEM Description RD DRAWINGS	
Alliance In A Infra- Infra-	ER SUPPLY AND DN PROJECT ER SUPPLY AND DN SYSTEM Description	
Alliance In Alliance	ER SUPPLY AND DN PROJECT ER SUPPLY AND DN SYSTEM Description	

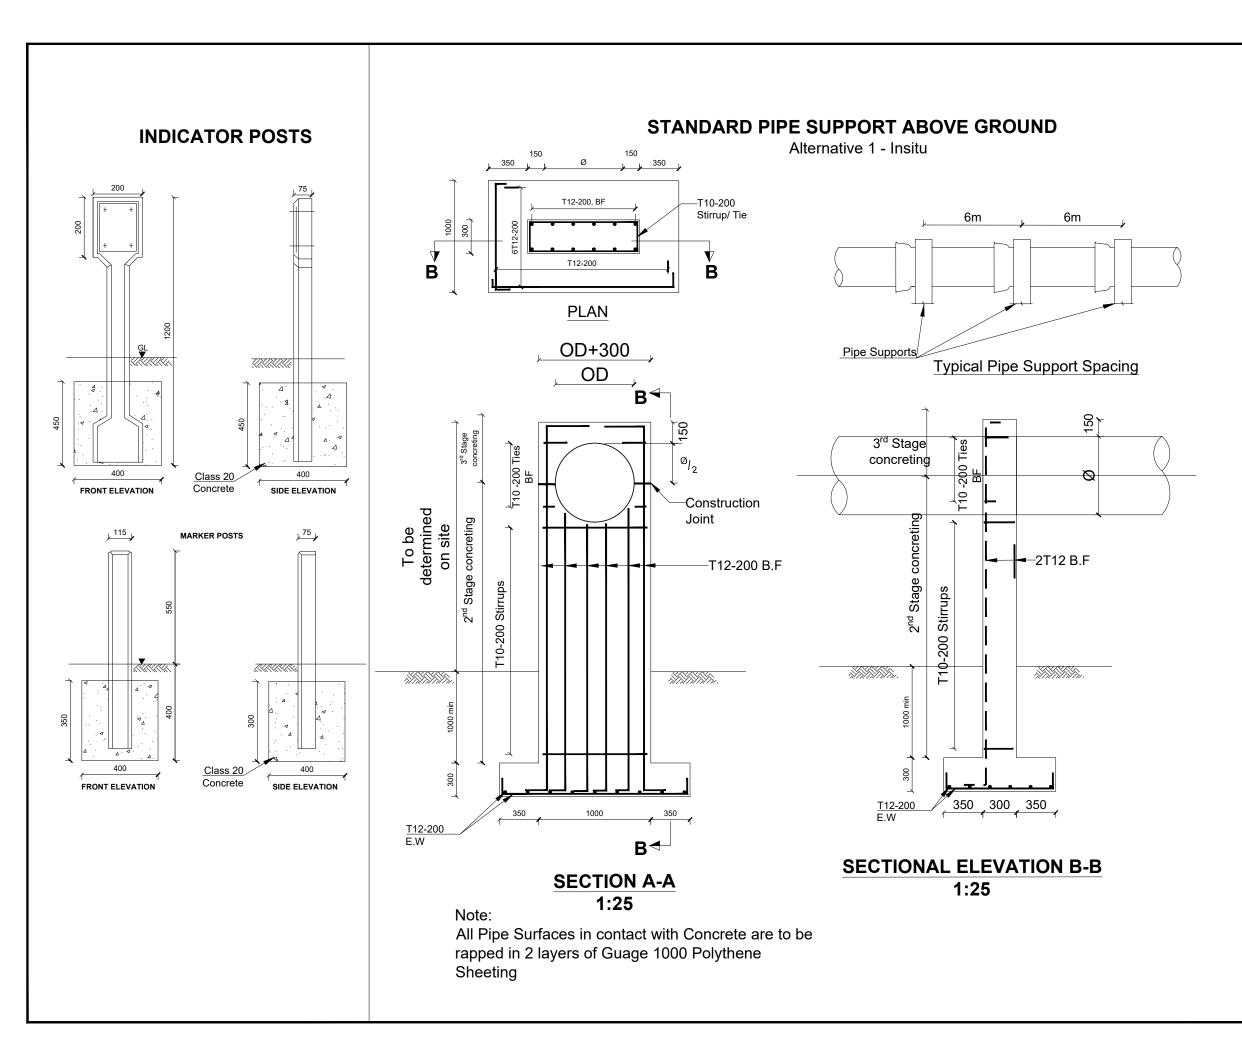

	LEGEND	
CLIENT :		
	Ð	
	IC OF UGANDA	
CO-FINANCED BY:	R AND ENVIRONMENT	
CAN THE		
IBRD+II	DA WORLD BANKGROUP	
CONSULTANT :		
NV.	e Consultants Itd	
In A	e Consultants Itd	
In A	ssociation with	
	Sociation with	
PROJECT : ALA-ORA WAT	ssociation with	
PROJECT : ALA-ORA WAT SANITATIO	ER SUPPLY AND N PROJECT	
PROJECT : ALA-ORA WAT SANITATIO NYAGAK WATE SANITATIO	ER SUPPLY AND N PROJECT	
PROJECT : ALA-ORA WAT SANITATIO	ER SUPPLY AND N PROJECT	
In A Infra- PROJECT : ALA-ORA WAT SANITATIC NYAGAK WATE SANITATIC	ER SUPPLY AND N PROJECT ER SUPPLY AND N SYSTEM	
In A Infra- PROJECT : ALA-ORA WAT SANITATIC NYAGAK WATE SANITATIC	ER SUPPLY AND N PROJECT ER SUPPLY AND N SYSTEM	
	ER SUPPLY AND ON PROJECT ER SUPPLY AND ON SYSTEM	
	ER SUPPLY AND ON PROJECT ER SUPPLY AND ON SYSTEM Description	
PROJECT : ALA-ORA WAT SANITATIC NYAGAK WAT SANITATIC REVISIONS : No Date DRAWING TITLE : STANDA Marker Post ar Surveyed by: R.K Drawn by: N.R	ER SUPPLY AND ON PROJECT ER SUPPLY AND ON SYSTEM Description	
PROJECT : ALA-ORA WAT SANITATIC NYAGAK WAT SANITATIC REVISIONS : No Date DRAWING TITLE : STANDA Marker Post ar Surveyed by: R.K Drawn by: N.R Designed by: W.G.M Checked by:	ER SUPPLY AND ON PROJECT ER SUPPLY AND ON SYSTEM Description	
PROJECT : ALA-ORA WAT SANITATIC NYAGAK WATE SANITATIC NYAGAK WATE SANITATIC NYAGAK WATE SANITATIC DRAWING TITLE : STANDA Marker Post ar Surveyed by: R.K Drawn by: N.R Designed by: W.G.M Checked by: J.K.K Date:	ER SUPPLY AND ON PROJECT ER SUPPLY AND ON SYSTEM Description	
PROJECT : ALA-ORA WAT SANITATIC NYAGAK WATE SANITATIC NYAGAK WATE SANITATIC NYAGAK WATE SANITATIC DRAWING TITLE :STANDA Marker Post ar Surveyed by: R.K Drawn by: N.R Designed by: W.G.M Checked by: J.K.K	ER SUPPLY AND DN PROJECT ER SUPPLY AND DN SYSTEM Description RD DRAWINGS and Pipe Support Details	

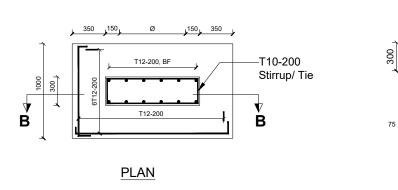

STANDARD PIPE SUPPORT ABOVE GROUND

125 ⊮—≱

125

ł

150

20

OD

75 �� 扁厂

Alternative 2 - Insitu with a precast concrete strap

125 I

125 ↓___∤


lφ.

150


T10-150

T10-150


L

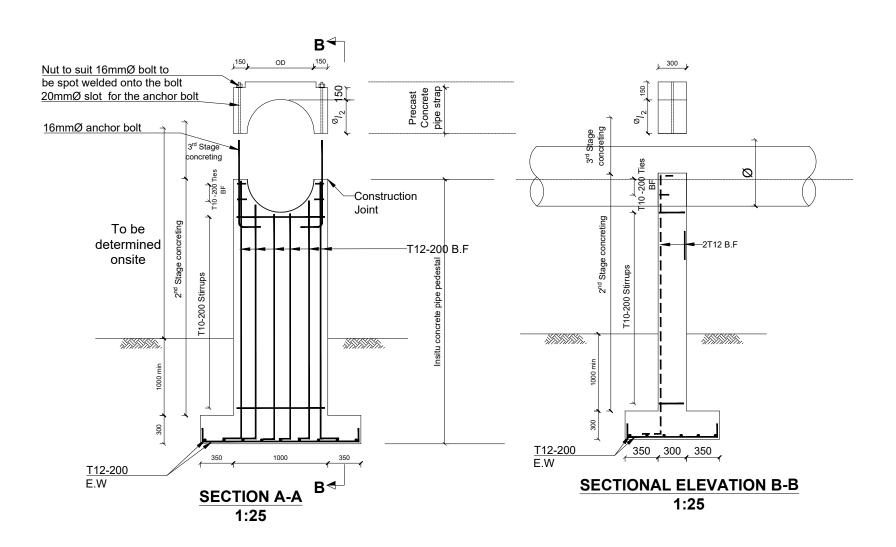


	LEGEND			
CLIENT :				
	LIC OF UGANDA R AND ENVIRONMENT			
CO-FINANCED BY:				
	CONSULTANT : Alliance Consultants Itd			
	Association with			
	-Consult Ltd			
PROJECT :				
	ER SUPPLY AND			
	ER SUPPLY AND			
	SANITATION SYSTEM			
REVISIONS : No Date	Description			
	DRAWING TITLE : STANDARD DRAWINGS Marker Post and Pipe Support Details			
Marker Post ar				
Marker Post ar				
Marker Post ar Surveyed by: R.K Drawn by: N.R Designed by: W.G.M				
Marker Post ar Surveyed by: R.K Drawn by: N.R Designed by: W.G.M Checked by: J.K.K				
Marker Post ar Surveyed by: R.K Drawn by: N.R Designed by: W.G.M Checked by: J.K.K Date: January 2023				
Marker Post ar Surveyed by: R.K Drawn by: Designed by: Checked by: J.K.K Date:	nd Pipe Support Details			

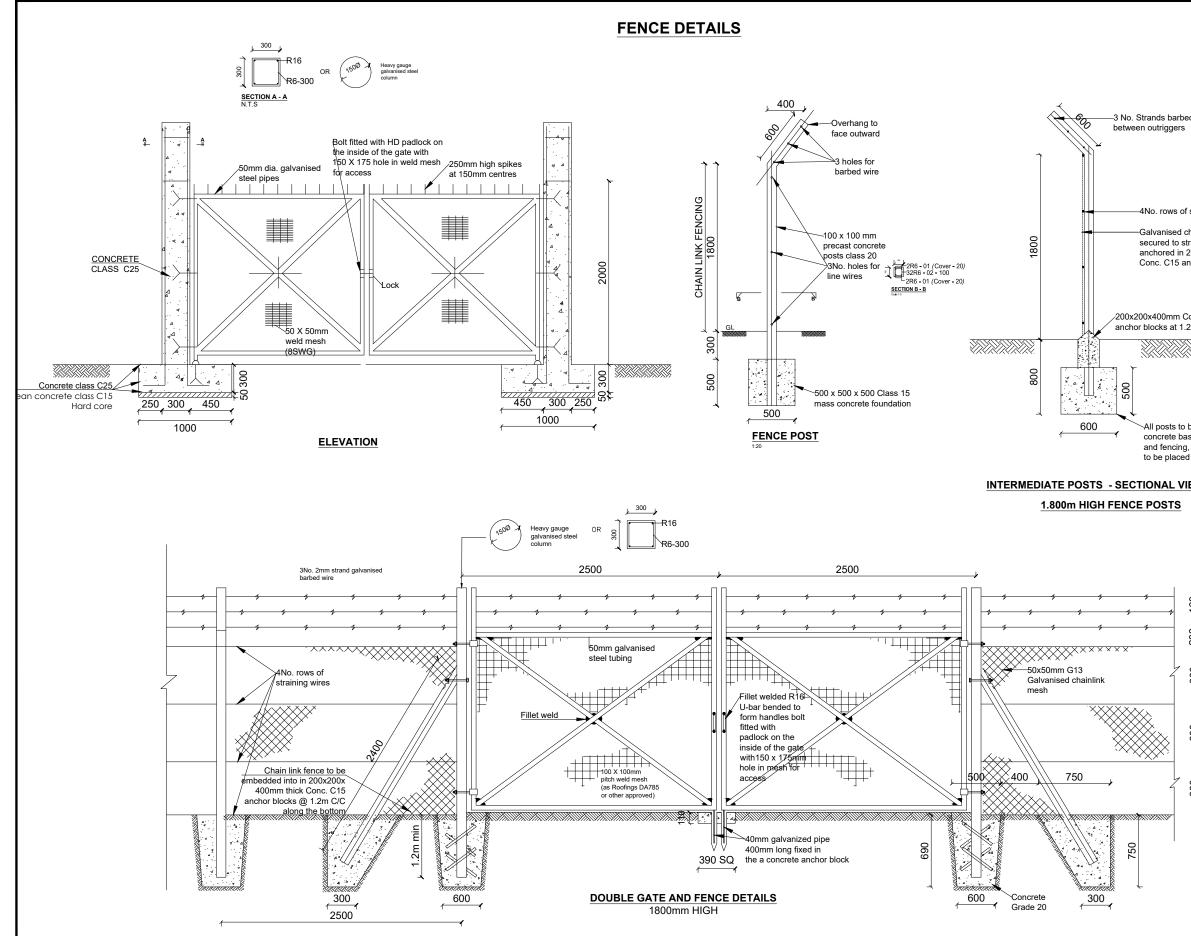


	LEGEND
d wire	
straining wires hain link fencing raining wires and 200x200x400mm nchor blocks at 1.2mC/C	
onc. C15 2m c/c	
be set in 600x600x500n ses. After fixing bottom , an additional 200mm c d around posts before ba <u>EW</u> (3.00m c/c)	CO-FINANCED BY:
	CONSULTANT : Alliance Consultants Itd In Association with
600 200 160 160 1	PROJECT : ALA-ORA WATER SUPPLY AND SANITATION PROJECT NYAGAK WATER SUPPLY AND
2320	SANITATION SYSTEM REVISIONS : No Date Description
600	DRAWING TITLE : STANDARD DRAWINGS Fence details
	Surveyed by: R.K Drawn by: N.R Designed by: W.G.M Checked by: J.K.K Date: January 2023 DRG. No.: ALA-ORA-SD-012 Scale: Sheet No.:
	1:120 1 of 2

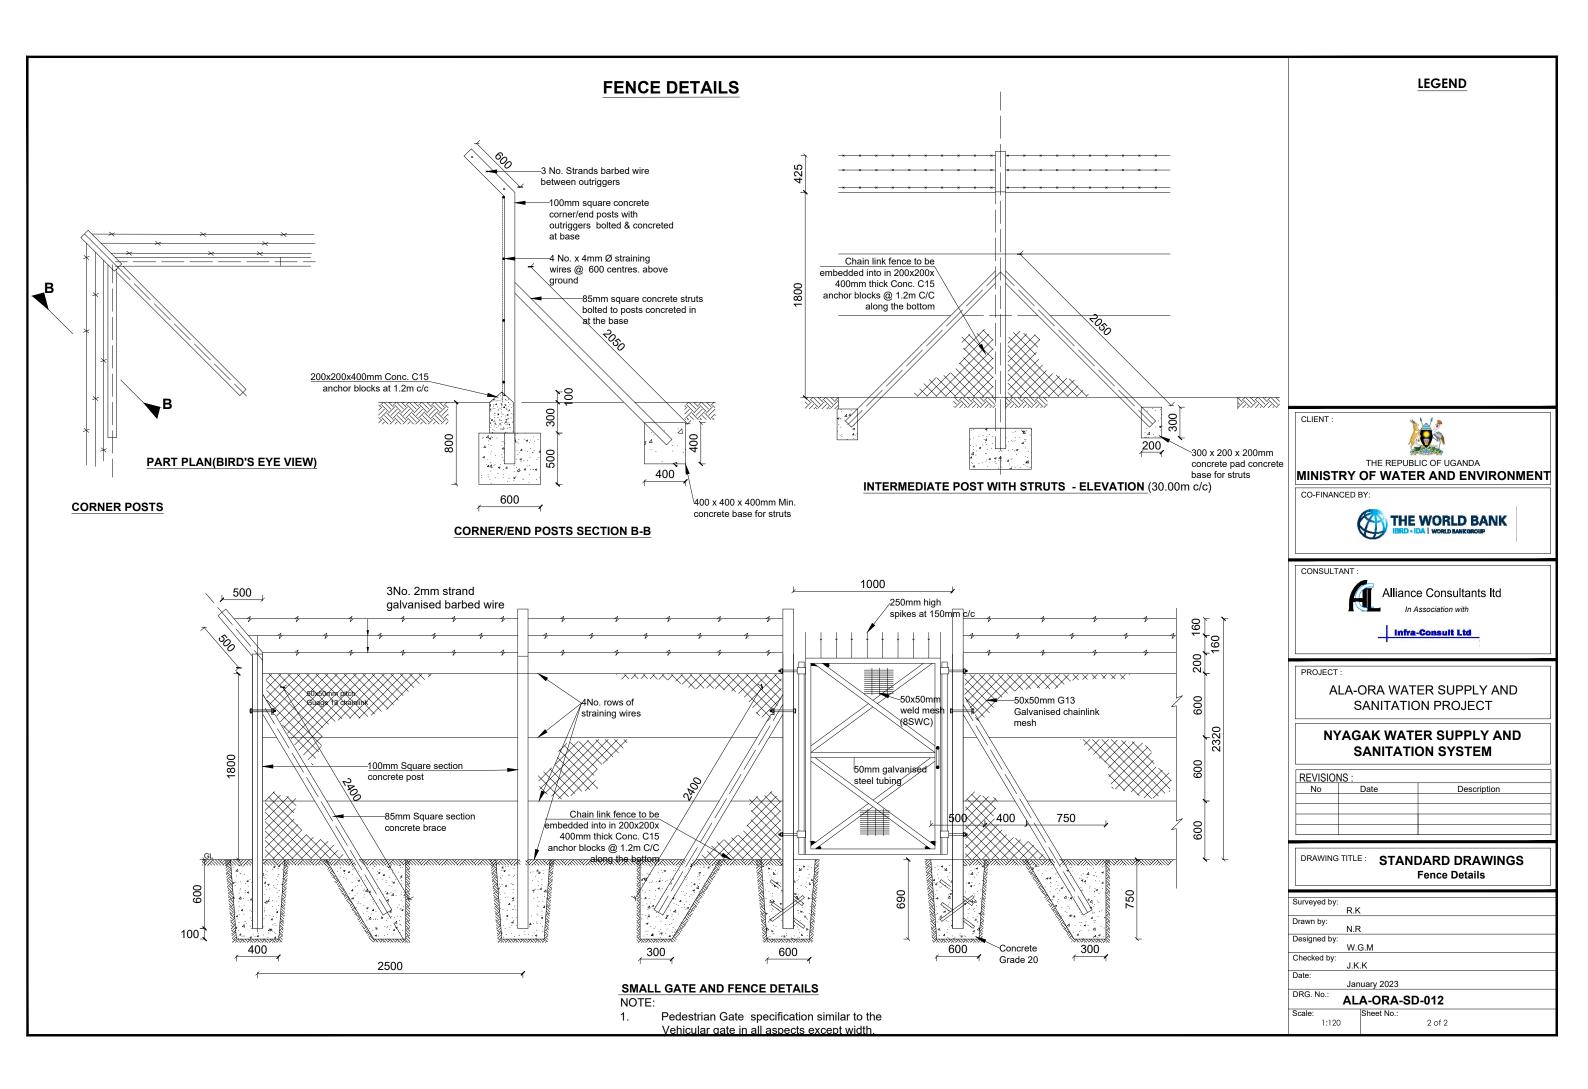

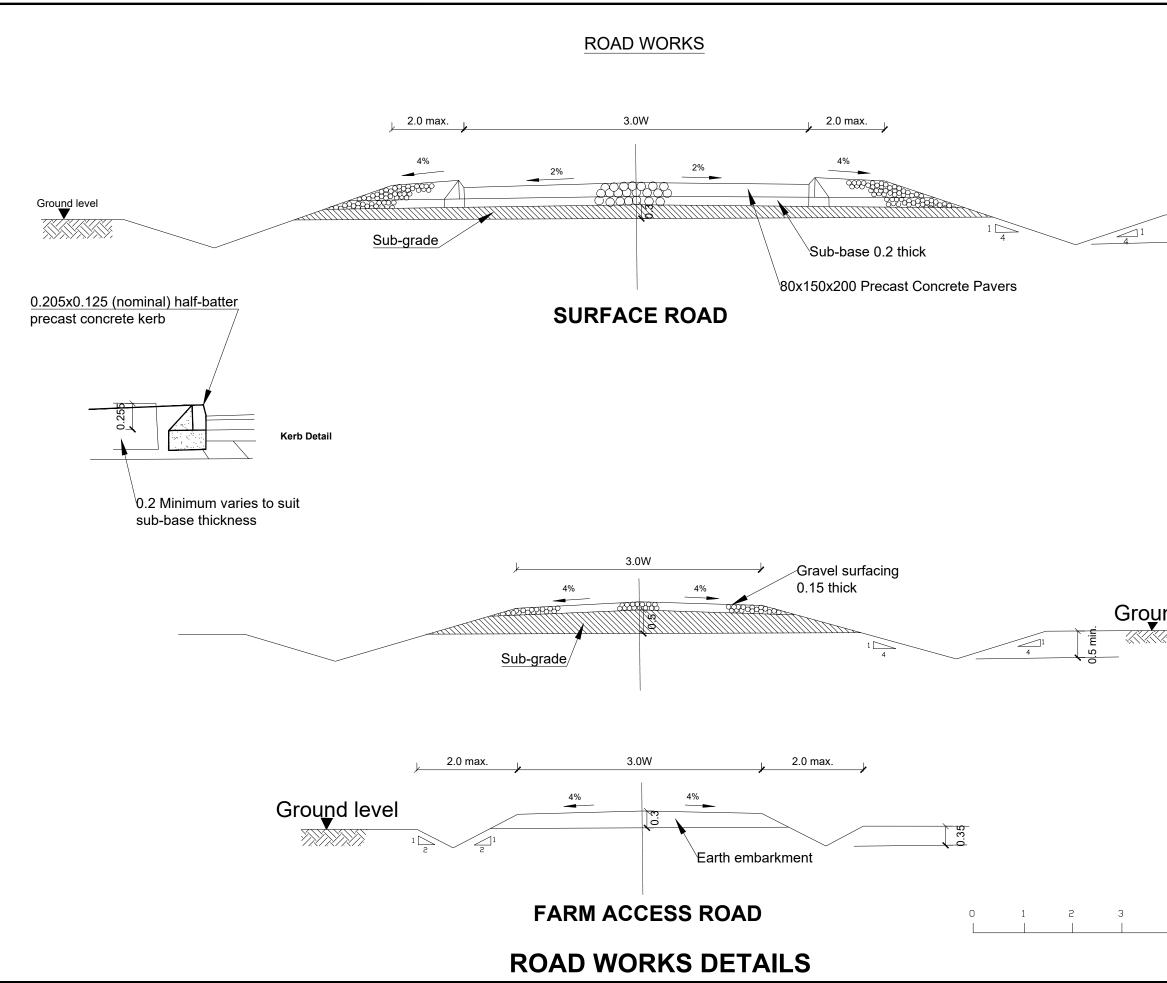

	LEGEND		
5 min.			
- \			
	THE REPUBLIC OF UGANDA MINISTRY OF WATER AND ENVIRONMENT		
	CO-FINANCED BY:		
	CONSULTANT : Alliance Consultants Itd		
	Infra-Consult Ltd		
nd level	PROJECT :		
	ALA-ORA WATER SUPPLY AND SANITATION PROJECT		
	NYAGAK WATER SUPPLY AND SANITATION SYSTEM		
	REVISIONS : No Date		
	DRAWING TITLE : STANDARD DRAWINGS Road Works		
	Surveyed by: R.K		
	Drawn by: N.R Designed by:		
4m	W.G.M Checked by: J.K.K		
	Date: January 2023		
	DRG. No.: ALA-ORA-SD-013 Scale: [Sheet No.:		
	Scale: Sheet No.: 1:120 1 of 1		



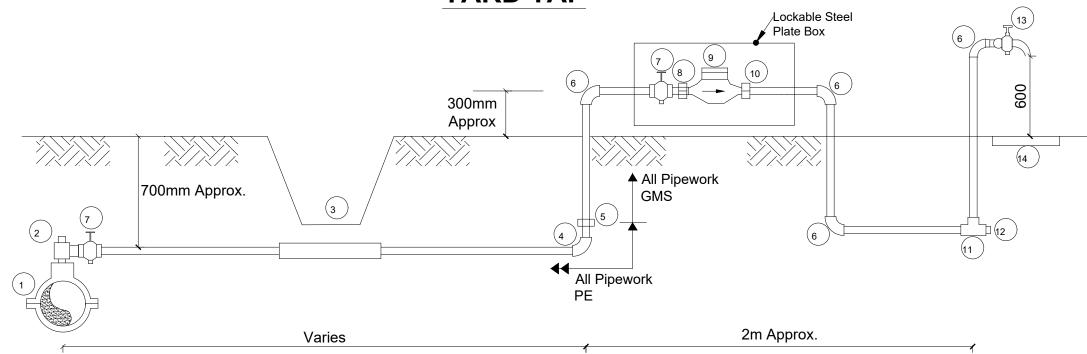


SCHEDULE	E OF FI	TTINGS
001120022	- 01 11	

ITEM NO.	DESCRIPTION	NO. REQUIRED PER CONNECTION
1.	PVC Saddle Clamp	1
2.	PE Outlet type swivel ferule	1
3.	1m Length GMS sleeve	1 (optional)
4.	PE Elbow	1
5.	PE/GMS Adaptor	4
6.	GMS Elbow	3
7.	Stop cock	1
8.	Male threaded connector	1
9.	Water meter	1
10.	Adjusting coupling	1
11.	GMS equal tee	1
12.	Plug	1
13.	Тар	3
14.	600x600x50mm RC precast reinfo	rced 1
15.	with a G10 (3.0mm Ø x 60 x 60mm Purpose made Lockable Meter pro	. ,
	made of 3mm Ms plate Complete in Painting and a 50mm Padlock	ncluding

NOTES:

- GMS pipe ends to be screwed with tapered threads to ISO
 R7 and to be supplied with sealing PTFE tape
- GMS pipe fittings to be malleable cast iron to BS 143 and BS 1256 with female threaded ends
- The adjusting coupling shall be made of bronze or brass with a threaded female connection at the outlet end. It shal incorporate sufficient adjustment to permit removal at the meter
- 4. All PE connections shall be of the push fit type
- 5. Diameter of pipe varies
- The Meter Protection shall be robust and be able to enclos the Meter and Stop clocks.

	LEGEND
	CLIENT :
	THE REPUBLIC OF UGANDA
	MINISTRY OF WATER AND ENVIRONMENT
	CO-FINANCED BY:
	THE WORLD BANK
	IBRD • IDA WORLD BANKGROUP
	CONSULTANT :
	Alliance Consultants Itd
	In Association with
	Infra-Consult Ltd
)	
·	PROJECT :
	ALA-ORA WATER SUPPLY AND
	SANITATION PROJECT
	NYAGAK WATER SUPPLY AND
	SANITATION SYSTEM
II	REVISIONS :
	No Date Description
	Tape Yard
se	Surveyed by: R.K
	Drawn by: N.R
	Designed by: W.G.M
	Checked by: J.K.K
	Date: January 2023
	DRG. No.: ALA-ORA-SD-014
	Scale: Sheet No.:
	1:120 1 of 1

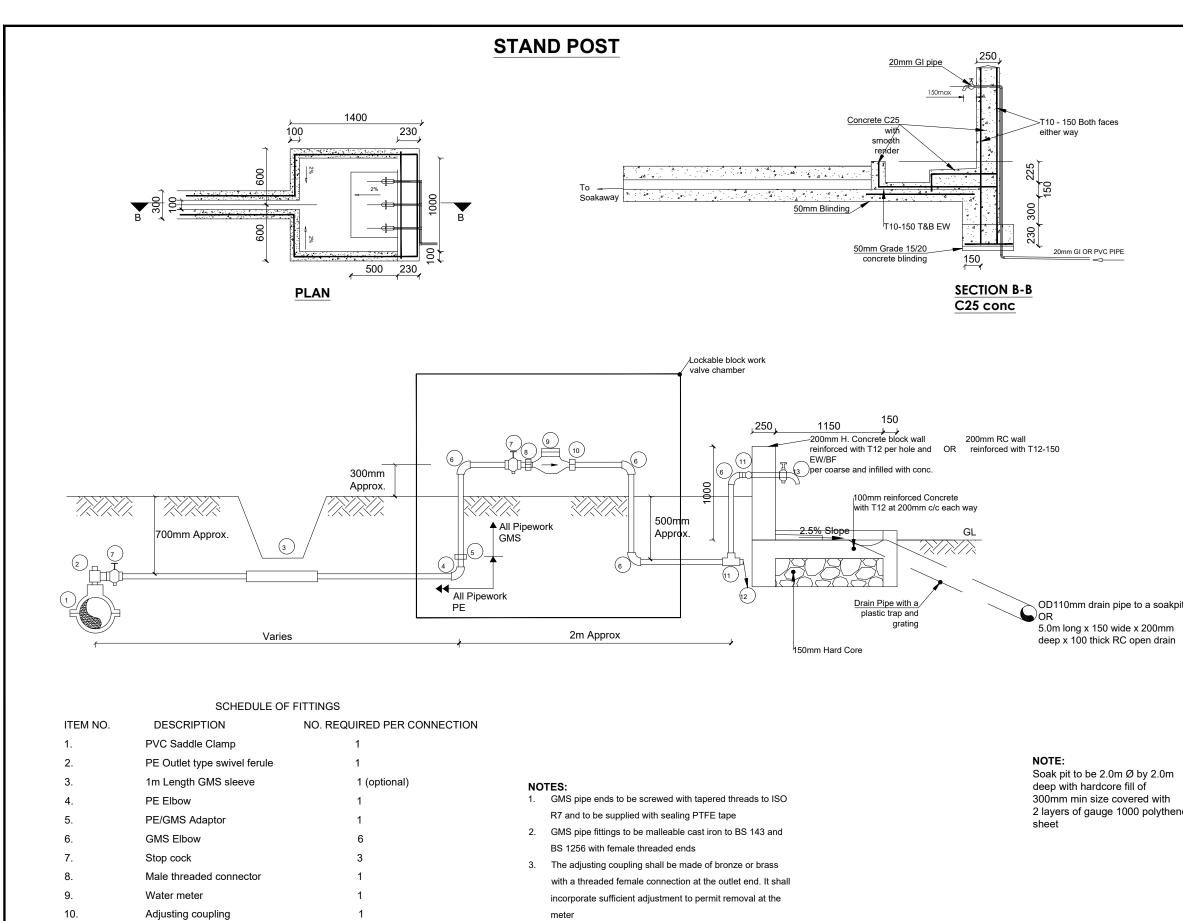

- 4. All PE connections shall be of the push fit type
- 5. Diameter of pipe varies

GMS equal tee

Plug

Тар

3

1

3


11.


12.


13.

6. The Meter Protection shall be robust and be able to enclose the Meter and Stop clocks.

	LEGEND
	CLIENT :
	MINISTRY OF WATER AND ENVIRONMENT CO-FINANCED BY:
	CONSULTANT : Alliance Consultants Itd In Association with
it	Infra-Consult Ltd
	PROJECT : ALA-ORA WATER SUPPLY AND SANITATION PROJECT
	NYAGAK WATER SUPPLY AND SANITATION SYSTEM
	REVISIONS : No Date Description
e	
	DRAWING TITLE : STANDARD DRAWINGS Stand Post
	Surveyed by: R.K
	Drawn by: N.R Designed by:
	W.G.M Checked by: J.K.K
	Date: January 2023
	DRG. No.: ALA-ORA-SD-015 Scale: Sheet No.:
	1:120 l of 1

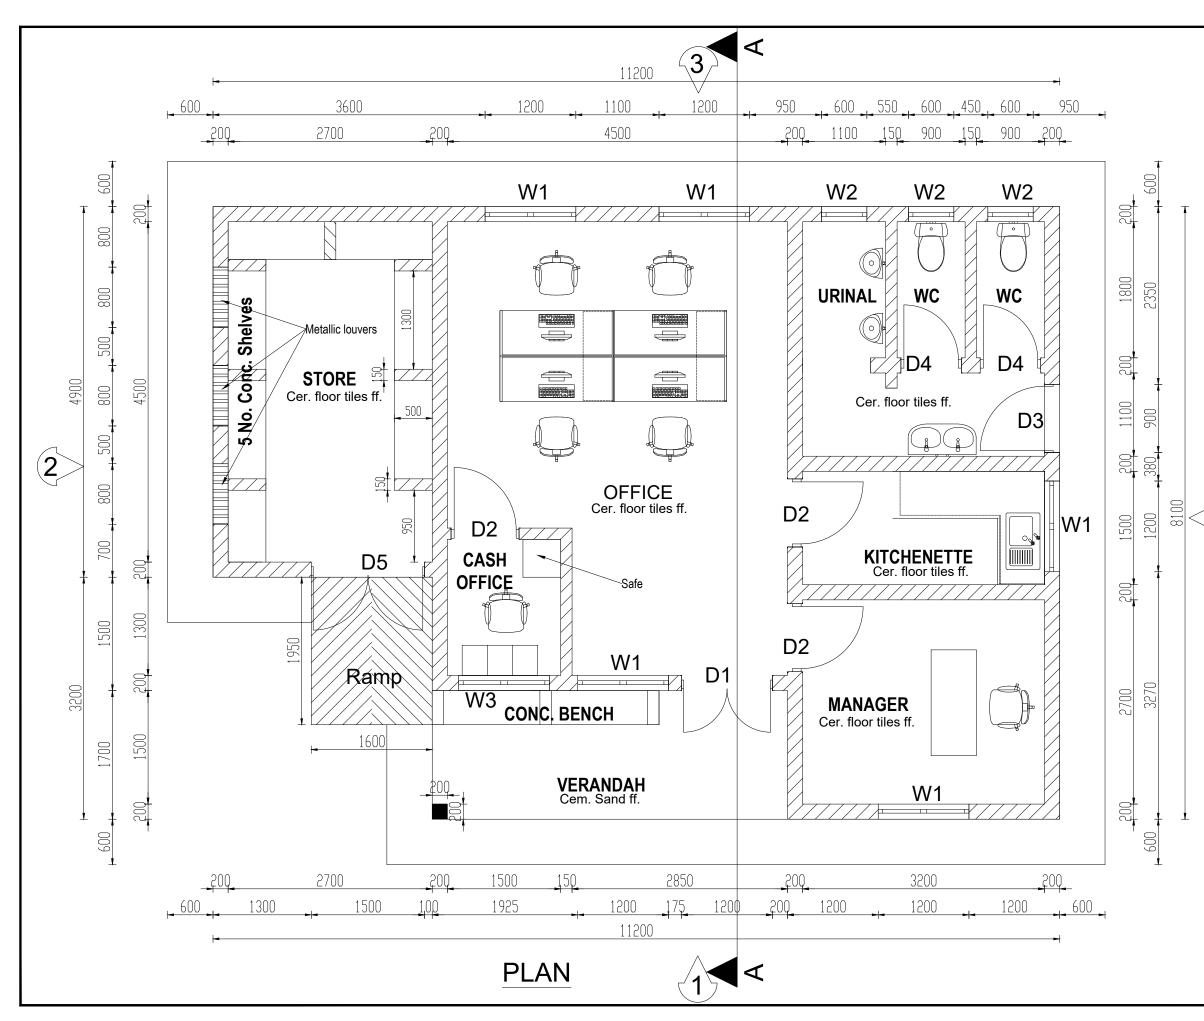


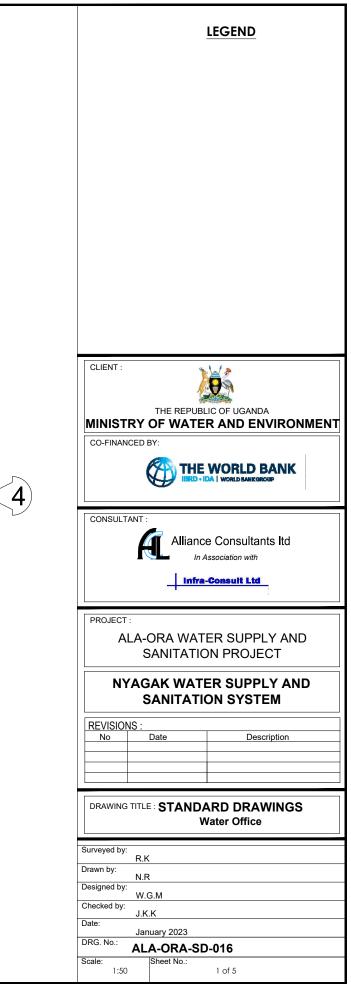


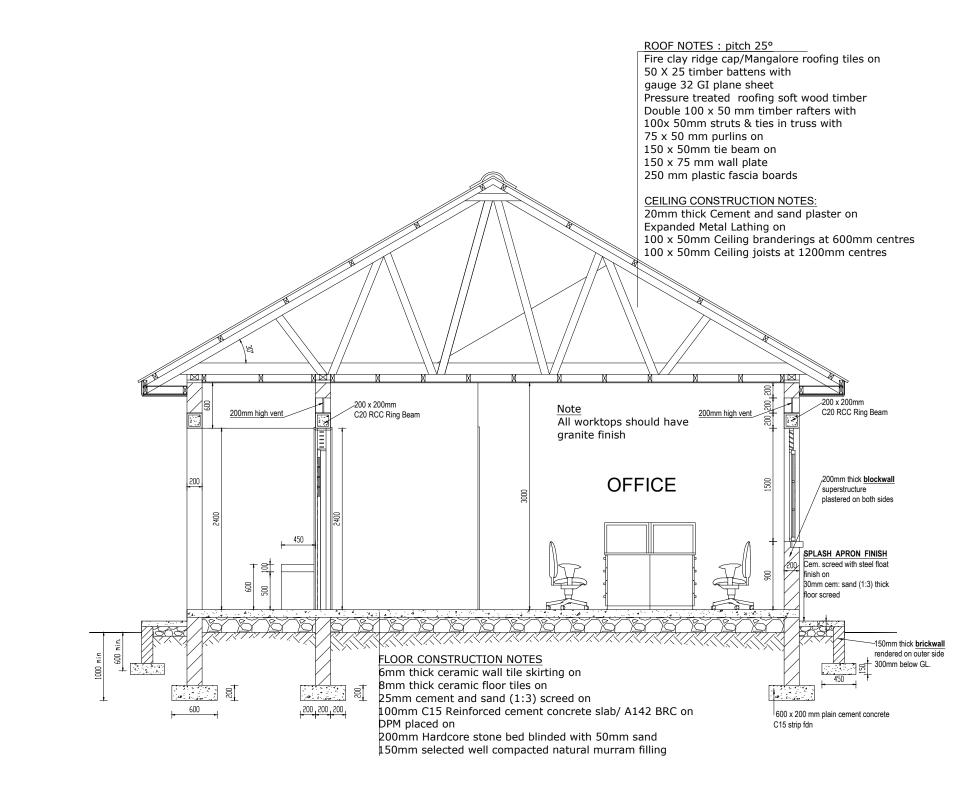

SECTION A-A

	LEGEND					
CLIENT :	had a					
	0					
	IC OF UGANDA R AND ENVIRONMENT					
CO-FINANCED BY:						
CAN THE						
	DA WORLD BANKGROUP					
CONSULTANT :						
	Alliance Consultants Itd					
	Issociation with					
infra-Consuit Ltd						
PROJECT :						
ALA-ORA WATER SUPPLY AND SANITATION PROJECT						
	ER SUPPLY AND					
	ON SYSTEM					
REVISIONS : No Date	Description					
DRAWING TITLE : STANDARD DRAWINGS						
Water Office						
Surveyed by: R.K Drawn by:						
N.R Designed by:						
W.G.M Checked by:						
Checked by:						
J.K.K Date:						
J.K.K	0-016					

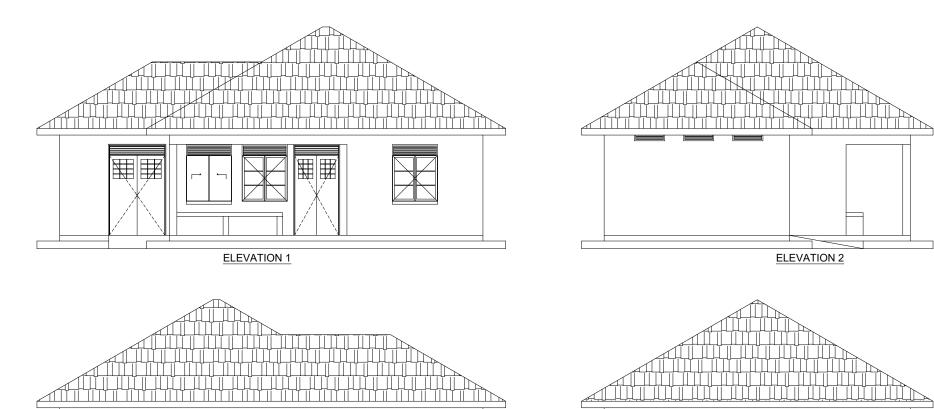

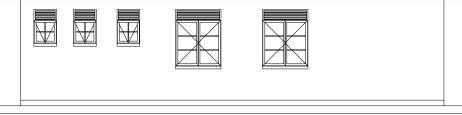


ELEVATION 3

ELEVATION 4


or Schedule						Window Schedule			
Door Name	D1	D2	D3	D4	D5	Window Name	W1	W2	W3
Quantity	2	3	1	2	1	Quantity	5	3	1
W x H Size	1200x2400	900x2400	900x2400	800x2400	1500x2400	W x H Size	1200x1500	600x900	1200 X 1500
Elevation View	Double Leaf Metalic Casement Door	Bingle Leaf Wooden Paneled Door	Bind the set of the se	Single Leaf Wooden Paneled Door	Double Leaf Metalik Casement Door		Metalic Casement		

• All metallic window & Door sections to be 3.0mm minimum thickness

	LEGEND					
CLIENT :						
	LIC OF UGANDA R AND ENVIRONMENT					
CO-FINANCED BY:						
CAN THE						
CONSULTANT :						
Alliance Consultants Itd						
	Association with					
Infra-Consult Ltd						
PROJECT :						
SANITATIC	ON PROJECT					
	ER SUPPLY AND ON SYSTEM					
REVISIONS : No Date	Description					
	Description					
	ARD DRAWINGS					
Water Office						
Surveyed by: R.K						
Drawn by: N.R						
Designed by:						
W.G.M						
Checked by: J.K.K Date:						
Checked by: J.K.K	016					

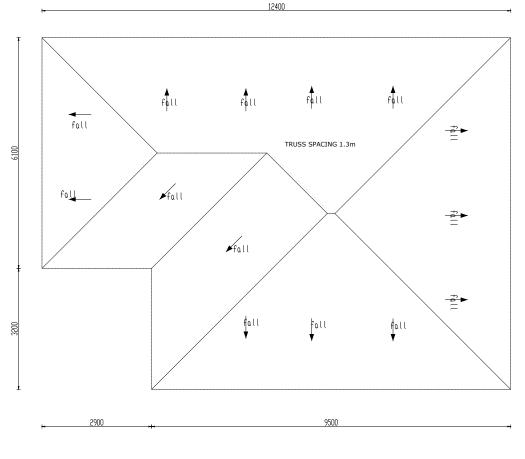


ROOF LAYOUT

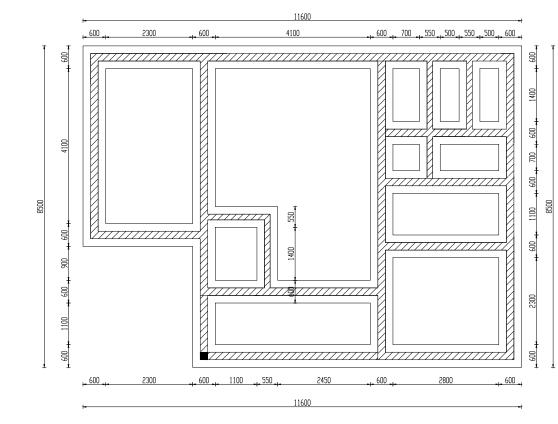

FOUNDATION LAYOUT

LEGEND
CLIENT :
THE REPUBLIC OF UGANDA MINISTRY OF WATER AND ENVIRONMENT CO-FINANCED BY:
CONSULTANT :
In Association with
PROJECT : ALA-ORA WATER SUPPLY AND SANITATION PROJECT
NYAGAK WATER SUPPLY AND SANITATION SYSTEM
REVISIONS : No Date
DRAWING TITLE : STANDARD DRAWINGS Water Office Type 1- Foundation and Roof layout
Surveyed by: R.K
Drawn by: N.R
Designed by: W.G.M Checked by:
J.K.K Date:
January 2023 DRG. No.: ALA-ORA-SD-016
Scale: Sheet No.: 1:100 4 of 5

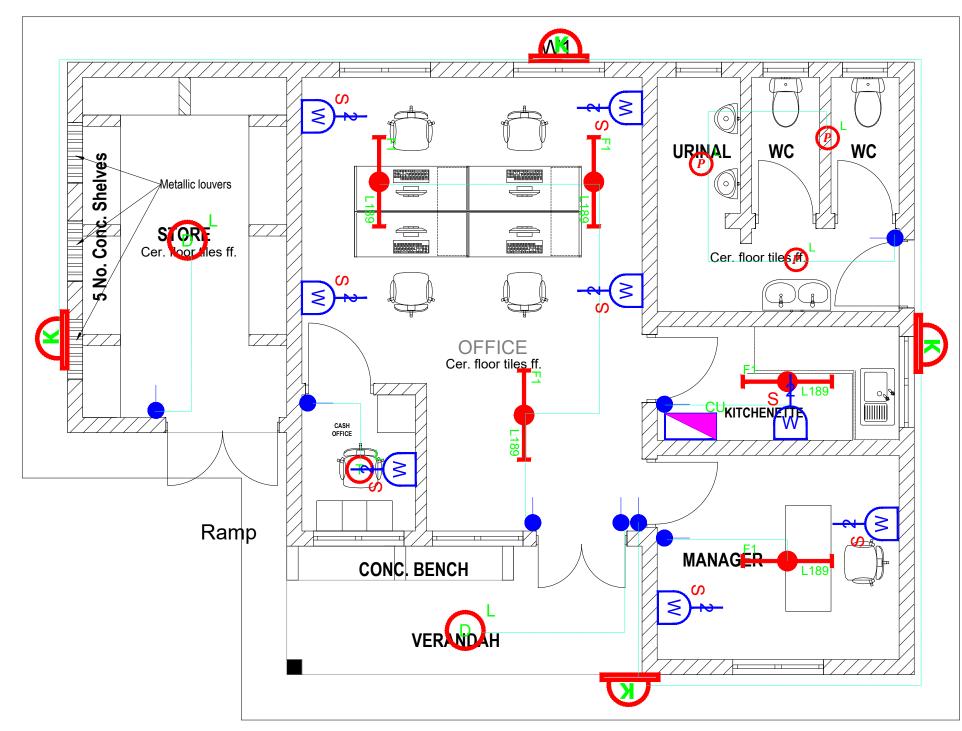

1). ALL WALL BRACKETS SHALL BE MOUNTED 1800mm ABOVE FINISHED FLOOR LEVEL

2). TELEPHONE, SOCKETS, T. V AND COMPUTER OUTLETS SHALL BE MOUNTED 300mm ABOVE FINISHED FLOOR LEVEL EXCEPT WHERE THEIR IS A WORKTOP.

3). WHERE THEIR IS A WORKTOP, TELEPHONE, SOCKETS, T. V AND COMPUTER OUTLETS SHALL BE MOUNTED 150mm ABOVE WORKTOPS.

- 4). CONSUMER UNITS SHALL BE 1800mm ABOVE FINISHED FLOOR LEVEL
- 5). ALL SWITCHES SHALL BE 1400mm ABOVE FINISHED FLOOR LEVEL


6). ALL OUTSIDE SOCKETS SHOULD BE WEATHER PROOF


7). ALL SHAVER SOCKETS SHOULD BE ON THE RIGHT HAND SIDE OF THE WASH HAND BASIN

8). ALL CABLES MUST BE STRANDED

SYMBOL		DESCRIPTION	1	
		n with a removable LED engine. IP20 or equal approved. (Light Type F1)		
O'	Pedant lighting fitting co flexible copper cable lan	mprising ceiling Rose 300mm 3x1.5mm p holder and 6W LED Lamp		
Ø	flexible copper cable lamp			
O	flexible copper cable lamp LED Lamp			
Ŷ	Decorative Bed side lamp arm as LEDS-C4 BALI (client's approval.	o complete with flexible spot light)5-3217-19-82 + PAN-157-BY) to		
	wall mounted light			
<u>``</u>	Socket outlet on Wall			
	Consumer's Unit			
¥	One Gang 2way Switch			
<u> </u>	Two Gang 2way Switch			
	Three Gang 2way Swite			
•	One Gang 1way Switch Two Gang 1way Switch	1		
	Three Gang Iway Switch	:h		
	Intermediate Switch			
PC	Photo - Cell			
CONSULTA PROJECT :		e Consultants Itd Issociation with		
	SANITATIC	ER SUPPLY AND IN PROJECT		
NY.		ER SUPPLY AND ON SYSTEM		
REVISION		Description		
No	Date	Description		
DRAWING TITLE : STANDARD DRAWINGS Water Office Type 1- Foundation and Roof layout				
Surveyed by:				
Drawn by:	R.K			
Designed by:	N.R			
Checked by:	W.G.M J.K.K			
Date:	January 2023			
DRG. No.:	ALA-ORA-SD	0-016		
Scale:	Sheet No.:			
1:50		5 of 5		


SEPTIC TANK

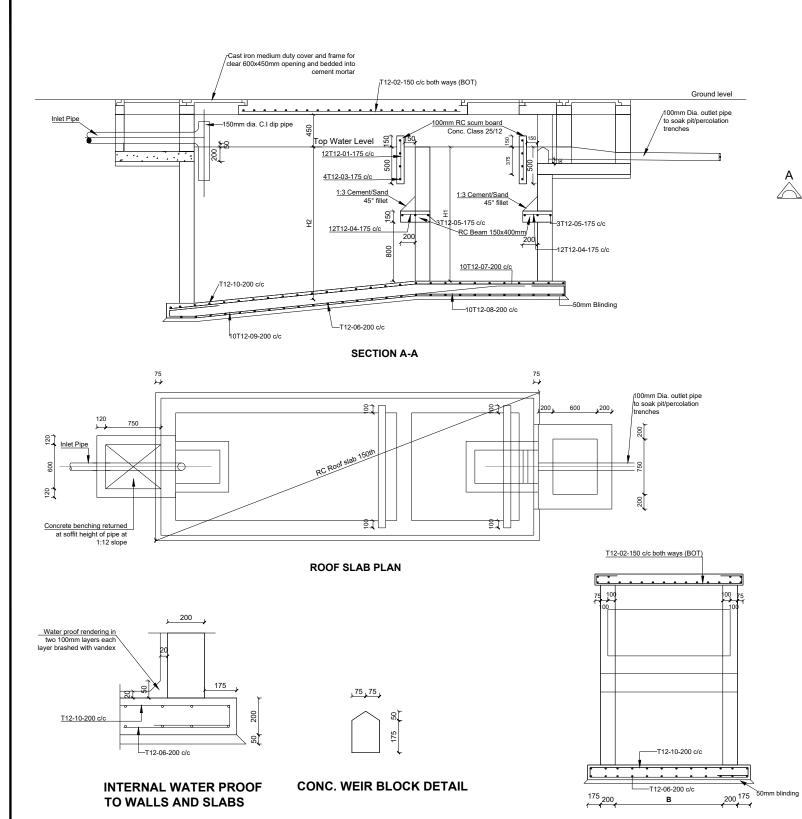

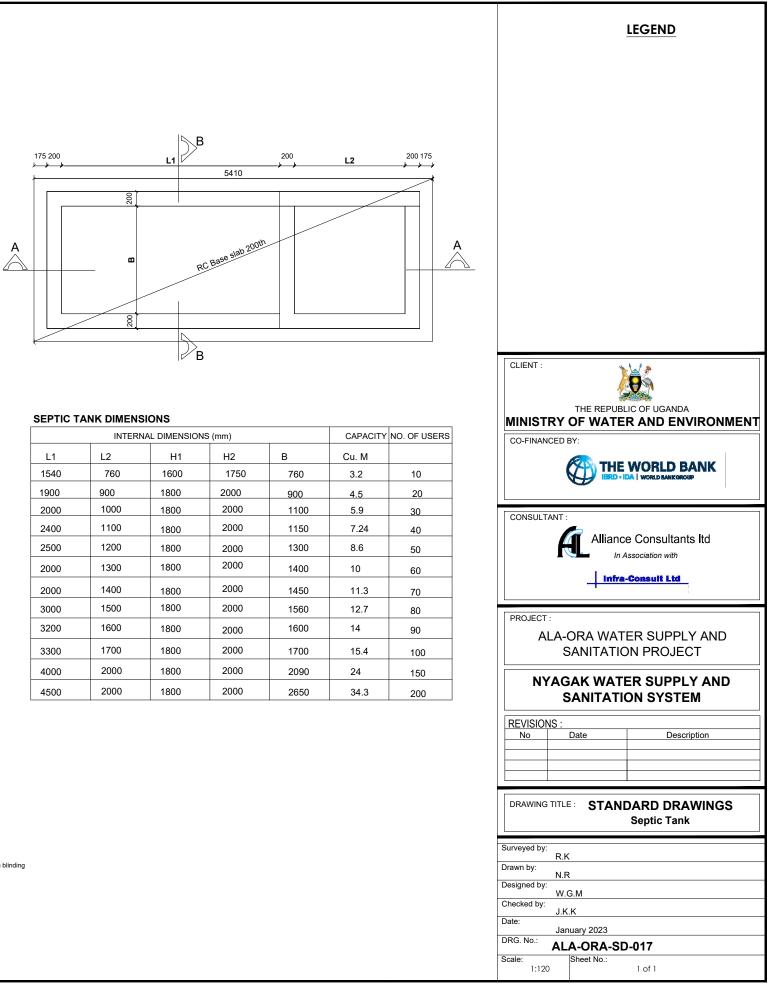


	CAPACITY	NO. C				
L1	L2	H1	H2	В	Cu. M	
1540	760	1600	1750	760	3.2	
1900	900	1800	2000	900	4.5	
2000	1000	1800	2000	1100	5.9	
2400	1100	1800	2000	1150	7.24	
2500	1200	1800	2000	1300	8.6	
2000	1300	1800	2000	1400	10	
2000	1400	1800	2000	1450	11.3	
3000	1500	1800	2000	1560	12.7	
3200	1600	1800	2000	1600	14	
3300	1700	1800	2000	1700	15.4	
4000	2000	1800	2000	2090	24	
4500	2000	1800	2000	2650	34.3	:




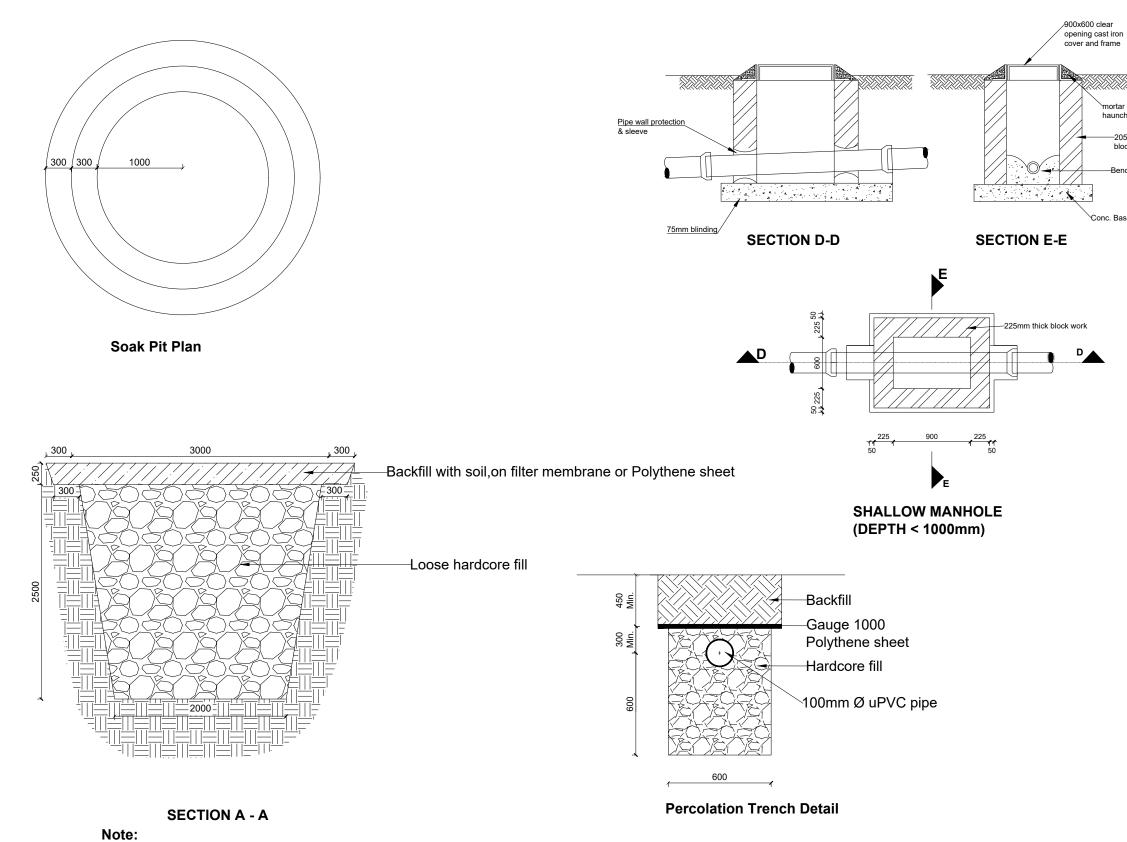


Detail for areas with sandy or red soils, for clay or black-cotton soils appropriate solutions to be determined on site.


		LEGEND
h		
5mm thick ckwork		
ching		
se		
	CLIENT :	
	CO-FINANCED BY:	ATER AND ENVIRONMENT
	Res.	THE WORLD BANK
		BRD - IDA WORLD BANKGROUP
		liance Consultants Itd In Association with Infra-Consult Ltd
	PROJECT :	
		VATER SUPPLY AND ATION PROJECT
	_	ATER SUPPLY AND ATION SYSTEM
	REVISIONS : No Date	Description
		NDARD DRAWINGS ole and Soak Pit Details
	Surveyed by: R.K	
	Drawn by: N.R Designed by:	
	W.G.M	
	J.K.K Date: January 202	3
	DRG. No.: ALA-ORA	A-SD-018
	Scale: Sheet No 1:120	1 of 1

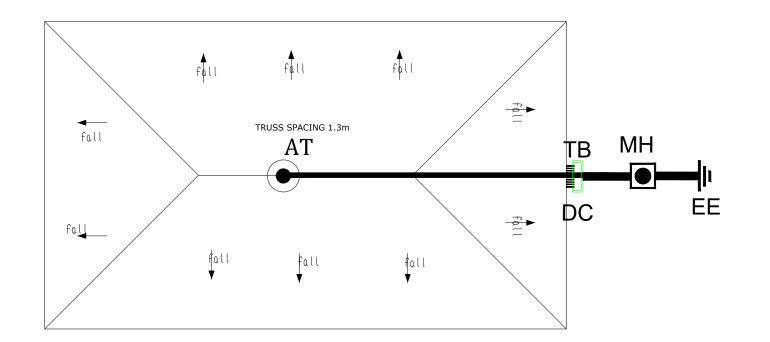


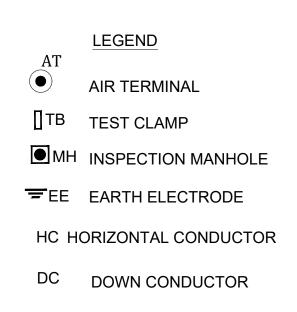

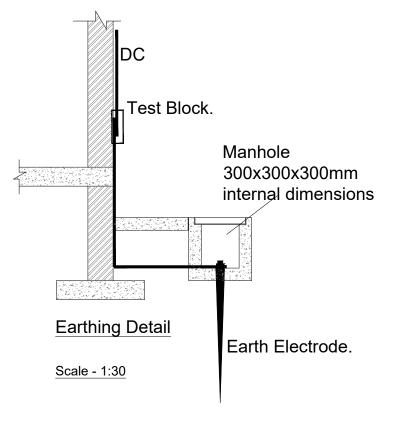



<u>NOTE</u> Air Terminal to be placed at the highest and center point of the roof					
CLIENT :					
THE REPUBLIC OF UGANDA MINISTRY OF WATER AND ENVIRONMENT					
CONSULTANT : Alliance Consultants Itd					
In Association with					
infra-Consult Ltd					
PROJECT : ALA-ORA WATER SUPPLY AND					
SANITATION PROJECT					
SANITATION SYSTEM					
REVISIONS : No Date Description					
DRAWING TITLE : STANDARD DRAWINGS					
Surveyed by:					
R.K Drawn by: N.R					
Designed by:					
W.G.M					
W.G.M Checked by: J.K.K					
W.G.M Checked by: J.K.K Date: January 2023					
W.G.M Checked by: J.K.K Date:					

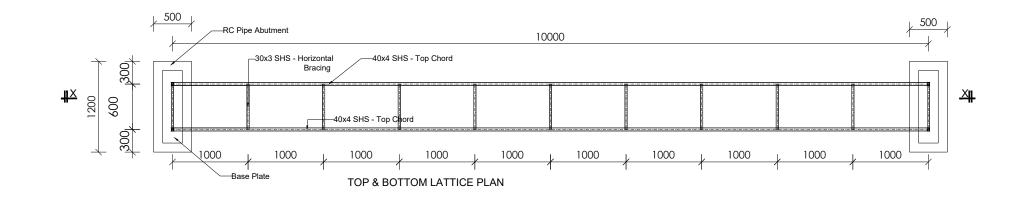

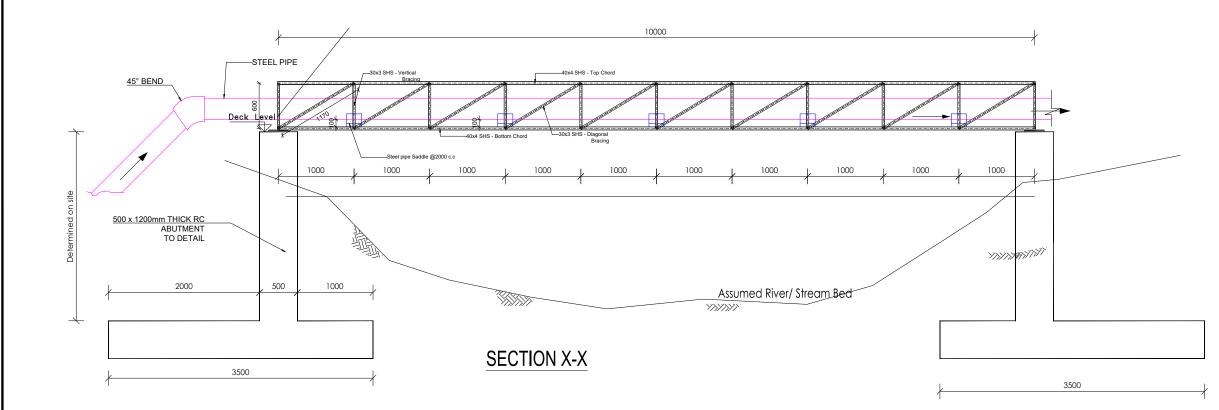


CLIENT :					
THE REPUBL	LIC OF UGANDA				
MINISTRY OF WATE	R AND ENVIRONMENT				
CO-FINANCED BY:					
CONSULTANT :					
Infra-Consult Ltd					
PROJECT :					
	ER SUPPLY AND				
STANDARI	D DRAWINGS				
REVISIONS : No Date	Description				
DRAWING TITLE : PIPE	E BRIDGES-10m				
Pla	n and Elevation				
Surveyed by: R.K					
Drawn by: A.K					
Designed by: B.A Checked by:					
J.K.K Date: March 2023					
DRG. No.: ALA-ORA-SD-020					
Scale: Sheet No.: 1:50	1 of 3				

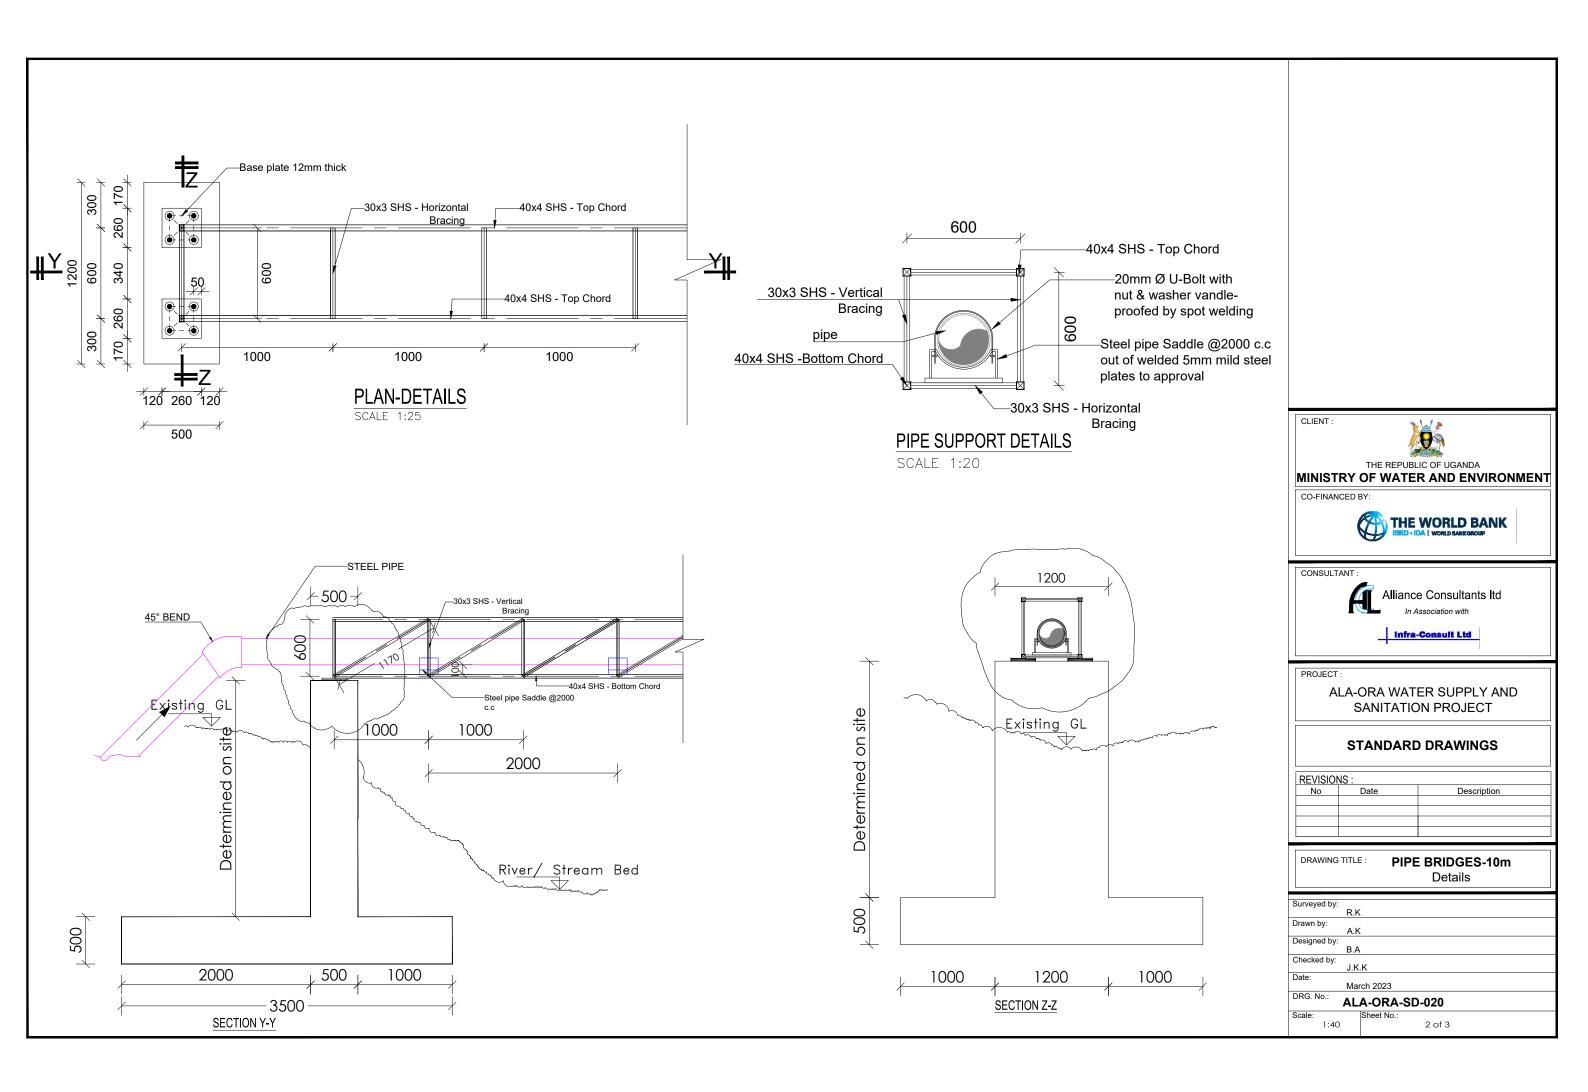


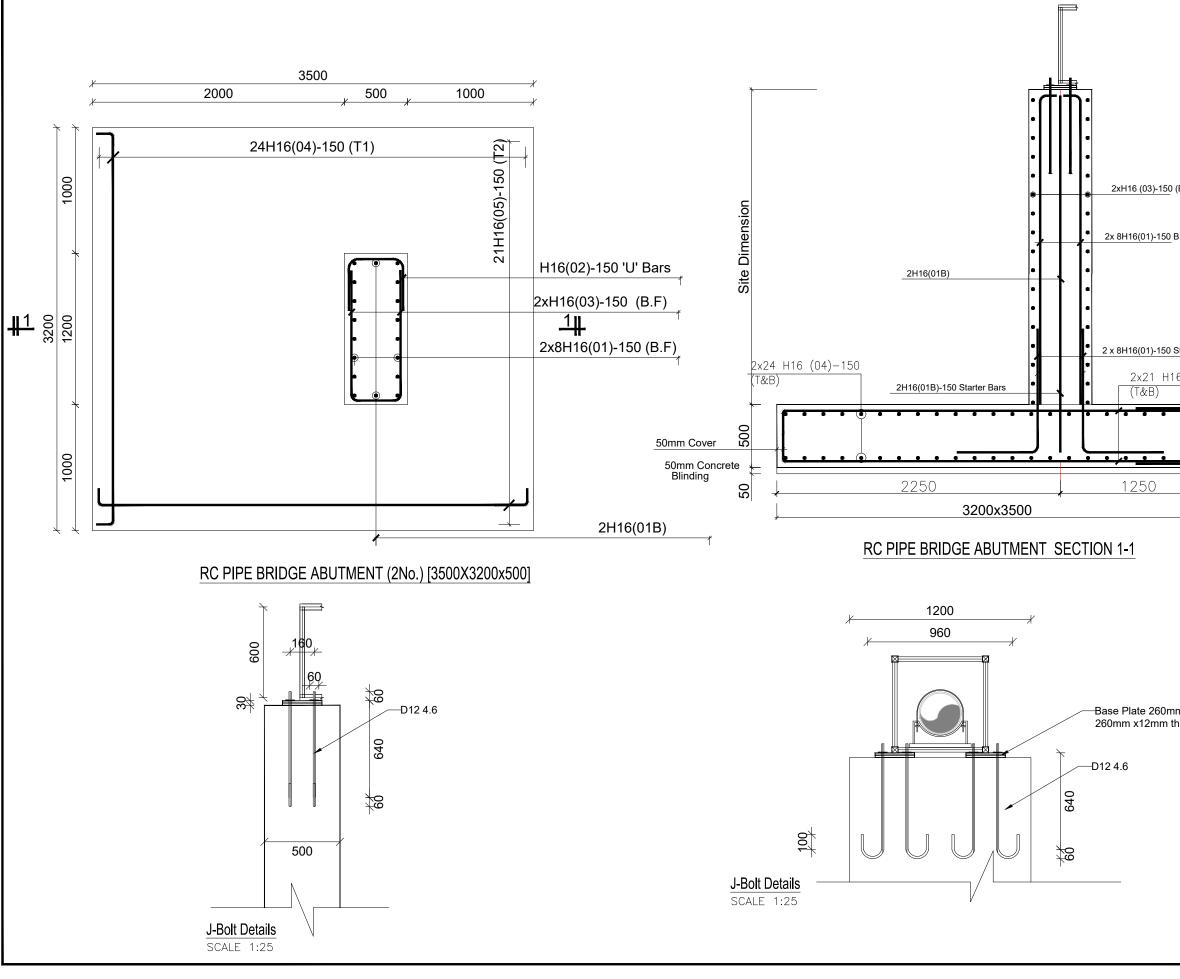


(B.F)	
3.F	
Starter Bars	CLIENT :
6 (05)-150	B
	THE REPUBLIC OF UGANDA MINISTRY OF WATER AND ENVIRONMENT
	CO-FINANCED BY:
<u> </u>	
	¥
* 	CONSULTANT :
*	Alliance Consultants Itd
	Infra-Consult Ltd
	PROJECT : ALA-ORA WATER SUPPLY AND
	SANITATION PROJECT
	STANDARD DRAWINGS
m x hick	REVISIONS : No Date Description
	DRAWING TITLE : PIPE BRIDGES-10m Reinforcement Details
	Surveyed by: R.K Drawn by:
	A.K Designed by: B.A
	Checked by: J.K.K Date:
	March 2023 DRG. No.: ALA-ORA-SD-020
	Scale: Sheet No.: 1:30 3 of 3

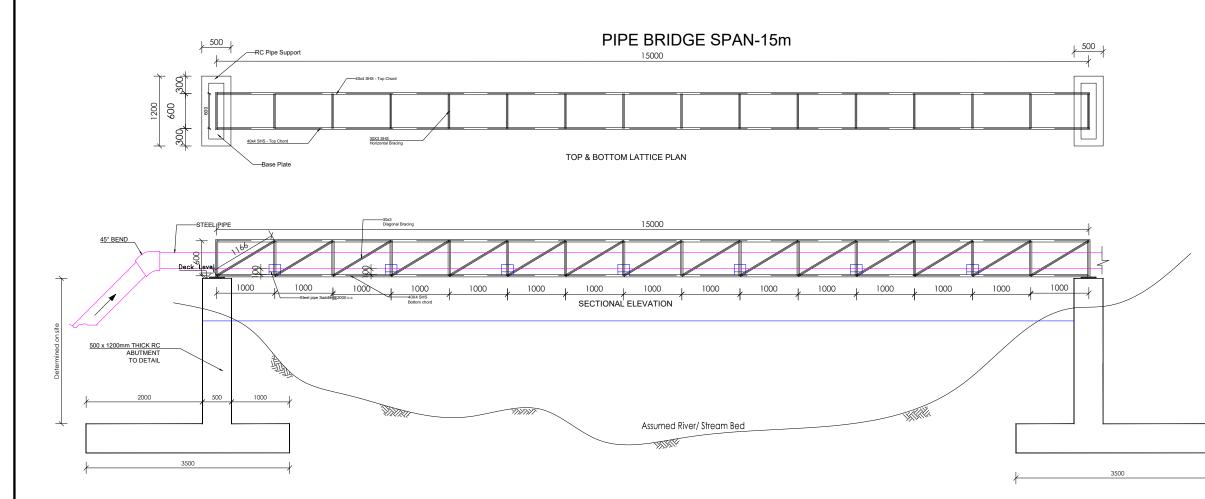


CLIENT : THE REPUBLIC OF UGANDA MINISTRY OF WATER AND ENVIRONMENT CO-FINANCED BY: THE WORLD BANK ISRD - IDA WORLD BANK GROUP
CONSULTANT : Alliance Consultants Itd In Association with
 PROJECT : ALA-ORA WATER SUPPLY AND SANITATION PROJECT STANDARD DRAWINGS REVISIONS : No Date
DRAWING TITLE : PIPE BRIDGES-15m Plan and Elevation
R.K Drawn by: A.K Designed by: B.A Checked by: J.K.K Date: March 2023 DRG. No.: ALA-ORA-SD-021
Scale: Sheet No.: 1:65 1 of 3

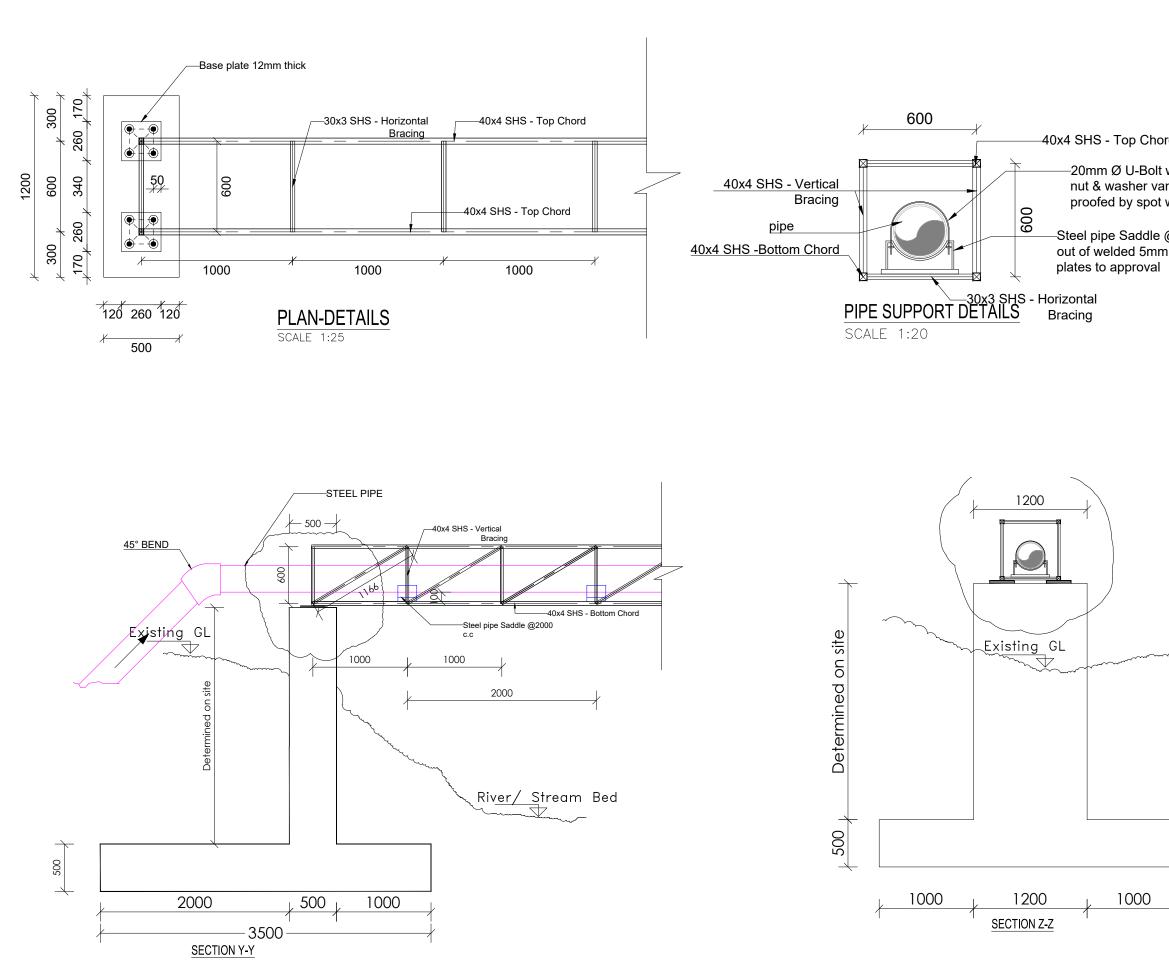


rd with ndle- welding @2000 c.c n mild steel	
	CLIENT : THE REPUBLIC OF UGANDA MINISTRY OF WATER AND ENVIRONMENT CO-FINANCED BY: CO-FINANCED BY: CO-FI
	CONSULTANT : Alliance Consultants Itd In Association with
~~~~	PROJECT : ALA-ORA WATER SUPPLY AND SANITATION PROJECT STANDARD DRAWINGS
	REVISIONS : No Date Description
	DRAWING TITLE : PIPE BRIDGES-15m Details
	Surveyed by: R.K Drawn by: A.K Designed by: B.A Checked by: J.K.K Date:
7	March 2023           DRG. No.:         ALA-ORA-SD-021           Scale:         1:40         2 of 3

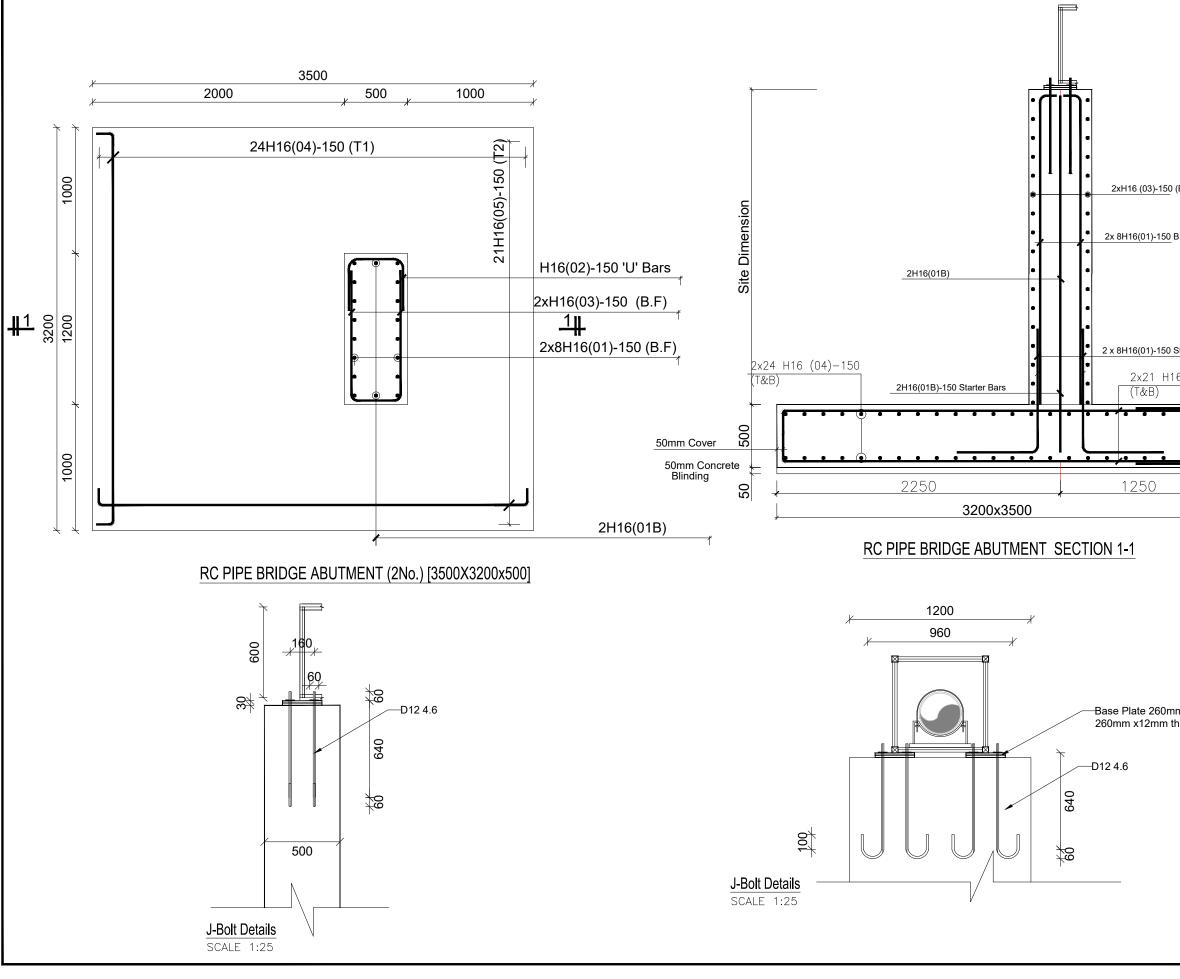


(B.F)	
3.F	
Starter Bars	CLIENT :
6 (05)-150	THE REPUBLIC OF UGANDA
	MINISTRY OF WATER AND ENVIRONMENT
	CO-FINANCED BY:
<u>_</u>	
Ĺ	CONSULTANT :
*	Alliance Consultants Itd
	In Association with
	Infra-Consult Ltd
	PROJECT : ALA-ORA WATER SUPPLY AND
	SANITATION PROJECT
	STANDARD DRAWINGS
m x	REVISIONS : No Date Description
hick	
	DRAWING TITLE : PIPE BRIDGES-15m
	Reinforcement Details
	Surveyed by: R.K
	Drawn by: A.K
	Designed by: B.A
	Checked by: J.K.K Date:
	March 2023
	Scale: Sheet No.:
	1:30 3 of 3

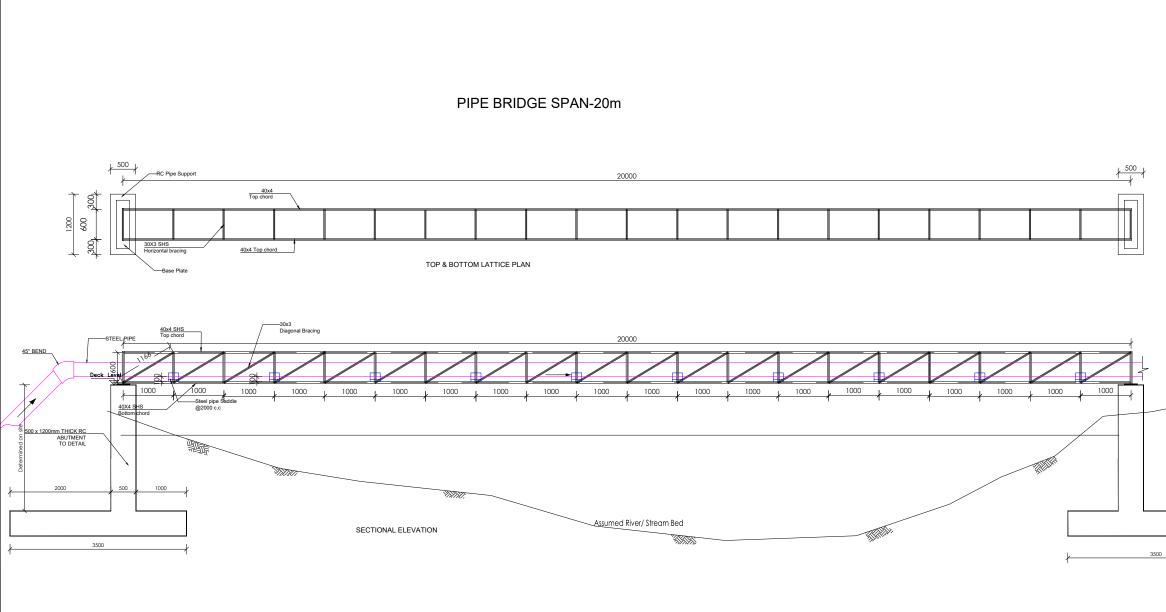

	CLIENT : THE REPUBLIC OF UGANDA MINISTRY OF WATER AND ENVIRONMENT CO-FINANCED BY: THE WORLD BANK END - IDA   WORLD BANK GROUP
	CONSULTANT : Alliance Consultants Itd In Association with
ł	PROJECT : ALA-ORA WATER SUPPLY AND SANITATION PROJECT STANDARD DRAWINGS
	REVISIONS : Description
	DRAWING TITLE : PIPE BRIDGES-20m Plan and Elevation
	A.K Designed by: B.A Checked by: J.K.K Date: March 2023
	Dros. No         ALA-ORA-SD-022           Scale:         1:75           1:75         1 of 3

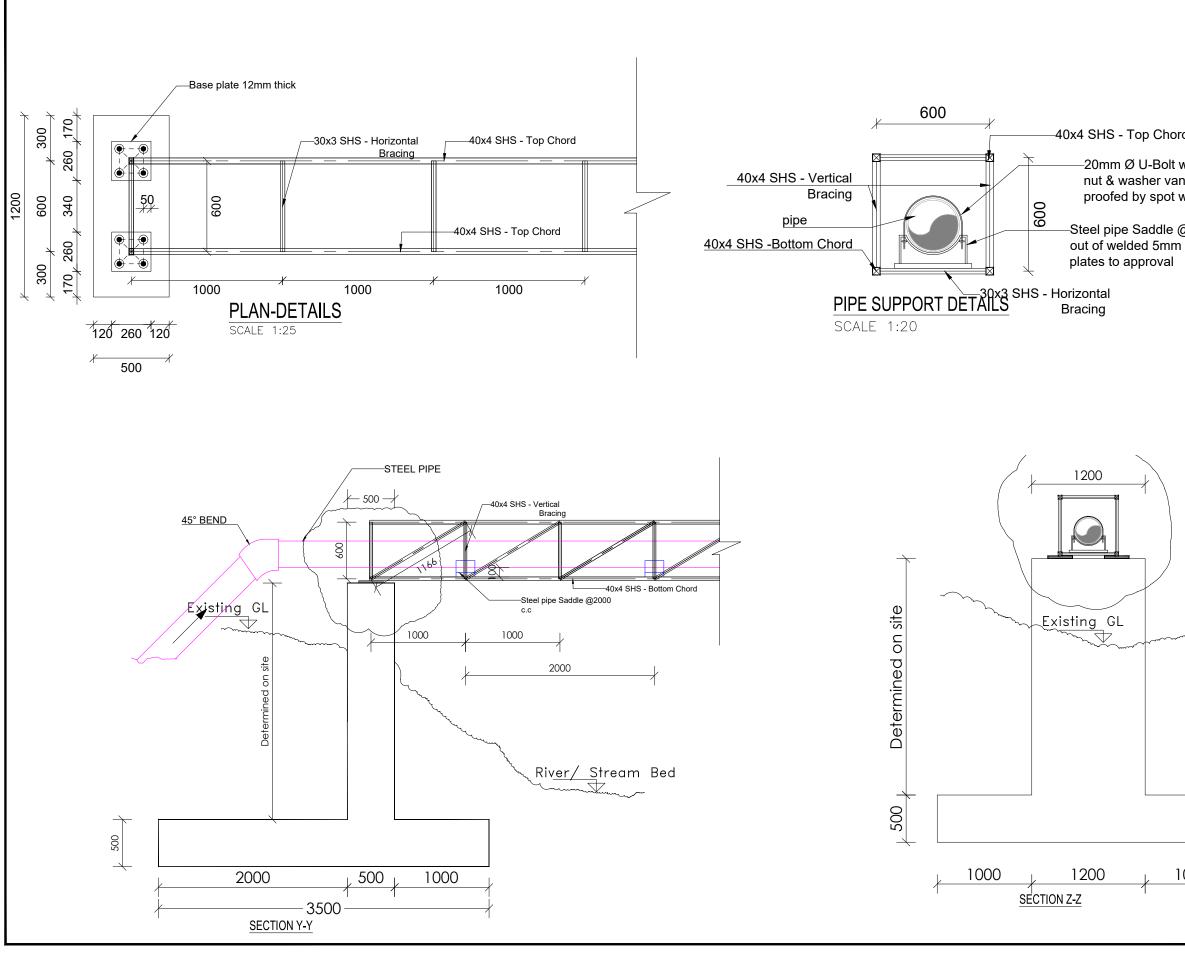


ord t with andle- t welding @2000 c.c m mild steel	CLIENT : MINISTRY CO-FINANCED B	OF WATE	
	CONSULTANT :		e Consultants Itd
	S	SANITATIC	ER SUPPLY AND DN PROJECT
	REVISIONS : No		Description
	DRAWING TITLE	E: PIPE	BRIDGES-20m Details
	Surveyed by: R.K Drawn by:		
1000	A.K Designed by: B.A Checked by: J.K		
1		rch 2023	
		A-ORA-SE	0-022
	Scale: 1:40	Sheet No.:	2 of 3

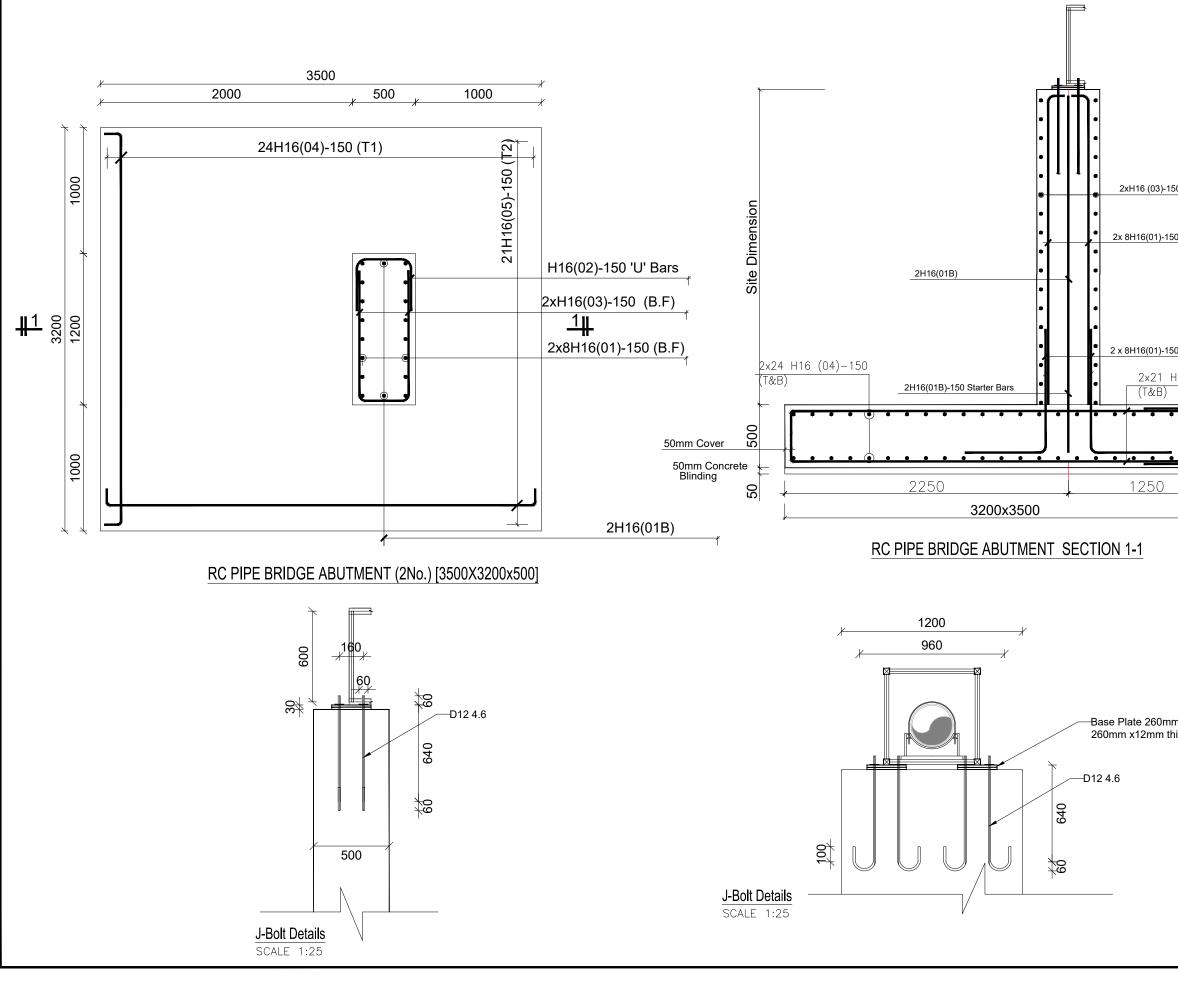


50 (B.F)	
<u>0</u> B.F	
0 Starter Bars	CLIENT :
116 (05)-150	<b>N</b>
	THE REPUBLIC OF UGANDA
	MINISTRY OF WATER AND ENVIRONMENT
	CO-FINANCED BY:
ļ	
	CONSULTANT :
<del>/</del>	Alliance Consultants Itd
	In Association with
	infra-Consult Ltd
	PROJECT :
	ALA-ORA WATER SUPPLY AND
	SANITATION PROJECT
	STANDARD DRAWINGS
	REVISIONS :
n x iick	No Date Description
	DRAWING TITLE : PIPE BRIDGES-20m
	Reinforcement Details
	Surveyed by:
	R.K Drawn by:
	A.K Designed by:
	B.A Checked by:
	J.K.K Date:
	March 2023
	Scale: Sheet No.:
	1:30 3 of 3




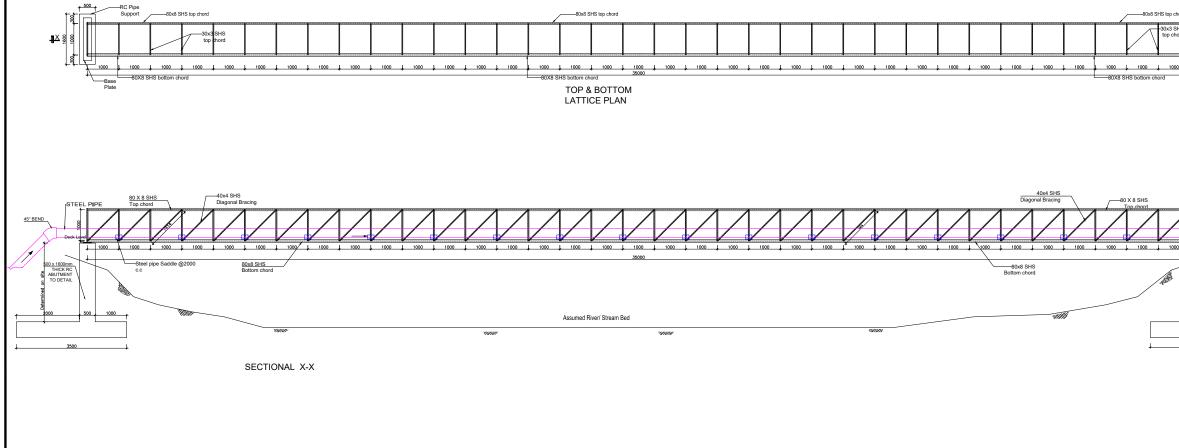


CLIENT :
THE REPUBLIC OF UGANDA MINISTRY OF WATER AND ENVIRONMENT
CO-FINANCED BY:
CONSULTANT : Alliance Consultants Itd In Association with
PROJECT :
 ALA-ORA WATER SUPPLY AND SANITATION PROJECT
STANDARD DRAWINGS
No         Date         Description
DRAWING TITLE : PIPE BRIDGES-35m Plan and Elevation
Surveyed by: R.K
Drawn by: A.K Designed by:
B.A Checked by:
J.K.K Date: March 2023
DRG. No.: ALA-ORA-SD-023
Scale: Sheet No.: 1:120 1 of 3

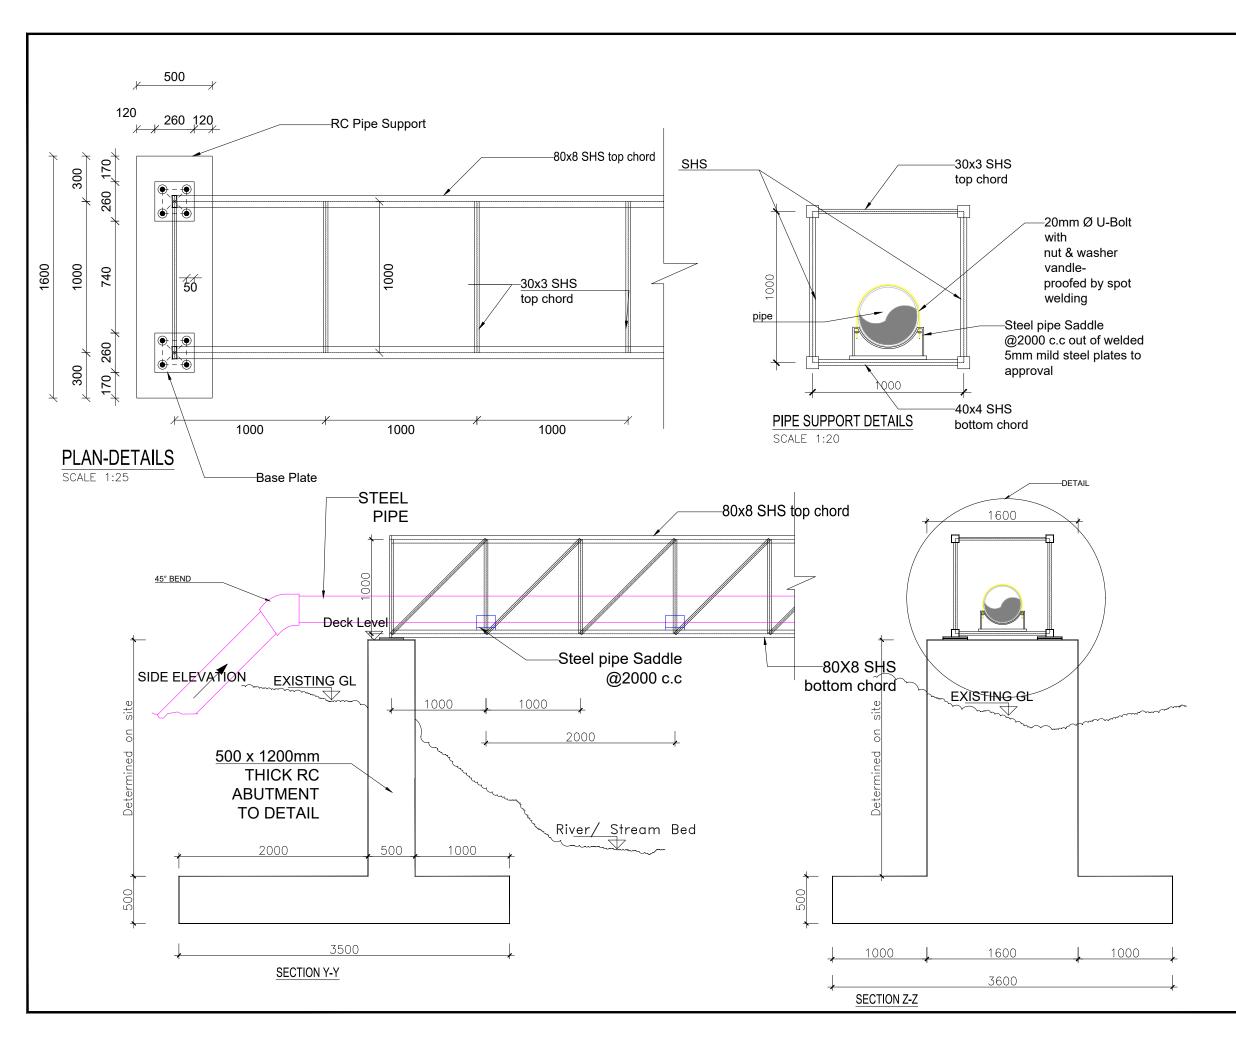

CLIENT :	al of
<u>6</u>	<b>9</b> 2
	IC OF UGANDA R AND ENVIRONMENT
CO-FINANCED BY:	
9	
CONSULTANT :	
	e Consultants Itd
Infra	-Consult Ltd
	ER SUPPLY AND
	ON PROJECT
STANDARL	DRAWINGS
REVISIONS : No Date	Description
DRAWING TITLE : PIPE	BRIDGES-35m
	Details
Surveyed by: R.K	
Drawn by: A.K Designed by:	
B.A Checked by: J.K.K	
Date: March 2023	
DRG. No.: ALA-ORA-SD	0-023
Scale: Sheet No.:	

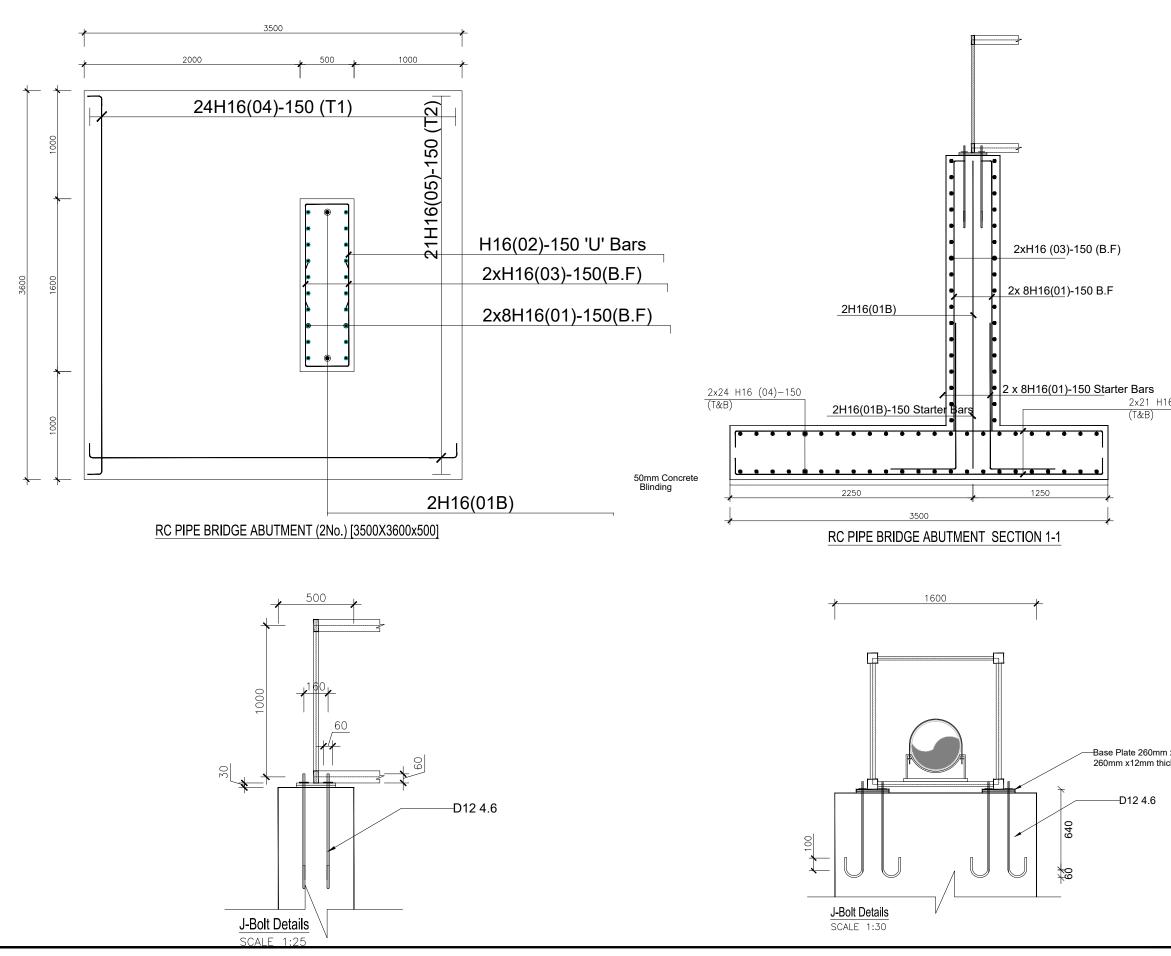


<u>6 (05)–1</u> 50	CLIENT : MINISTRY CO-FINANCED	OF WATE	IC OF UGANDA R AND ENVIRONMENT WORLD BANK
	CONSULTANT		e Consultants Itd ssociation with
	5	SANITATIC	ER SUPPLY AND ON PROJECT
,	REVISIONS : No	Date	Description
x k	DRAWING TITLI		BRIDGES-35m orcement Details
	Surveyed by: R.k Drawn by: Designed by: B.A	<	
	Checked by: J.K Date: Ma		0-023
	Scale: 1:35	Sheet No.:	3 of 3

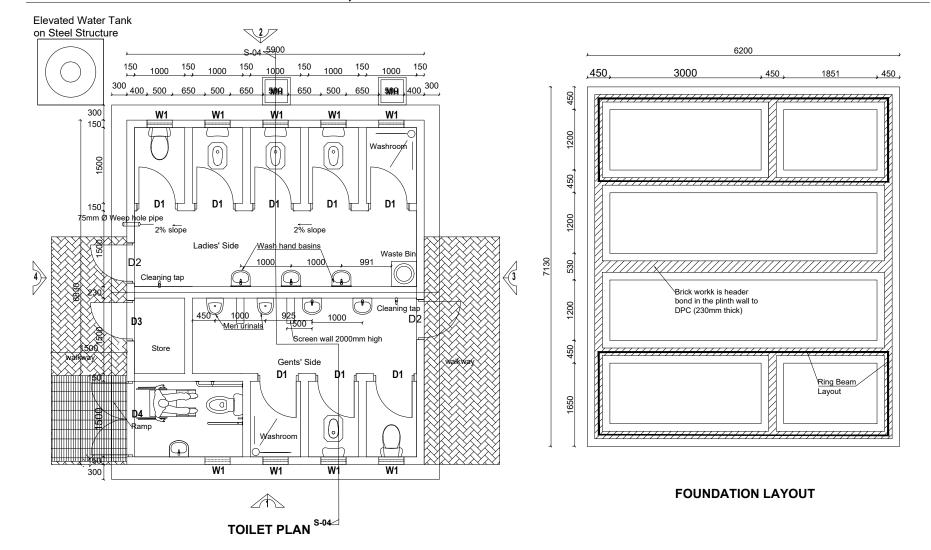


## EIGHT STANCE WITH DISABLED UNIT, STORE AND A BATHROOM WATERBORNE TOILET FULLY ROOFED

LEGEND
CLIENT :
MINISTRY OF WATER AND ENVIRONMENT
CONSULTANT :
Alliance Consultants Itd
In Association with
PROJECT : ALA-ORA WATER SUPPLY AND
SANITATION PROJECT
NYAGAK WATER SUPPLY AND SANITATION SYSTEM
REVISIONS :           No         Date   Description
DRAWING TITLE : SANITATION FACILITIES Public Toilets - Plan and Foundation Layout
Surveyed by: R.K
Drawn by: M.K Designed by:
W.G.M Checked by:
J.K.K Date:
January 2023 DRG. No.: ALA-ORA- SAN-001
Scale: Sheet No.: 1:75 1 of 6

# EIGHT STANCE WITH DISABLED UNIT, STORE AND A BATHROOM WATERBORNE TOILET FULLY ROC

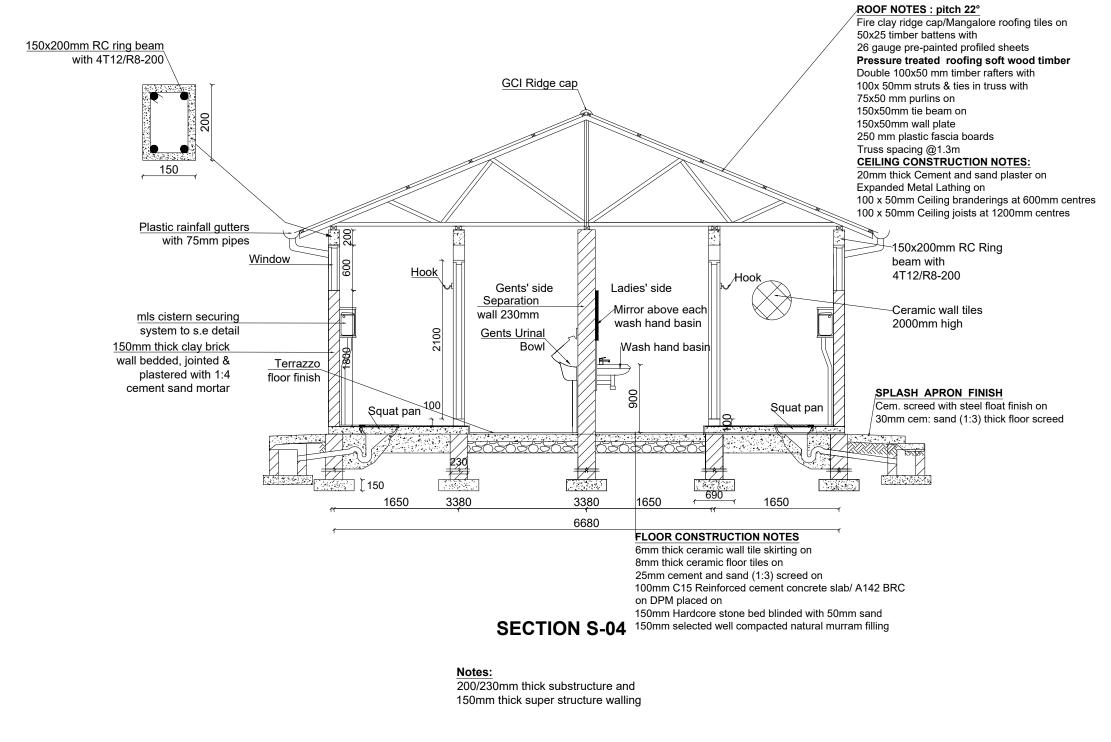

	LEGEND
DFED	
	CLIENT :
	THE REPUBLIC OF UGANDA MINISTRY OF WATER AND ENVIRONMENT
	CO-FINANCED BY:
	CONSULTANT : Alliance Consultants Itd In Association with
	PROJECT :
	ALA-ORA WATER SUPPLY AND SANITATION PROJECT
	NYAGAK WATER SUPPLY AND SANITATION SYSTEM
	REVISIONS :       No     Date         Description
	DRAWING TITLE : SANITATION FACILITIES Public Toilets - Section
	Surveyed by: R.K
	Drawn by: M.K Designed by:
	W.G.M Checked by: J.K.K
	Date: January 2023
	DRG. No.: ALA-ORA- SAN-001 Scale:  Sheet No.:
	1:50 2 of 6

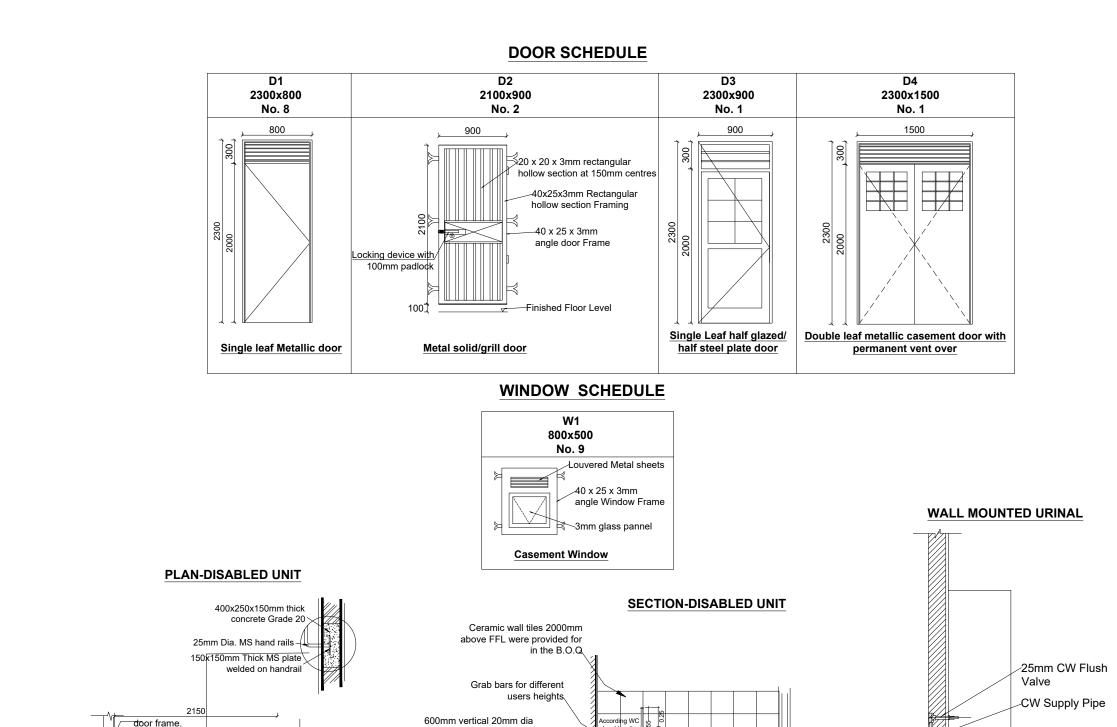

Door

Floor slope 2%

Urinal

Drop pipe

90° Elbow Inlet

of 80x40mm

-100mm pipe connected to

Floor Level

Novic or sewerline

 $\gg$ 

galvanised pipe grab rail

approval.

movable galvanised grab

Water cisterr

600mm Horizontal 20mm dia

galvanised pipe grab rail

¹≥900mm long horizontal

600mm long vertical

–galvanised grab rail.

to engineers approval.

_movable galvanised grab rail

galvanised grab-rails with different heights

Ceramic wall tiles where provided for in the B.O.Q

÷


0

Terrazzo floor

2%<u>slo</u>pe


D

LEGEND			
CLIENT :			
THE REPUBL	LIC OF UGANDA		
	R AND ENVIRONMENT		
CO-FINANCED BY:			
	WORLD BANK BANK BANK BANK BANK BANK BANK BANK		
CONSULTANT :			
	e Consultants Itd		
Infra-Consult Ltd			
PROJECT : ALA-ORA WAT	ER SUPPLY AND		
SANITATIC	ON PROJECT		
NYAGAK WATER SUPPLY AND SANITATION SYSTEM			
REVISIONS : No Date	Description		
	Description		
DRAWING TITLE : SANITATIO	N FACILITIES		
Public Toilets - Door and Window Sche	edule, Disabled Unit Details & Urinal Detail		
Surveyed by: R.K Drawn by:			
M.K Designed by:			
W.G.M Checked by: J.K.K			
Date: January 2023			
Date: January 2023 DRG. No.: ALA-ORA- SAN-00	1		

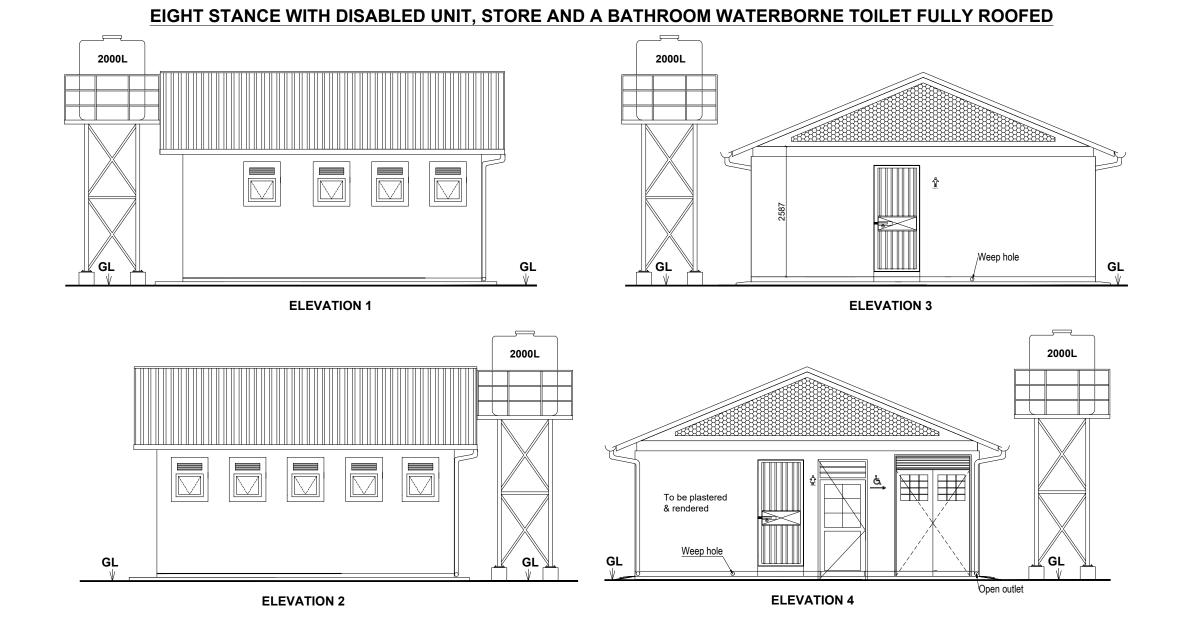

THE REPUBLIC OF UGANDA MINISTRY OF WATER AND ENVIRONMENT CO-FINANCED BY: THE WORLD BANK DERD - IDA   WORLD BANKGROUP CONSULTANT : Alliance Consultants Itd			
THE REPUBLIC OF UGANDA MINISTRY OF WATER AND ENVIRONMENT CO-FINANCED BY: THE WORLD BANK DERD - IDA   WORLD BANKGROUP CONSULTANT : Alliance Consultants Itd			
THE REPUBLIC OF UGANDA MINISTRY OF WATER AND ENVIRONMENT CO-FINANCED BY: CO-FINANCED BY: CONSULTANT: Alliance Consultants Itd			
THE REPUBLIC OF UGANDA MINISTRY OF WATER AND ENVIRONMENT CO-FINANCED BY: THE WORLD BANK DERD - IDA   WORLD BANKGROUP CONSULTANT : Alliance Consultants Itd			
THE REPUBLIC OF UGANDA MINISTRY OF WATER AND ENVIRONMENT CO-FINANCED BY: CONSULTANT:			
THE REPUBLIC OF UGANDA MINISTRY OF WATER AND ENVIRONMENT CO-FINANCED BY: CONSULTANT:			
THE REPUBLIC OF UGANDA MINISTRY OF WATER AND ENVIRONMENT CO-FINANCED BY: CONSULTANT:			
THE REPUBLIC OF UGANDA MINISTRY OF WATER AND ENVIRONMENT CO-FINANCED BY: CONSULTANT:			
THE REPUBLIC OF UGANDA MINISTRY OF WATER AND ENVIRONMENT CO-FINANCED BY: CONSULTANT:			
THE REPUBLIC OF UGANDA MINISTRY OF WATER AND ENVIRONMENT CO-FINANCED BY: CONSULTANT:			
CO-FINANCED BY:			
CO-FINANCED BY:			
CONSULTANT : Alliance Consultants Itd			
CONSULTANT : Alliance Consultants Itd			
Alliance Consultants Itd			
infra-Consuit Ltd			
ALA-ORA WATER SUPPLY AND			
SANITATION PROJECT			
NYAGAK WATER SUPPLY AND SANITATION SYSTEM			
REVISIONS :           No         Date			
DRAWING TITLE : SANITATION FACILITIES Public Toilets - Elevations			
Surveyed by:			
R.K Drawn by: M.K			
Designed by: W.G.M			
Checked by: J.K.K Date:			
January 2023			
ALA-ORA- SAN-001           Scale:         Sheet No.:           1:75         4 of 6			

## EIGHT STANCE WITH DISABLED UNIT, STORE AND A BATHROOM WATERBORNE TOILET FULLY ROOFED

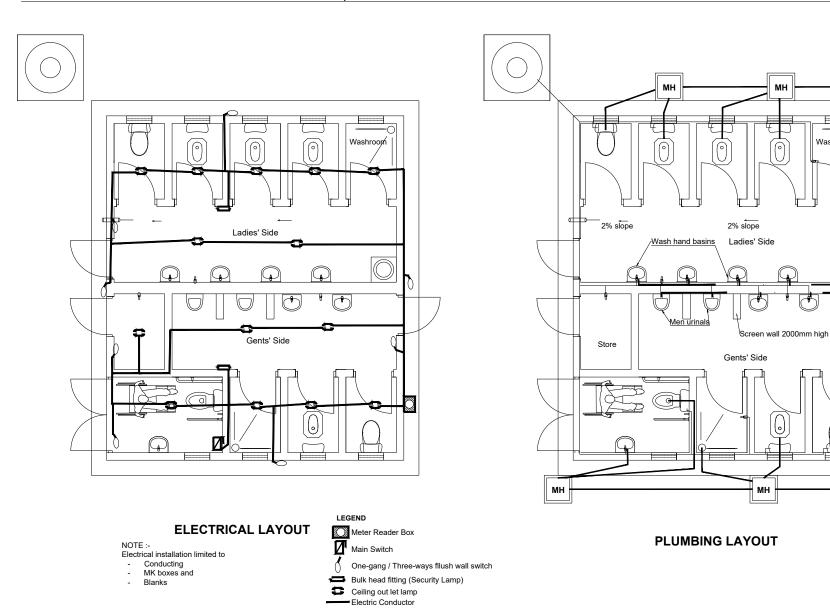

LEGEND			
CLIENT :			
THE REPUBLIC	OF UGANDA		
MINISTRY OF WATER			
IBRD - IDA	WORLD BANKGROUP		
CONSULTANT :			
Alliance Consultants Itd			
Infra-Consult Ltd			
PROJECT :			
ALA-ORA WATER SUPPLY AND			
SANITATION PROJECT			
NYAGAK WATEI SANITATIO			
REVISIONS : No Date	Description		
DRAWING TITLE. SANITATION FACILITIES Public Toilets - Electrical & Plumbing Layouts			
Surveyed by:			
R.K Drawn by: M.K			
Designed by: W.G.M			
Checked by: J.K.K			
Date: January 2023			
DRG No ·			
	6 of 6		

To Novic Tank 4

.)

 $\odot$ 

мн


Washroor

Waste Bin

ΜН

мн

мн

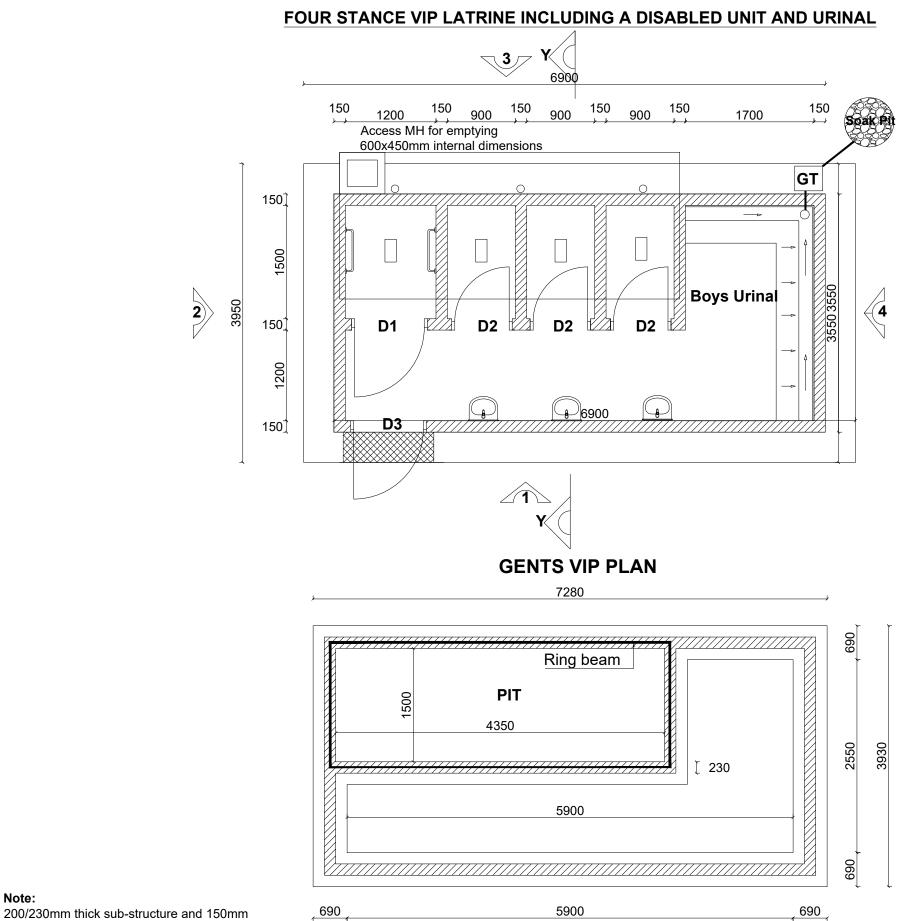


FOUNDATION LAYOUT

Note:


thick super structure walling

LEGEND			
CLIENT :			
🤌	<b>B</b>		
	C OF UGANDA R AND ENVIRONMENT		
CO-FINANCED BY:			
CONSULTANT :			
	Consultants Itd		
	Consult Ltd		
ALA-ORA WATER SUPPLY AND SANITATION PROJECT			
NYAGAK WATER SUPPLY AND SANITATION SYSTEM			
REVISIONS : No Date			
	Description		
	Description		
	Description		
DRAWING TITLE : SANITATION VIP Latrine Gents - Plar			
DRAWING TITLE : VIP Latrine Gents - Plan	N FACILITIES		
DRAWING TITLE: VIP Latrine Gents - Plan Surveyed by: R.K Drawn by: M.K Designed by:	N FACILITIES		
DRAWING TITLE - SANITATION VIP Latrine Gents - Plar Surveyed by: R.K Drawn by: M.K Designed by: W.G.M Checked by:	N FACILITIES		
DRAWING TITLE : SANITATION VIP Latrine Gents - Plar Surveyed by: R.K Drawn by: M.K Designed by: W.G.M	N FACILITIES		
DRAWING TITLE . SANITATION VIP Latrine Gents - Plar Surveyed by: R.K Drawn by: M.K Designed by: W.G.M Checked by: J.K.K Date:	N FACILITIES		

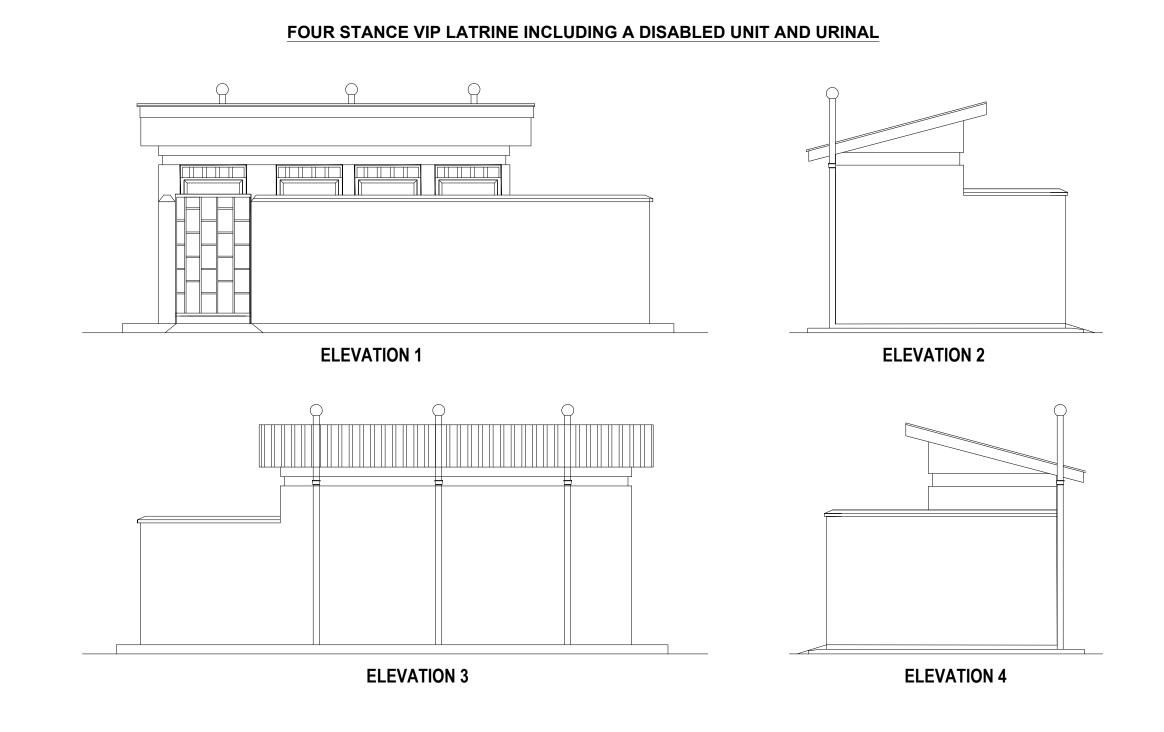


LEGEND			
CLIENT :			
	Ð		
	IC OF UGANDA R AND ENVIRONMENT		
CO-FINANCED BY:			
CONSULTANT :			
Infra-Consult Ltd			
PROJECT : ALA-ORA WATER SUPPLY AND			
	ER SUPPLY AND		
ALA-ORA WAT	ER SUPPLY AND IN PROJECT		
ALA-ORA WATI SANITATIC NYAGAK WATE			
ALA-ORA WATI SANITATIC NYAGAK WATE	N PROJECT		
ALA-ORA WATI SANITATIC NYAGAK WATE SANITATIC	ON PROJECT ER SUPPLY AND DN SYSTEM		
ALA-ORA WATI SANITATIC NYAGAK WATE SANITATIC	ON PROJECT ER SUPPLY AND DN SYSTEM		
ALA-ORA WATI SANITATIC NYAGAK WATE SANITATIC REVISIONS : No Date	DN PROJECT ER SUPPLY AND DN SYSTEM Description		
ALA-ORA WATI SANITATIC NYAGAK WATE SANITATIC REVISIONS : No Date	N PROJECT ER SUPPLY AND Description N FACILITIES		
ALA-ORA WATI SANITATIC NYAGAK WATE SANITATIC REVISIONS : No Date DRAWING TITLE : SANITATIO VIP Latrine Ge Surveyed by: R.K Drawn by: M.K	N PROJECT ER SUPPLY AND Description N FACILITIES		
ALA-ORA WATI SANITATIC NYAGAK WATE SANITATIC REVISIONS : No Date DRAWING TITLE : SANITATIO VIP Latrine Ge Surveyed by: R.K Drawn by: M.K Designed by: W.G.M Checked by:	N PROJECT ER SUPPLY AND Description N FACILITIES		
ALA-ORA WATI SANITATIC NYAGAK WATE SANITATIC REVISIONS : No Date DRAWING TITLE: SANITATIO VIP Latrine Ge Surveyed by: R.K Drawn by: M.K Designed by: W.G.M Checked by: J.K.K Date:	N PROJECT ER SUPPLY AND Description N FACILITIES		
ALA-ORA WATI SANITATIC NYAGAK WATE SANITATIC REVISIONS : No Date DRAWING TITLE : SANITATIO VIP Latrine Ge Surveyed by: R.K Drawn by: M.K Designed by: W.G.M Checked by: J.K.K	Description		

## FOUR STANCE VIP LATRINE INCLUDING A DISABLED UNIT AND URINAL

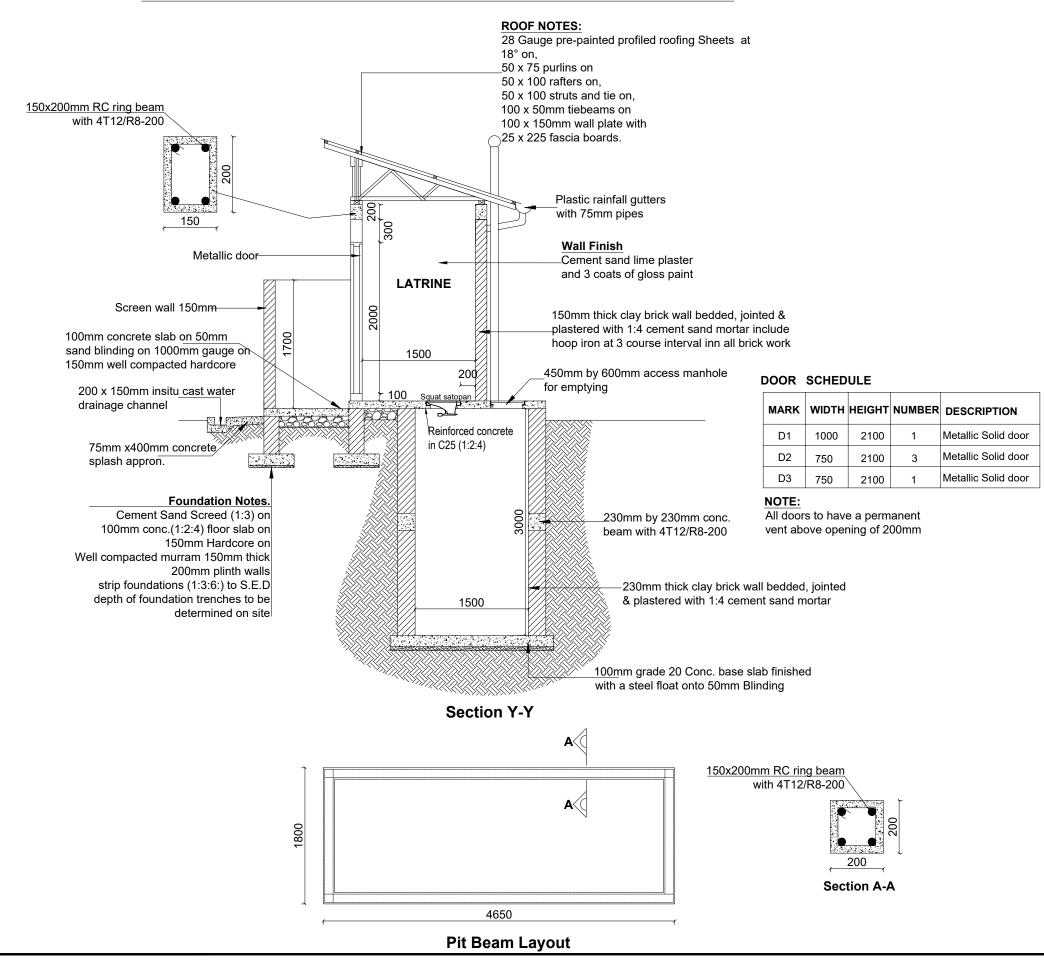


LEGEND			
	7		
CLIENT :			
THE REPUBLIC OF UGANDA			
MINISTRY OF WATER AND ENVIRONMENT			
IBRD - IDA   WORLD BANKGROUP			
CONSULTANT :	]		
Alliance Consultants Itd			
Infra-Consult Ltd			
PROJECT :			
ALA-ORA WATER SUPPLY AND SANITATION PROJECT			
NYAGAK WATER SUPPLY AND			
SANITATION SYSTEM			
REVISIONS : No Date Description	-		
	J		
VIP Latrine Gents - Section & Door and Window Schedule			
VIP Latrine Gents - Section & Door and Window Schedule Surveyed by:	_		
VIP Latrine Gents - Section & Door and Window Schedule	_		
VIP Latrine Gents - Section & Door and Window Schedule Surveyed by: R.K Drawn by: M.K Designed by: W.G.M			
VIP Latrine Gents - Section & Door and Window Schedule Surveyed by: R.K Drawn by: M.K Designed by:			
VIP Latrine Gents - Section & Door and Window Schedule Surveyed by: R.K Drawn by: M.K Designed by: W.G.M Checked by: J.K.K			

FIVE STANCE VIP LATRINE INCLUDING A DISABLED UNIT AND INCINERATOR

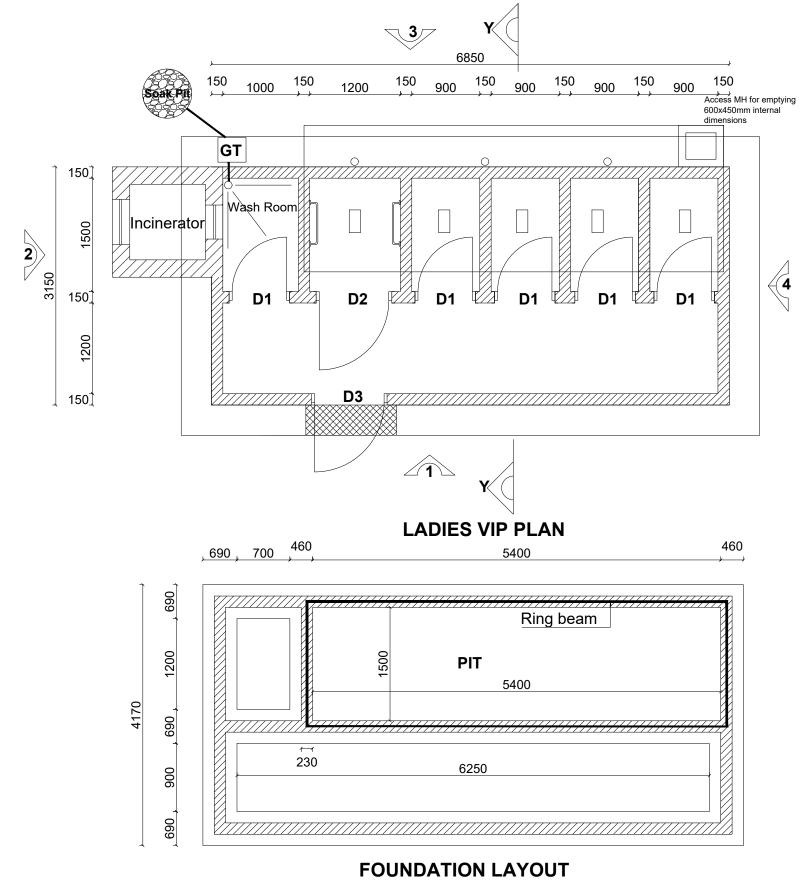


LEGEND			
CLIENT :			
THE REPUBLIC OF UGANDA			
MINISTRY OF WATER AND ENVIRONMENT			
IBRD • IDA   WORLD BANKGROUP			
CONSULTANT :			
Alliance Consultants Itd			
infra-Consult Ltd			
PROJECT : ALA-ORA WATER SUPPLY AND			
SANITATION PROJECT			
NYAGAK WATER SUPPLY AND			
SANITATION SYSTEM			
No Date Description			
DRAWING TITLE - SANITATION FACILITIES VIP Latrine Ladies - Plan and Foundation Layout			
Surveyed by: R.K			
Drawn by: M.K Designed by:			
W.G.M Checked by:			
J.K.K Date: January 2023			
DRG. No.: ALA-ORA- SAN-003 Scale: Sheet No.:			

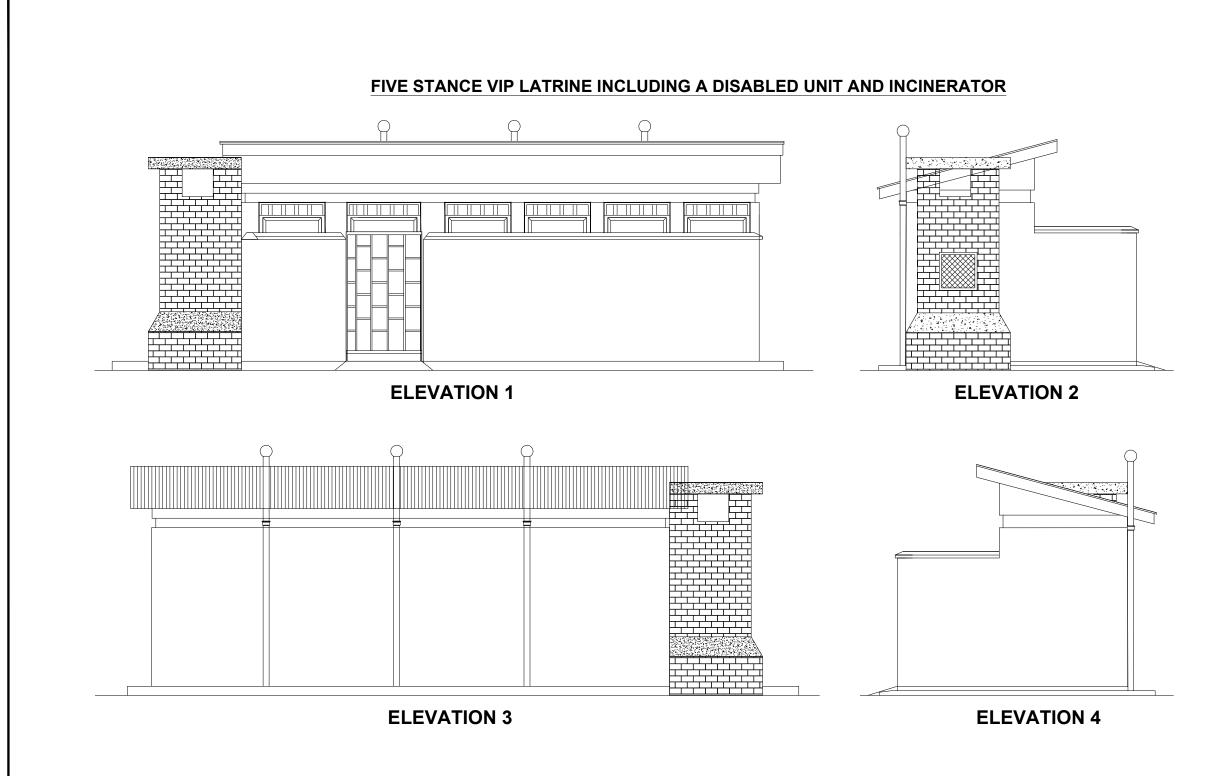


LEGEND			
CLIENT :			
THE REPUBLIC OF UGANDA			
MINISTRY OF WATER AND ENVIRONMEN	Т		
IBRD - IDA   WORLD BANKGROUP			
CONSULTANT :	-		
Alliance Consultants Itd			
In Association with			
PROJECT :			
ALA-ORA WATER SUPPLY AND SANITATION PROJECT			
NYAGAK WATER SUPPLY AND			
NYAGAK WATER SUPPLY AND SANITATION SYSTEM			
SANITATION SYSTEM			
SANITATION SYSTEM			
SANITATION SYSTEM			
SANITATION SYSTEM         REVISIONS :       Description         No       Date       Description         Understand       Understand       Understand         DRAWING TITLE :       SANITATION FACILITIES			
SANITATION SYSTEM         REVISIONS :       Description         No       Date       Description         DRAWING TITLE :       SANITATION FACILITIES       VIP Latrine Ladies - Elevations         Surveyed by:       Surveyed by:			
SANITATION SYSTEM         REVISIONS :       Description         No       Date       Description         Drawing Title :       Sanitation Facilities         VIP Latrine Ladies - Elevations       Surveyed by:         R.K       Drawn by:			
SANITATION SYSTEM         REVISIONS :       Description         No       Date       Description         Drawing Title :       Sanitation Facilities         VIP Latrine Ladies - Elevations       Surveyed by:         R.K       Drawn by:       M.K         Designed by:       W.G.M			
SANITATION SYSTEM         REVISIONS :       Description         No       Date       Description         Date       Description       Description         DRAWING TITLE :       SANITATION FACILITIES       VIP Latrine Ladies - Elevations         Surveyed by:       R.K       Drawn by:       M.K         Designed by:       M.K       Designed by:			
SANITATION SYSTEM         REVISIONS :       Description         No       Date       Description         Date       Description       Description         DRAWING TITLE :       SANITATION FACILITIES         VIP Latrine Ladies - Elevations       VIP Latrine Ladies - Elevations         Surveyed by:       R.K         Drawn by:       M.K         Designed by:       W.G.M         Checked by:       J.K.K			


## FIVE STANCE VIP LATRINE INCLUDING A DISABLED UNIT AND INCINERATOR

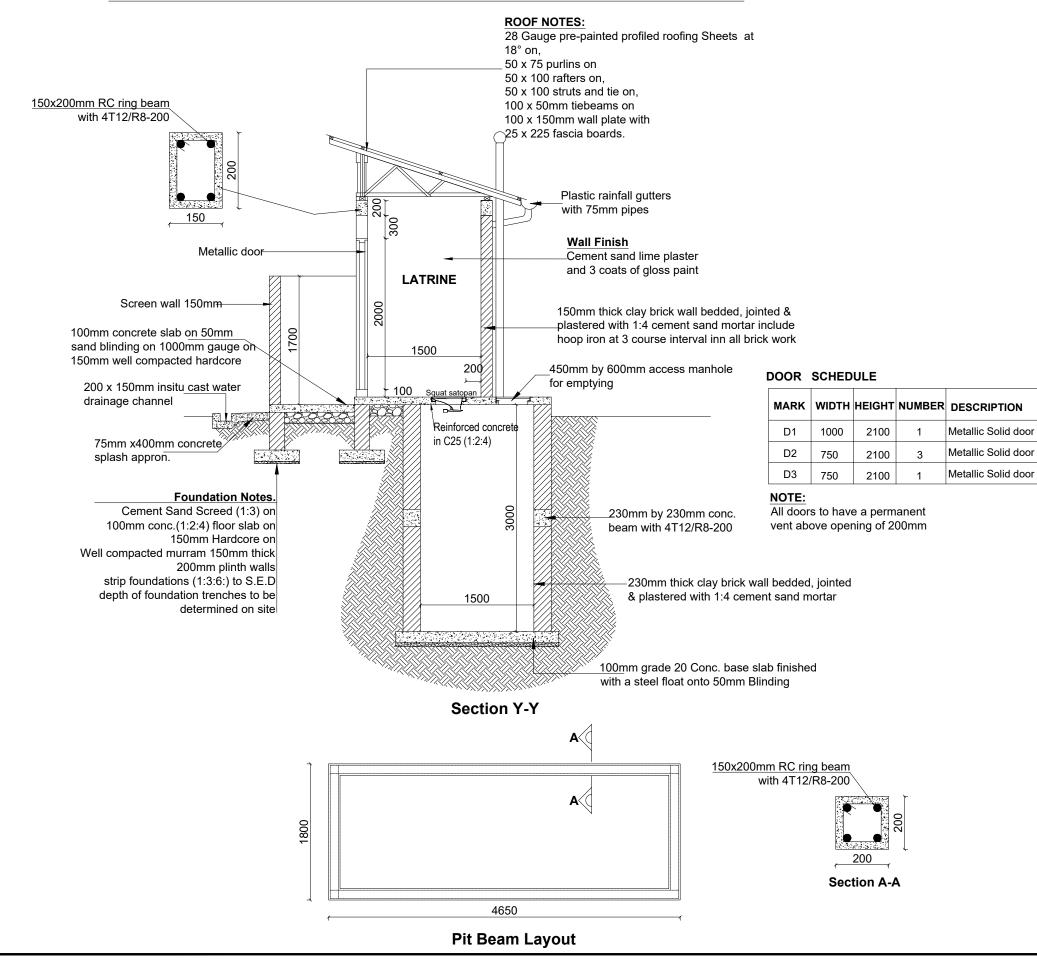

	LEGEND		
CLIENT :			
	IC OF UGANDA R AND ENVIRONMENT		
CO-FINANCED BY:			
CONSULTANT :			
Alliance Consultants Itd			
In A	SSOCIATION WITH		
	Consult Ltd		
Infra-			
PROJECT : ALA-ORA WAT	Consult Ltd ER SUPPLY AND		
PROJECT : ALA-ORA WATI SANITATIC	Consult Ltd ER SUPPLY AND IN PROJECT		
PROJECT : ALA-ORA WATI SANITATIC NYAGAK WATE	Consult Ltd ER SUPPLY AND		
PROJECT : ALA-ORA WATI SANITATIC NYAGAK WATE	Consult Ltd ER SUPPLY AND IN PROJECT ER SUPPLY AND		
PROJECT : ALA-ORA WATI SANITATIC NYAGAK WATE SANITATIC	Consult Ltd ER SUPPLY AND ON PROJECT ER SUPPLY AND ON SYSTEM		
PROJECT : ALA-ORA WATE SANITATIC NYAGAK WATE SANITATIC REVISIONS : No Date	Consult Ltd ER SUPPLY AND IN PROJECT ER SUPPLY AND DN SYSTEM Description		
PROJECT : ALA-ORA WATE SANITATIC NYAGAK WATE SANITATIC REVISIONS : No Date Drawing title : SANITATIO	Consult Ltd ER SUPPLY AND IN PROJECT ER SUPPLY AND Description		
PROJECT : ALA-ORA WATI SANITATIO NYAGAK WATE SANITATIO REVISIONS : No Date DRAWING TITLE: SANITATIO VIP Latrine Ladies - Section Surveyed by:	Consult Ltd ER SUPPLY AND IN PROJECT ER SUPPLY AND DN SYSTEM Description		
PROJECT : ALA-ORA WATI SANITATIC NYAGAK WATE SANITATIC REVISIONS : No Date DRAWING TITLE : SANITATIO VIP Latrine Ladies - Section	Consult Ltd ER SUPPLY AND IN PROJECT ER SUPPLY AND Description		
PROJECT : ALA-ORA WATI SANITATIC NYAGAK WATE SANITATIC REVISIONS : No Date DRAWING TITLE : SANITATIO UIP Latrine Ladies - Section Surveyed by: R.K Drawn by: M.K Designed by: W.G.M	Consult Ltd ER SUPPLY AND IN PROJECT ER SUPPLY AND Description		
PROJECT : ALA-ORA WATI SANITATIC NYAGAK WATE SANITATIC REVISIONS : No Date DRAWING TITLE : SANITATIO UIP Latrine Ladies - Section Surveyed by: R.K Drawn by: M.K Designed by: W.G.M Checked by: J.K.K Date:	Consult Ltd ER SUPPLY AND IN PROJECT ER SUPPLY AND Description		
PROJECT : ALA-ORA WATE SANITATIC NYAGAK WATE SANITATIC REVISIONS : No Date DRAWING TITLE : SANITATIO VIP Latrine Ladies - Section Surveyed by: R.K Drawn by: M.K Designed by: W.G.M Checked by: J.K.K	Consult Ltd ER SUPPLY AND IN PROJECT ER SUPPLY AND Description N FACILITIES & Door and Window Schedule		

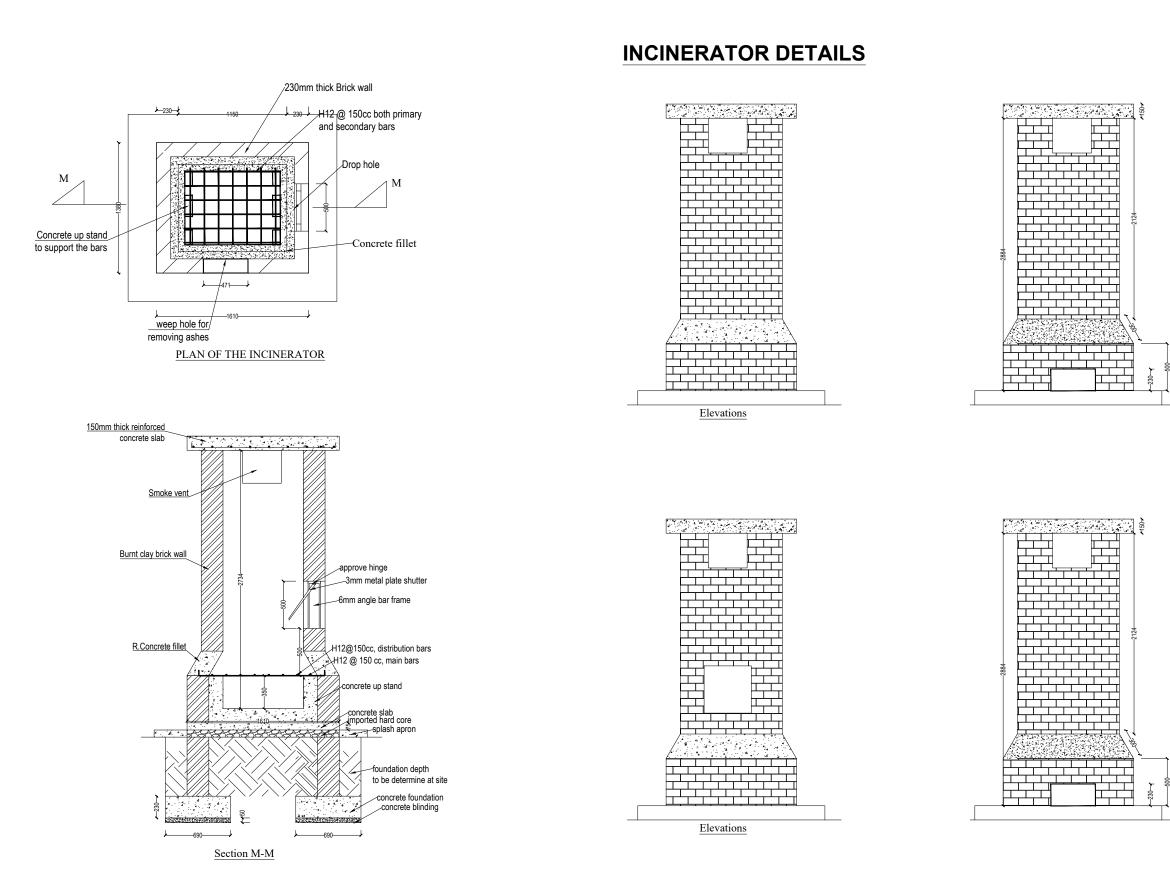


	LEGEND			
	CLIENT :			
	THE REPUBLIC OF UGANDA			
	CO-FINANCED BY:			
	CONSULTANT : Alliance Consultants Itd In Association with			
	Infra-Consult Ltd			
	PROJECT : ALA-ORA WATER SUPPLY AND SANITATION PROJECT			
	NYAGAK WATER SUPPLY AND SANITATION SYSTEM			
	REVISIONS :           No         Date         Description			
	DRAWING TITLE : SANITATION FACILITIES Incinerator			
	Surveyed by: R.K			
_	Drawn by: M.K Designed by:			
	W.G.M Checked by: J.K.K			
	Date: January 2023 DRG. No.:			
	ALA-ORA- SAN-004 Scale: Sheet No.:			
	1:40 l of 1			

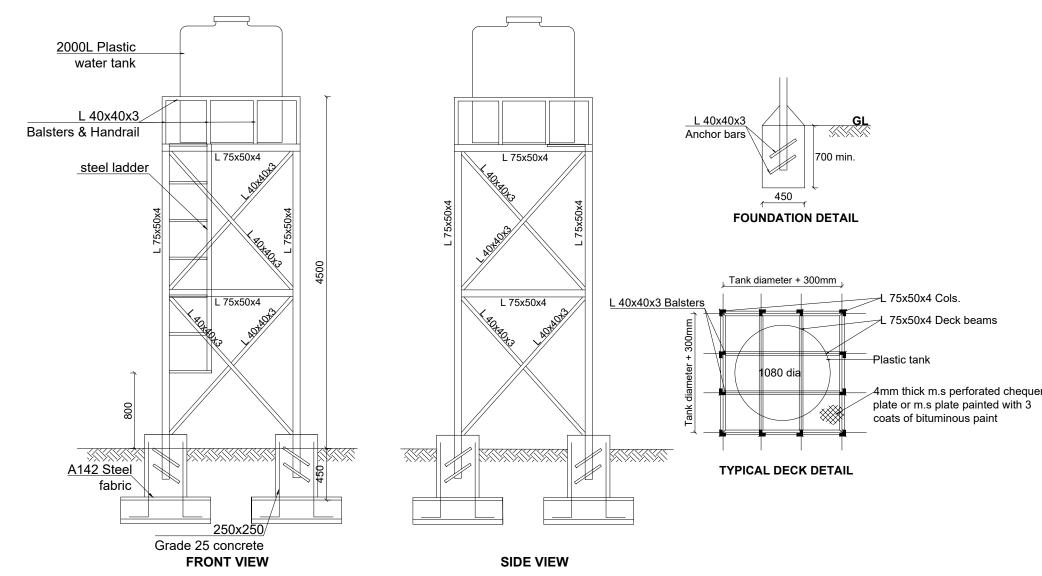

## WATER TANK SUPPORTING STRUCTURE

	LEGEND				
	CLIENT :				
	THE REPUBLIC OF UGANDA MINISTRY OF WATER AND ENVIRONMENT CO-FINANCED BY:				
	CONSULTANT : Alliance Consultants Itd In Association with				
ered	PROJECT : ALA-ORA WATER SUPPLY AND SANITATION PROJECT				
	NYAGAK WATER SUPPLY AND SANITATION SYSTEM				
	REVISIONS :       No     Date   Description				
	DRAWING TITLE : SANITATION FACILITIES Public Toilets - Elevated Tank Details				
	Surveyed by: R.K Drawn by: M.K Designed by:				
	W.G.M Checked by: J.K.K				
	Date: January 2023 DRG. No.:				
	ALA-ORA- SAN-005           Scale:         Sheet No.:           1:40         5 of 6				


**NovIC TANK** 

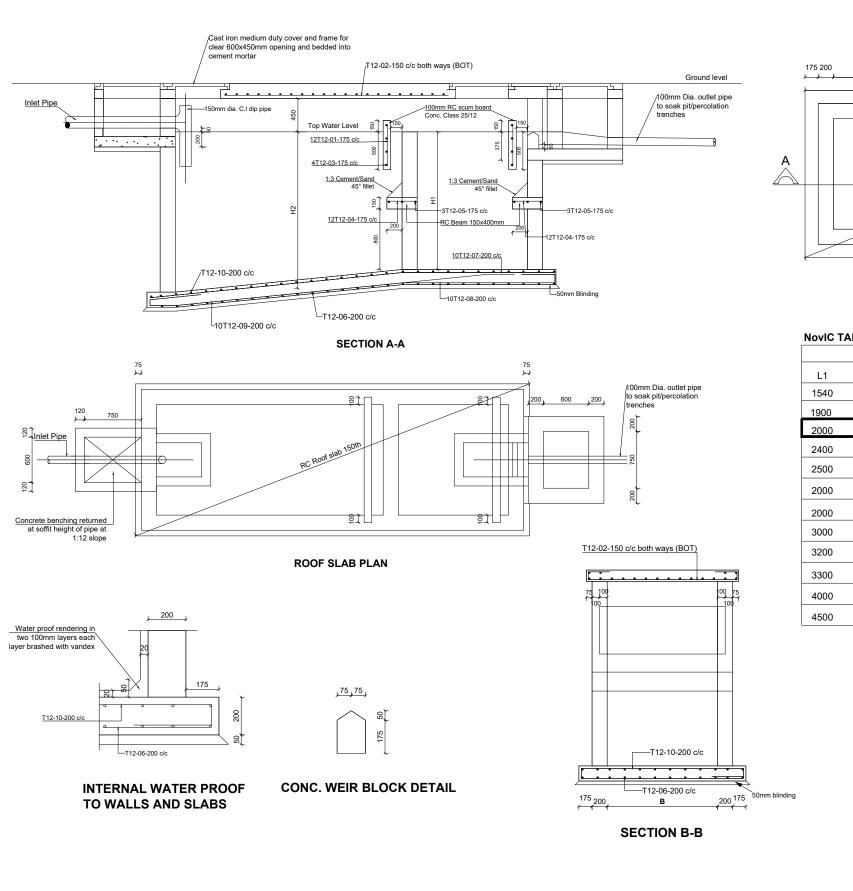


A m RC Base stab 200th L2 B

#### NovIC TANK DIMENSIONS

INTERNAL DIMENSIONS (mm)					CAPACITY	١
L1	L2	H1	H2	В	Cu. M	
1540	760	1600	1750	760	3.2	
1900	900	1800	2000	900	4.5	
2000	1000	1800	2000	1100	5.9	
2400	1100	1800	2000	1150	7.24	
2500	1200	1800	2000	1300	8.6	
2000	1300	1800	2000	1400	10	
2000	1400	1800	2000	1450	11.3	
3000	1500	1800	2000	1560	12.7	
3200	1600	1800	2000	1600	14	
3300	1700	1800	2000	1700	15.4	
4000	2000	1800	2000	2090	24	
4500	2000	1800	2000	2650	34.3	

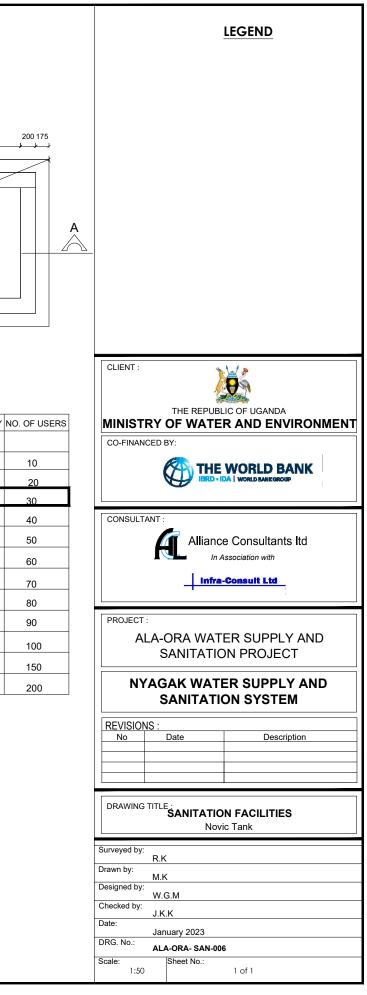

# SOAK AWAY PIT AND MANHOLE DETAILS

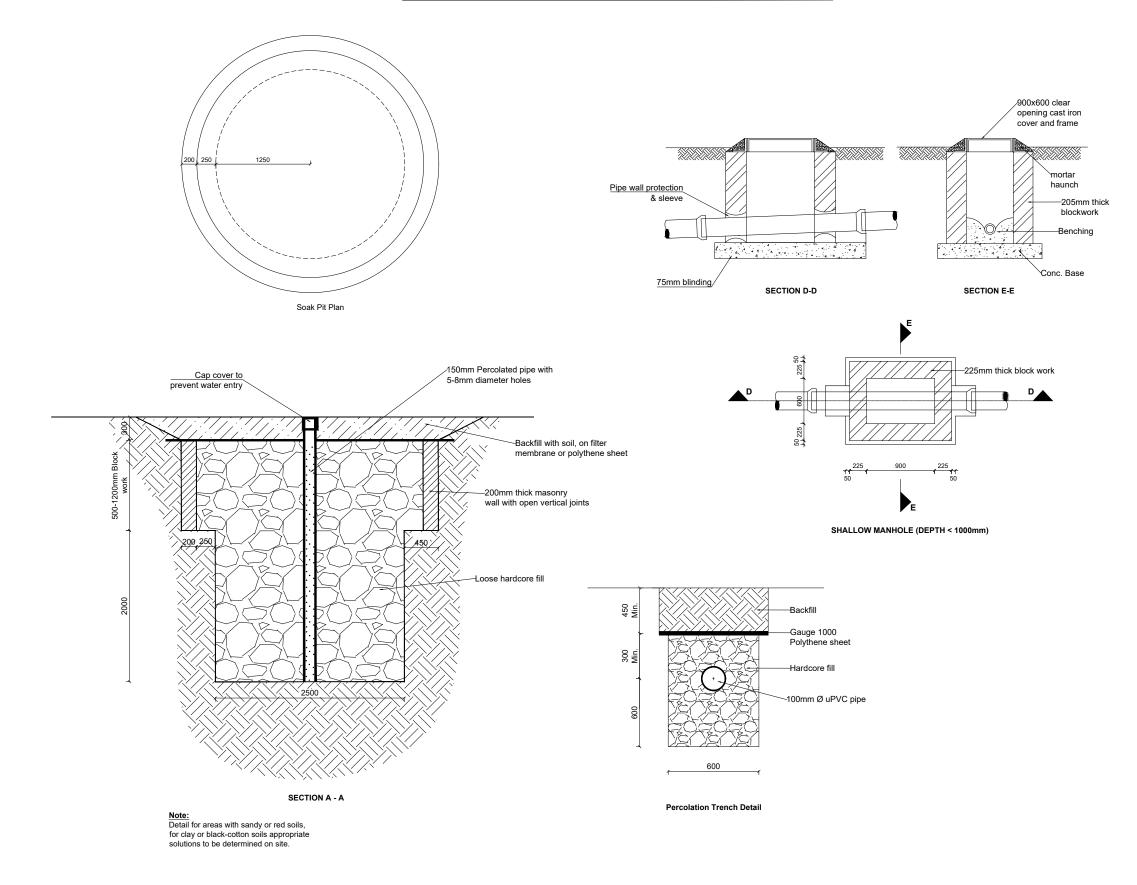

	LEGEND
	CLIENT :
	THE REPUBLIC OF UGANDA MINISTRY OF WATER AND ENVIRONMENT
	CO-FINANCED BY:
	CONSULTANT :
	Alliance Consultants Itd
	Infra-Consult Ltd
	PROJECT :
	ALA-ORA WATER SUPPLY AND
	SANITATION PROJECT
I	NYAGAK WATER SUPPLY AND
	SANITATION SYSTEM
	REVISIONS :
	REVISIONS :
	REVISIONS : No Date Description
	REVISIONS :
	REVISIONS :         No       Date         Description         Date         Drawing Title:         Sanitation Facilities         Manhole and Soak away Pit         Surveyed by:
	REVISIONS :         No       Date       Description         Image: Colspan="2">Image: Colspan="2">Description         Image: Colspan="2">Description         Image: Colspan="2">Image: Colspan="2"Descrip
	REVISIONS :         No       Date         Description         Date         Description         Date         Drawn by:         R.K         Drawn by:         M.K         Designed by:         W.G.M
	REVISIONS :         Description           No         Date         Description           Image: I
	REVISIONS :         Description           No         Date         Description           Image: I
	REVISIONS :       No       Date       Description         No       Date       Description         Date       Description         Date       Description         Drawn by:       R.K         Drawn by:       M.K         Designed by:       W.G.M         Checked by:       J.K.K         Date:       U.K.K