

The Republic of Uganda

MINISTRY OF WATER AND ENVIRONMENT

Directorate of Water Development Rural Water and Sanitation Department

In Financial Cooperation with



Bid For

ALA - ORA WATER SUPPLY & SANITATION SYSTEM

LOAN No.:	
PROJECT ID No.:	

LOT 3: CONSTRUCTION OF ENYAU WATER SUPPLY AND SANITATION SYSTEM

MWE/WRKS/22-23/.....

BIDDING DOCUMENTS

VOLUME 4 – BOOK OF DRAWINGS

ISSUED ON: JANUARY 2023

CONSTRUCTION OF ENYAU WATER SUPPLY AND SANITATION SCHEME-LOT 3 BOOK OF DRAWINGS CONTENT

ITEM	DESCRIPTION	DWG. NO.	SHEETS
	ENYAU Project General Layout	ENY-GL-001	2
Raw Water Works	Intake Structure	ENY-INT-001	3
	Intake Chamber	ENY-INT-002	3
	Intake Guard House	ENY-INT-003	5
	Toilet (Intake)	ENY-INT-004	3
	Raw Water Main	ENY-RWM-001	14
	Treatment Plant Site Layout	ENY-WTP-001A	1
	Treatment Plant Hydraulic Profile	ENY-WTP-001B	1
	Inlet Structure	ENY-WTP-002	1
	Alum Dosing House	ENY-WTP-003	6
	Flocculator	ENY-WTP-004	2
	Sedimentation Tank	ENY-WTP-005	2
	Rapid Sand Filters	ENY-WTP-006	3
	Chlorine Dosing House	ENY-WTP-007	6
	Clear water Tank	ENY-WTP-008	3
Treatment Plant	Pump house	ENY-WTP-009	12
	Backwash Tank	ENY-WTP-010	2
	Sludge Drying Beds	ENY-WTP-011	3
	Sand Storage Shade	ENY-WTP-012	1
	Administration Building and Laboratory	ENY-WTP-012	5
			_
	Superintendent's Quarters Attendant's House	ENY-WTP-014 ENY-WTP-015	5
	Guard Post	ENY-WTP-015	5
	Chemical Store	ENY-WTP-016	5
	Chemical Store		
Pumping Main 1	Pumped from WTP To 90m³ Existing Reservoir	ENY-PM-001	1
	15m³ RESERVOIR (TANK 1/OTUMBALI) ARE	- Λ	
Pumping Main 2	Pumped from WTP To 15m³ Reservoir	ENY-PM-002	17
	Reservoir Site Layout	ENY-RES-MVP-001	1 1
To 15m³ Reservoir	15m³ Reservoir Plan and Sections	ENY-RES-MVP-001	2
Cravity Main 1	From WTD to Too lumption at Ch. 21045	ENIX OTM 004	1 6
Gravity Main 1	From WTP to Tee Junction at Ch. 3+015	ENY-GTM-001	6
	202m³ RESERVOIR (TANK 2/MVEPI ZONE 3) A		
Gravity Main 2	To 202m³ Reservoir	ENY-GTM-002	1
202m³ Reservoir	Reservoir Site Layout	ENY-RES-MVP-002	1
ZOZIII Neservoii	202m³ Reservoir Plan and Sections	ENY-RES-MVP-002	2
Distribution Mains	Distribution 1	ENY-DM-001	15
	69m³ NDAAPI RESERVOIR AREA		
Pumping Main 3	Pumping main 3 to Ndaapi Reservoir	ENY-PM-003	18
	Reservoir Site Layout	ENY-RES-MVP-005	1
69m³ Ndaapi Reservoir	69m³ Reservoir Plan and Sections	ENY-RES-MVP-005	2
	Total Moderna Management	12.11.11.20 11111 000	
Scheme Nodes	Enyau Nodes	ENY-ND-001	3

	STRUCTURALS		
TEM	DESCRIPTION	DWG. NO.	SHEETS
Raw Water Works	Intake Weir	AR/WSASS/EN/STR/001	4
Train Train Trains	Intake Chamber	AR/WSASS/EN/STR/002	2
	Inlet Structure	AR/WSASS/EN/STR/003	1
	Alum Dosing House	AR/WSASS/EN/STR/004	2
	Flocculator	AR/WSASS/EN/STR/005	4
	Sedimentation Tank	AR/WSASS/EN/STR/006	5
Treatment Plant	Rapid Sand Filters	AR/WSASS/EN/STR/007	4
Healineill Flaill	Chlorine Dosing House	AR/WSASS/EN/STR/008	3
	Clear water Tank	AR/WSASS/EN/STR/009	3
	Pump House	AR/WSASS/EN/STR/010	3
	50m³ Backwash Tank	AR/WSASS/EN/STR/011	2
	Sludge Drying Beds	AR/WSASS/EN/STR/012	3
	202m³ Reservoir	AR/WSASS/EN/STR/013	2
Reservoirs	69m³ Reservoir	AR/WSASS/EN/STR/016	2
	15m³ Reservoir	AR/WSASS/EN/STR/017	2
	STANDARD DRAWINGS	•	
ITEM	DESCRIPTION	DWG. NO.	SHEETS
0	General Notes	ALA-ORA-SD-000	1
1	Sign Board	ALA-ORA-SD-000 ALA-ORA-SD-001	1
2	Gate Valve & Surface Box	ALA-ORA-SD-001 ALA-ORA-SD-002	1
3	Fire Hydrant Chamber & Pipework	ALA-ORA-SD-002 ALA-ORA-SD-003	1
3 4	Air Valve Chamber & Pipework	ALA-ORA-SD-003 ALA-ORA-SD-004	1
5	Washout Details, Chamber & Outfall structure	ALA-ORA-SD-004 ALA-ORA-SD-005	1
6	Anchor Block Details	ALA-ORA-SD-005 ALA-ORA-SD-006	3
U	Trenching, Road Crossing ,Backfilling, Pipe Protection	ALA-ORA-SD-000	3
7	and Pipe Sleeving details	ALA-ORA-SD-007	2
8	Reinforcement Details for washout/ Valve Chamber and Roof slab details	ALA-ORA-SD-008	1
9	Step Iron & Flexible Pipe Joint Details	ALA-ORA-SD-009	1
10	Precast chamber cover slab and Section	ALA-ORA-SD-010	1
11	Marker Post & Pipe Support Details	ALA-ORA-SD-011	2
12	Fence Details	ALA-ORA-SD-012	2
13	Road Works	ALA-ORA-SD-013	1
14	Yard Tap	ALA-ORA-SD-014	1
15	Stand Post	ALA-ORA-SD-015	1
16	Water Office - Type 1	ALA-ORA-SD-016A	5
17	Water Office - Type 2	ALA-ORA-SD-016B	5
18	Septic Tank	ALA-ORA-SD-017	1
19	Manhole details & Soak pit details	ALA-ORA-SD-018	1
20	Lightning Conductor	ALA-ORA-SD-019	1
21	Pipe Bridge ≤ 10m	ALA-ORA-SD-020	3
22	Pipe Bridge ≤ 15m	ALA-ORA-SD-021	3
23	Pipe Bridge ≤ 20m	ALA-ORA-SD-022	3
24	Pipe Bridge ≤ 35m	ALA-ORA-SD-023	3
24			~
24			

ALA-ORA-SAN-001

ALA-ORA-SAN-002

ALA-ORA-SAN-003

ALA-ORA-SAN-004

ALA-ORA-SAN-005

ALA-ORA-SAN-006

ALA-ORA-SAN-007

5

3

3

1

Public Waterborne Toilet

Institutional VIP for Gents

Institutional VIP for Ladies

Incinerator Details
Elevated Water Tank

Septic Tank

Soak Pit Details


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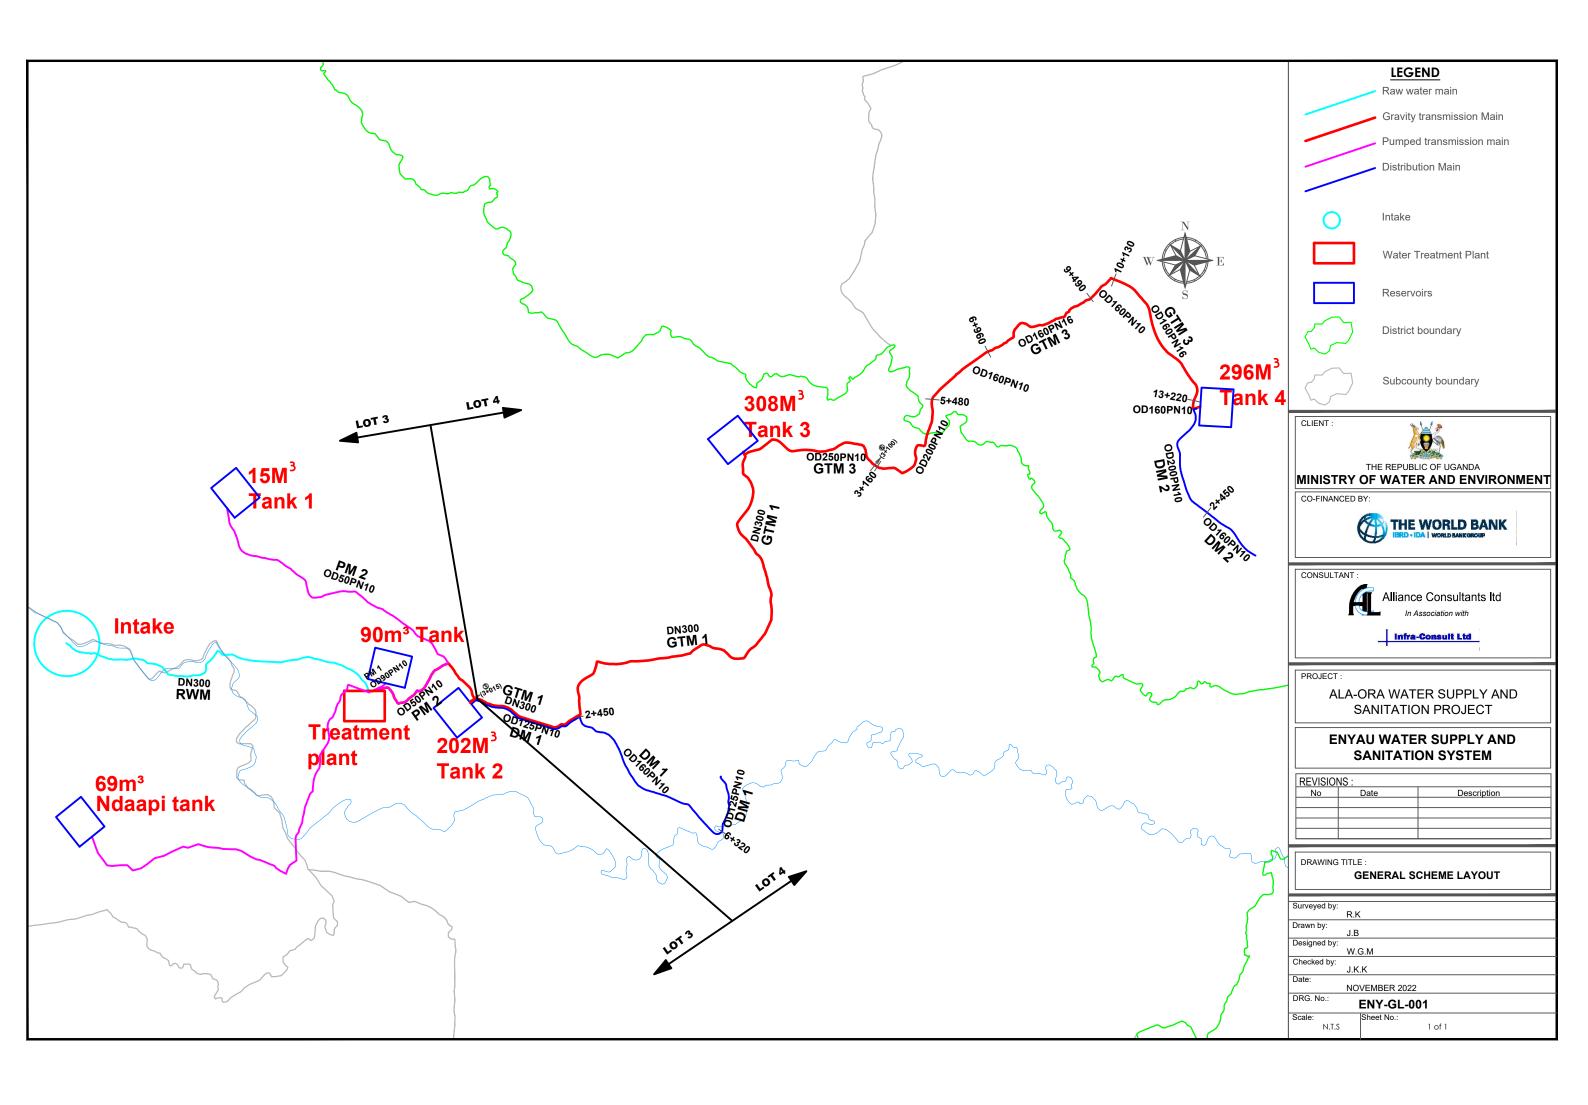
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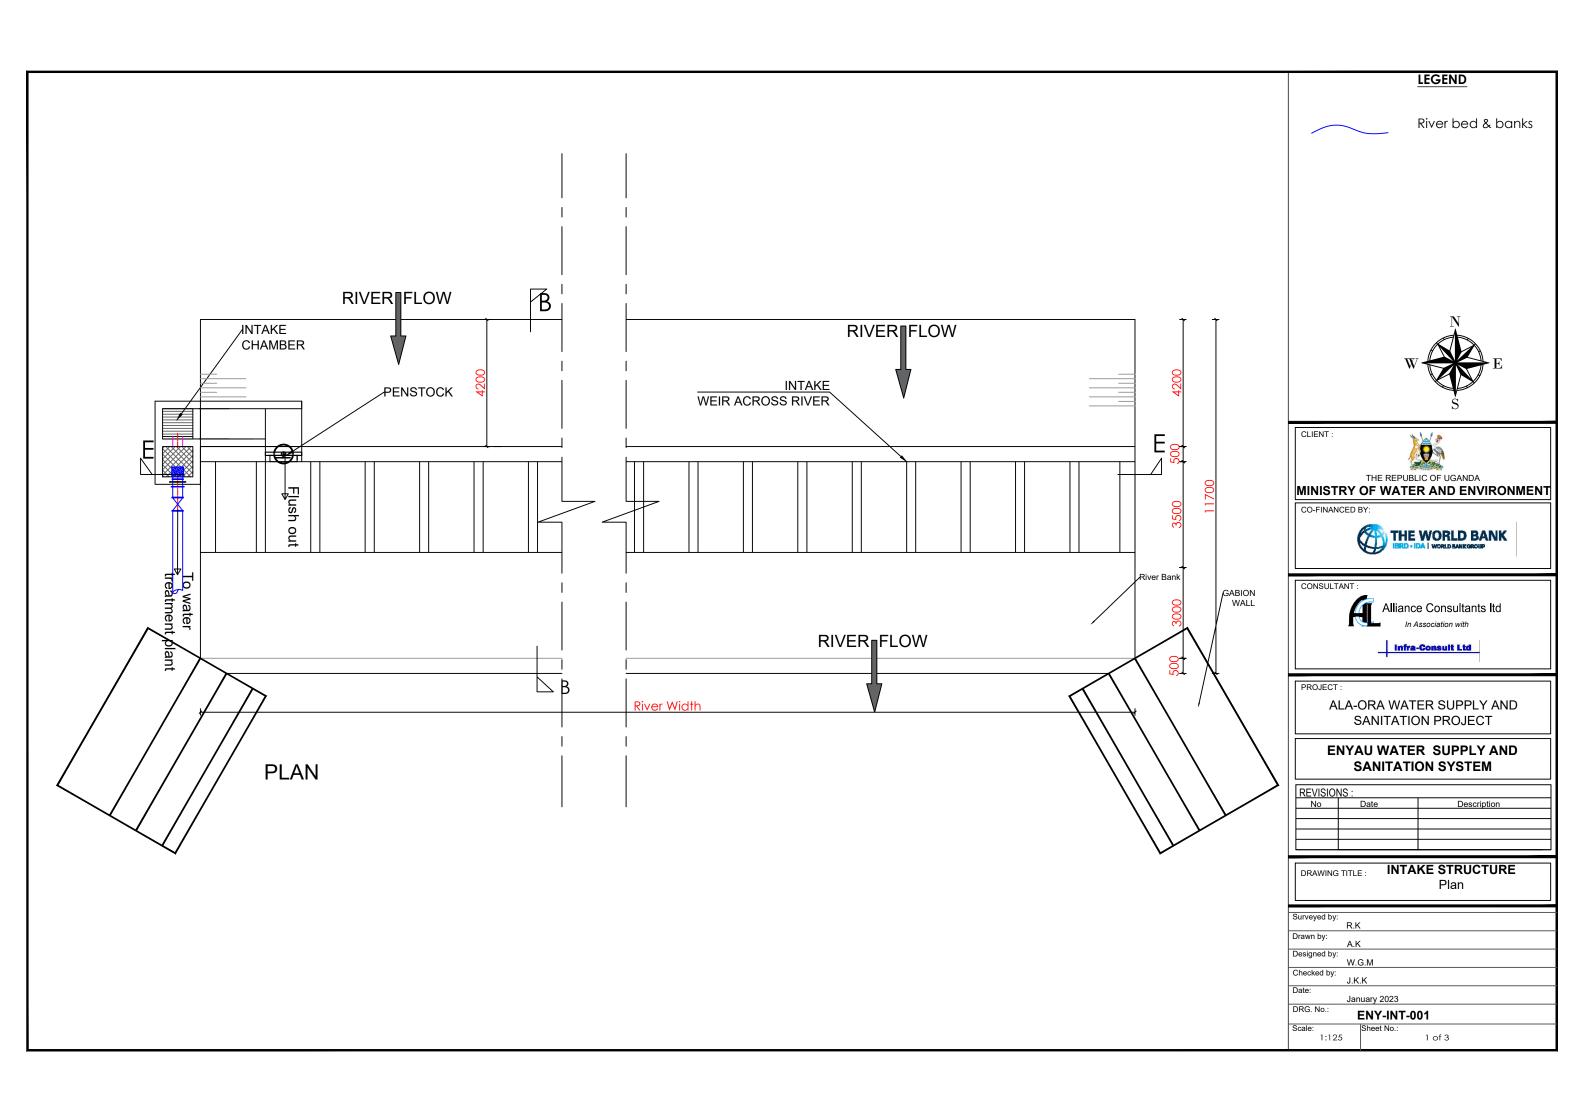
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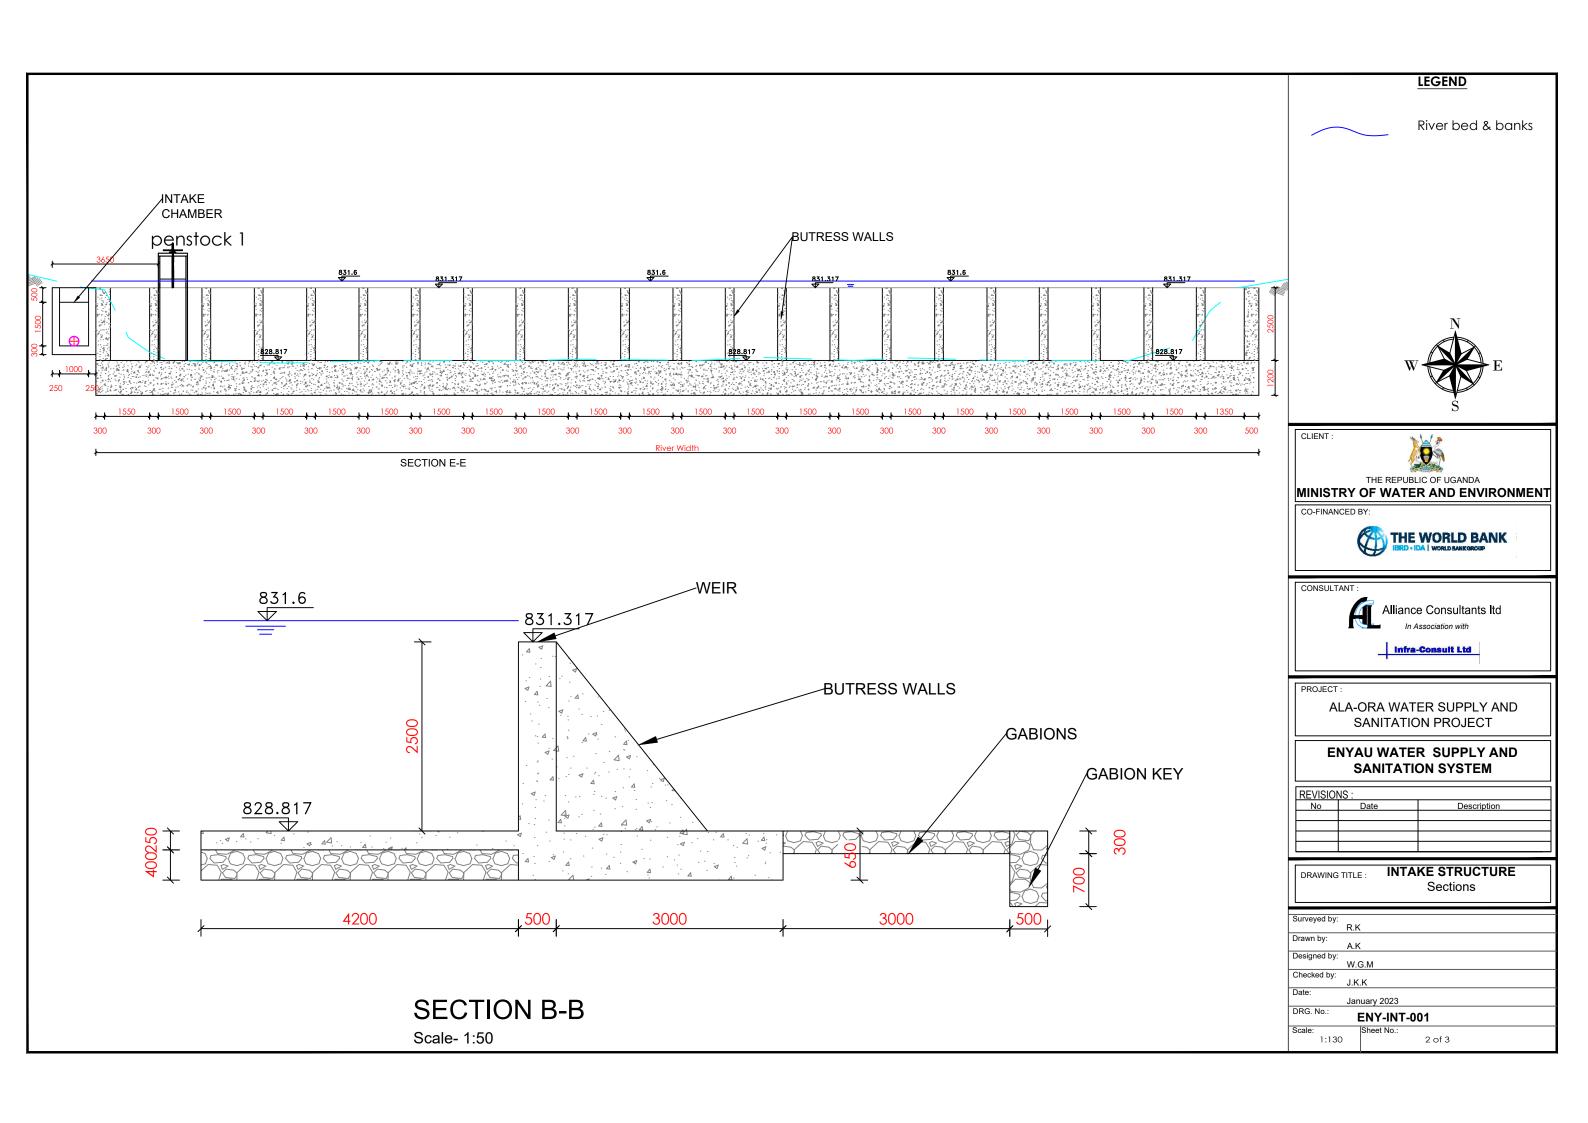
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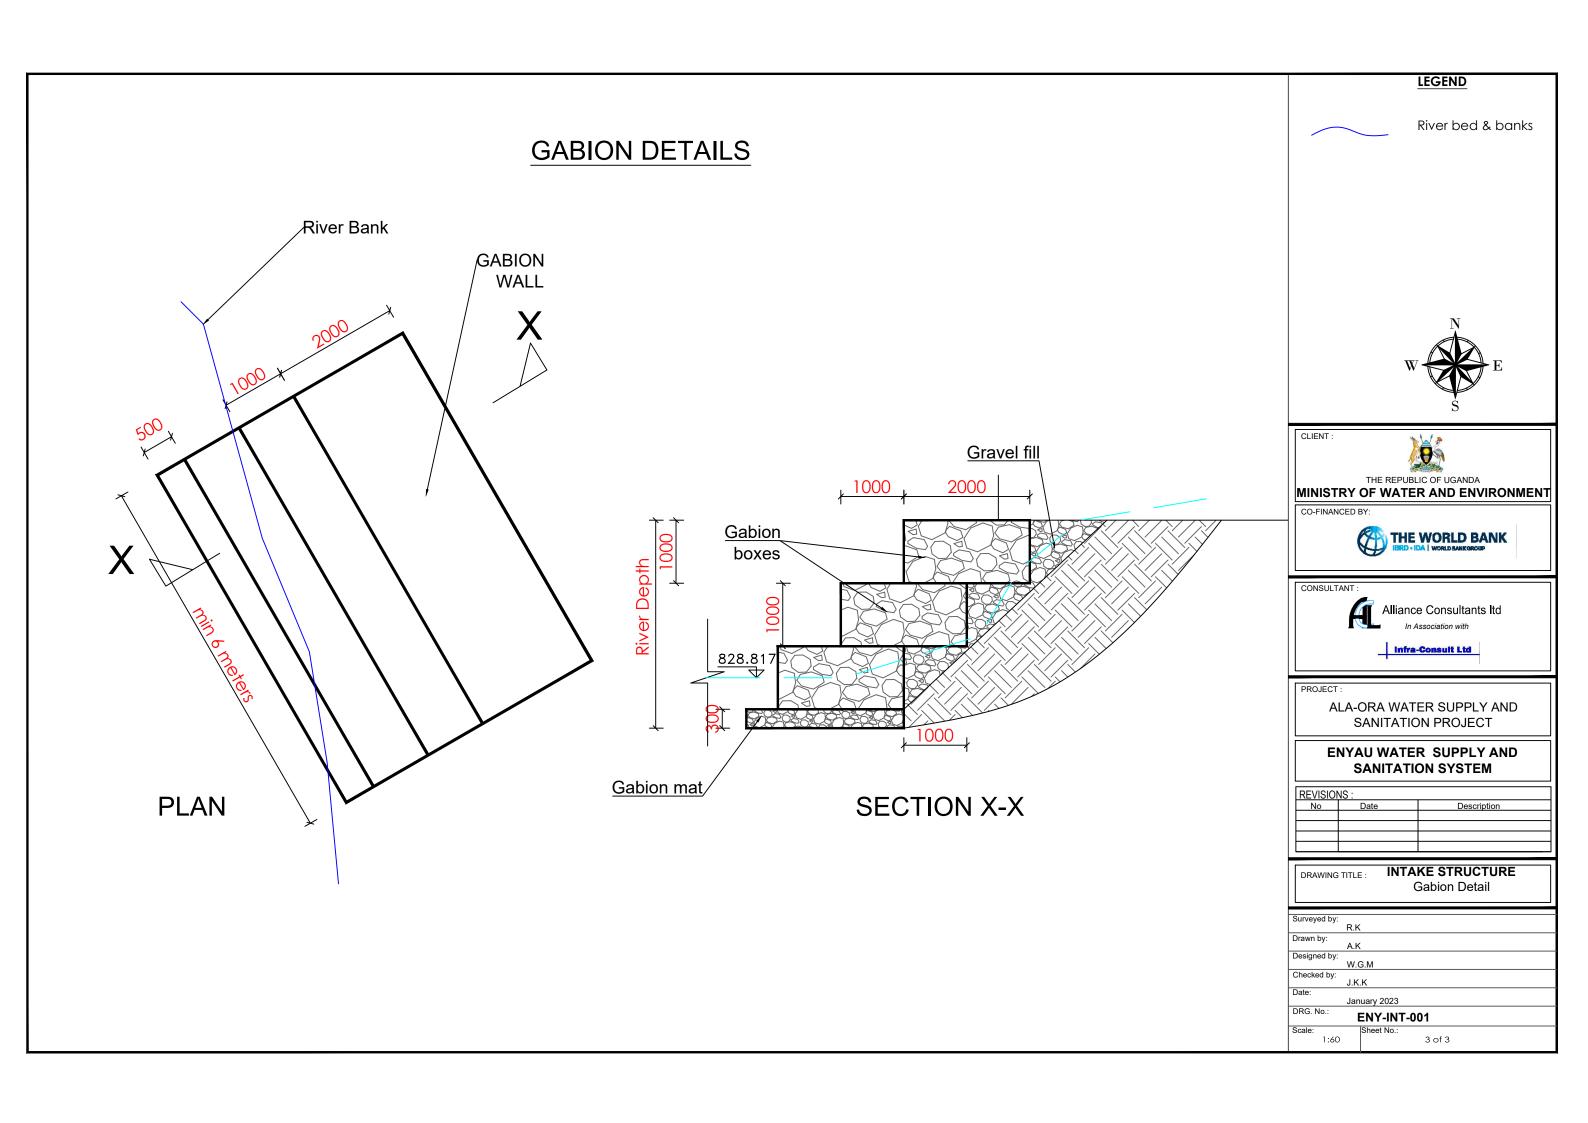
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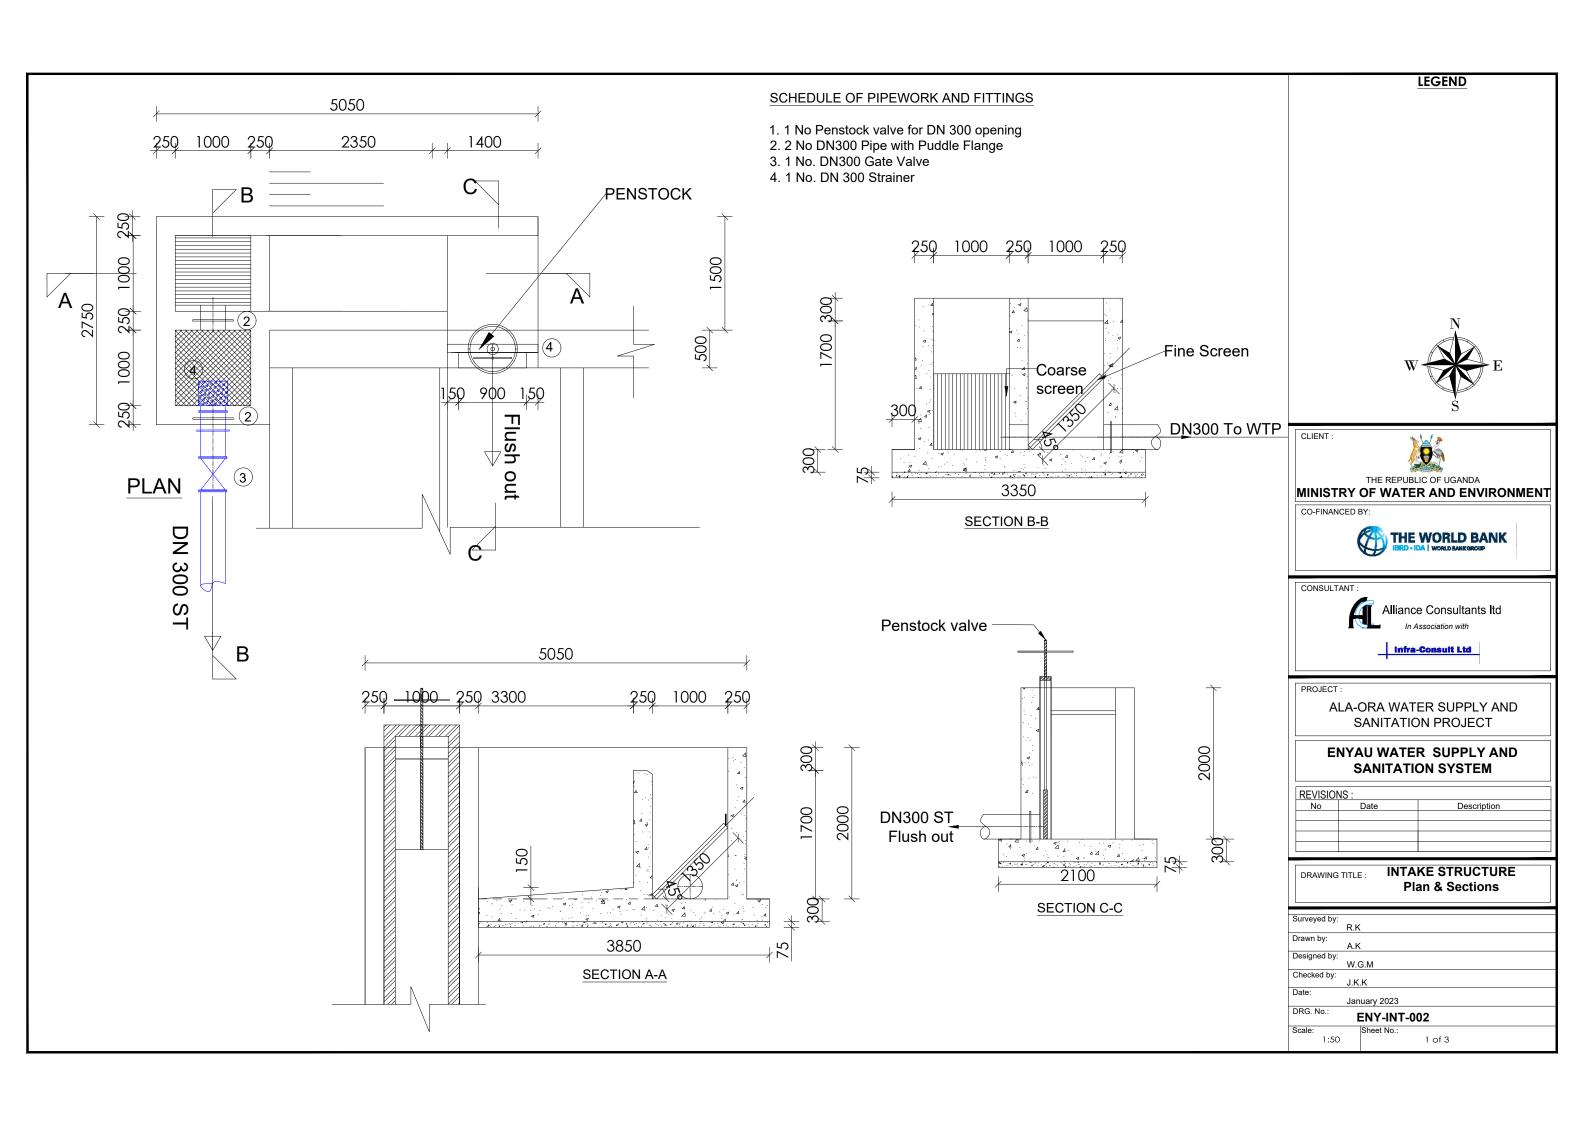











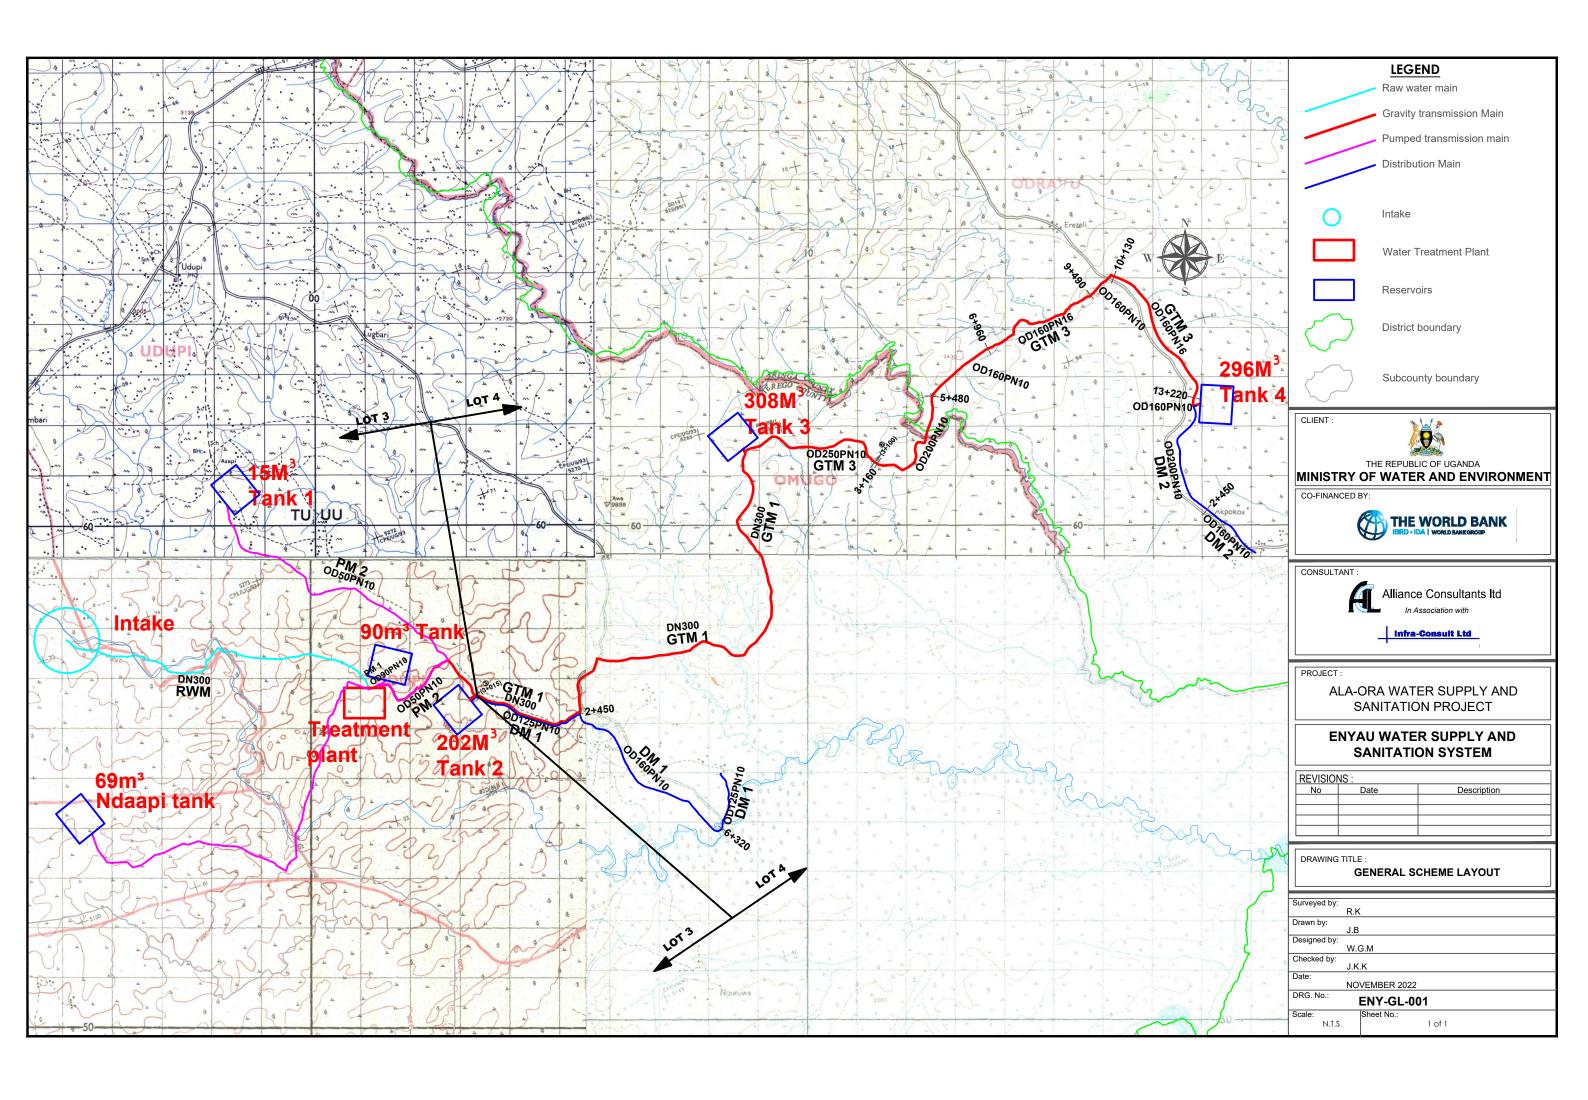




NOTES

All dimensions are in millimetres unless otherwise

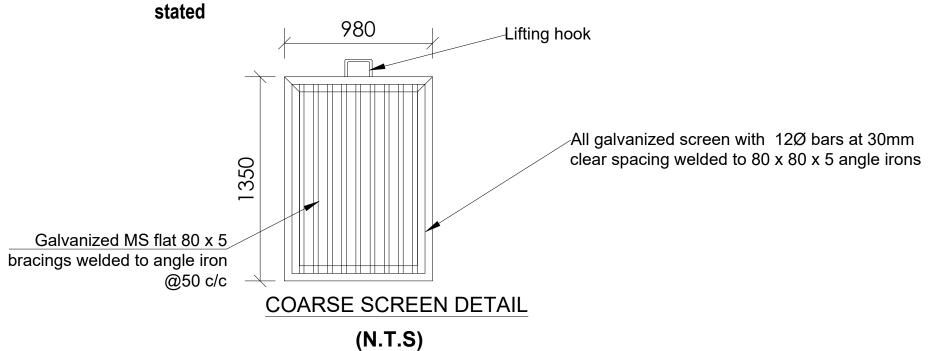

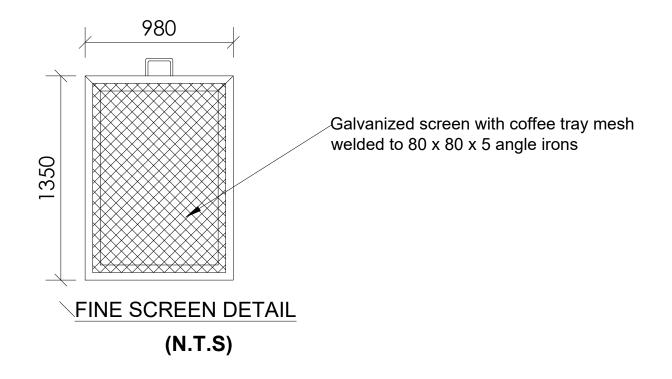



CLIENT :



THE REPUBLIC OF UGANDA MINISTRY OF WATER AND ENVIRONMENT

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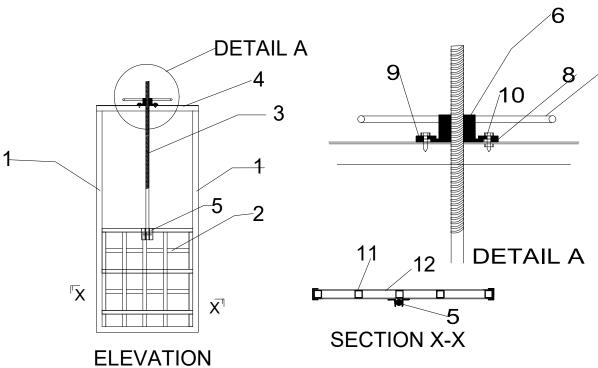
ALA-ORA WATER SUPPLY AND SANITATION PROJECT

ENYAU WATER SUPPLY AND SANITATION SYSTEM


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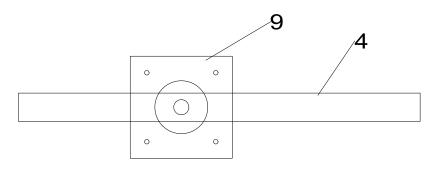
Surveyed by:	
	R.K
Drawn by:	
,	A.K
Designed by:	
	W.G.M
Checked by:	
,	J.K.K
Date:	
	January 2023
DRG. No.:	ENIX INT OCC
	ENY-INT-002
Scale:	Sheet No.:
N.T.S	2 of 3



- 1 Channel section 75x38x6mm
- 2 Gate board formed by sandwiching a frame of SHS 50x50x3mm spaced at 270mm both ways
- 3 Threaded shaft 40mm dia attached to check board moved by mechanism in detail A38x6mm



- 4 Channel section 75x38x6mm
- 5 Angle brackets 50X50x6mm fixing the shaft to the board with a pin that can shear on excessive turning of closing wheel 75x38x6mm
- 6 Metal piece with female thread to move the gate shaft
- 7 Wheel welded to part 6 above
- 8 Spacer plate 270x270x12mm with central hole 178mm dia and 4 No holes 12mm dia for bolts (see detail) It is welded all round to item 4
- 9 Steel plate 270x270x12mm with central hole 140mm dia and 4 No holes 12mm dia for bolts (see detail)
- 10 Bolts 10mm dia with necessary washers and nut
- 11 frame of SHS 50x50x3mm spaced at 270mm both ways
- 12 Steel Plate 1200x600x6mm covering each of the sides of steel sections

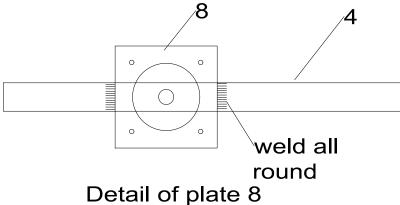

Detail of plate 9

DETAILS OF PENSTOCKS

LEGEND







ALA-ORA WATER SUPPLY AND SANITATION PROJECT

ENYAU WATER SUPPLY AND SANITATION SYSTEM

REVISIO	NS :	
No	Date	Description

DRAWING TITLE : INTAKE CHAMBER
Penstock Details

Surveyed by:
R.K

R.K

Drawn by:

A.K

Designed by:

W.G.M

Checked by:

J.K.K

Date:

January 2023

DRG. No.:


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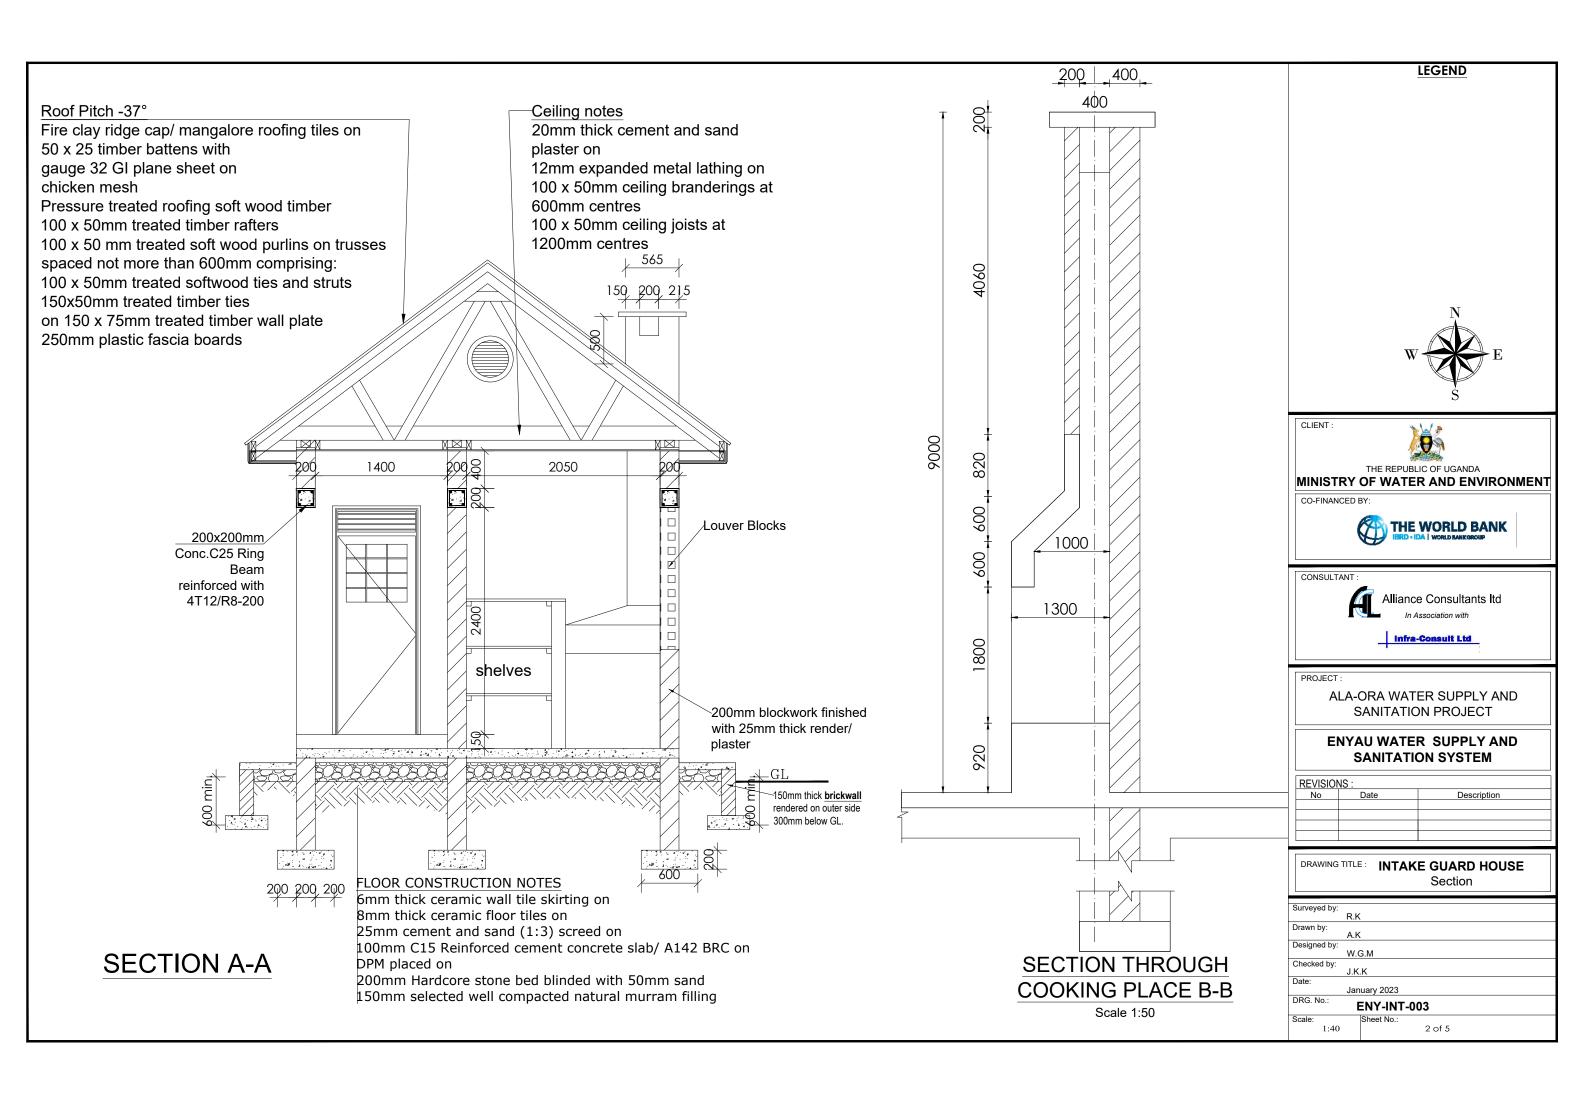
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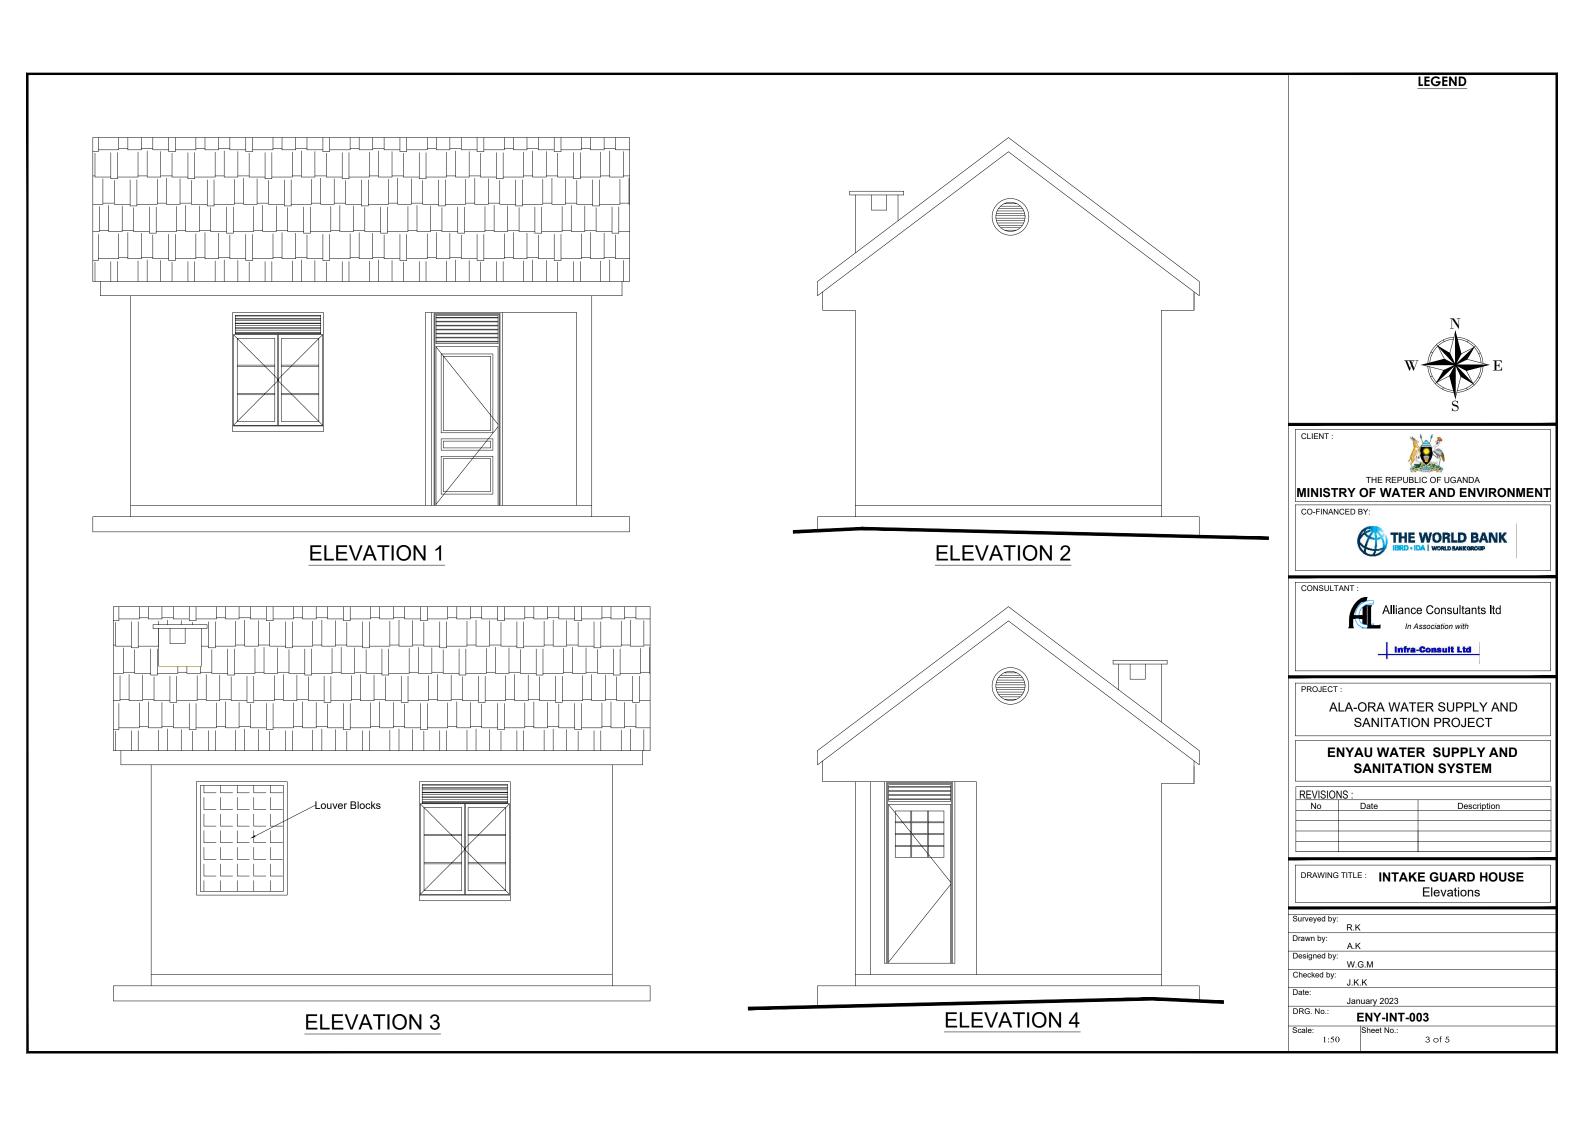
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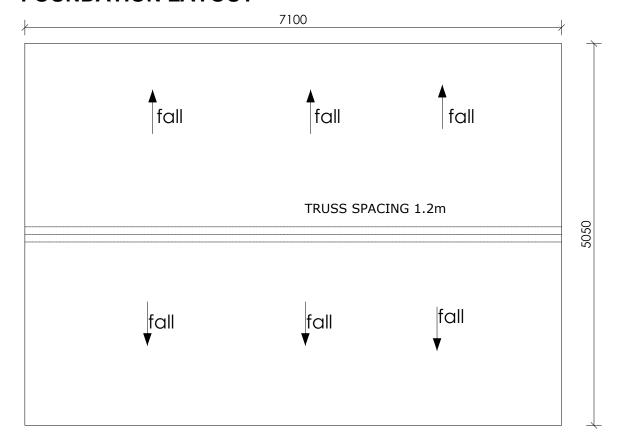






FOUNDATION LAYOUT

ROOF LAYOUT

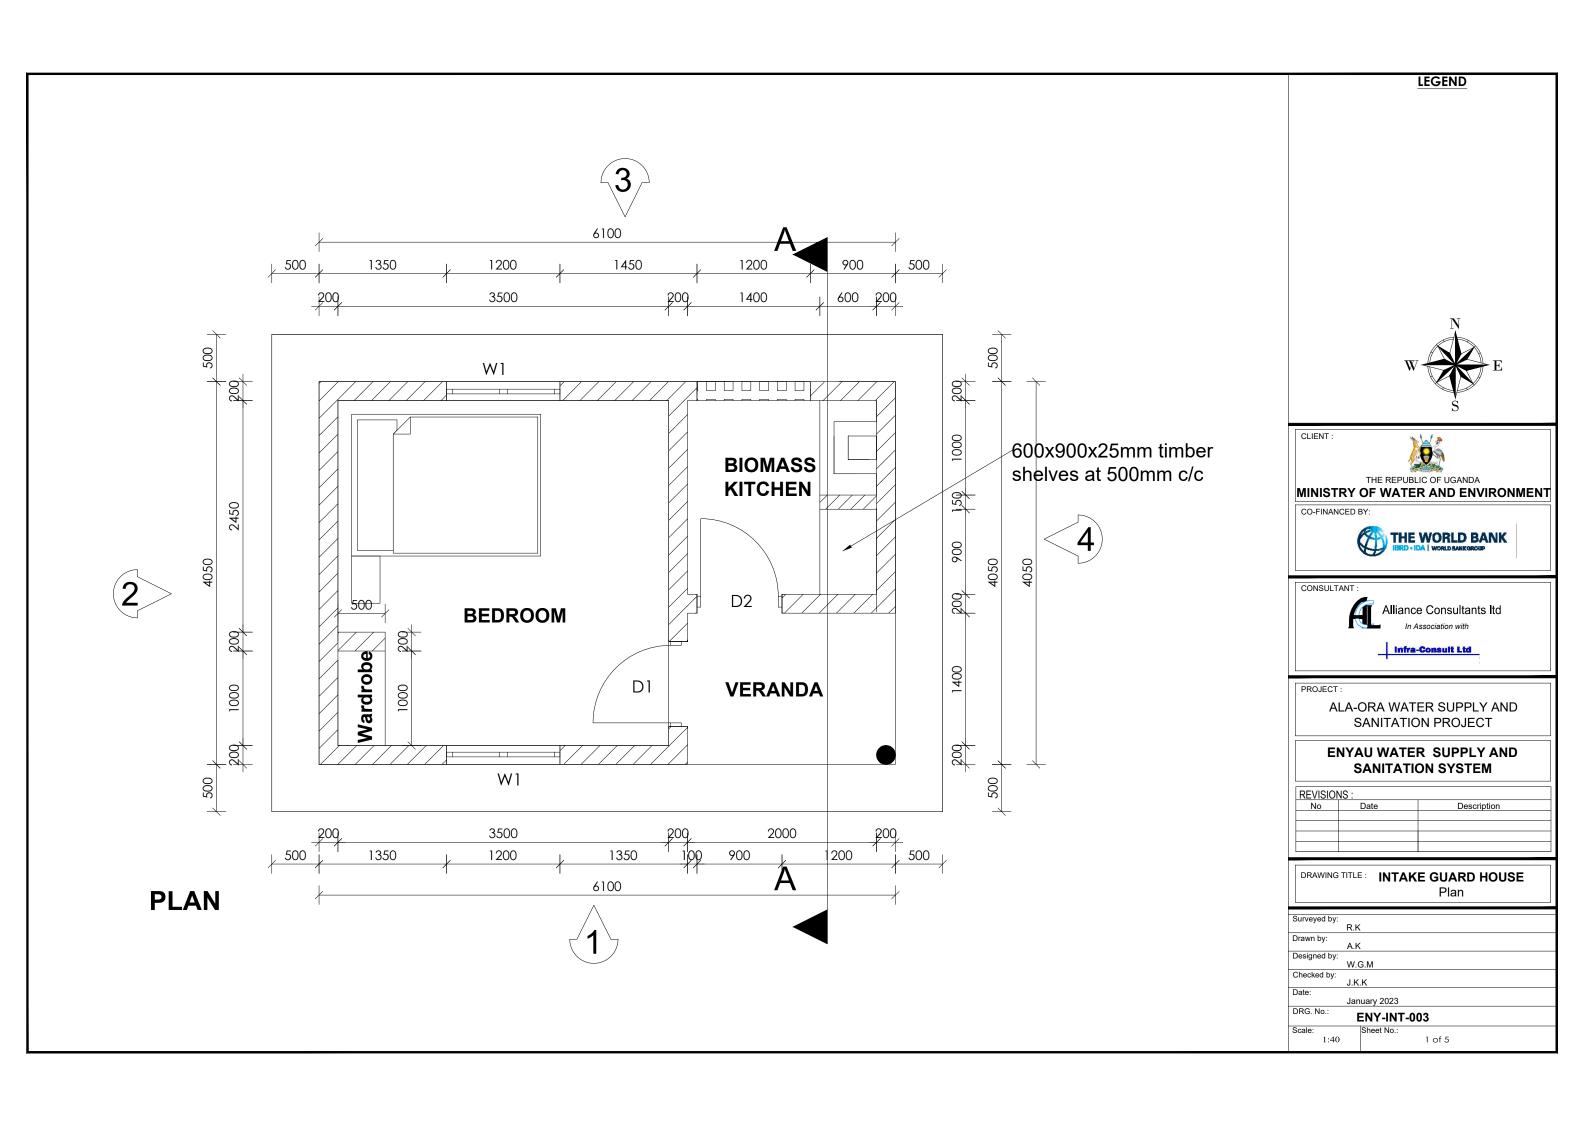

LEGEND



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MINISTRY OF WATER AND ENVIRONMENT

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PRO IECT


ALA-ORA WATER SUPPLY AND SANITATION PROJECT

ENYAU WATER SUPPLY AND SANITATION SYSTEM

REVISIO	NS:	
No	Date	Description
		·

DRAWING TITLE: INTAKE GUARD HOUSE
Roof & Foundation Layout

Surveyed by:	
, ,	R.K
Drawn by:	
Diawii by.	A.K
Designed by:	
,	W.G.M
Checked by:	
,	J.K.K
Date:	
	January 2023
DRG. No.:	
	ENY-INT-003
Scale:	Sheet No.:
1:50	4 of 5

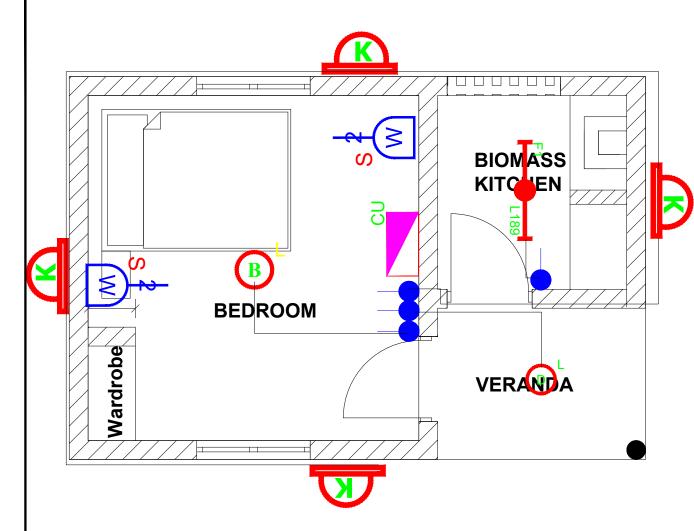

- 1). ALL WALL BRACKETS SHALL BE MOUNTED 1800mm ABOVE FINISHED FLOOR LEVEL
- 2). TELEPHONE, SOCKETS, T.V AND COMPUTER OUTLETS SHALL BE MOUNTED 300mm ABOVE FINISHED FLOOR LEVEL EXCEPT WHERE THEIR IS A WORKTOP.
- 3). WHERE THEIR IS A WORKTOP, TELEPHONE, SOCKETS, T.V AND COMPUTER OUTLETS SHALL BE MOUNTED 150mm ABOVE WORKTOPS.
- 4). CONSUMER UNITS SHALL BE 1800mm ABOVE FINISHED FLOOR LEVEL
- 5). ALL SWITCHES SHALL BE 1400mm ABOVE FINISHED FLOOR LEVEL
- 6). ALL OUTSIDE SOCKETS SHOULD BE WEATHER PROOF
- 7). ALL SHAVER SOCKETS SHOULD BE ON THE RIGHT HAND SIDE OF THE WASH HAND BASIN
- 8). ALL CABLES MUST BE STRANDED

SYMBOL	DESCRIPTION
F1 L189	1200mm 18W LED batten with a removable LED engine. IP20 As Thorn PopPack LED. or equal approved. (Light Type F1)
© ^L	Pedant lighting fitting comprising ceiling Rose 300mm 3x1.5mm ² flexible copper cable lamp holder and 6W LED Lamp
	Pedant lighting fitting comprising ceiling Rose 300mm 3x1.5mm ² flexible copper cable lamp holder and 6WLED Lamp
B	Pedant lighting fitting comprising ceiling Rose 300mm 3x1.5mm ² flexible copper cable lamp holder and 6W LED Lamp
K	Decorative Bed side lamp complete with flexible spot light arm as LEDS-C4 BALI (05-3217-19-82 + PAN-157-BY) to client's approval.
K	wall mounted light
s ‡	Socket outlet on Wall
CU	Consumer's Unit
<u> </u>	One Gang 2way Switch
**	Two Gang 2way Switch
	Three Gang 2way Switch
	One Gang 1way Switch
•	Two Gang 1way Switch
	Three Gang 1way Switch
	Intermediate Switch
PC	Photo - Cell

LEGEND



AIR TERMINAL

TB TEST CLAMP

MH INSPECTION MANHOLE

≡EE EARTH ELECTRODE

HC HORIZONTAL CONDUCTOR

DC DOWN CONDUCTOR







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MINISTRY OF WATER AND ENVIRONMENT

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ROJECT :


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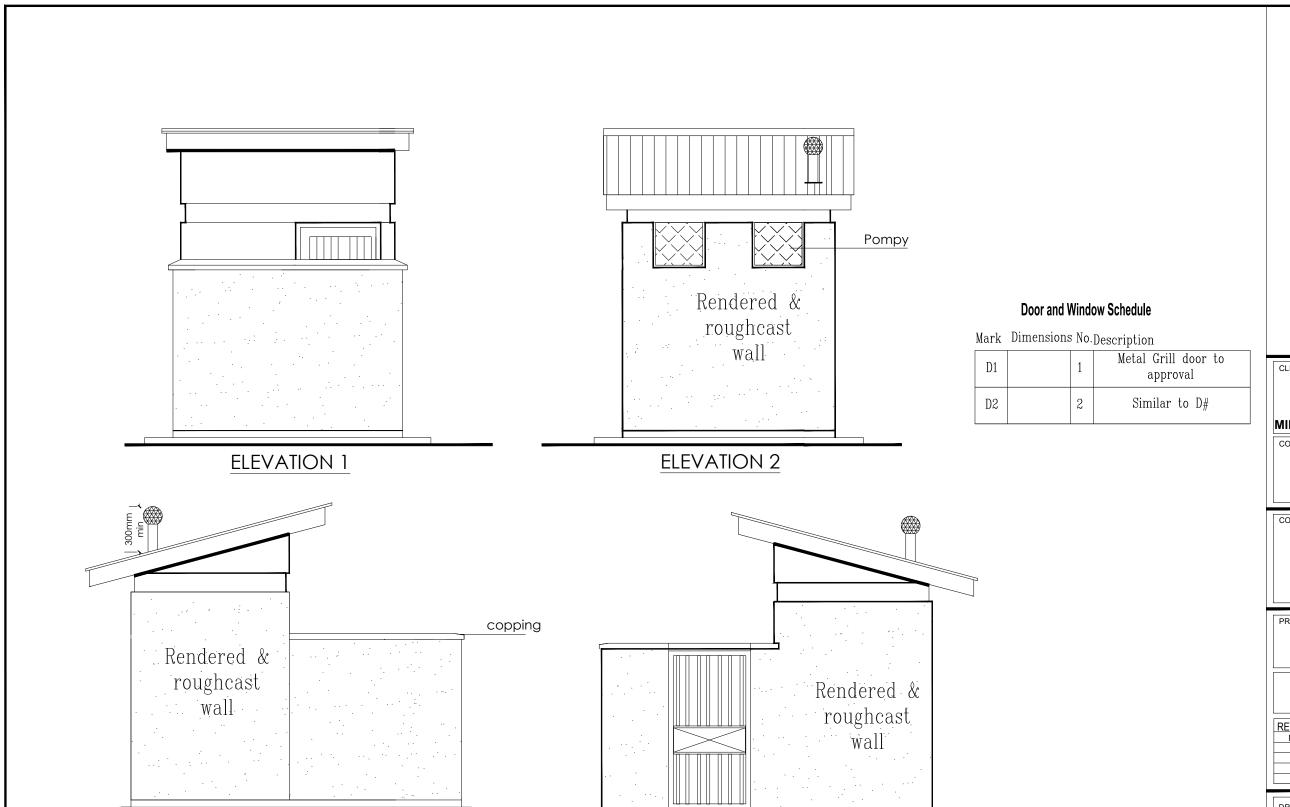
ENYAU WATER SUPPLY AND SANITATION SYSTEM

REVISIONS:			
No	Date	Description	

DRAWING TITLE: INTAKE GUARD HOUSE
Electrical Layout

Surveyed by:	
	R.K
Drawn by:	
	A.K
Designed by:	
	W.G.M
Checked by:	
,	J.K.K
Date:	
	January 2023
DRG. No.:	
ENY-INT-003	
Scale:	Sheet No.:
1:40	5 of 5



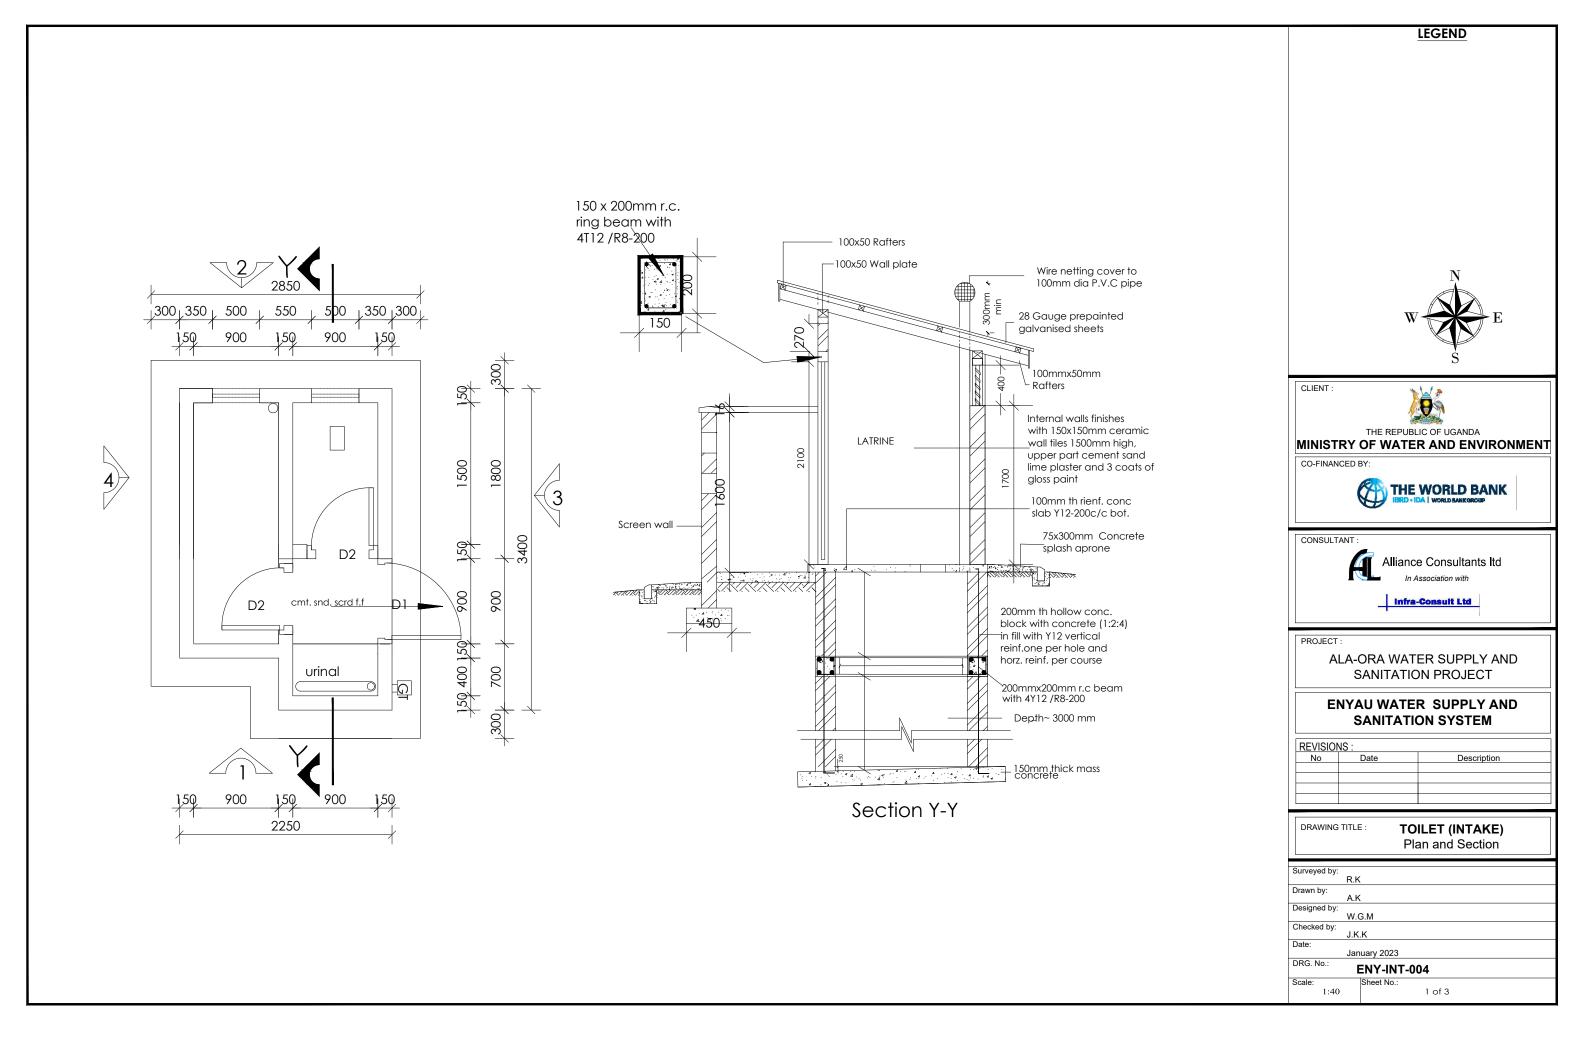

ELEVATION 3

2-STANCE, 1-URINAL TOILET BLOCK

ELEVATION 4



LEGEND

CLIENT :



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CONSULTANT:



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PRO IEC

ALA-ORA WATER SUPPLY AND SANITATION PROJECT

ENYAU WATER SUPPLY AND SANITATION SYSTEM

REVISIONS:		
No	Date	Description

DRAWING TITLE: TOILET (INTAKE)
Elevations

Surveyed by:

R.K

Drawn by:

A.K

Designed by:

W.G.M

Checked by:

J.K.K

Date:

January 2023

DRG. No.:


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Sheet No.:

2 of 3



SYMBOL	DESCRIPTION
F1 L189	1200mm 18W LED batten with a removable LED engine. IP20 As Thorn PopPack LED. or equal approved. (Light Type F1)
© ^L	Pedant lighting fitting comprising ceiling Rose 300mm 3x1.5mm ² flexible copper cable lamp holder and 6W LED Lamp
	Pedant lighting fitting comprising ceiling Rose 300mm 3x1.5mm ² flexible copper cable lamp holder and 6WLED Lamp
B	Pedant lighting fitting comprising ceiling Rose 300mm 3x1.5mm ² flexible copper cable lamp holder and 6W LED Lamp
K	Decorative Bed side lamp complete with flexible spot light arm as LEDS-C4 BALI (05-3217-19-82 + PAN-157-BY) to client's approval.
K	wall mounted light



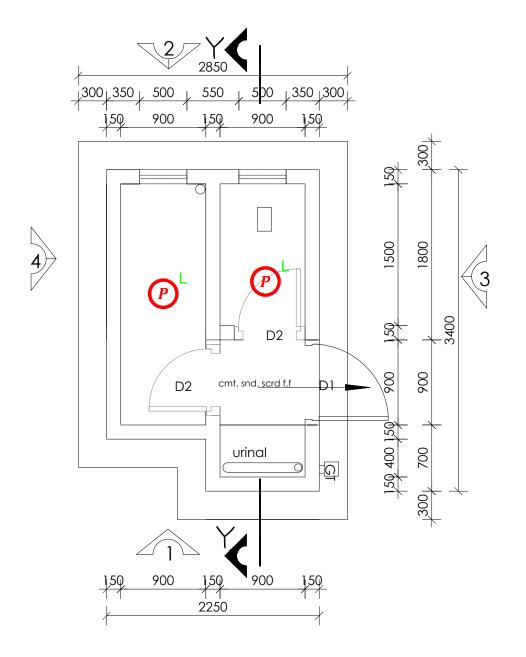

CLIENT :



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MINISTRY OF WATER AND ENVIRONMENT

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CONSULTANT :



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PROJECT


ALA-ORA WATER SUPPLY AND SANITATION PROJECT


ENYAU WATER SUPPLY AND SANITATION SYSTEM


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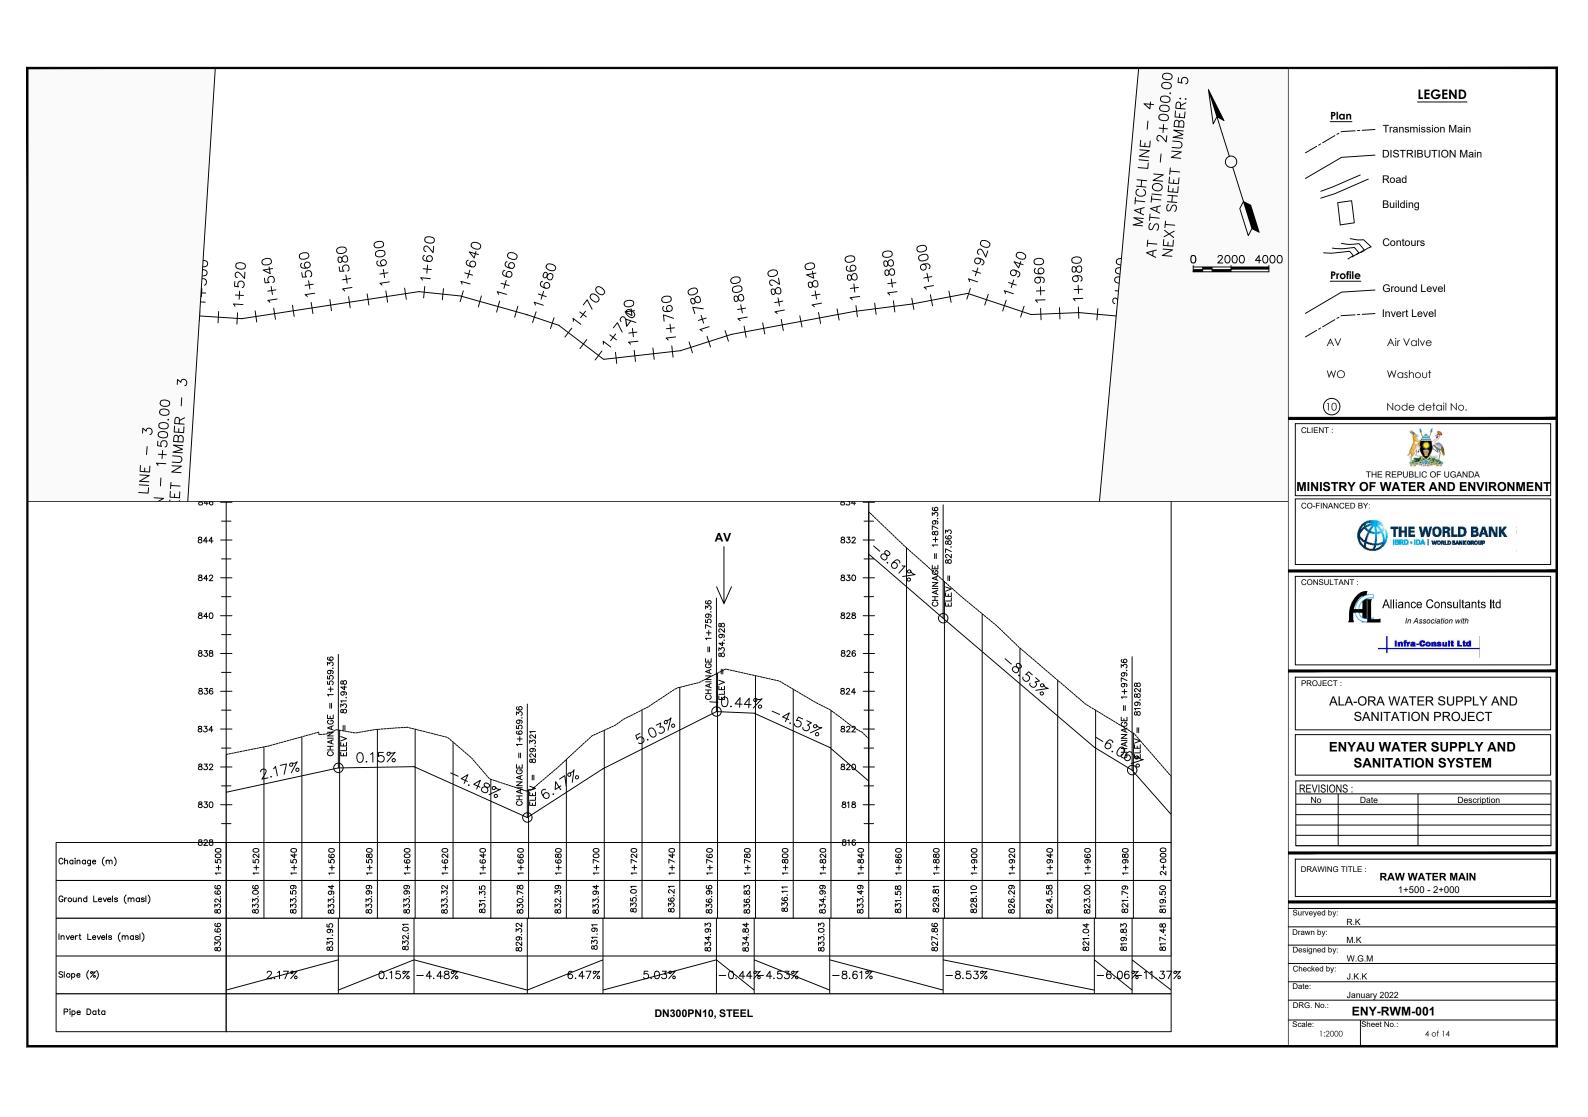
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Electrical Layouts


Surveyed by:
R.K
Drawn by:
A.K
Designed by:
W.G.M
Checked by:
J.K.K
Date:
January 2023
DRG. No.:
ENY-INT-004
Scale:
1:30
Sheet No.:
3 of 3




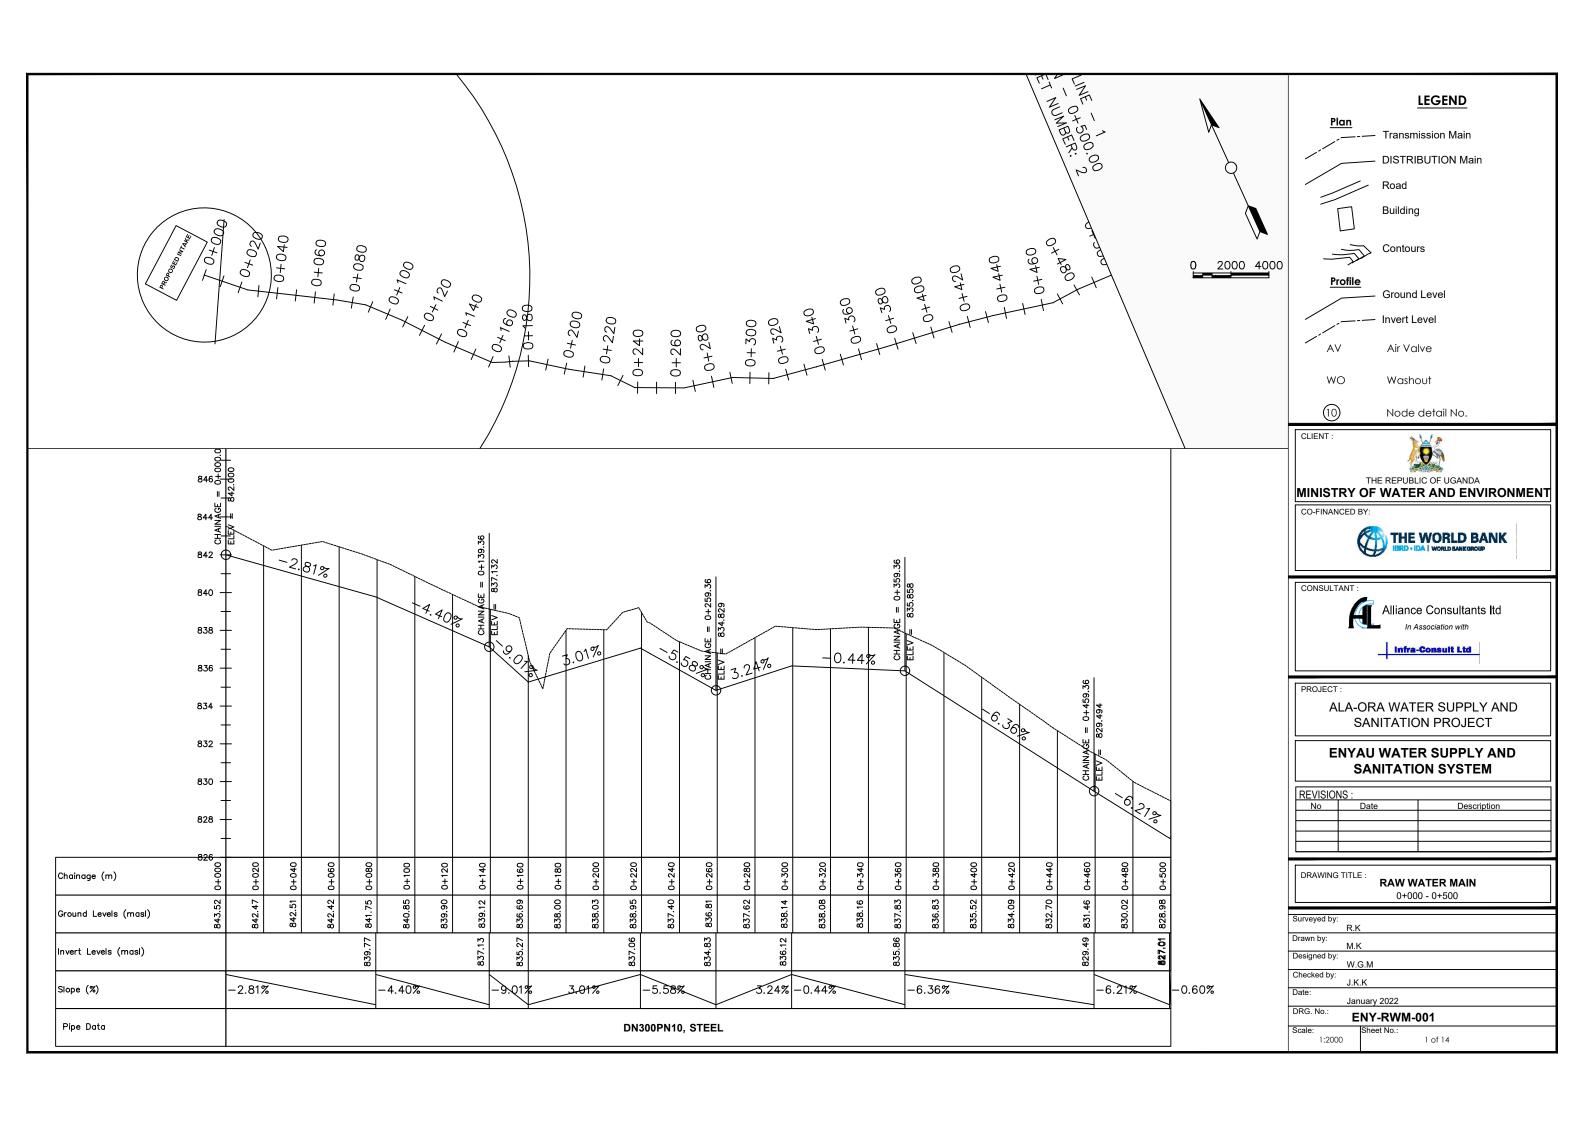


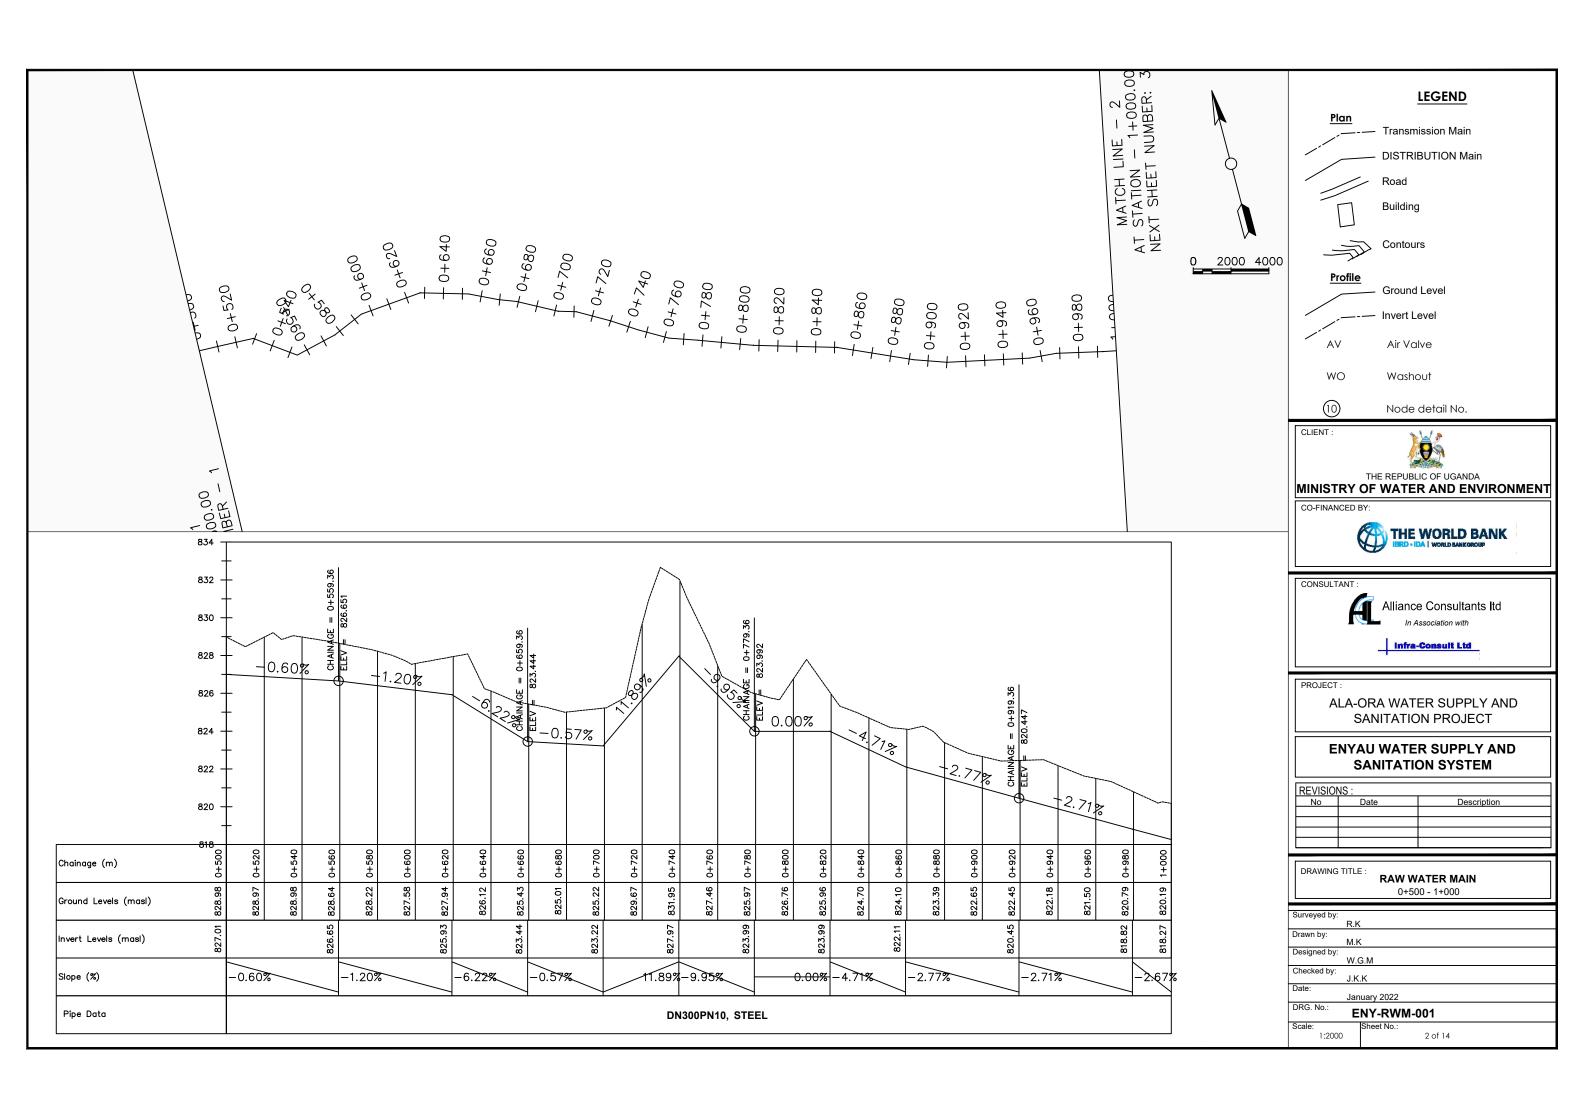


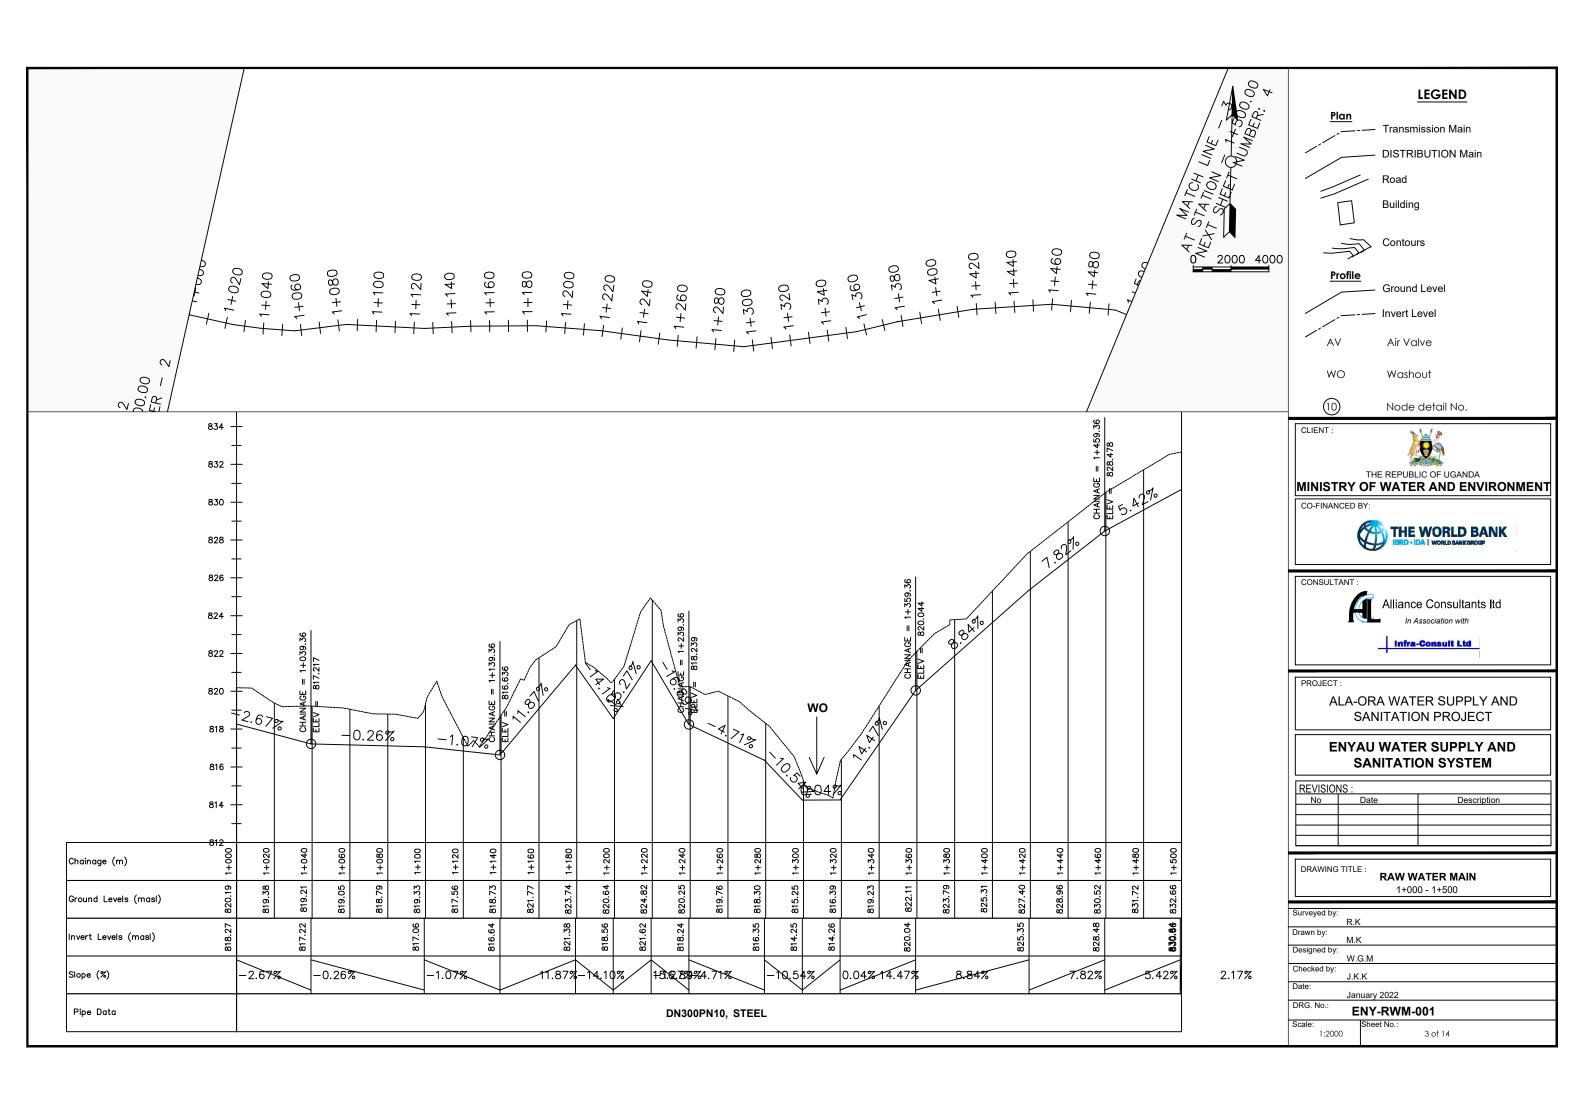


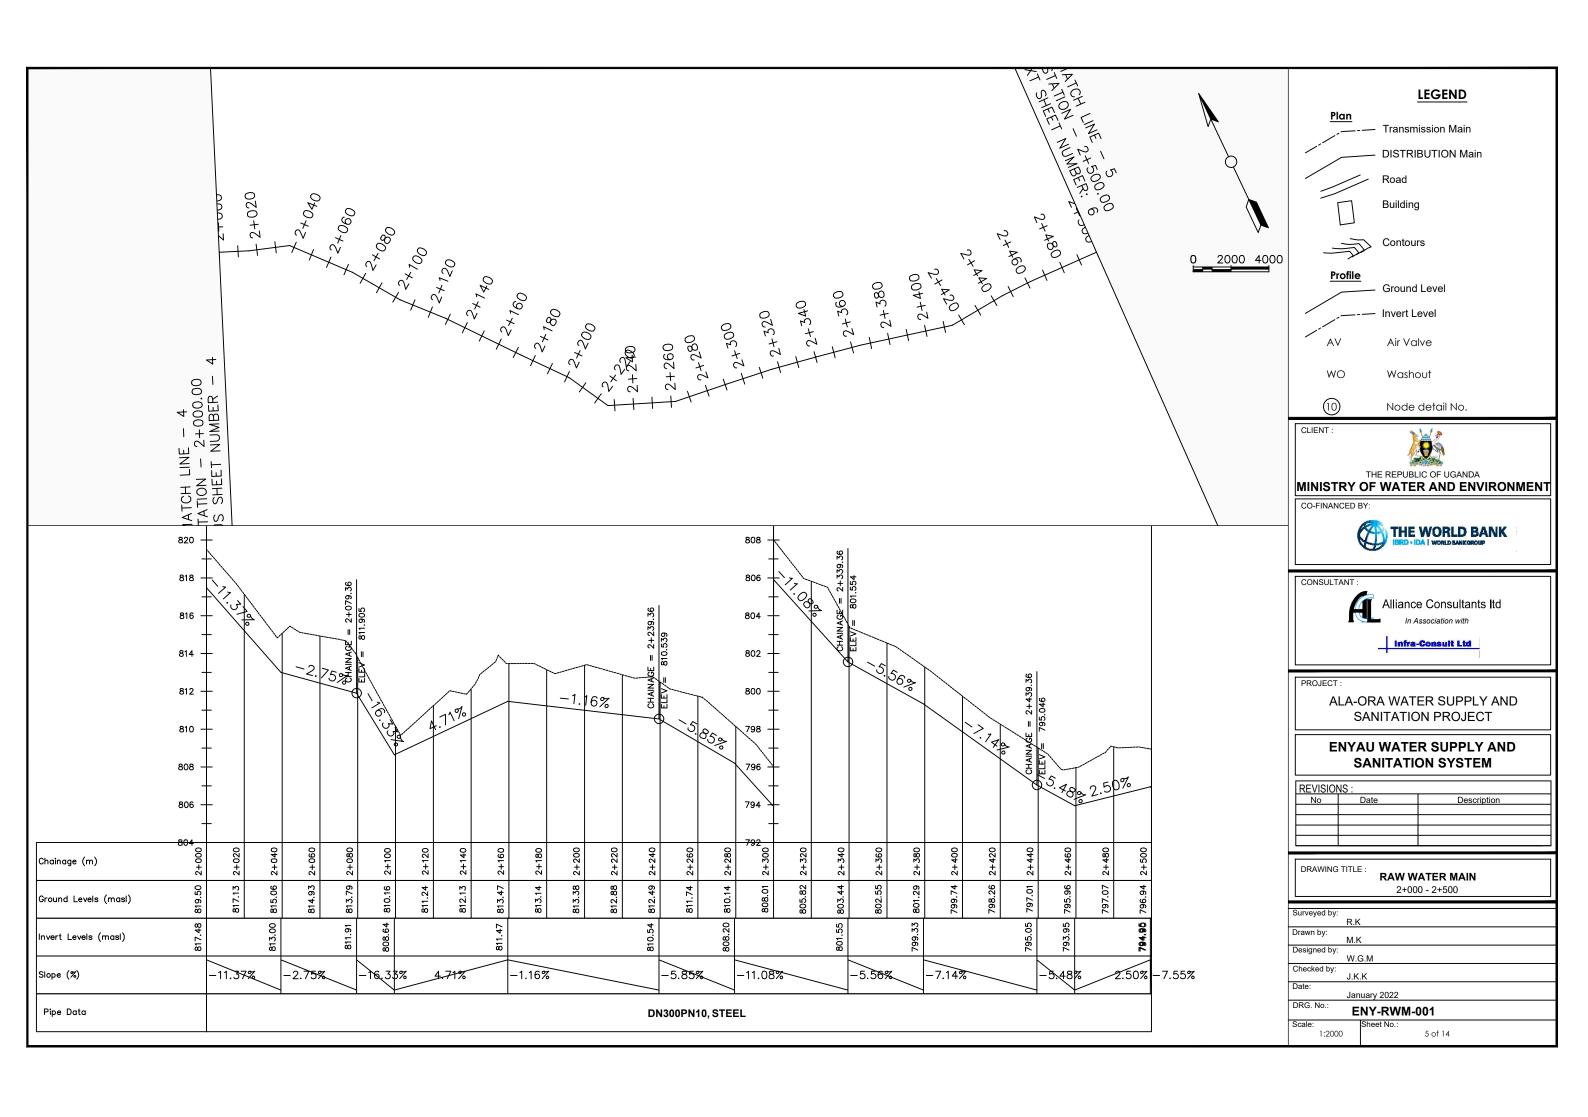


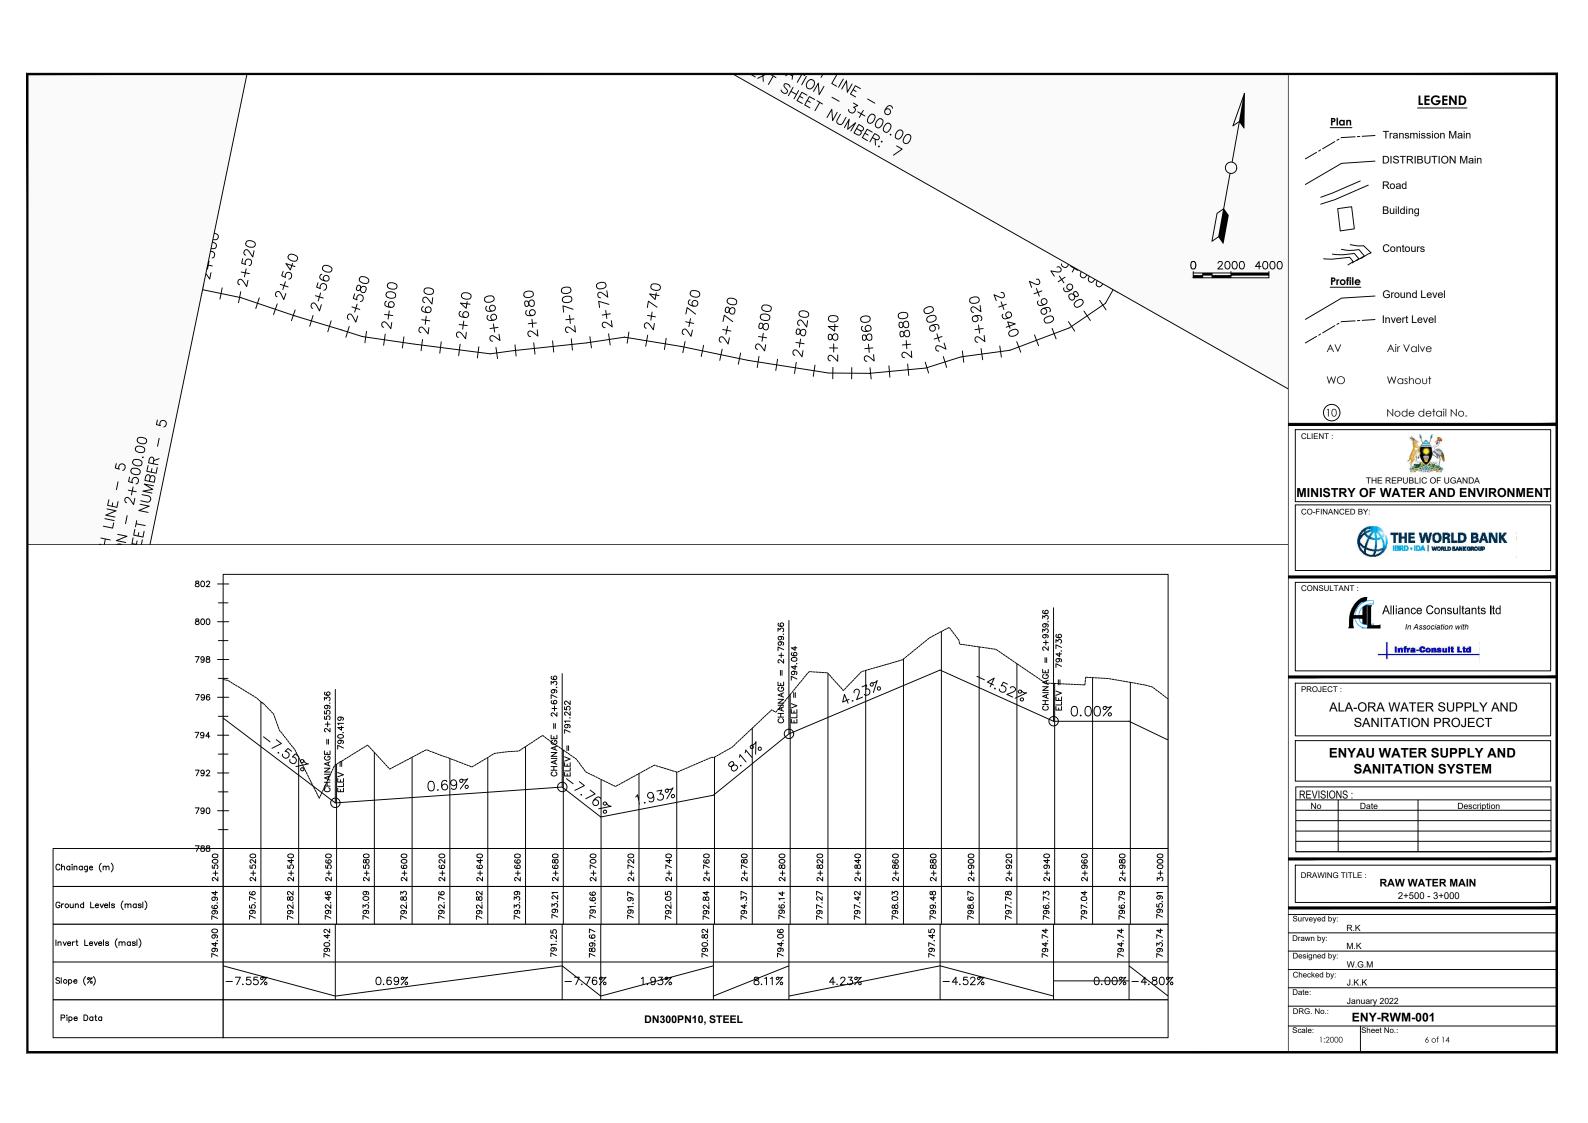


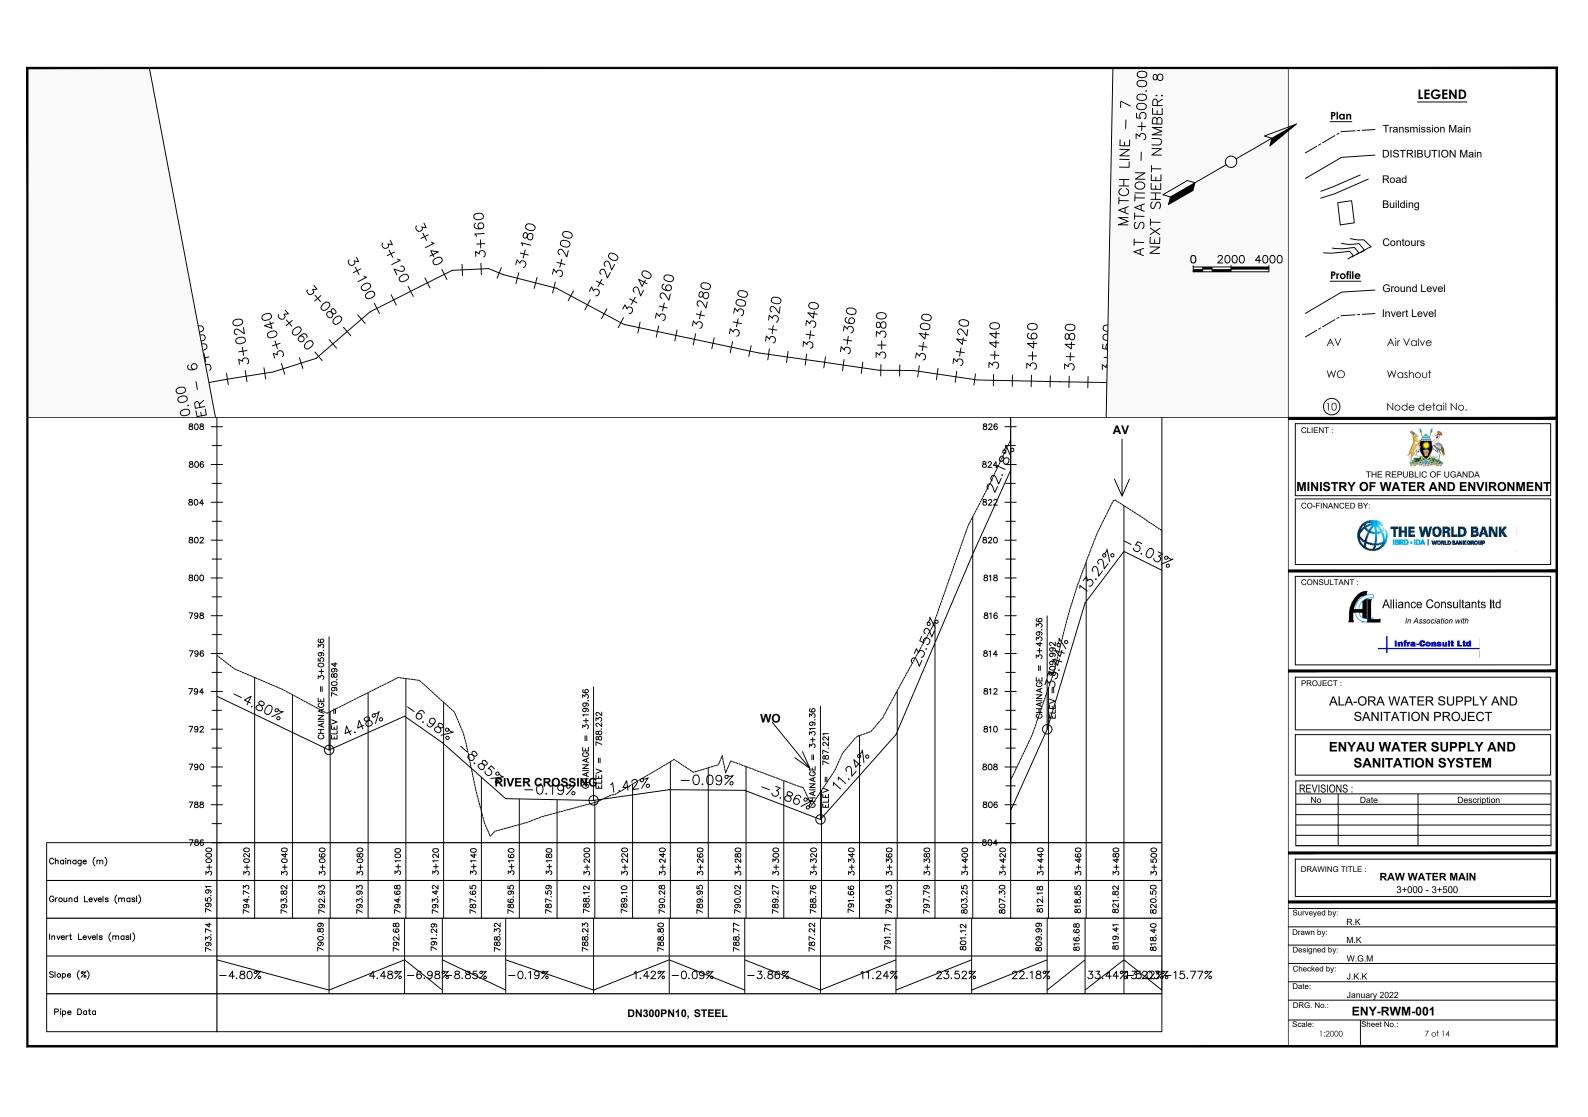


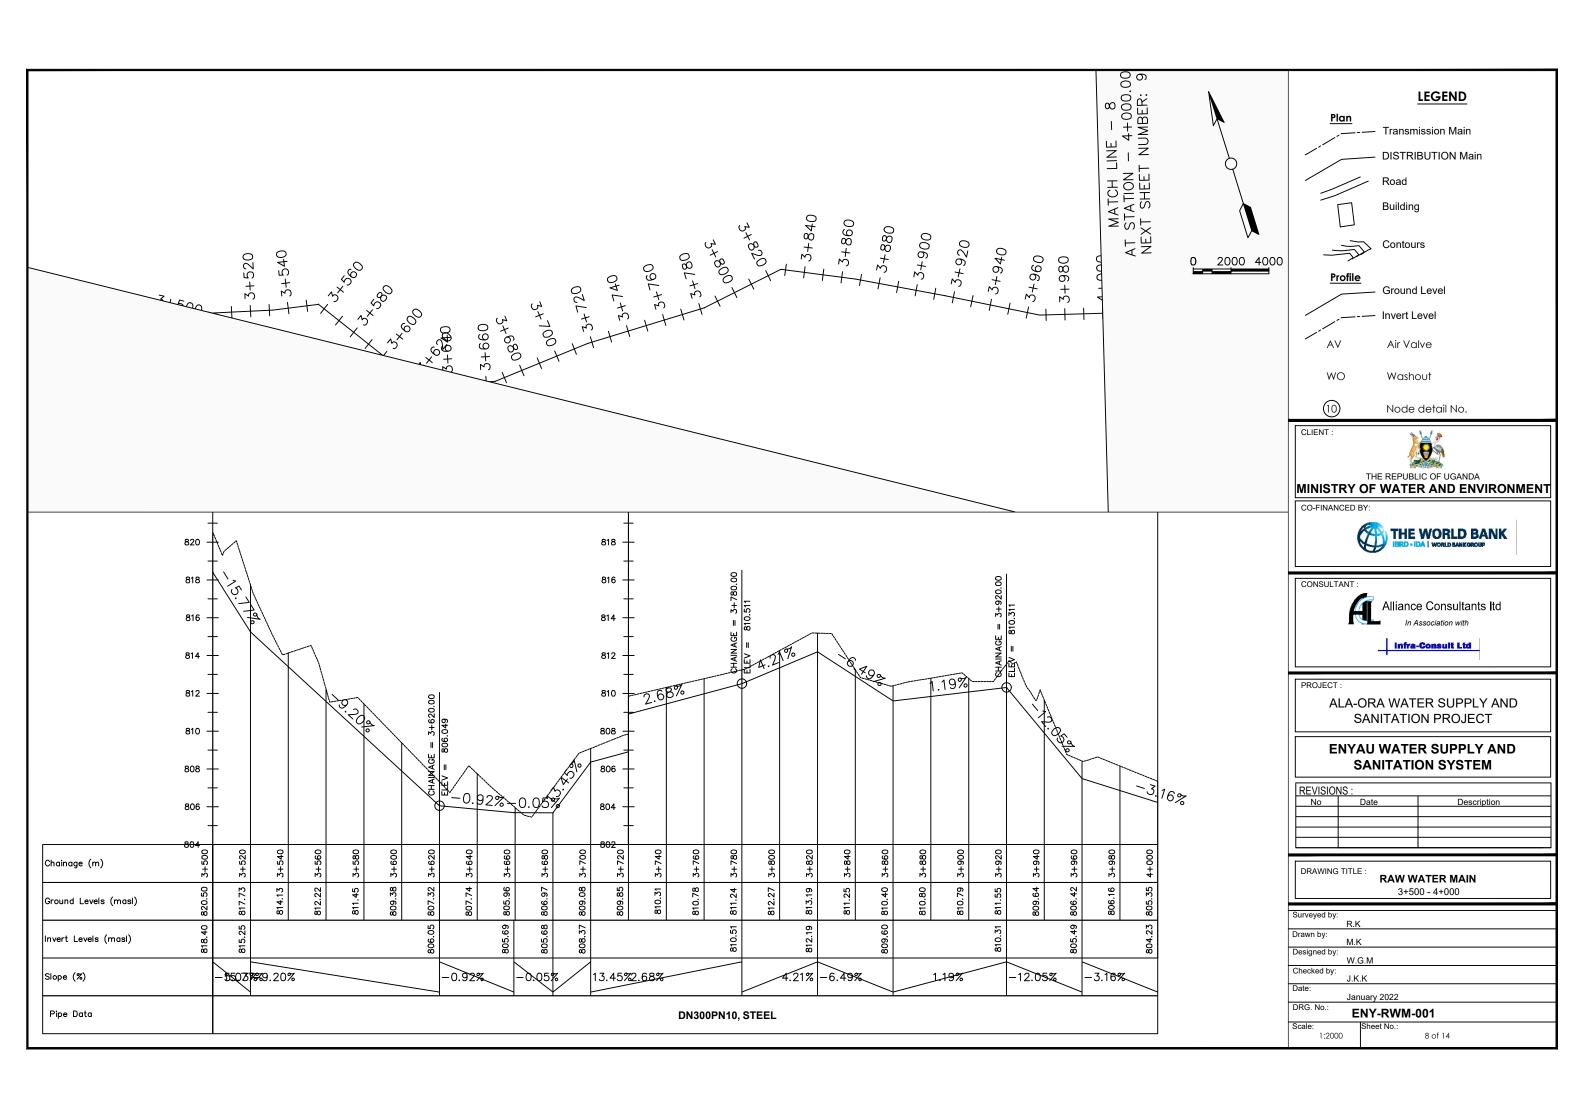


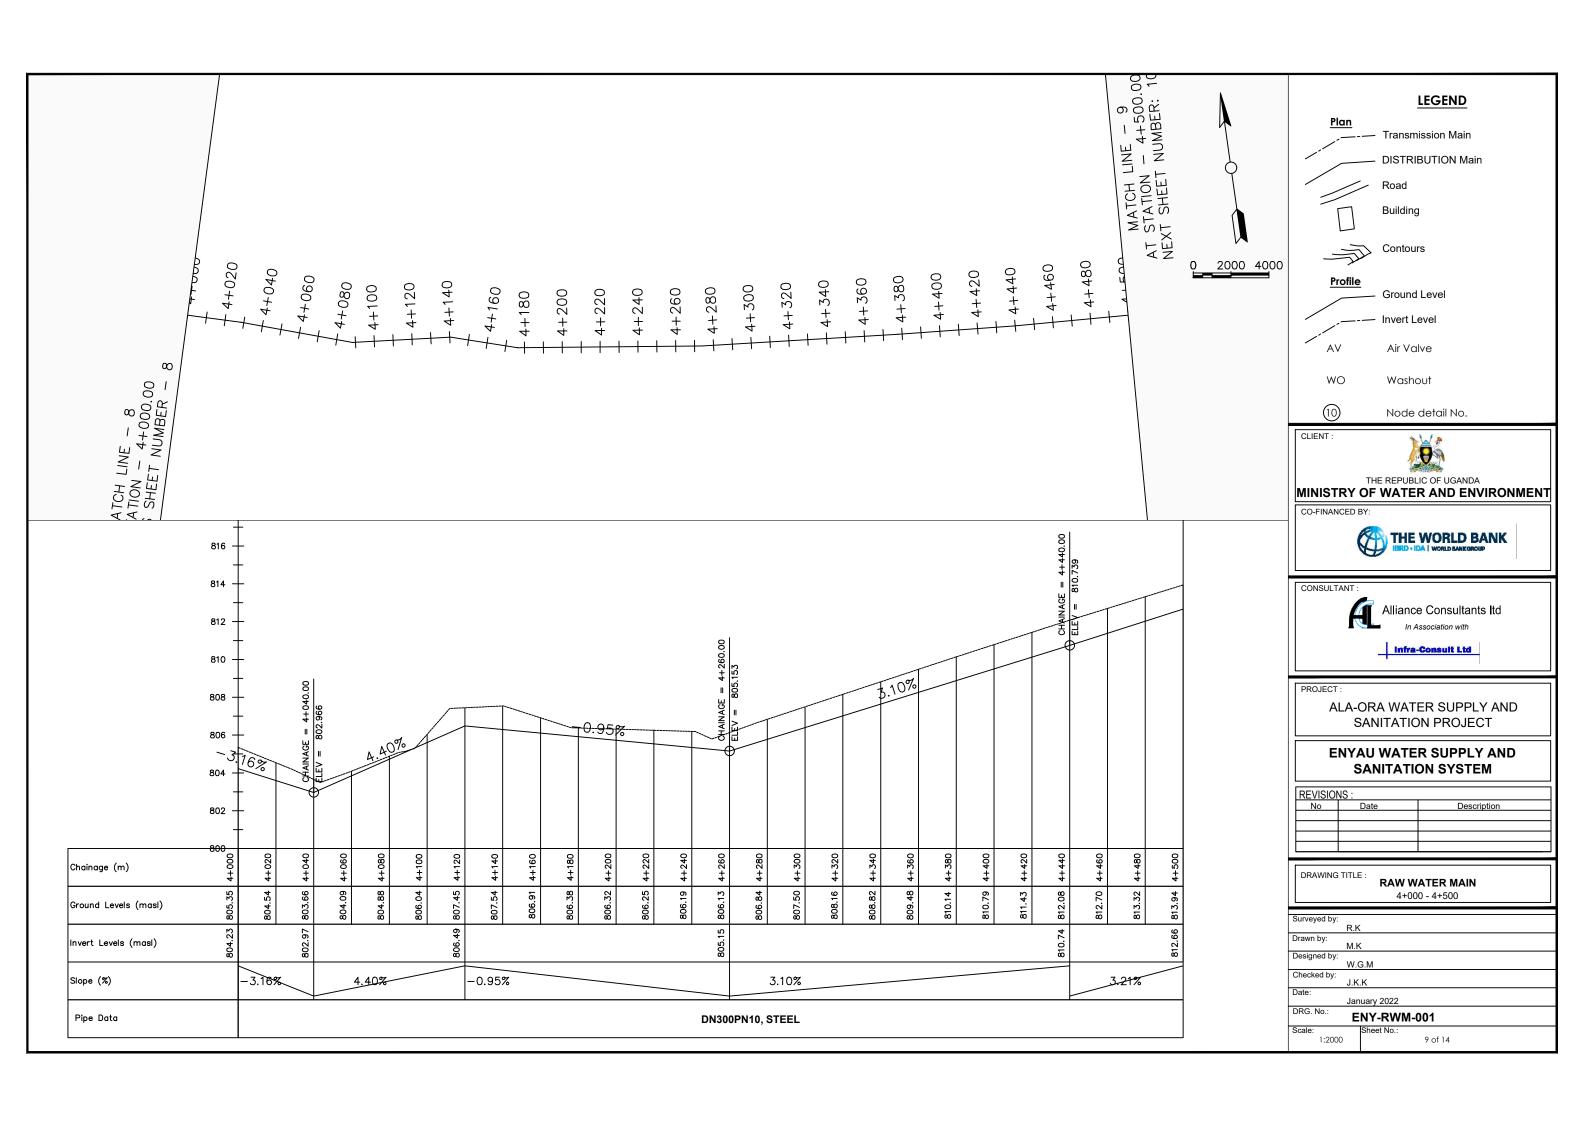


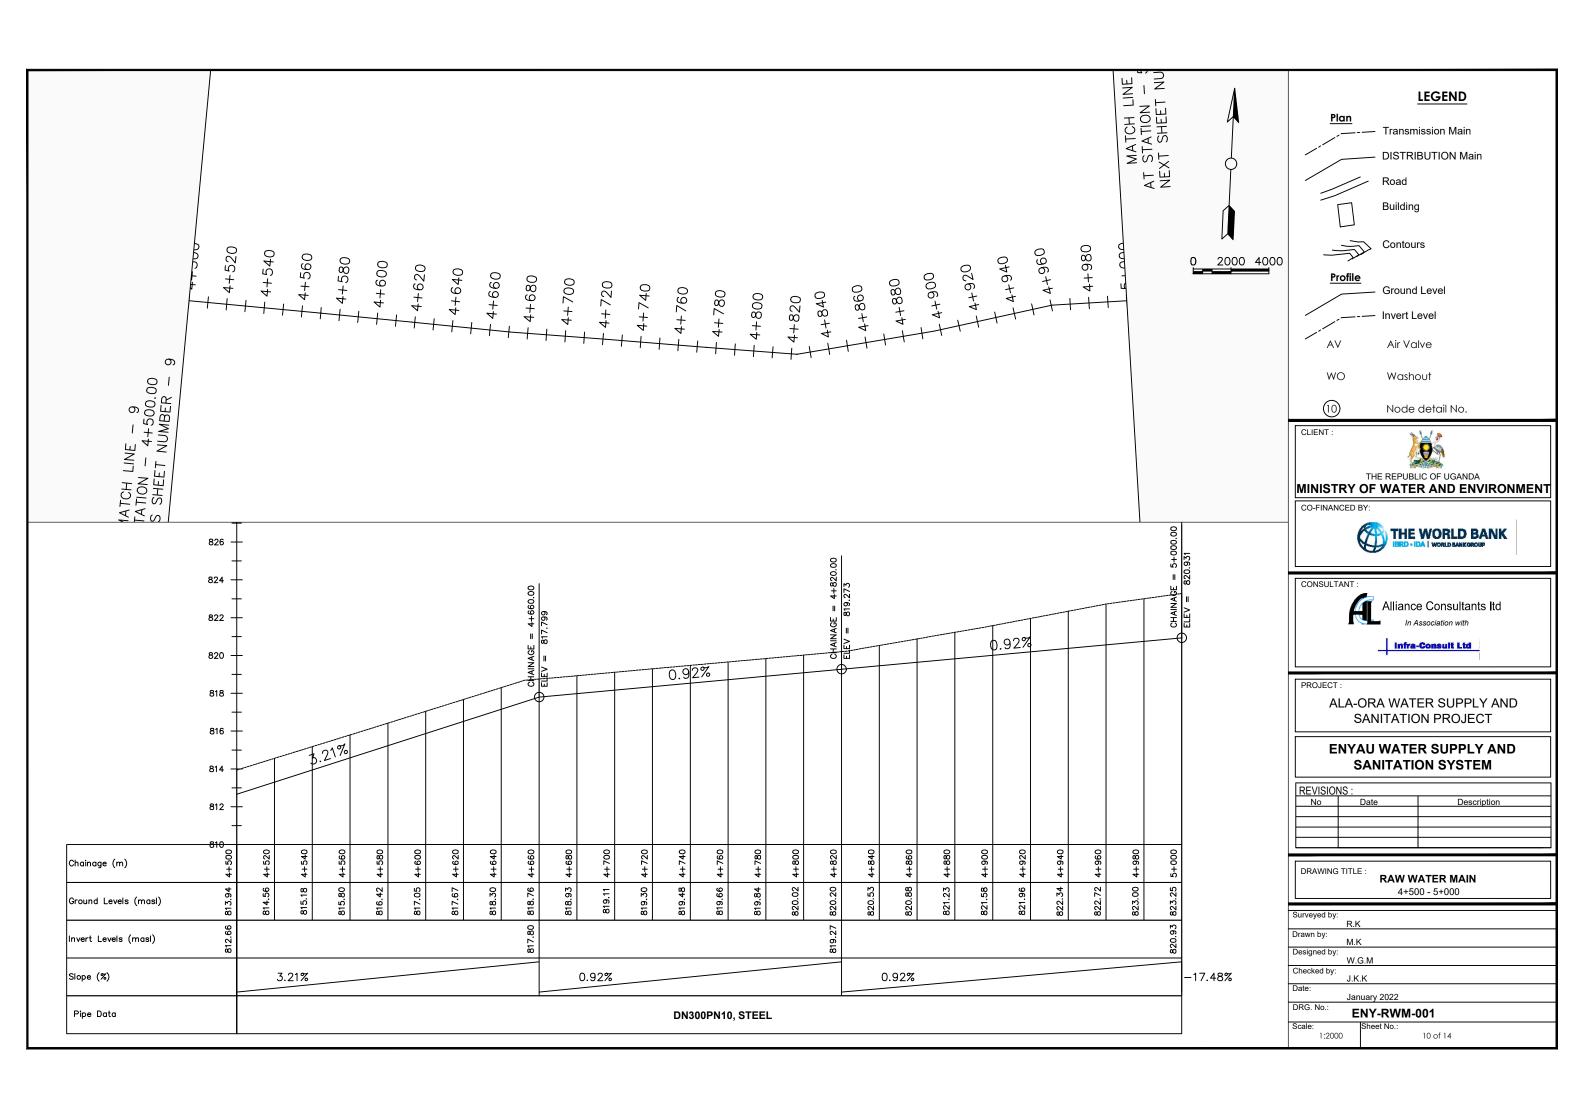


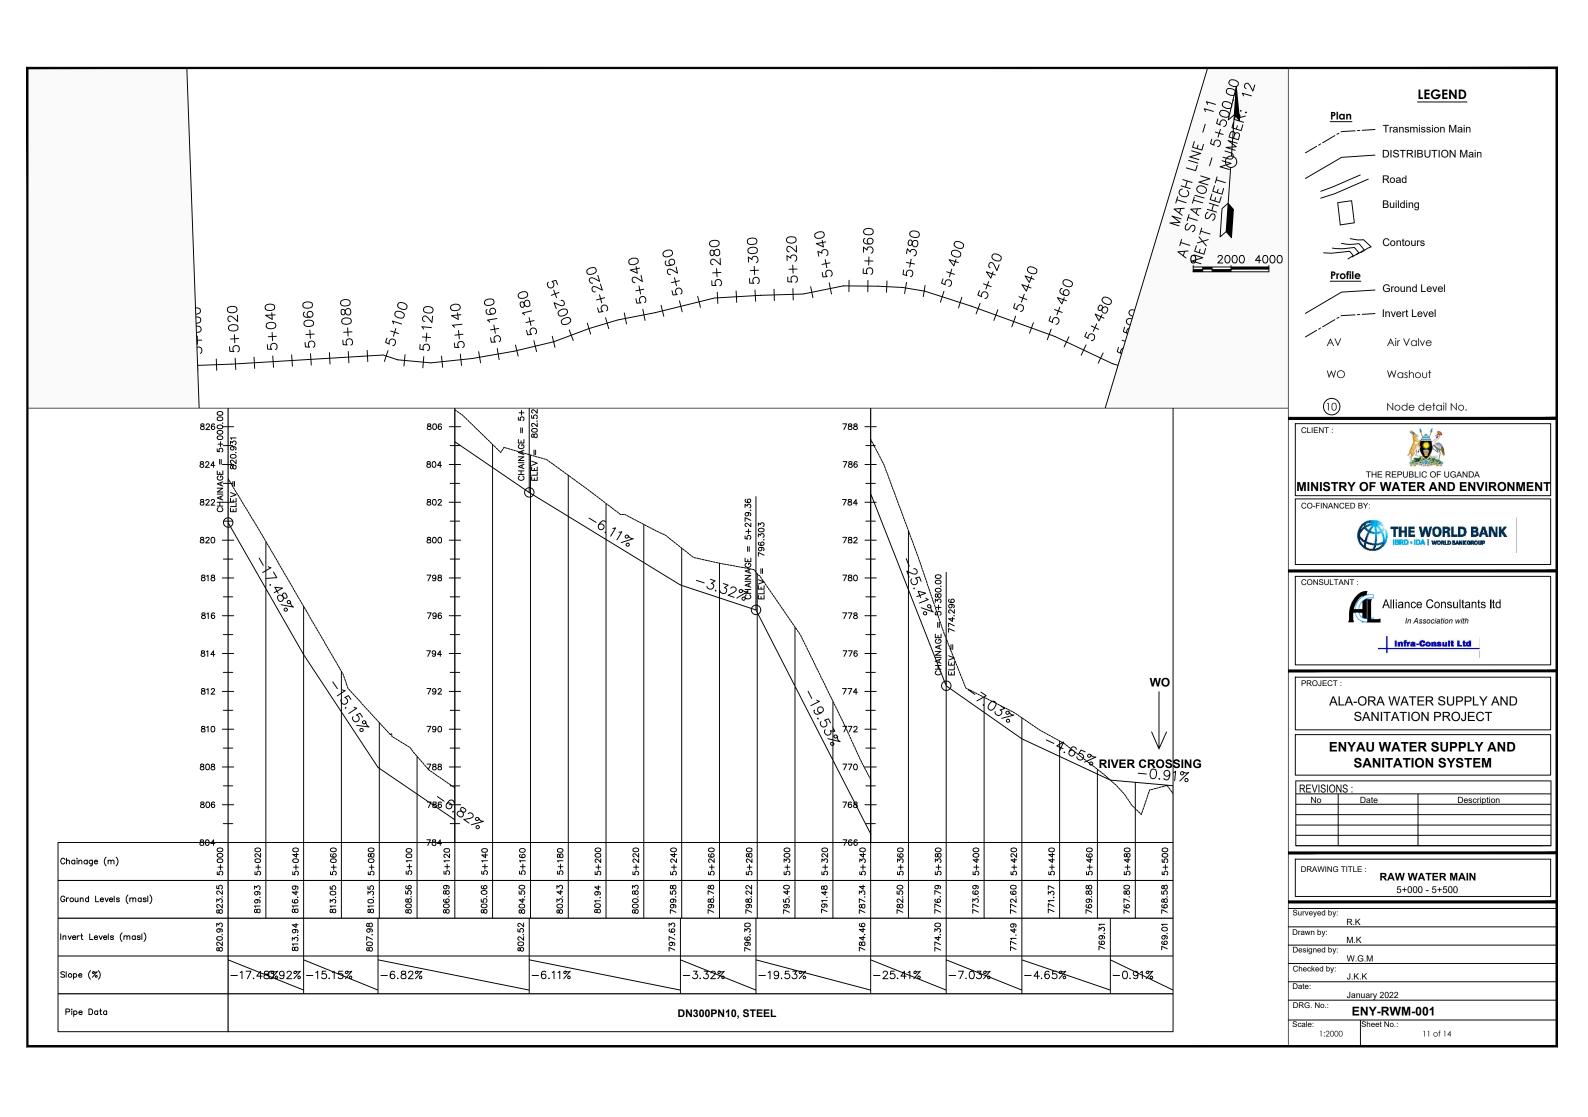

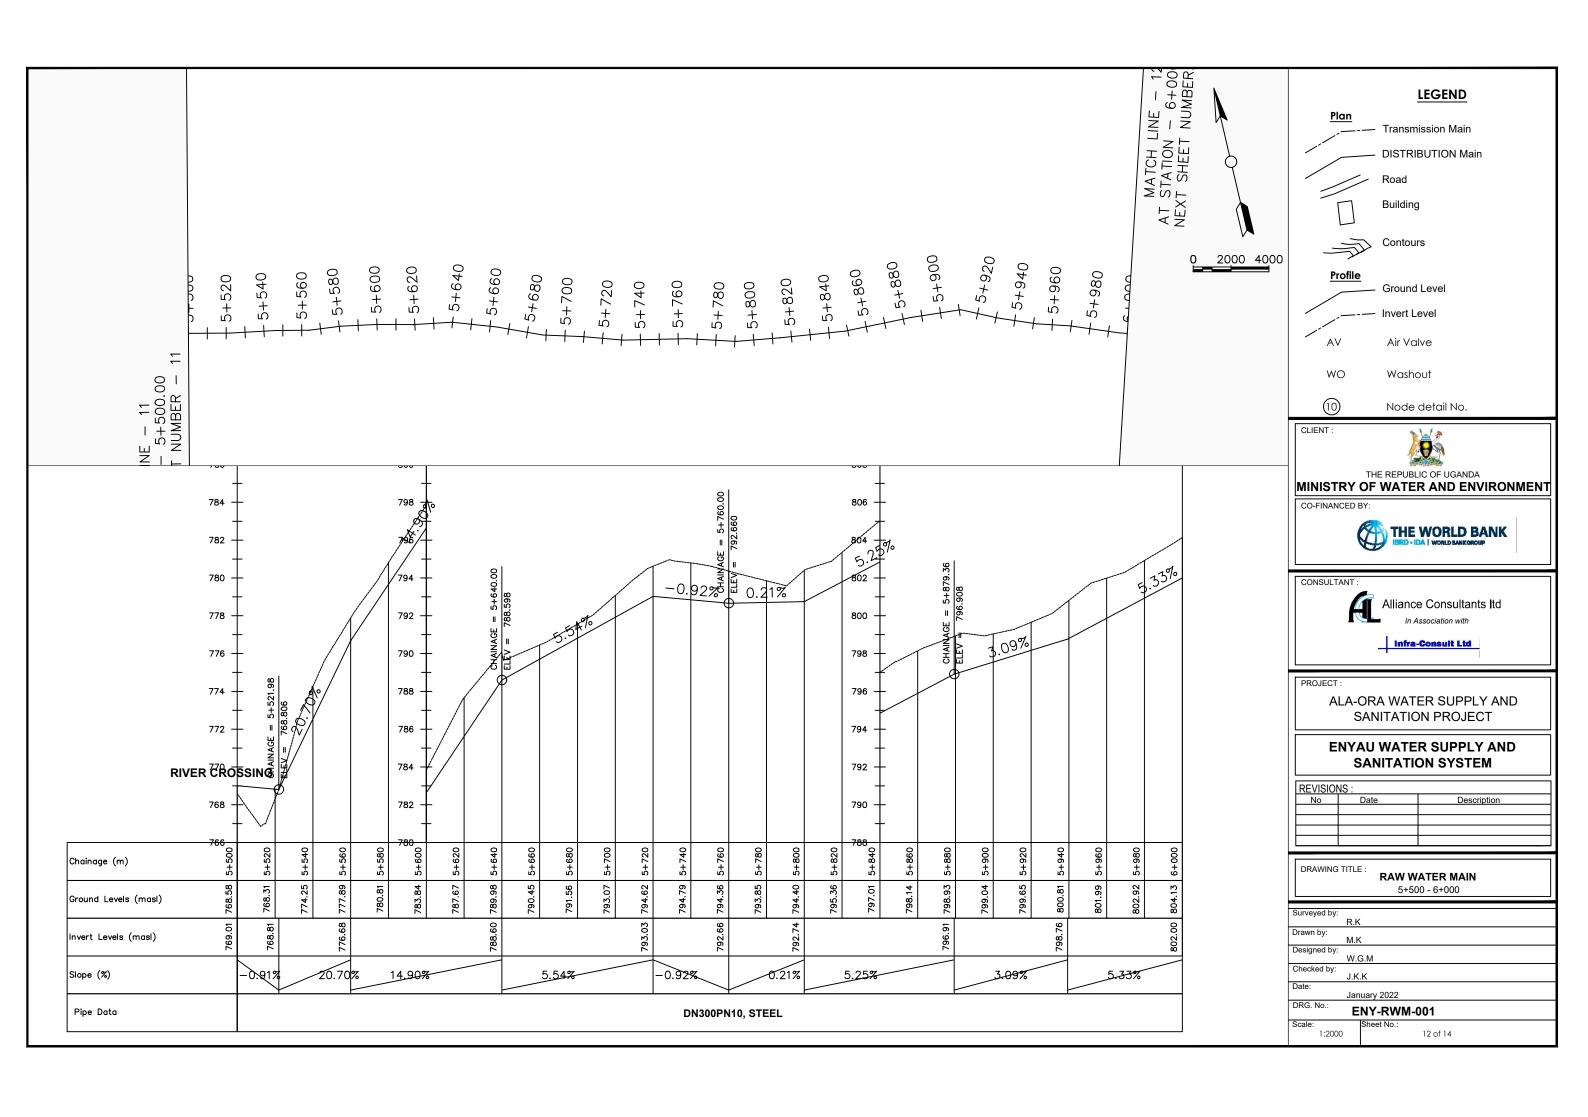

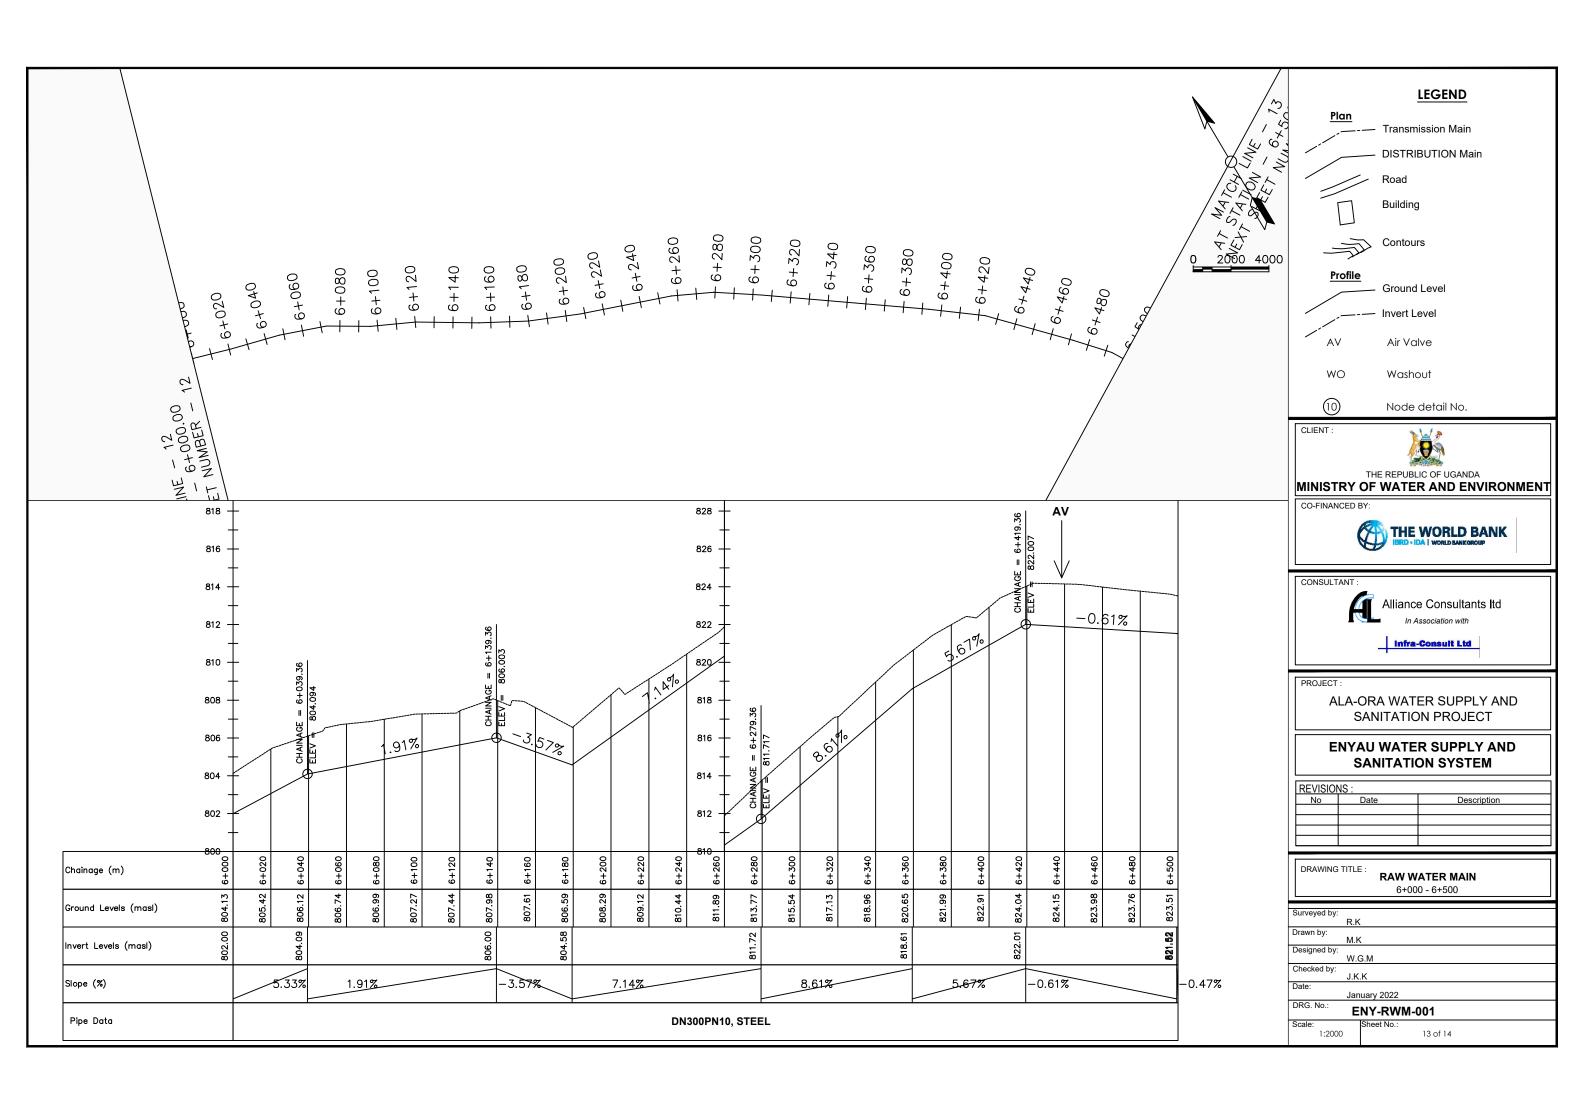

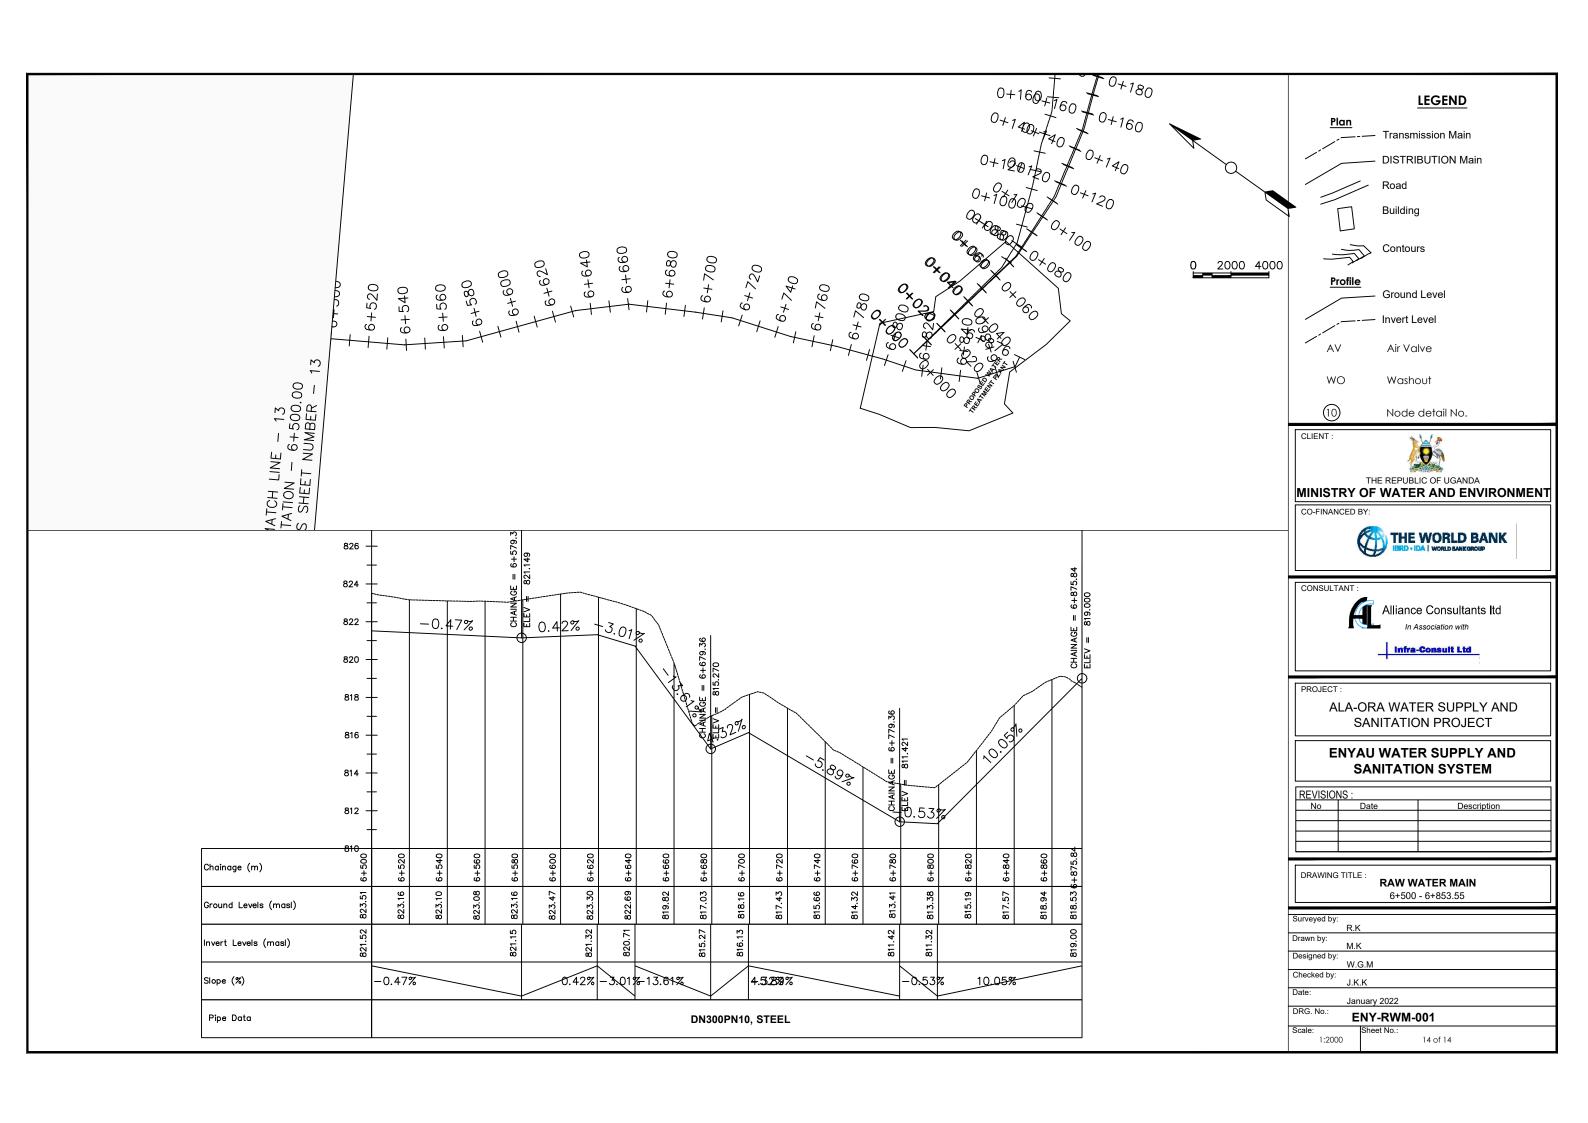

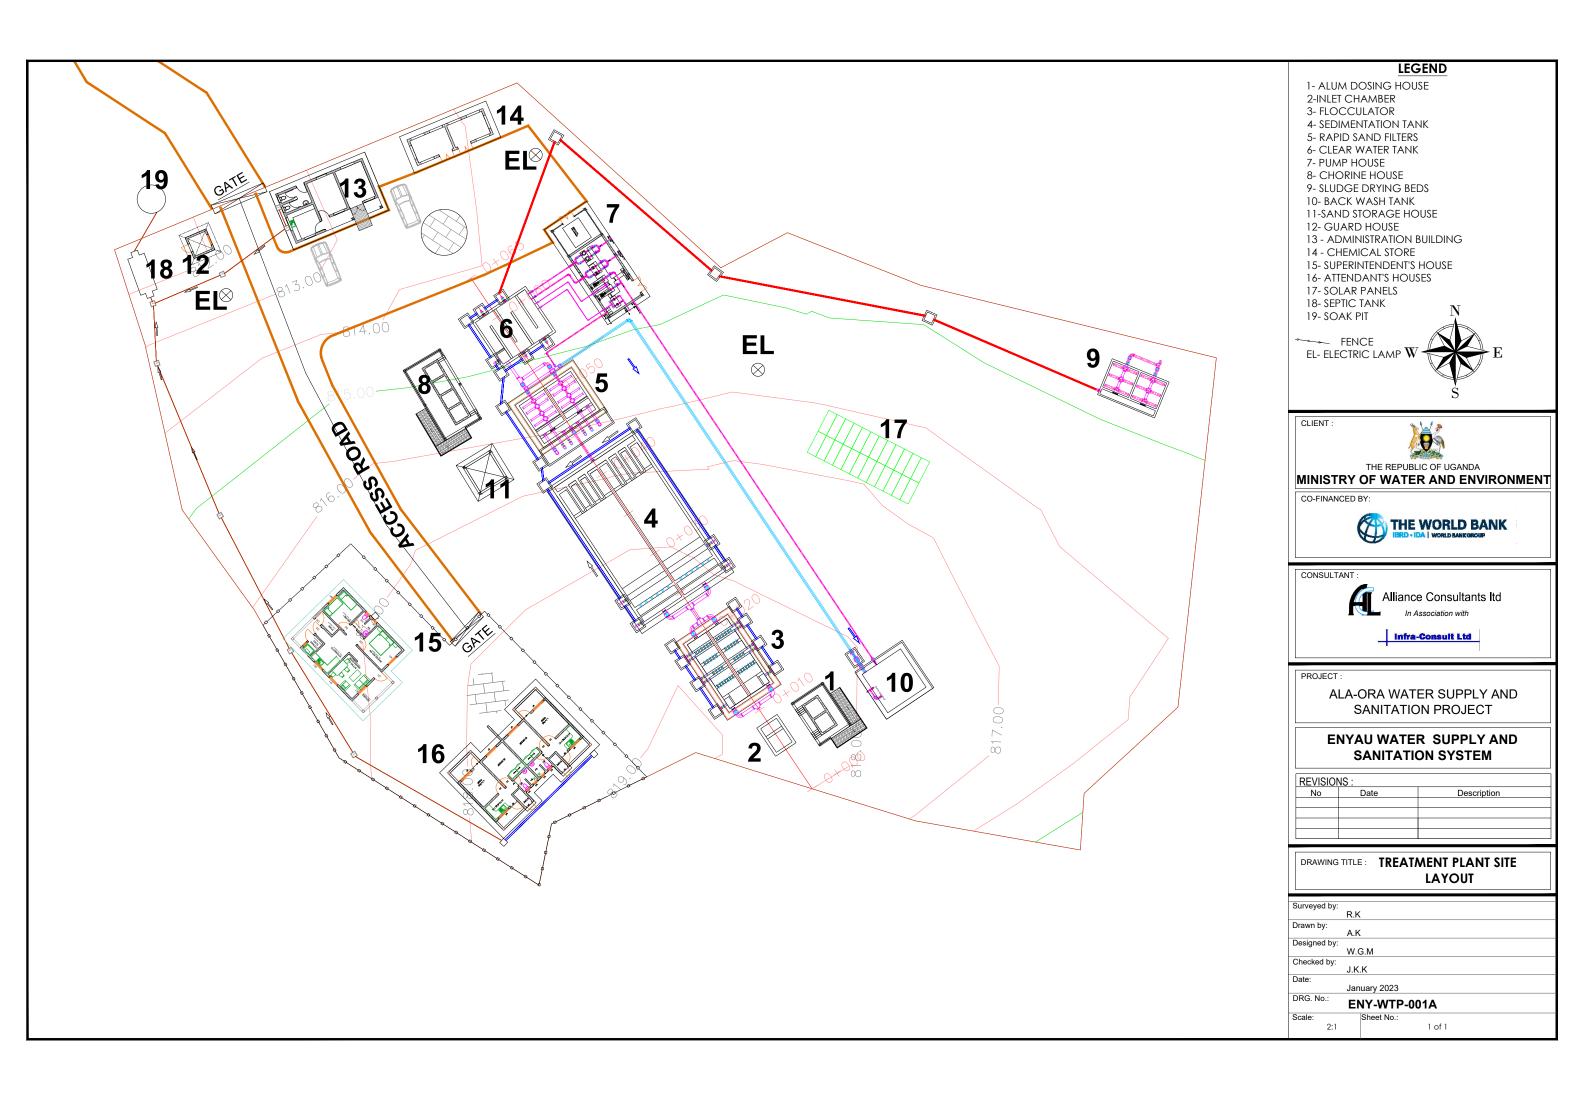


Alignment - (4) PROFILE

LEGEND

- 1- ALUM DOSING HOUSE 2- FLOCCULATOR
- 3- SEDIMENTATION TANK
- 4- RAPID SAND FILTERS
- 5- CLEAR WATER TANK



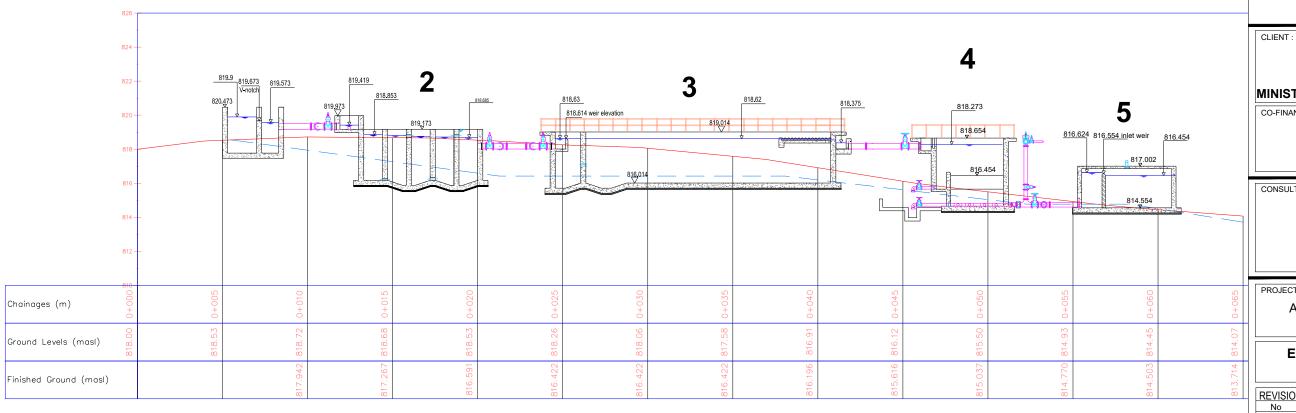





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ALA-ORA WATER SUPPLY AND SANITATION PROJECT


ENYAU WATER SUPPLY AND SANITATION SYSTEM

REVISIONS:		
No	Date	Description

DRAWING TITLE: TREATMENT PLANT SITE **PROFILE**

Surveyed by:	
	R.K
Drawn by:	
D.u 2,.	A.K
Designed by:	
,	W.G.M
Checked by:	
•	J.K.K
Date:	
	January 2023
DRG. No.:	
	ENY-WTP-001B
Scale:	Sheet No.:
4.5:1	1 of 1
4.0.1	1 5.1

3600 300 300 DN 300 flanged Butterfly valve A DN 300 Inlet Pipe SECTIONAL PLAN

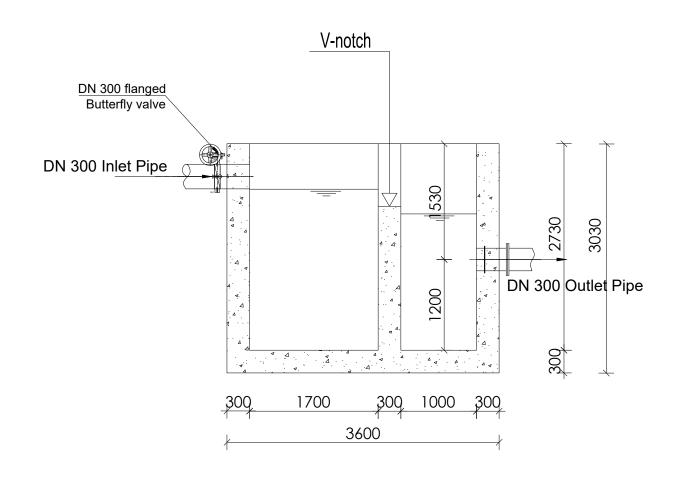

LEGEND



CLIENT :



THE REPUBLIC OF UGANDA
MINISTRY OF WATER AND ENVIRONMENT

CO-FINANCED BY:



CONSULTANT :



Alliance Consultants Itd

Infra-Consult Ltd

PRO IEC

ALA-ORA WATER SUPPLY AND SANITATION PROJECT


ENYAU WATER SUPPLY AND SANITATION SYSTEM


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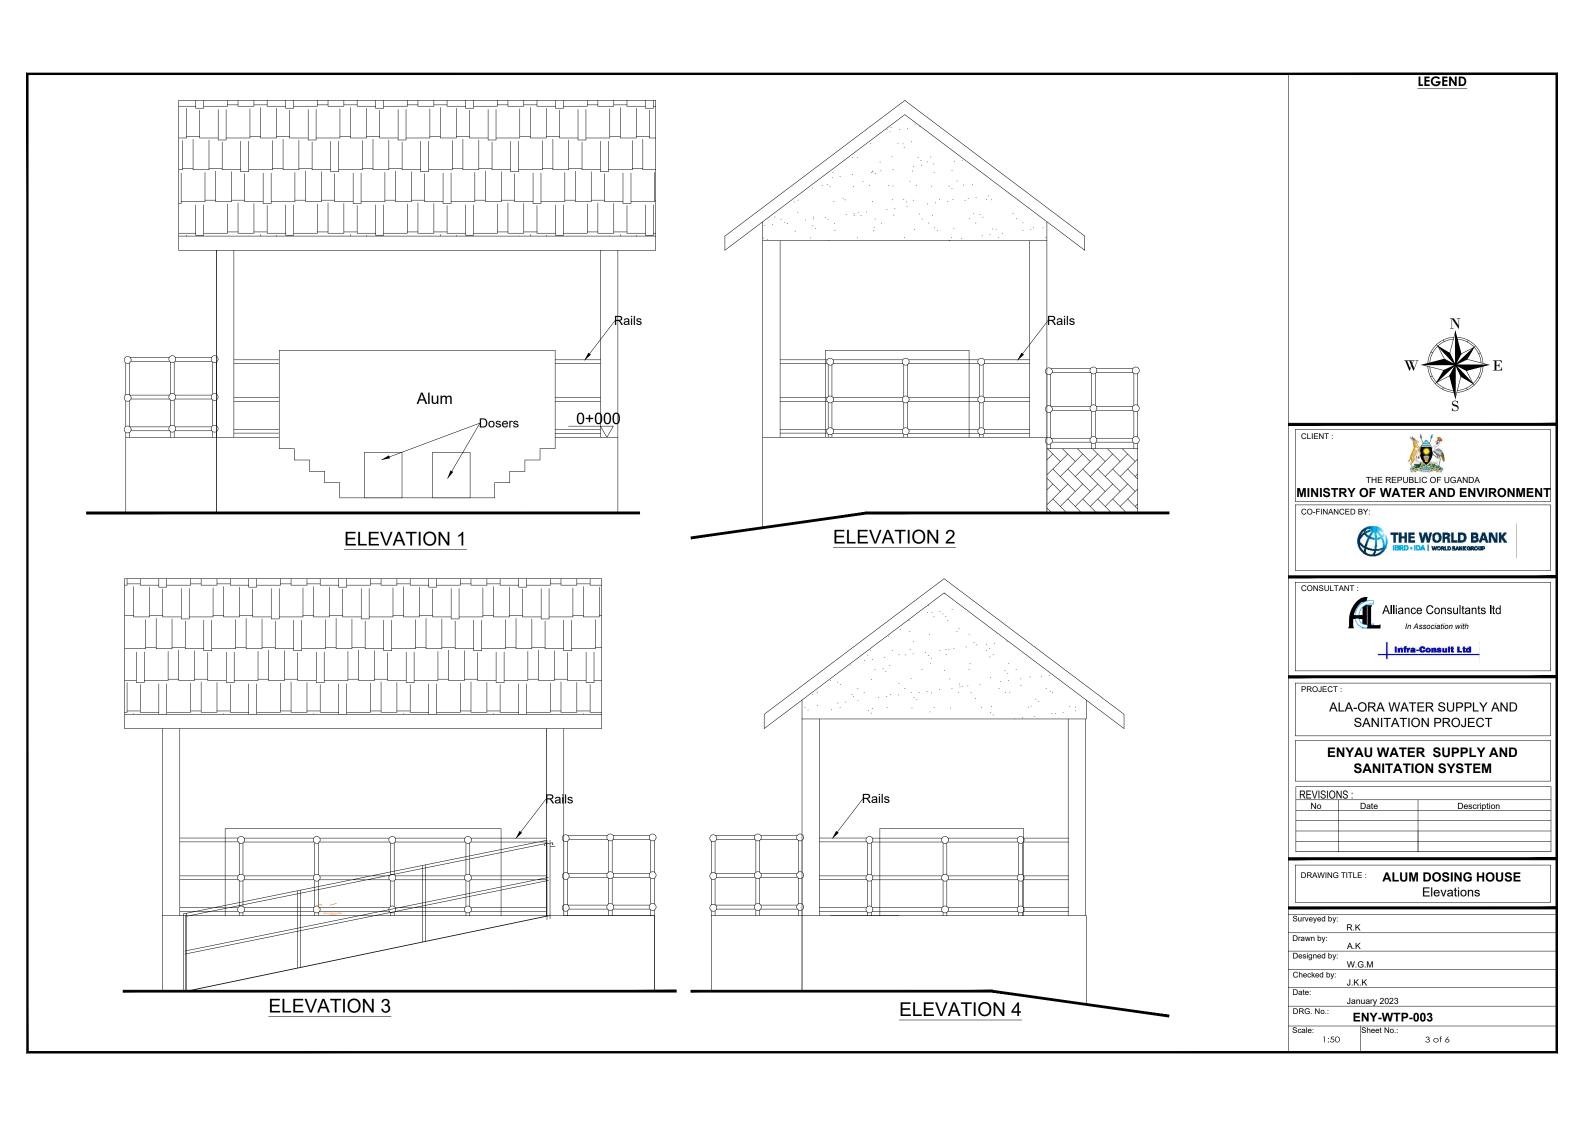
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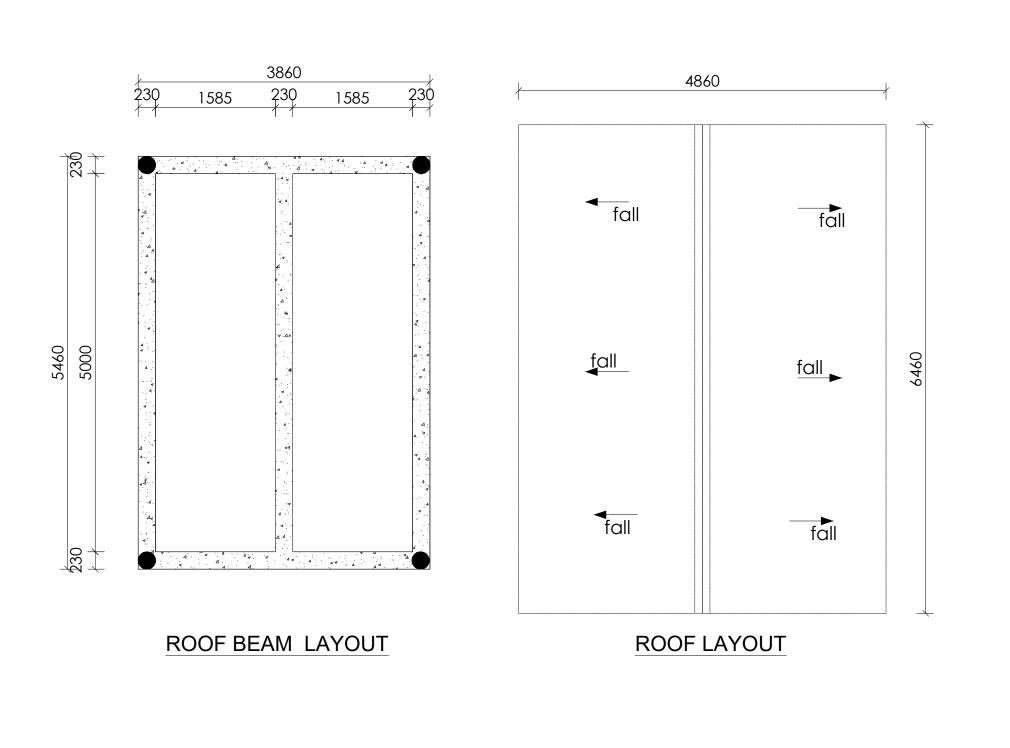
INLET STRUCTURE

Designed by:	A.K	
	W.G.M	
Checked by:	J.K.K	
Date:	January 2023	
DRG. No.:	ENY-WTP-002	





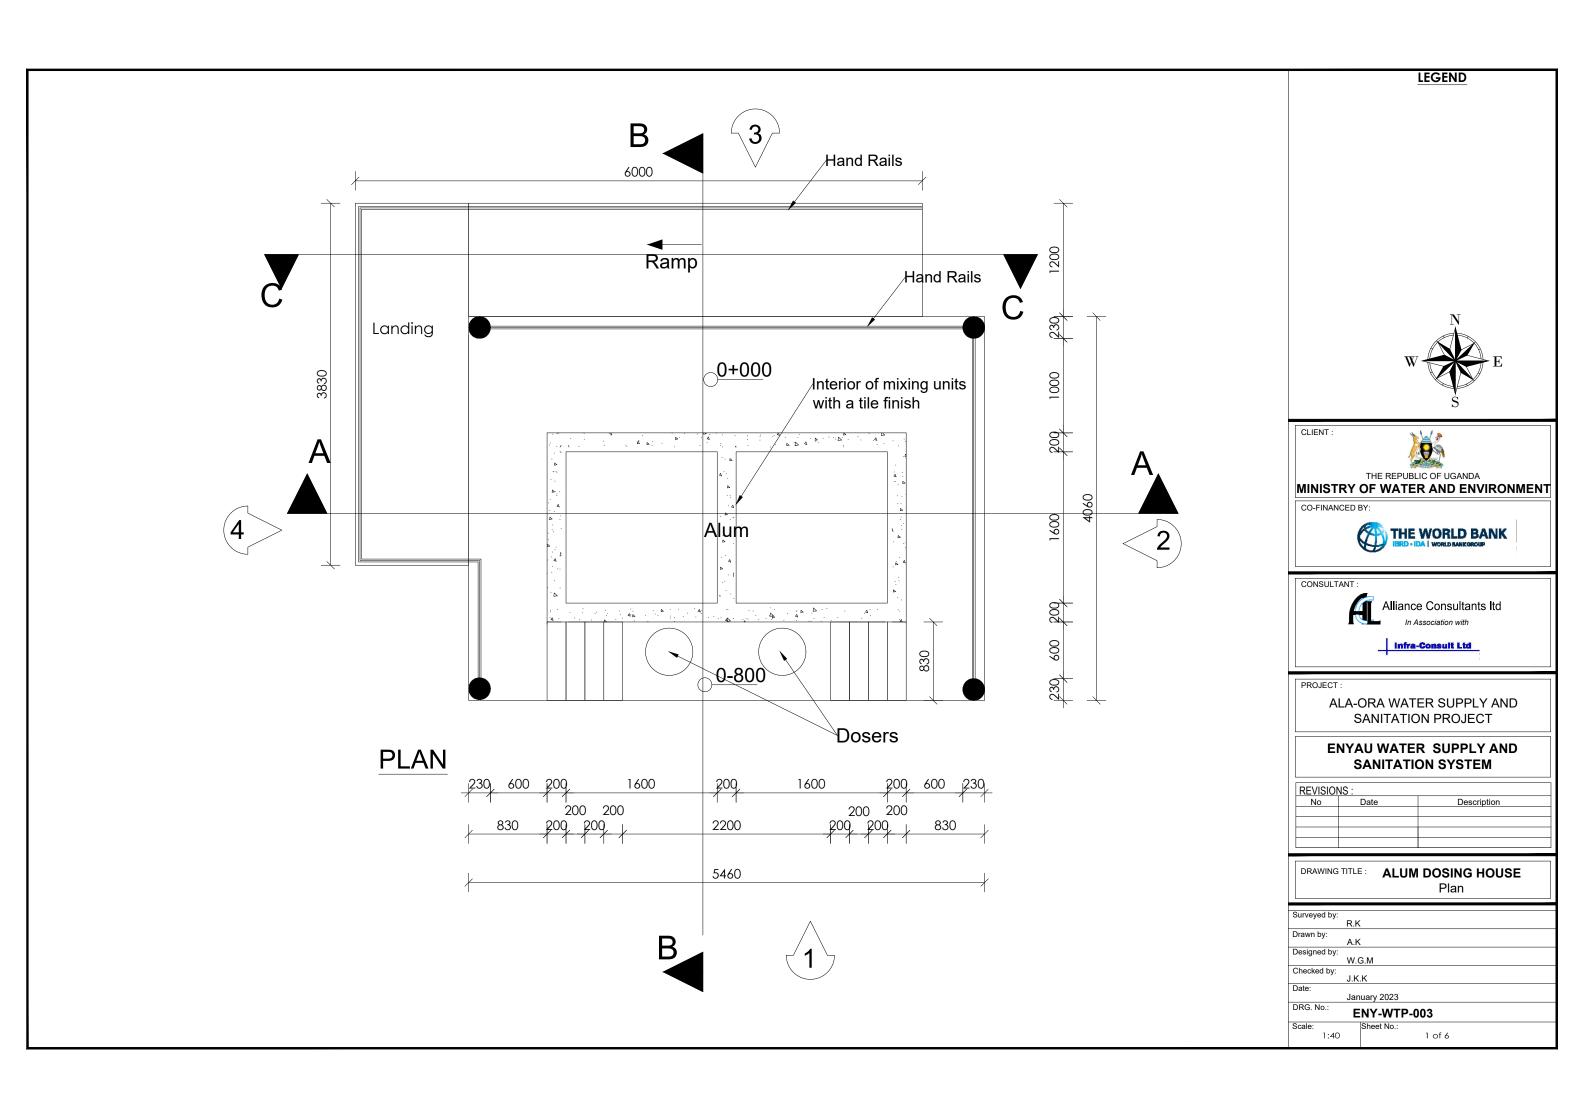

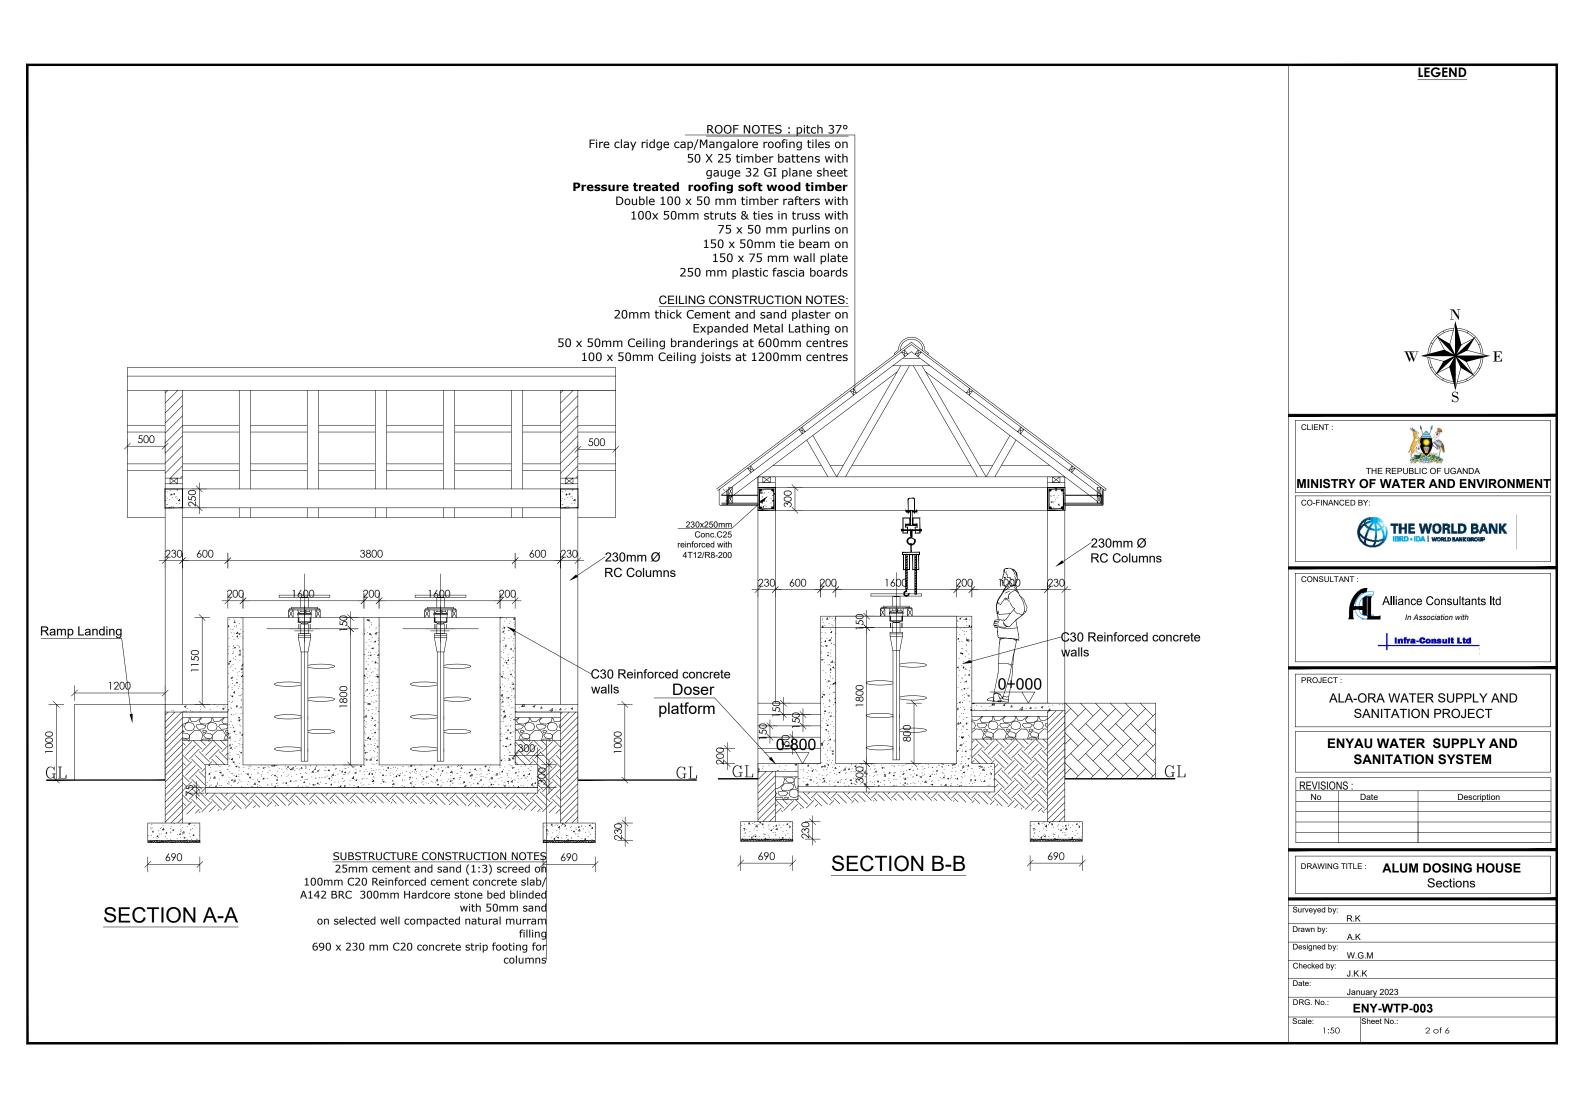







THE REPUBLIC OF UGANDA
MINISTRY OF WATER AND ENVIRONMENT

CO-FINANCED BY:



CONSULTANT :



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Infra-Consult I td

PRO IECT

ALA-ORA WATER SUPPLY AND SANITATION PROJECT


ENYAU WATER SUPPLY AND SANITATION SYSTEM


REVISIONS:		
No	Date	Description

DRAWING TITLE: ALUM DOSING HOUSE

Roof and Roof Beam Layout

Surveyed by:	
, ,	R.K
Drawn by:	
,	A.K
Designed by:	
	W.G.M
Checked by:	
	J.K.K
Date:	
	January 2023
DRG. No.:	ENV MED AND
	ENY-WTP-003
Scale:	Sheet No.:
1:50	4 of 6

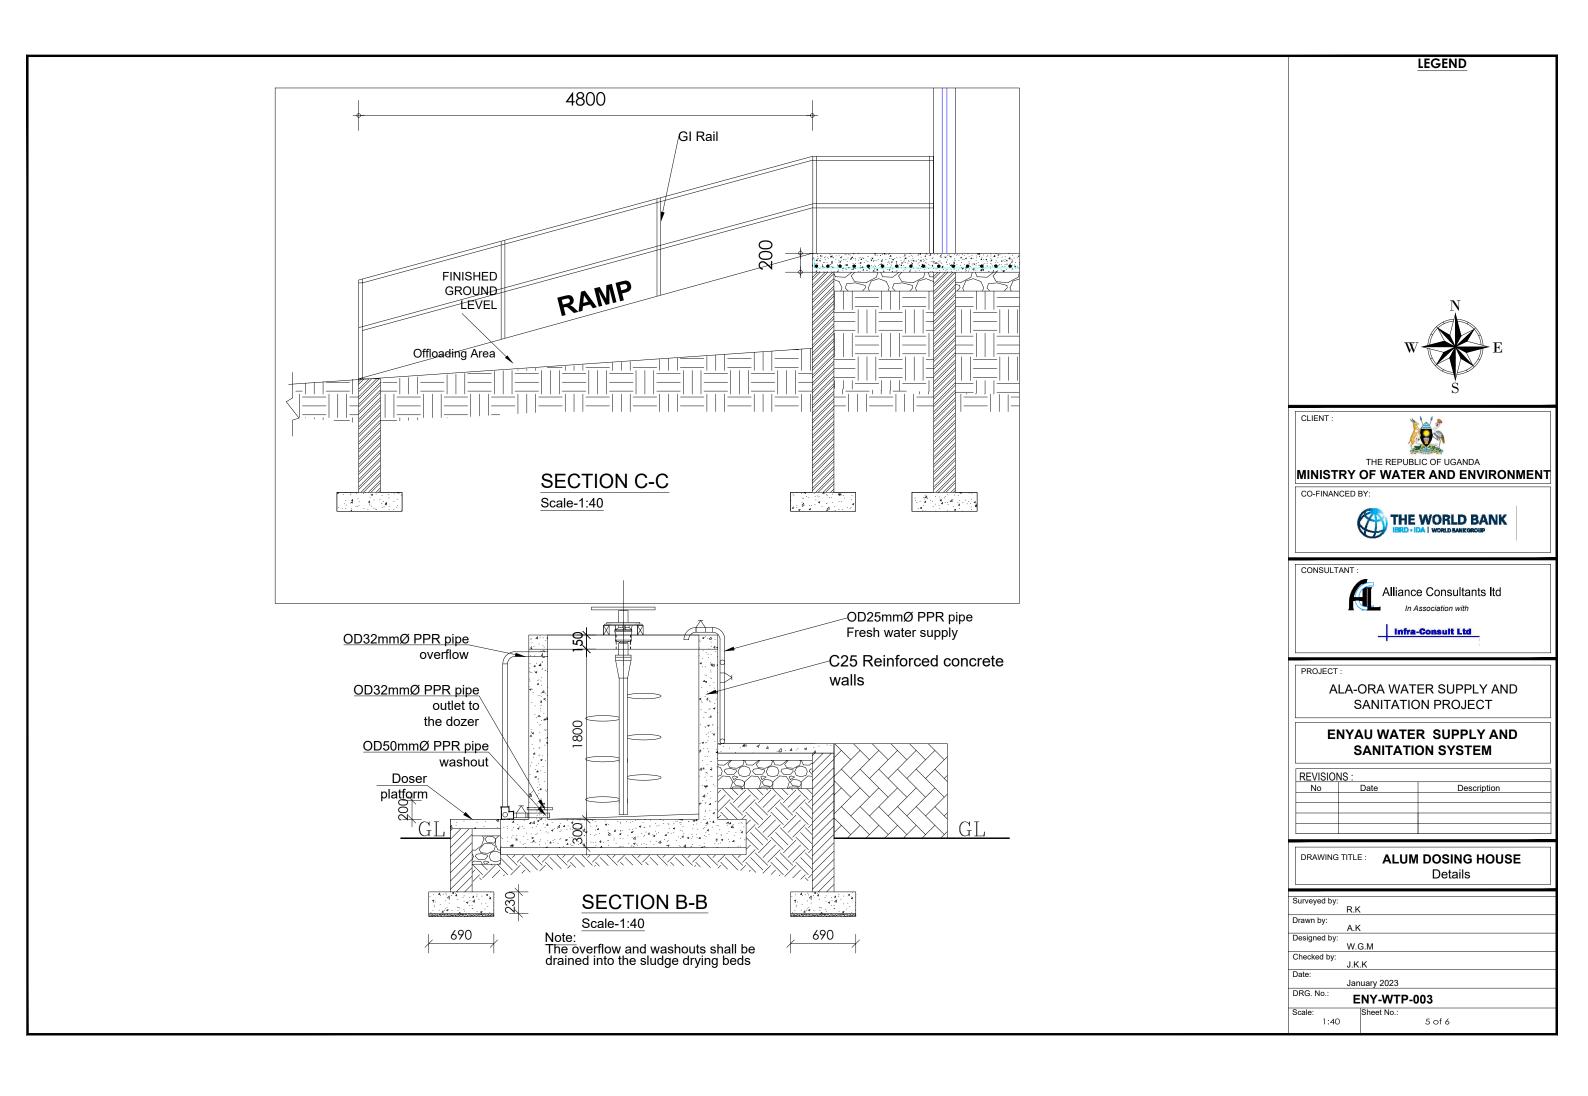

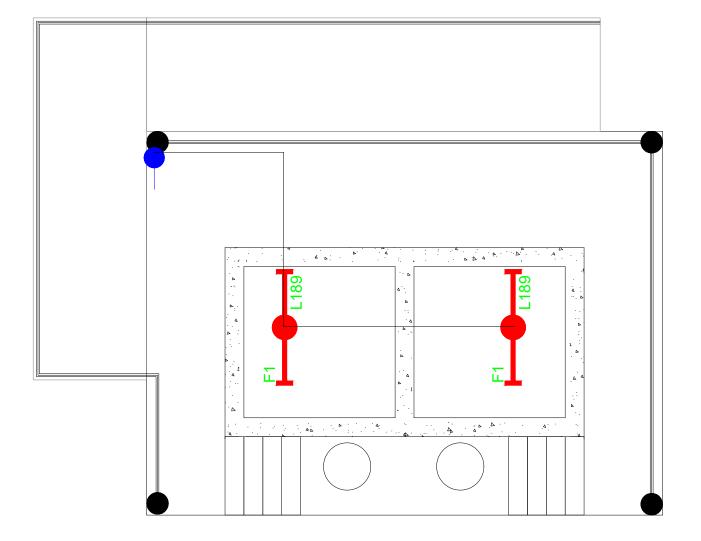

SYMBOL	DESCRIPTION
F1 L189	1200mm 18W LED batten with a removable LED engine. IP20 As Thorn PopPack LED. or equal approved. (Light Type F1)
o ∟	Pedant lighting fitting comprising ceiling Rose 300mm 3x1.5mm flexible copper cable lamp holder and 6W LED Lamp
	Pedant lighting fitting comprising ceiling Rose 300mm 3x1.5mm ² flexible copper cable lamp holder and 6WLED Lamp Pedant lighting fitting comprising ceiling Rose 300mm 3x1.5mm ² flexible copper cable lamp holder and 6W LED Lamp
K	wall mounted light
s ?	Socket outlet on Wall
CU	Consumer's Unit
	One Gang 1way Switch
6	Two Gang 1way Switch
	Three Gang 1way Switch







THE REPUBLIC OF UGANDA
MINISTRY OF WATER AND ENVIRONMENT

CO-FINANCED BY:



CONSULTANT :



Alliance Consultants Itd

Infra-Consult Ltd

PRO IECT


ALA-ORA WATER SUPPLY AND SANITATION PROJECT


ENYAU WATER SUPPLY AND SANITATION SYSTEM


REVISIONS:		
No	Date	Description


DRAWING TITLE: ALUM DOSING HOUSE Electrical Layout


Surveyed by:		
	Drawn by:	P.K
	Designed by:	P.K
	Checked by:	S.C.D
	Date:	January 2023
DRG. No.: ENY-WTP-003		ENY-WTP-003
	Scale: 1:40	Sheet No.: 6 of 6

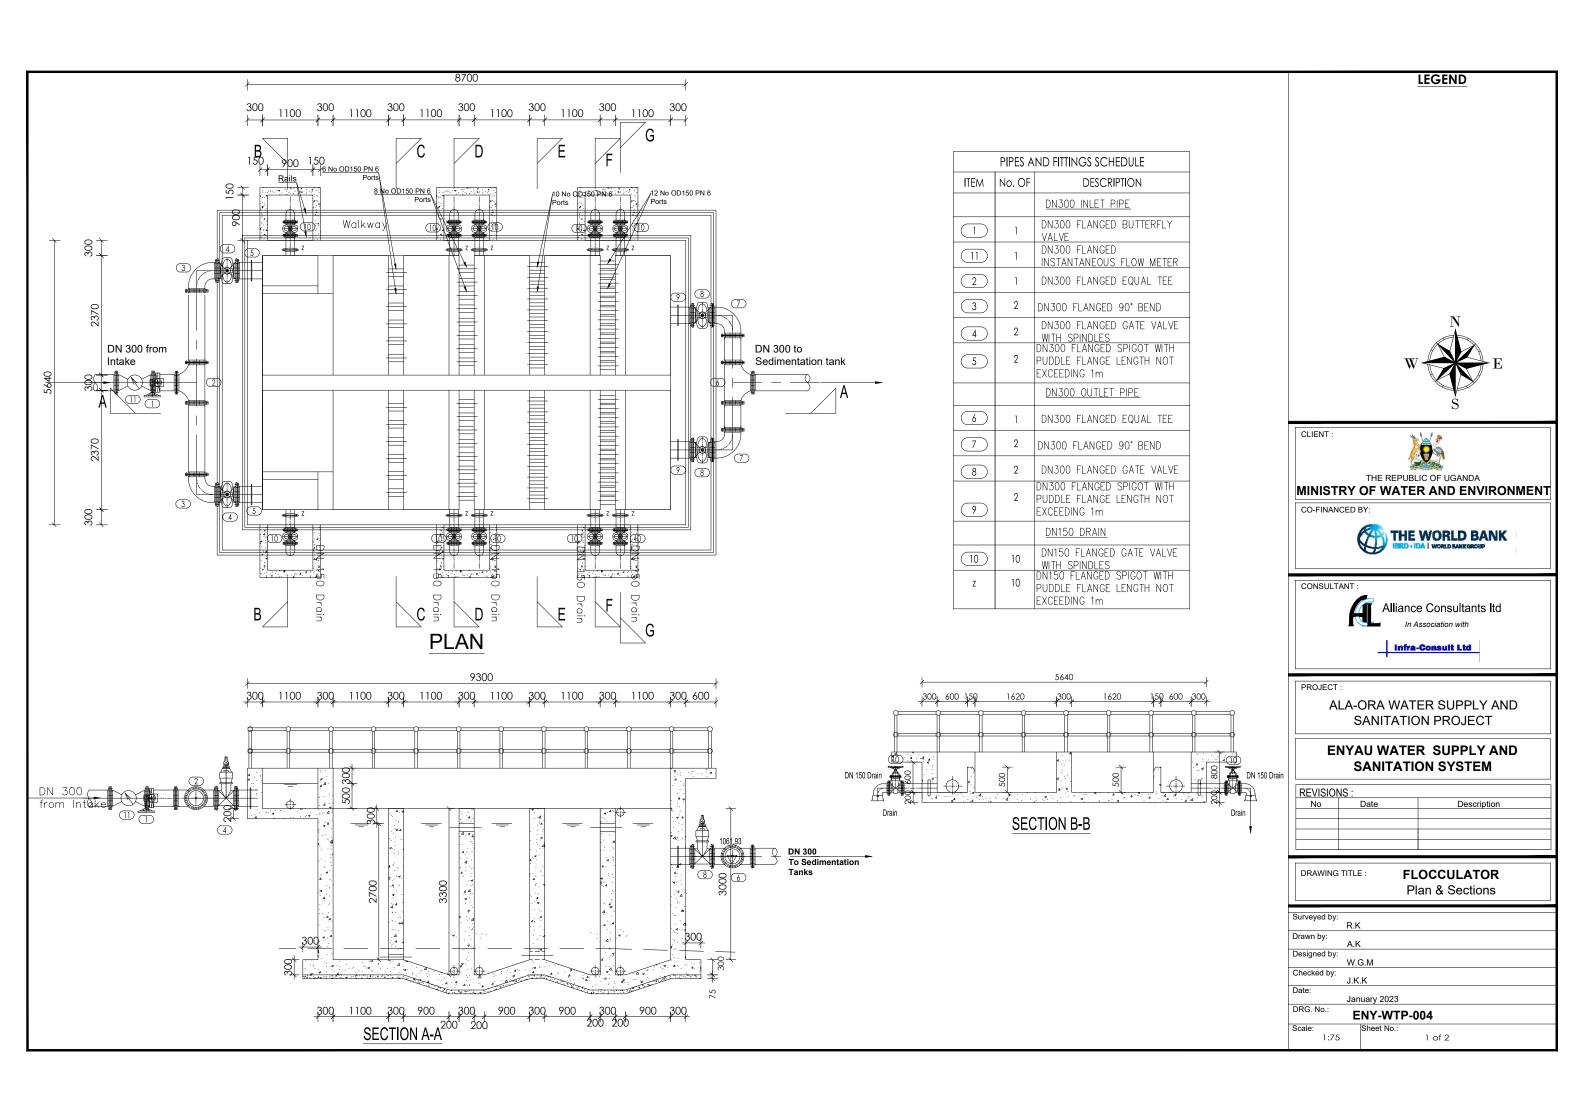


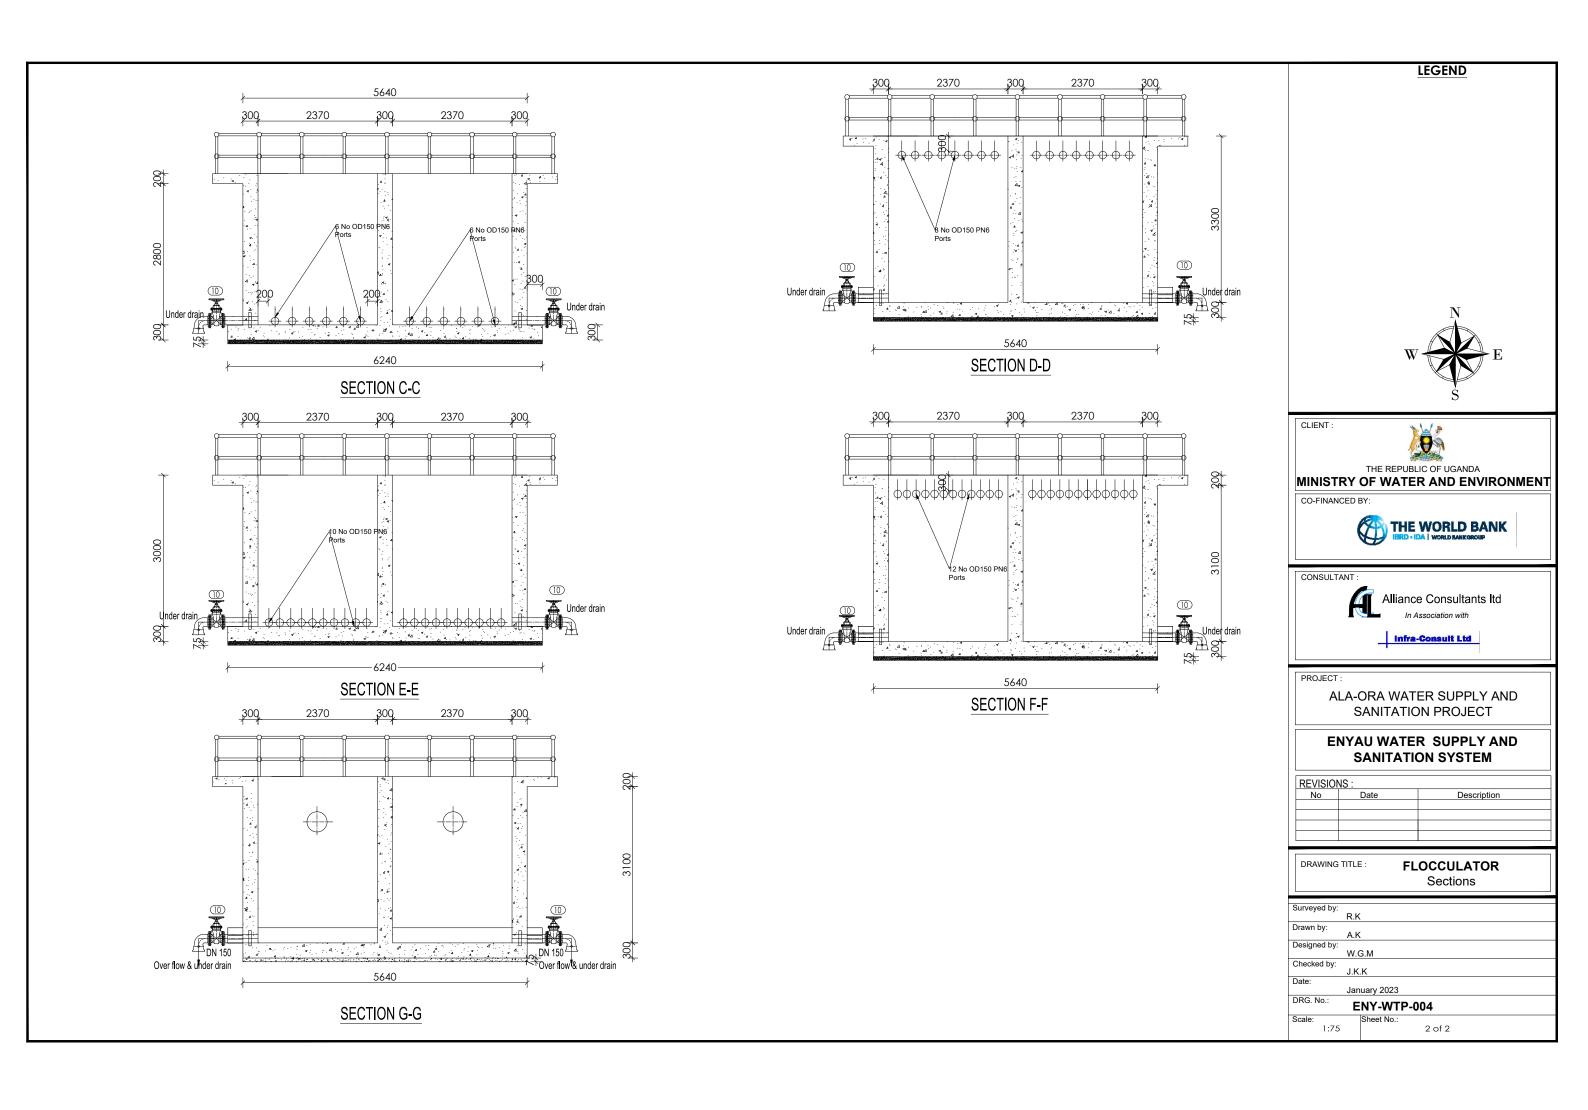


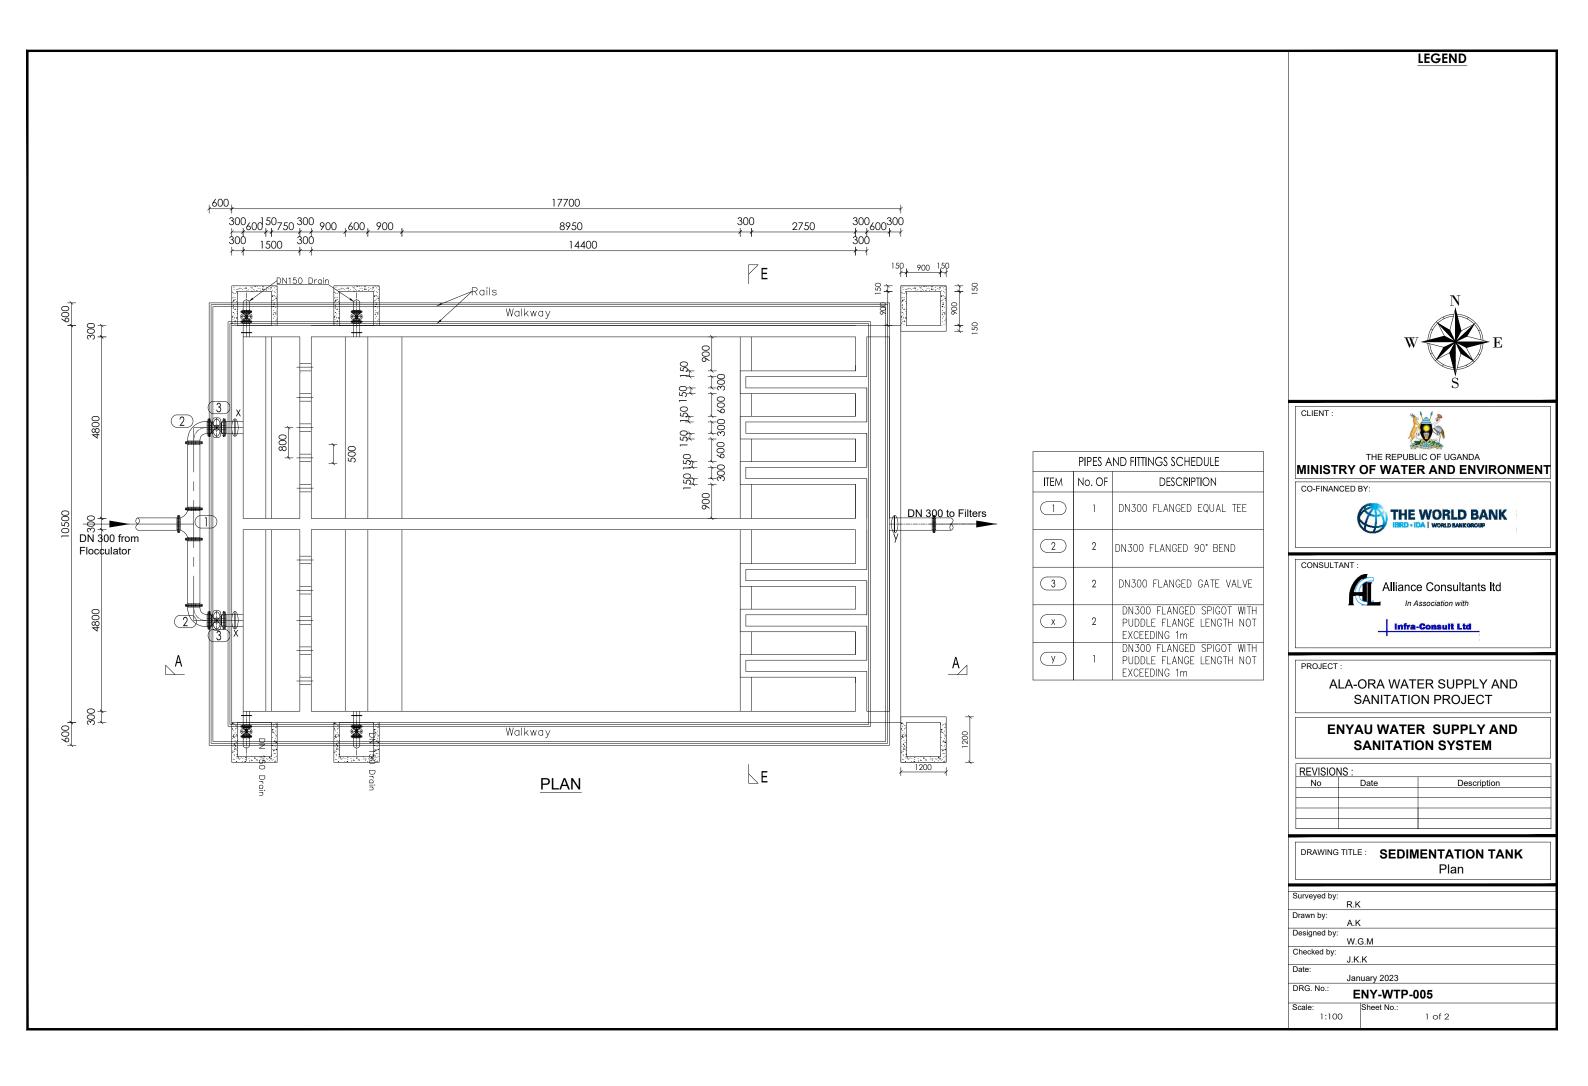

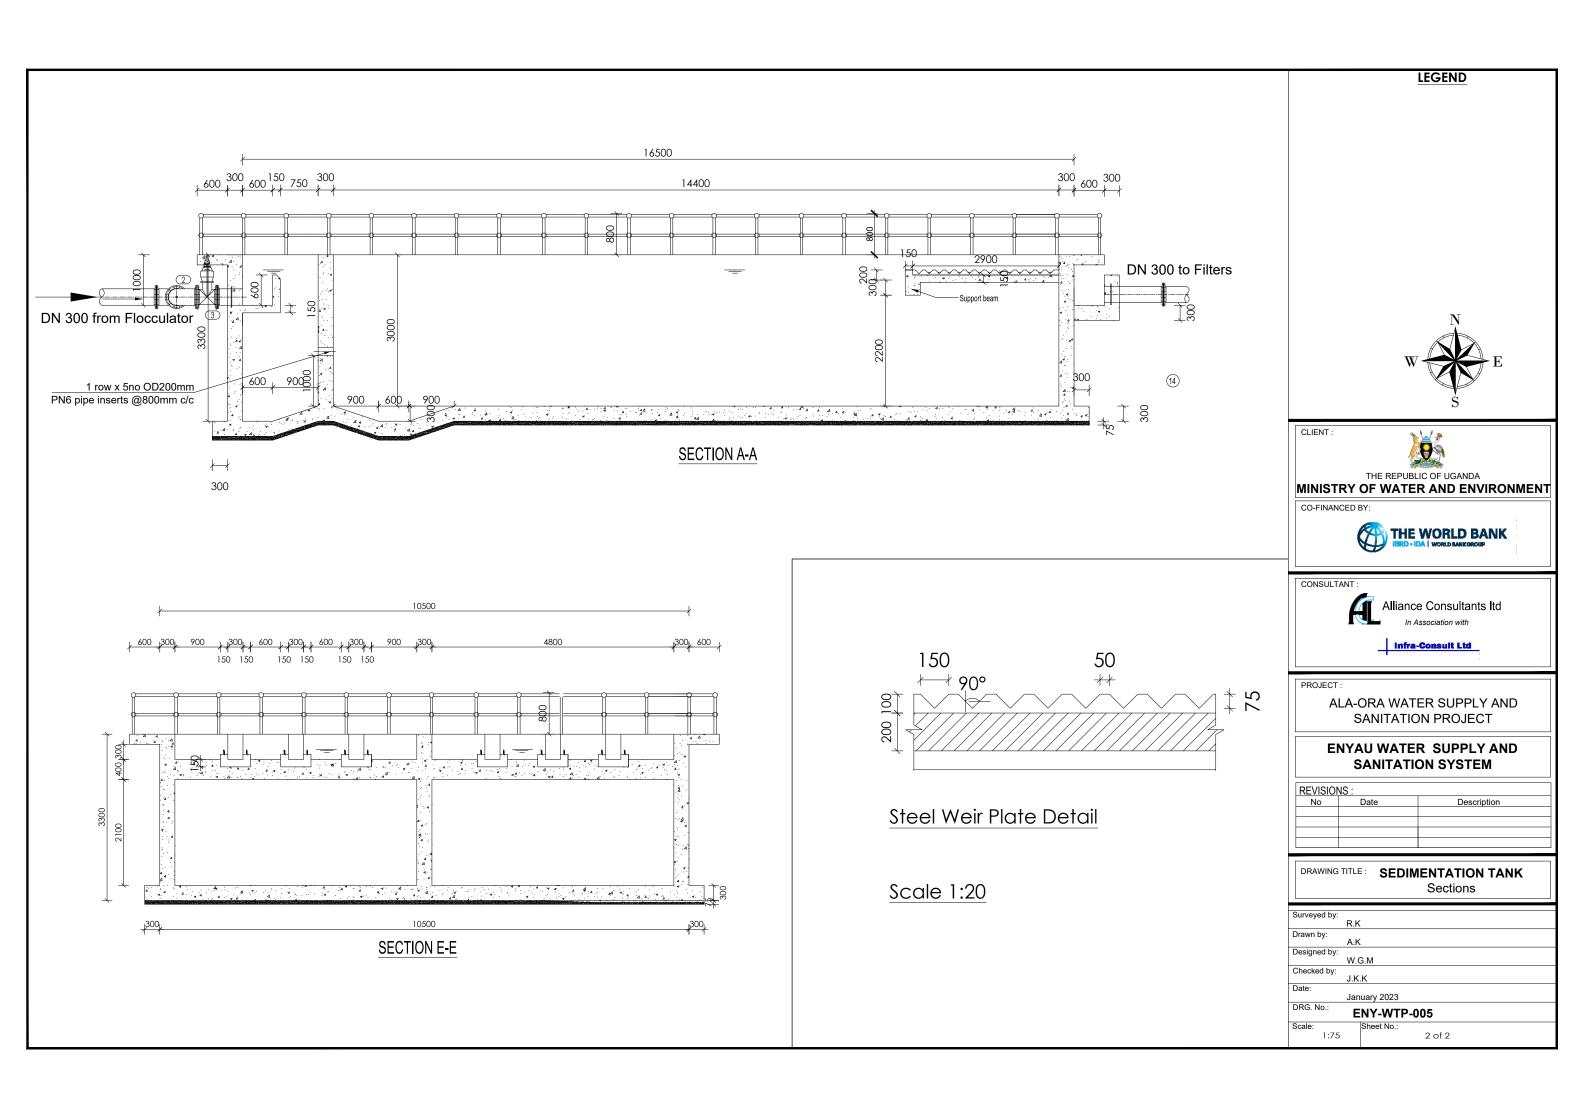

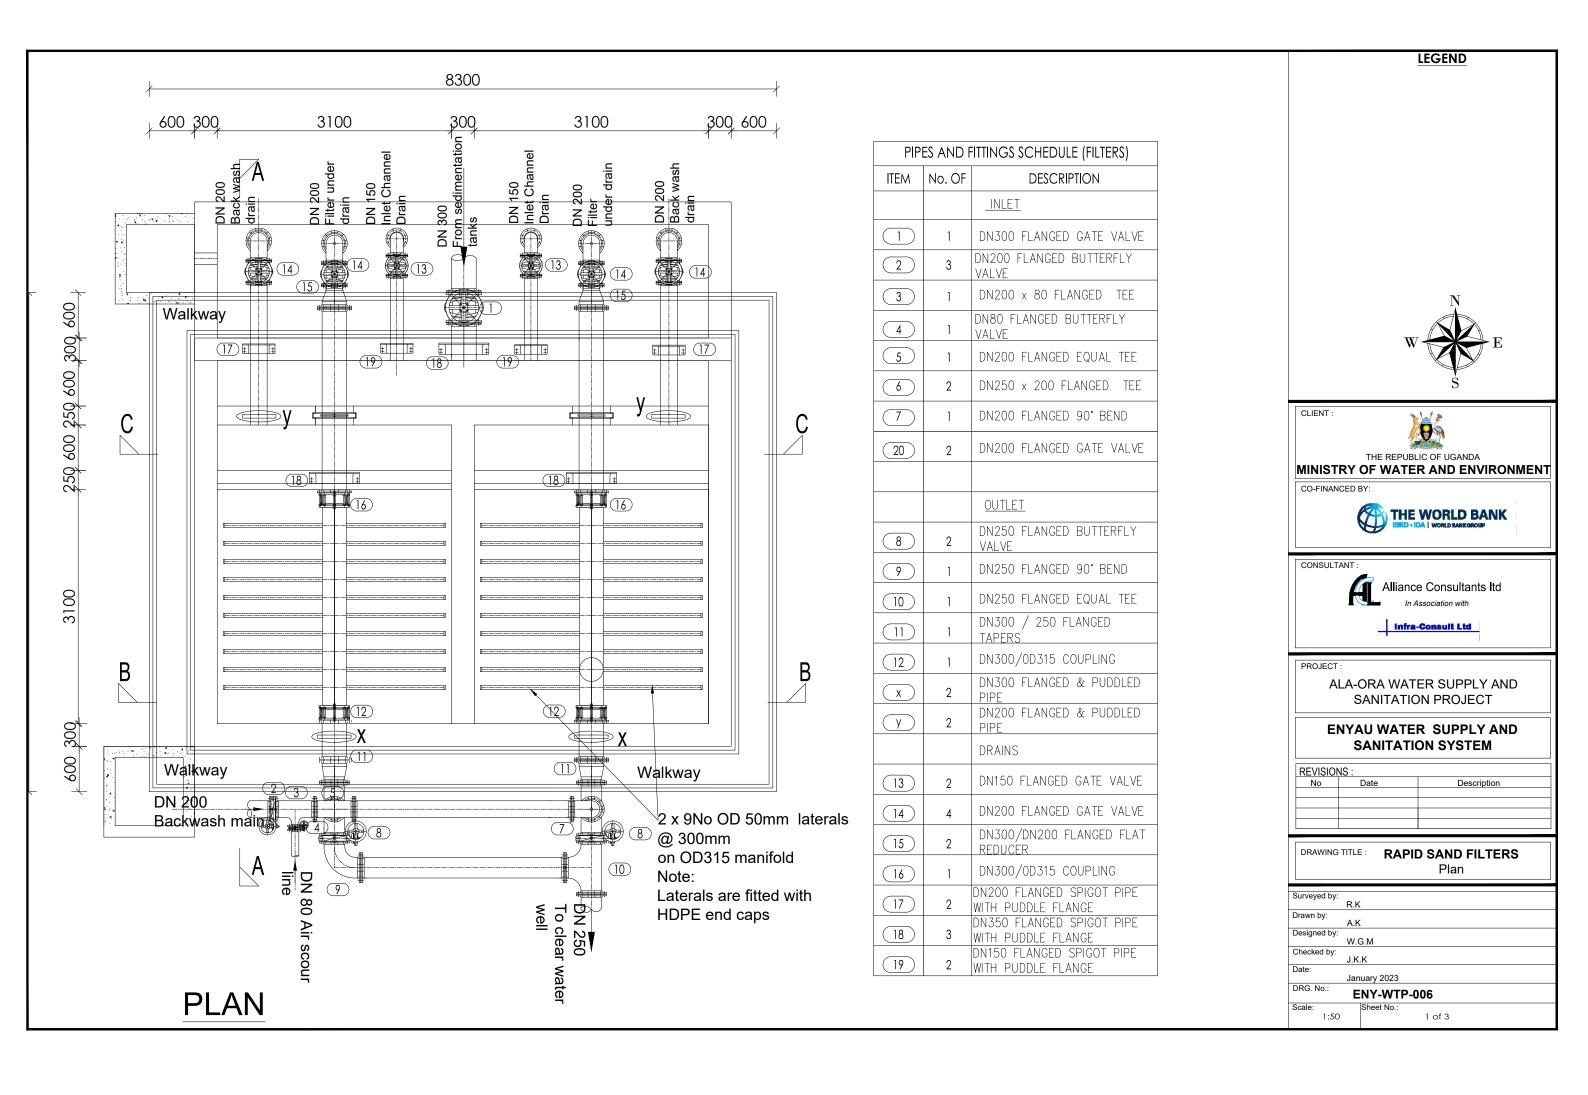

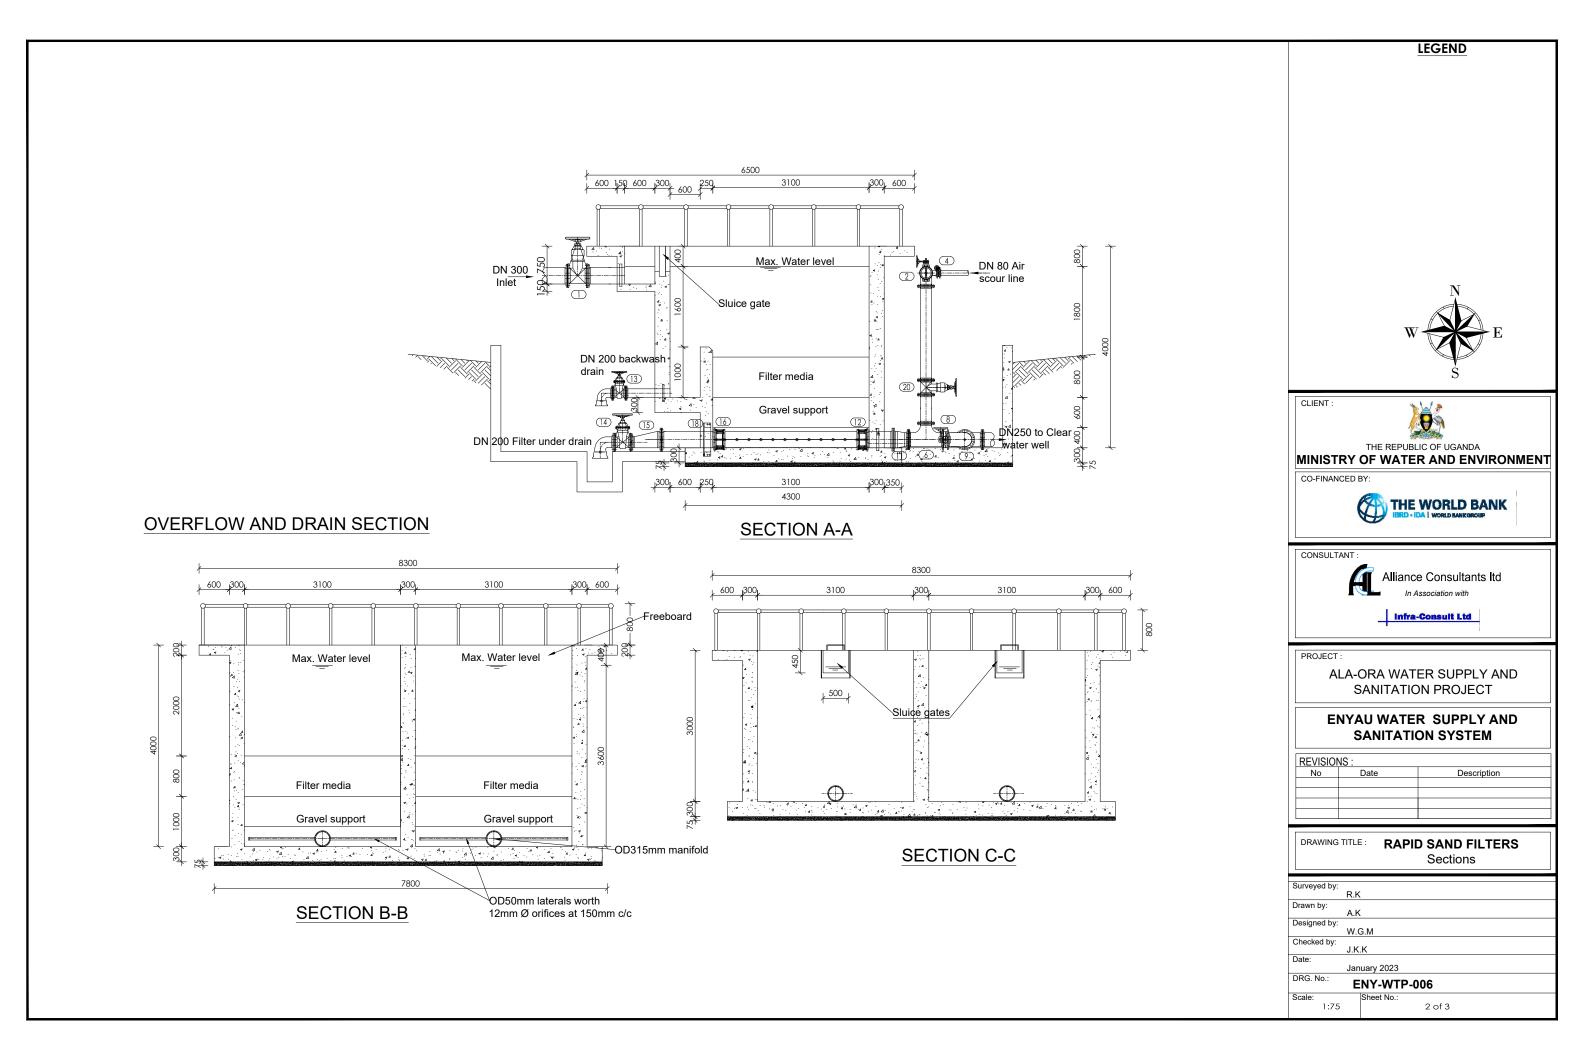

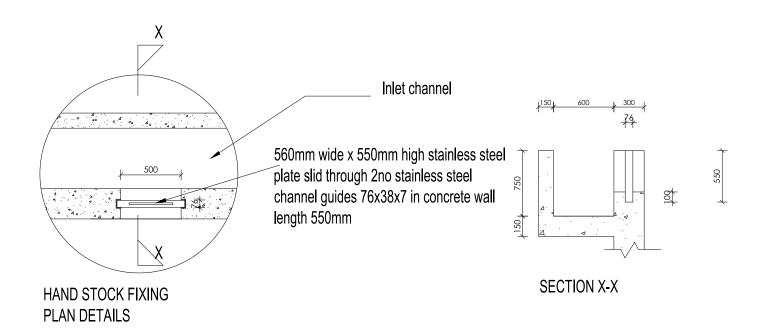

DETAIL a

LAYER	DEPTH mm	Coefficient of Uniformity	EFFECTIVE SIZE mm
TOP	200	2.5	3.0
MIDDLE	200	2.5	10.0
воттом	200	2.5	25.0

FILTER MEDIA SUPPORT BED










ALA-ORA WATER SUPPLY AND
SANITATION PROJECT


ENYAU WATER SUPPLY AND SANITATION SYSTEM


REVISIONS:		
No	Date	Description
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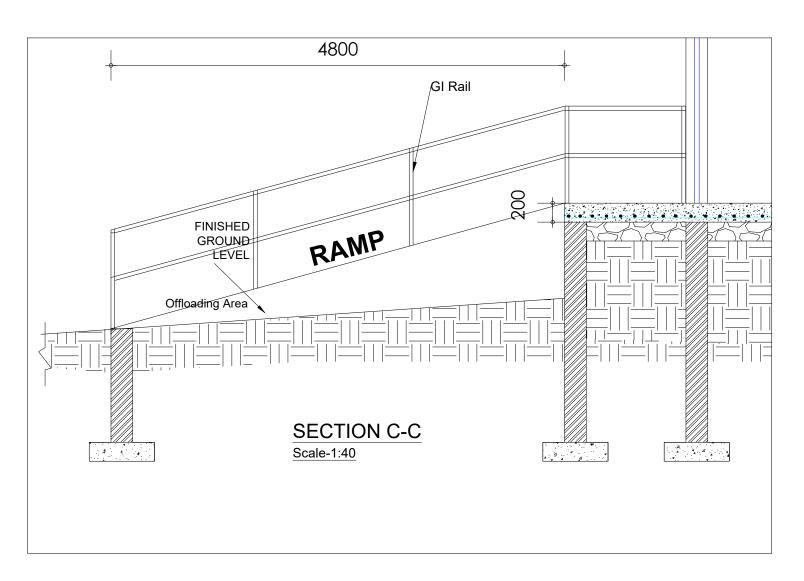
DRAWING TITLE: RAPID SAND FILTERS
Details


Surveyed by:	
	R.K
Drawn by:	
,	A.K
Designed by:	
	W.G.M
Checked by:	
,	J.K.K
Date:	
	January 2023
DRG. No.:	ENV/14/ED 000
ENY-WTP-006	
Scale:	Sheet No.:
1:75	3 of 3



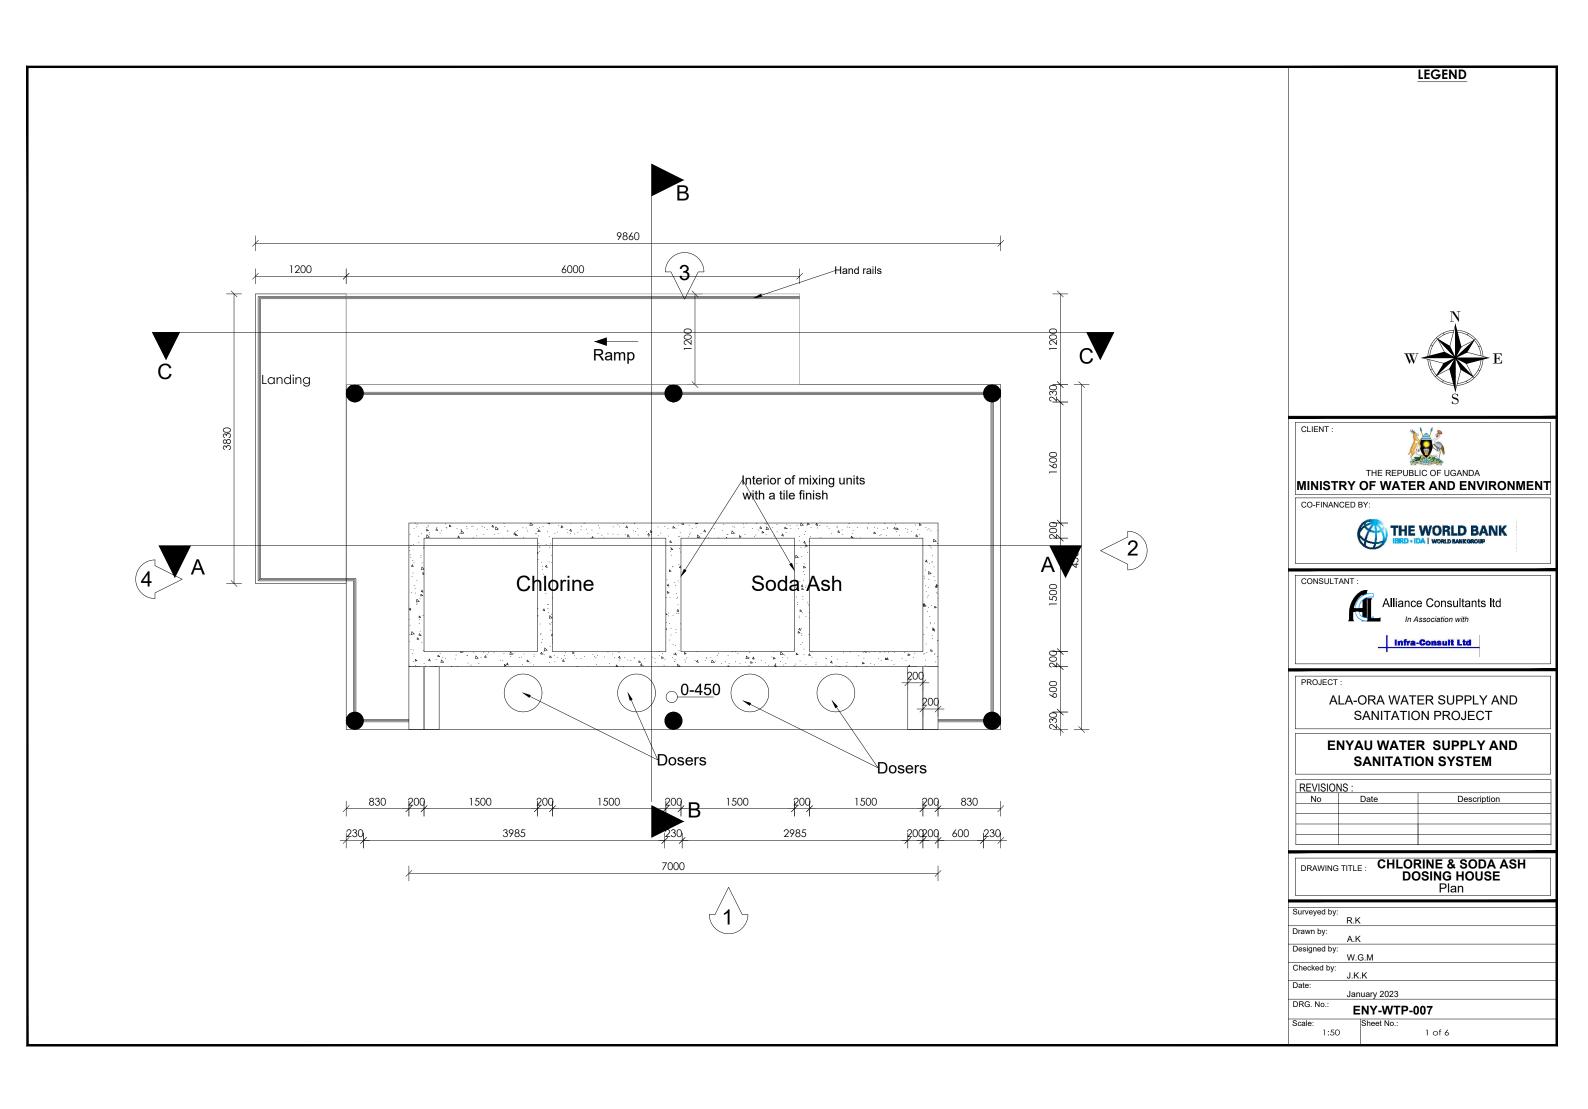

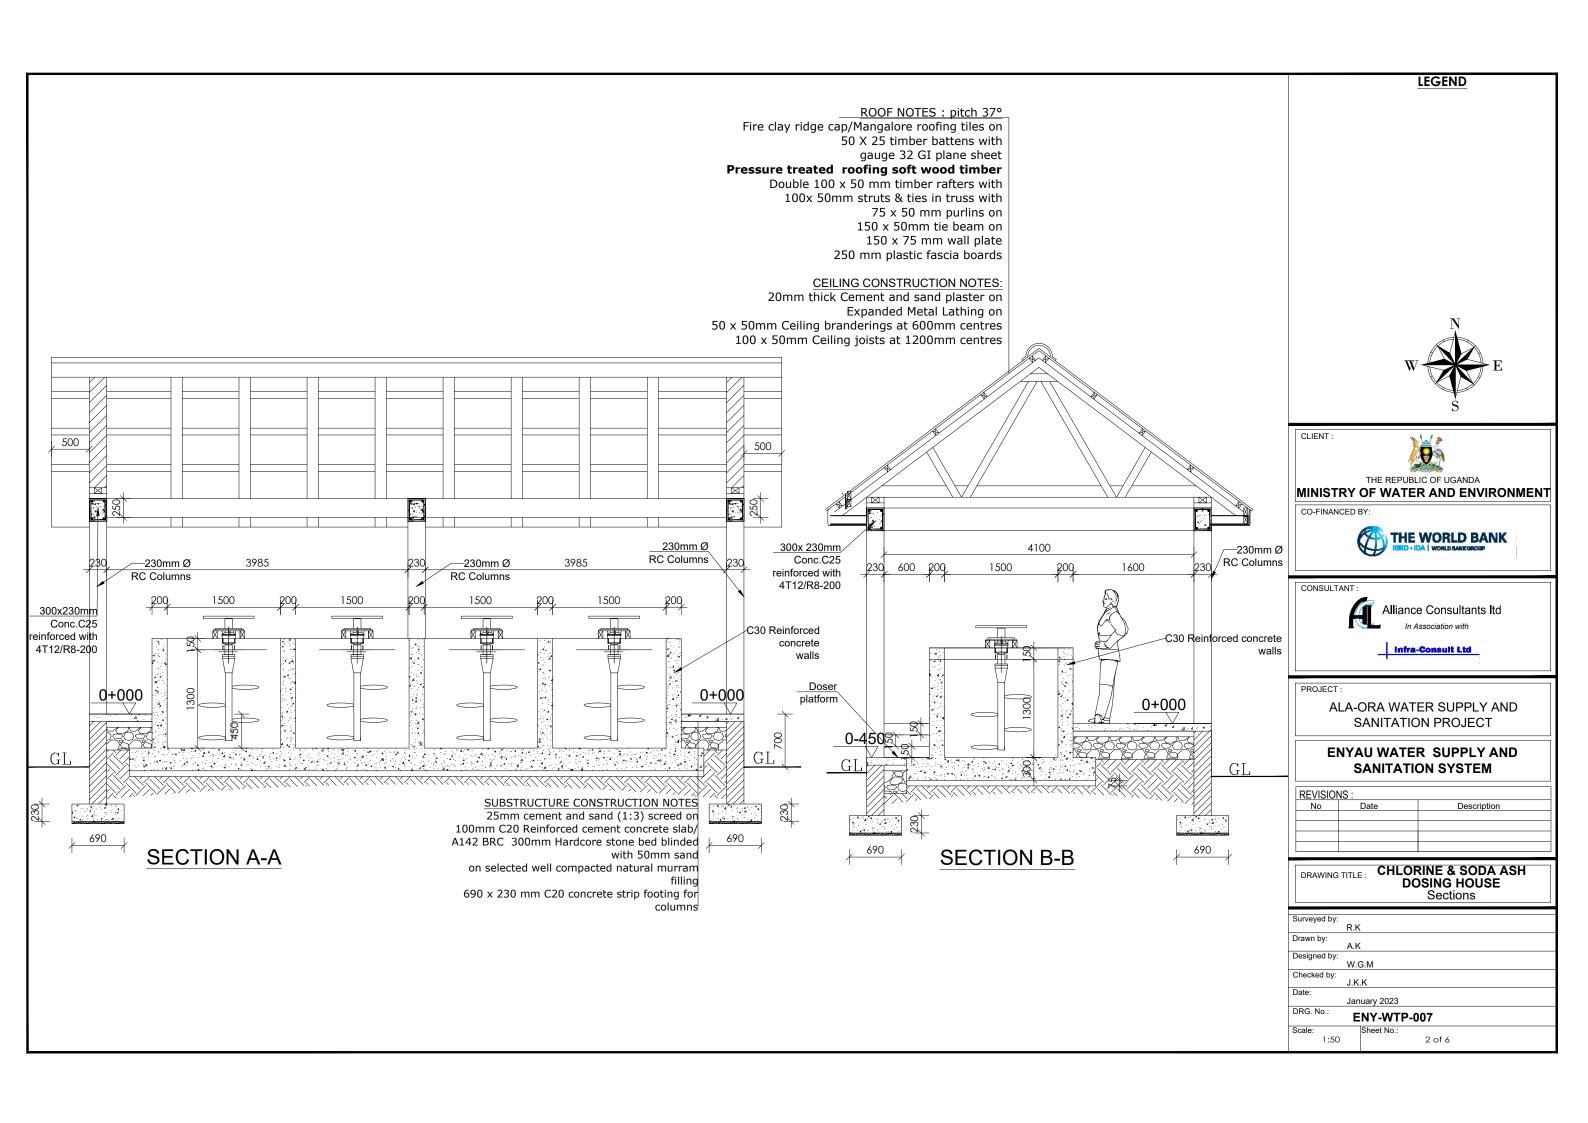

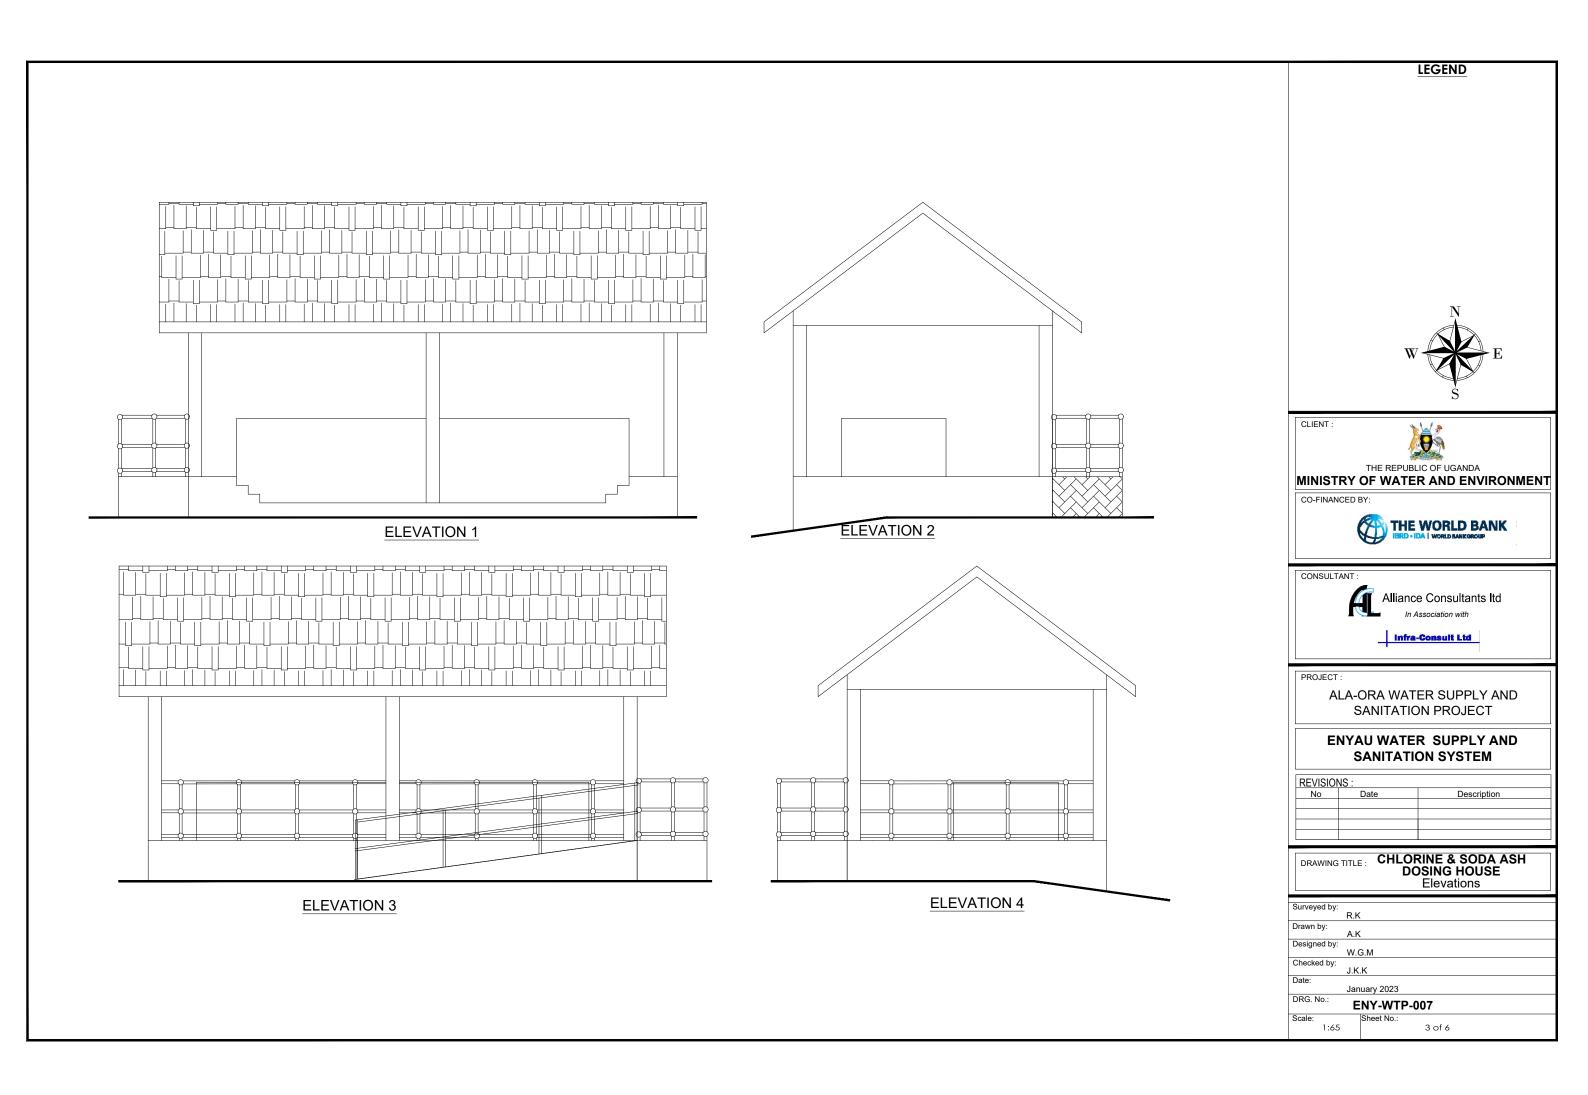

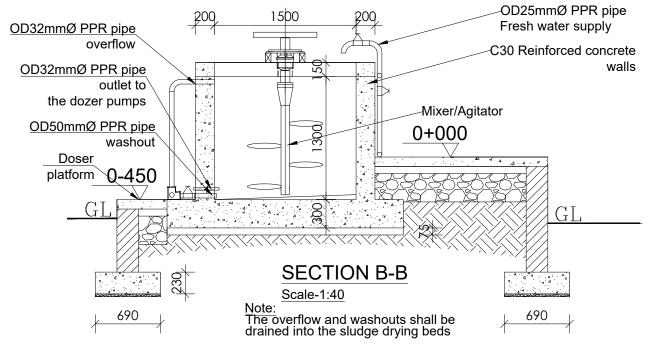







THE REPUBLIC OF UGANDA
MINISTRY OF WATER AND ENVIRONMENT

CO-FINANCED BY:



CONSULTANT :



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Infra-Consult Ltd

PROJECT:


ALA-ORA WATER SUPPLY AND SANITATION PROJECT


ENYAU WATER SUPPLY AND SANITATION SYSTEM

REVISIO	REVISIONS:				
No	Date	Description			

DRAWING TITLE: CHLORINE & SODA ASH DOSING HOUSE Details

Surveyed by:	
	R.K
Drawn by:	
,	A.K
Designed by:	
-	W.G.M
Checked by:	
•	J.K.K
Date:	
	January 2023
DRG. No.:	ENV WED OOF
	ENY-WTP-007
Scale:	Sheet No.:
1:40	4 of 6

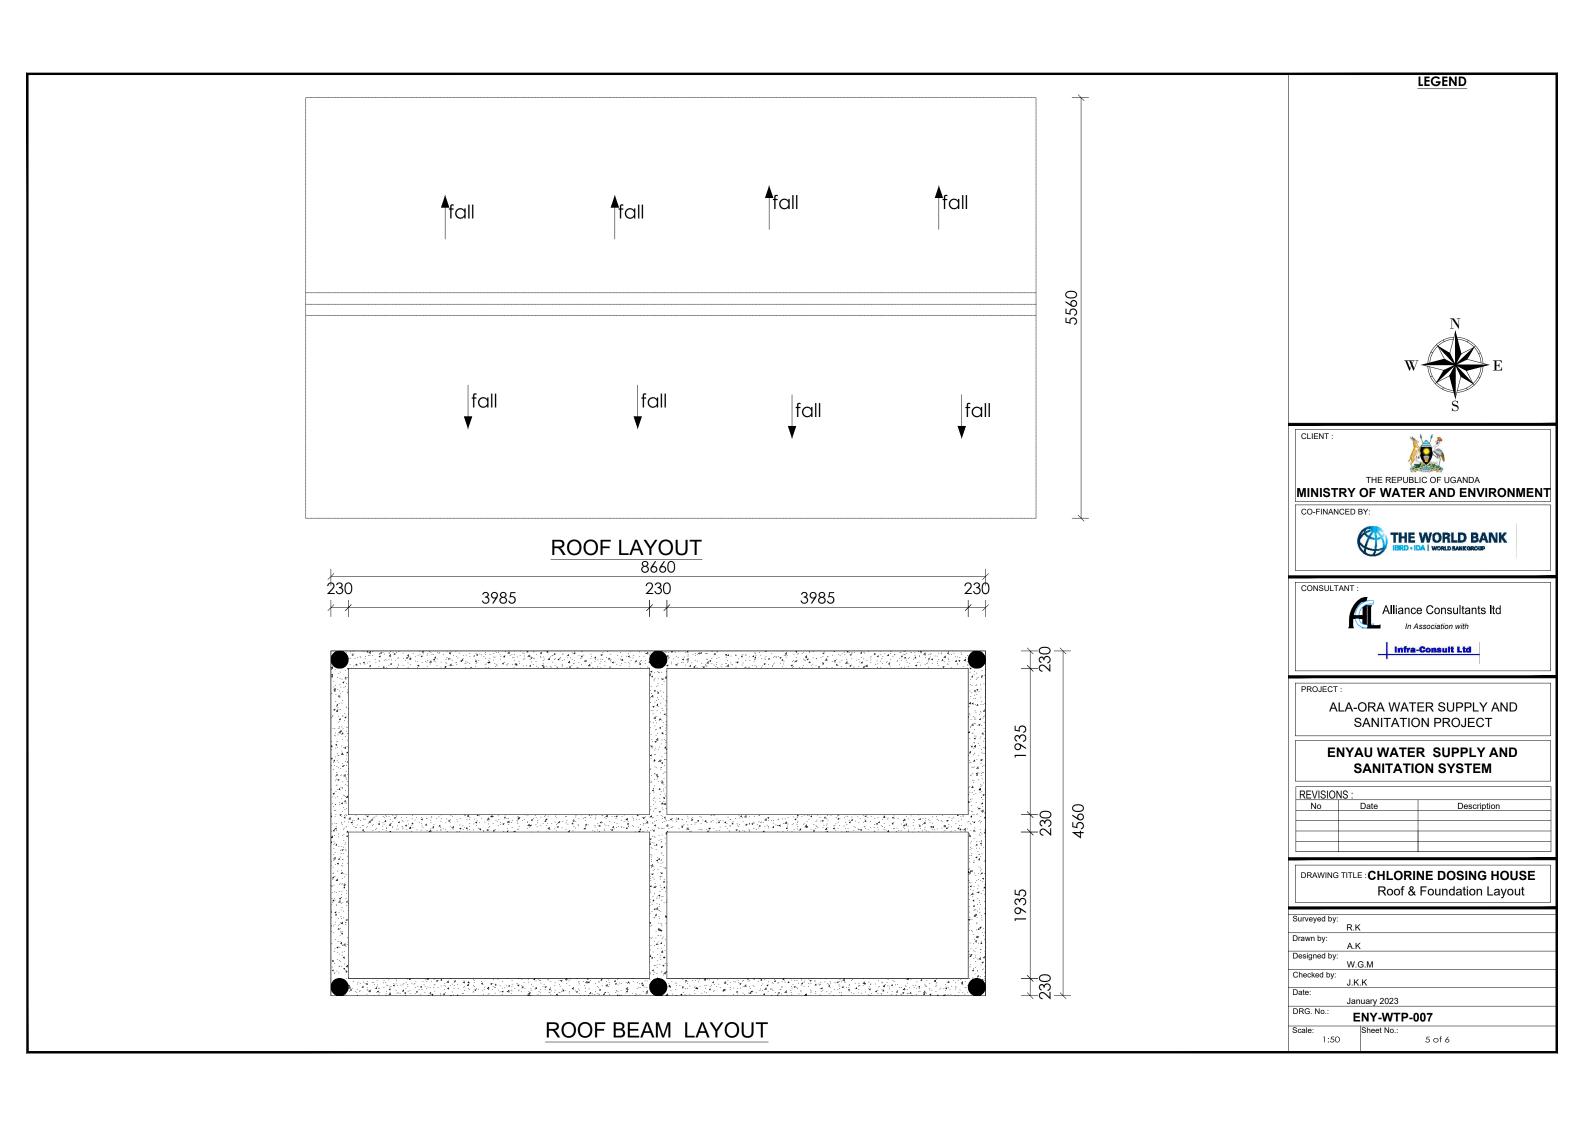

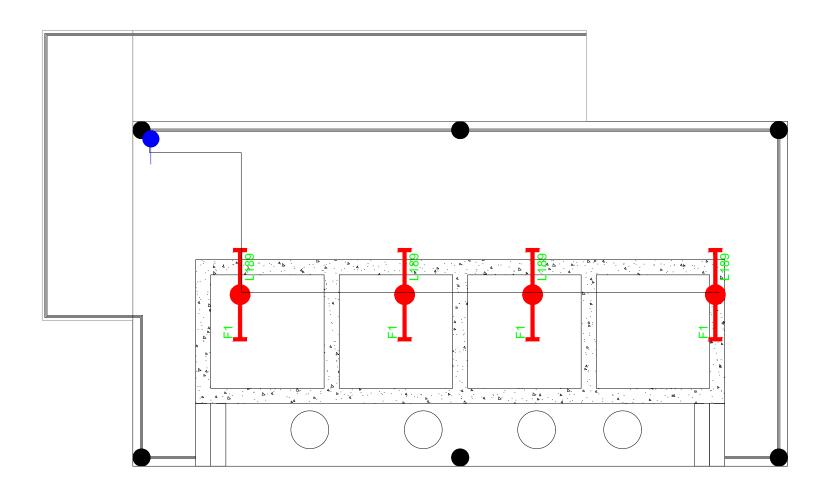

SYMBOL	DESCRIPTION
F1 L189	1200mm 18W LED batten with a removable LED engine. IP20 As Thorn PopPack LED. or equal approved. (Light Type F1)
O ^L	Pedant lighting fitting comprising ceiling Rose 300mm 3x1.5mm ² flexible copper cable lamp holder and 6W LED Lamp
	Pedant lighting fitting comprising ceiling Rose 300mm 3x1.5mm ² flexible copper cable lamp holder and 6WLED Lamp
B	Pedant lighting fitting comprising ceiling Rose 300mm 3x1.5mm ² flexible copper cable lamp holder and 6W LED Lamp
K	wall mounted light
s W	Socket outlet on Wall
CU	Consumer's Unit
•	One Gang Iway Switch
66	Two Gang 1way Switch
•••	Three Gang 1way Switch







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MINISTRY OF WATER AND ENVIRONMENT

CO-FINANCED BY:



CONSULTANT :



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PROJEC


ALA-ORA WATER SUPPLY AND SANITATION PROJECT


ENYAU WATER SUPPLY AND SANITATION SYSTEM


REVISIO	REVISIONS:				
No	Date	Description			


DRAWING TITLE: CHLORINE DOSING HOUSE Electrical Layout

Surveyed by:	
Drawn by:	P.K
Designed by:	P.K
Checked by:	S.C.D
Date:	January 2023
DRG. No.:	ENY-WTP-007
Scale: 1:50	Sheet No.: 6 of 6

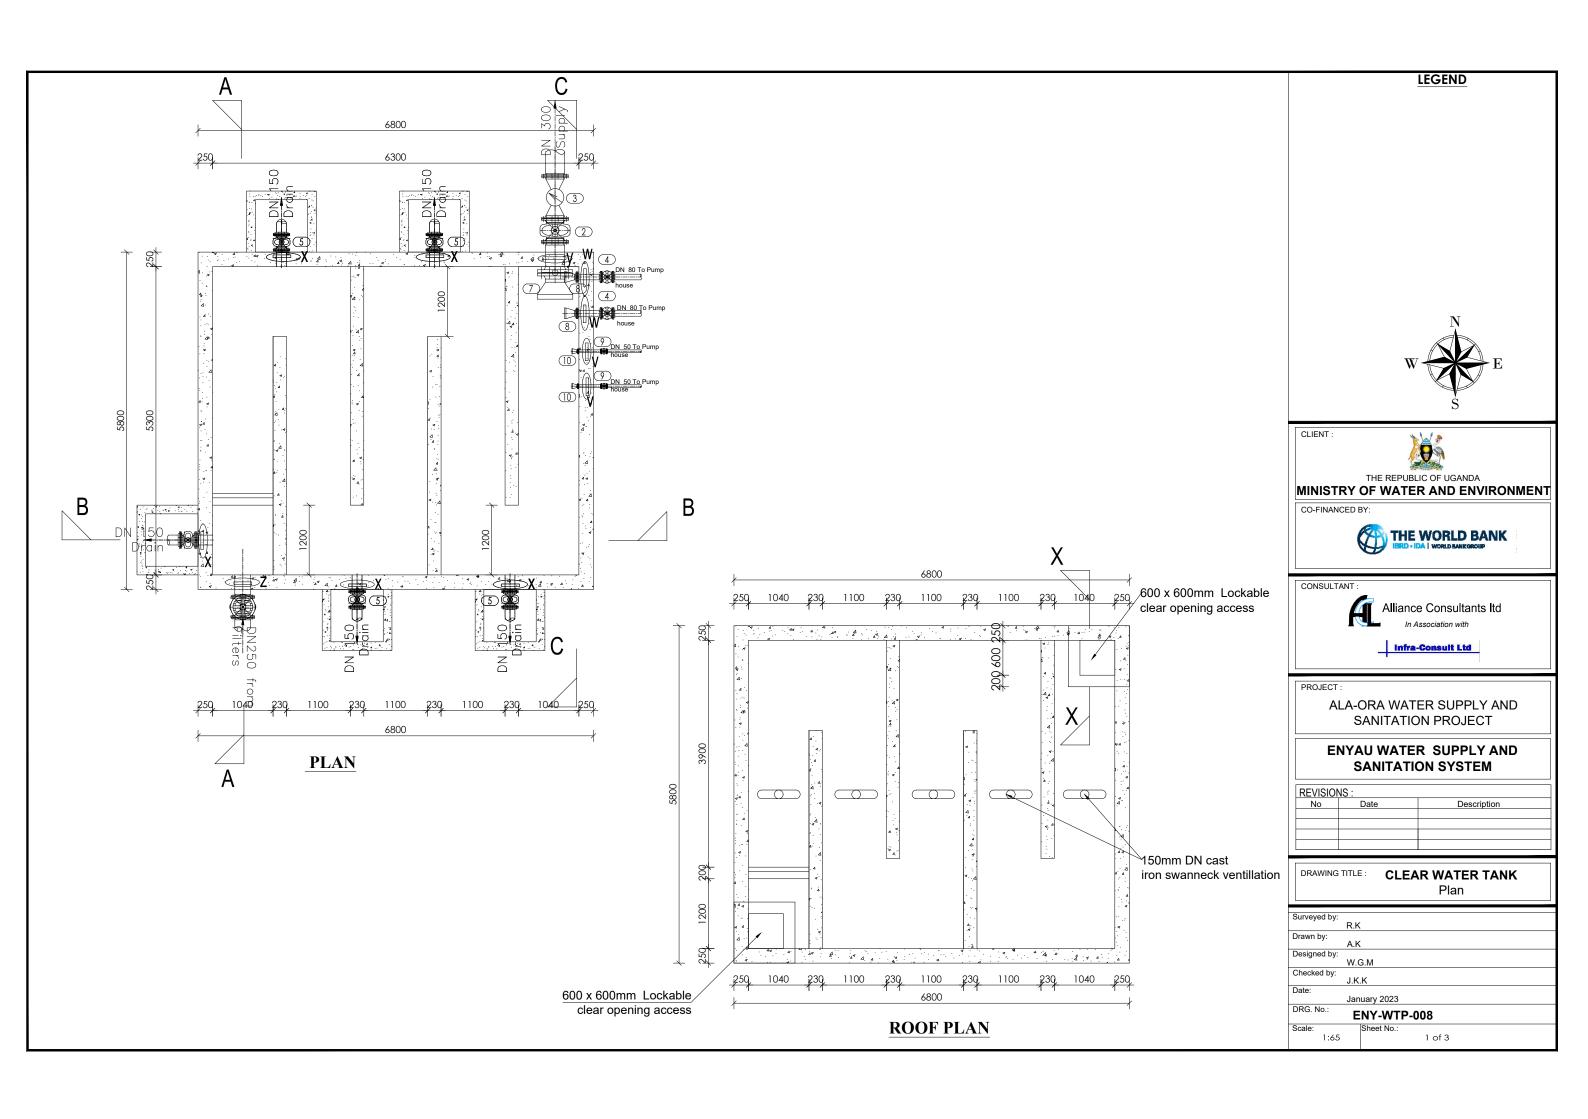

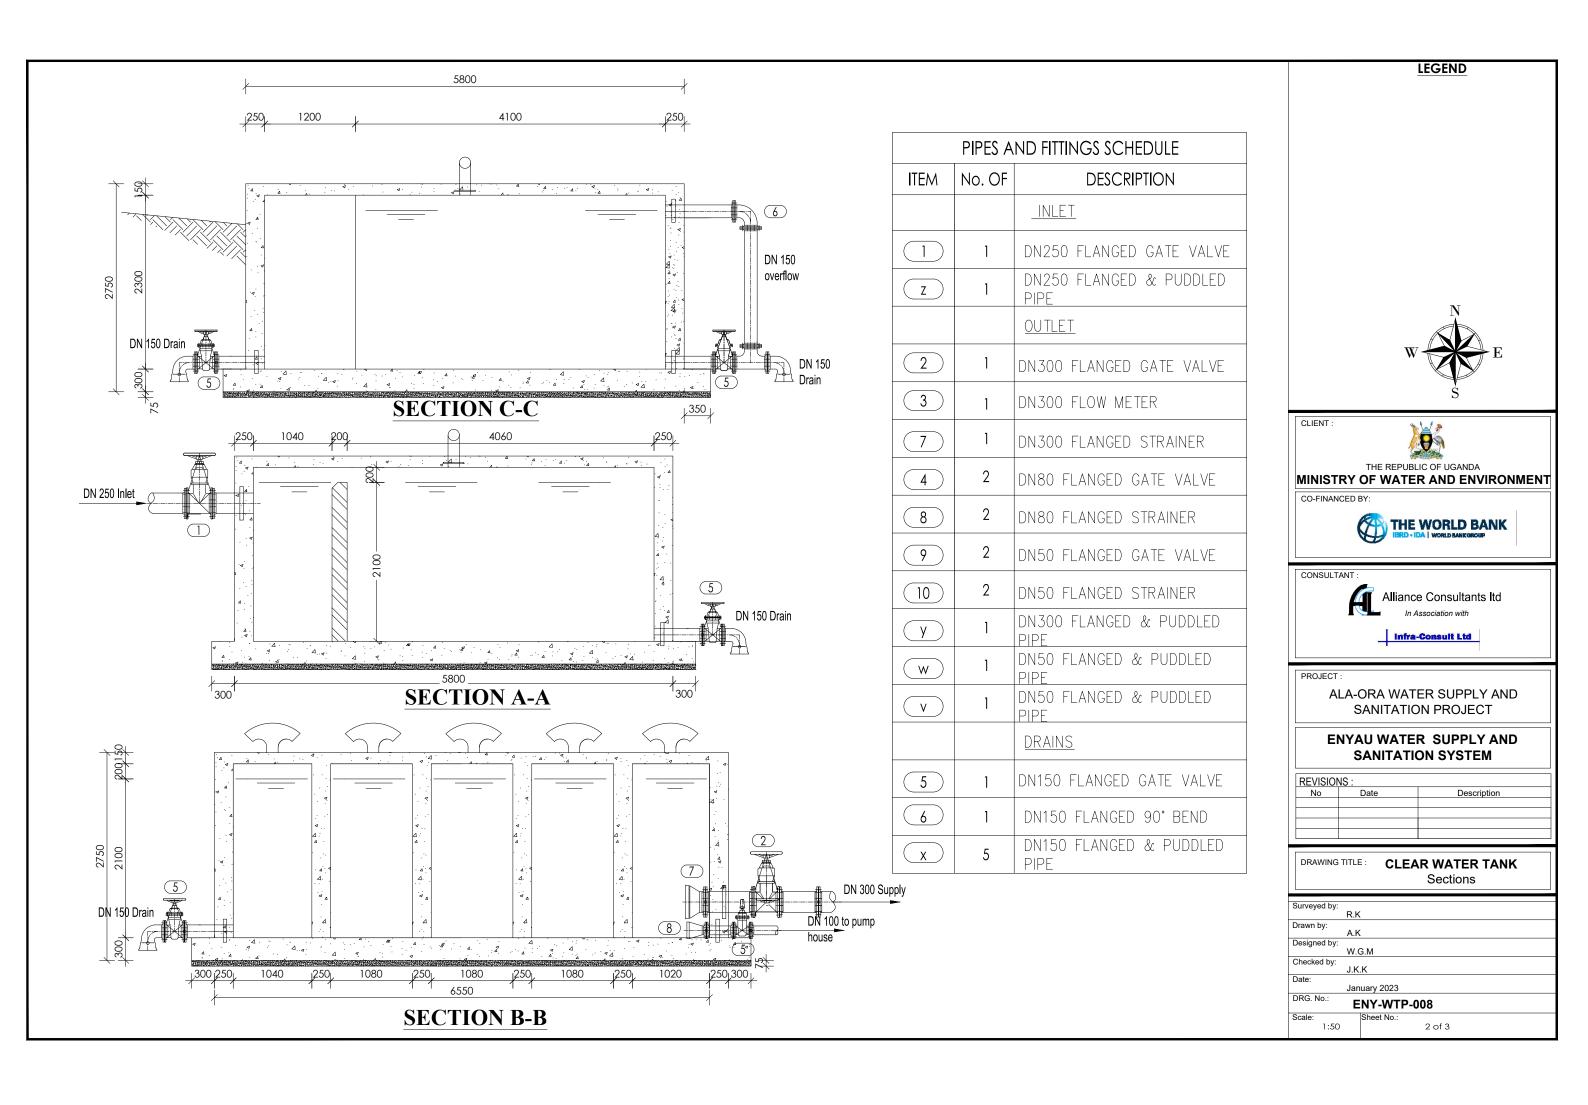

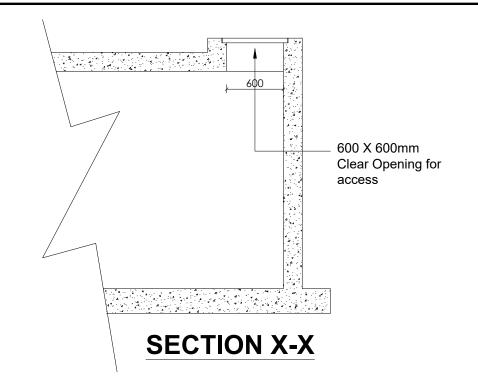

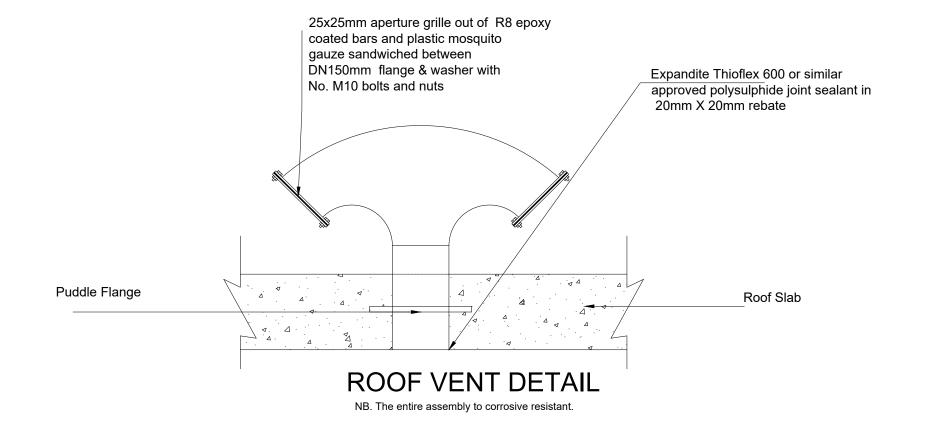

LEGEND



CLIENT :



THE REPUBLIC OF UGANDA
MINISTRY OF WATER AND ENVIRONMENT

CO-FINANCED BY:



CONSULTANT :



Alliance Consultants Itd

In Association with

Infra-Consult Ltd

PROJECT


ALA-ORA WATER SUPPLY AND SANITATION PROJECT


ENYAU WATER SUPPLY AND SANITATION SYSTEM


REVISIONS:		
No	Date	Description
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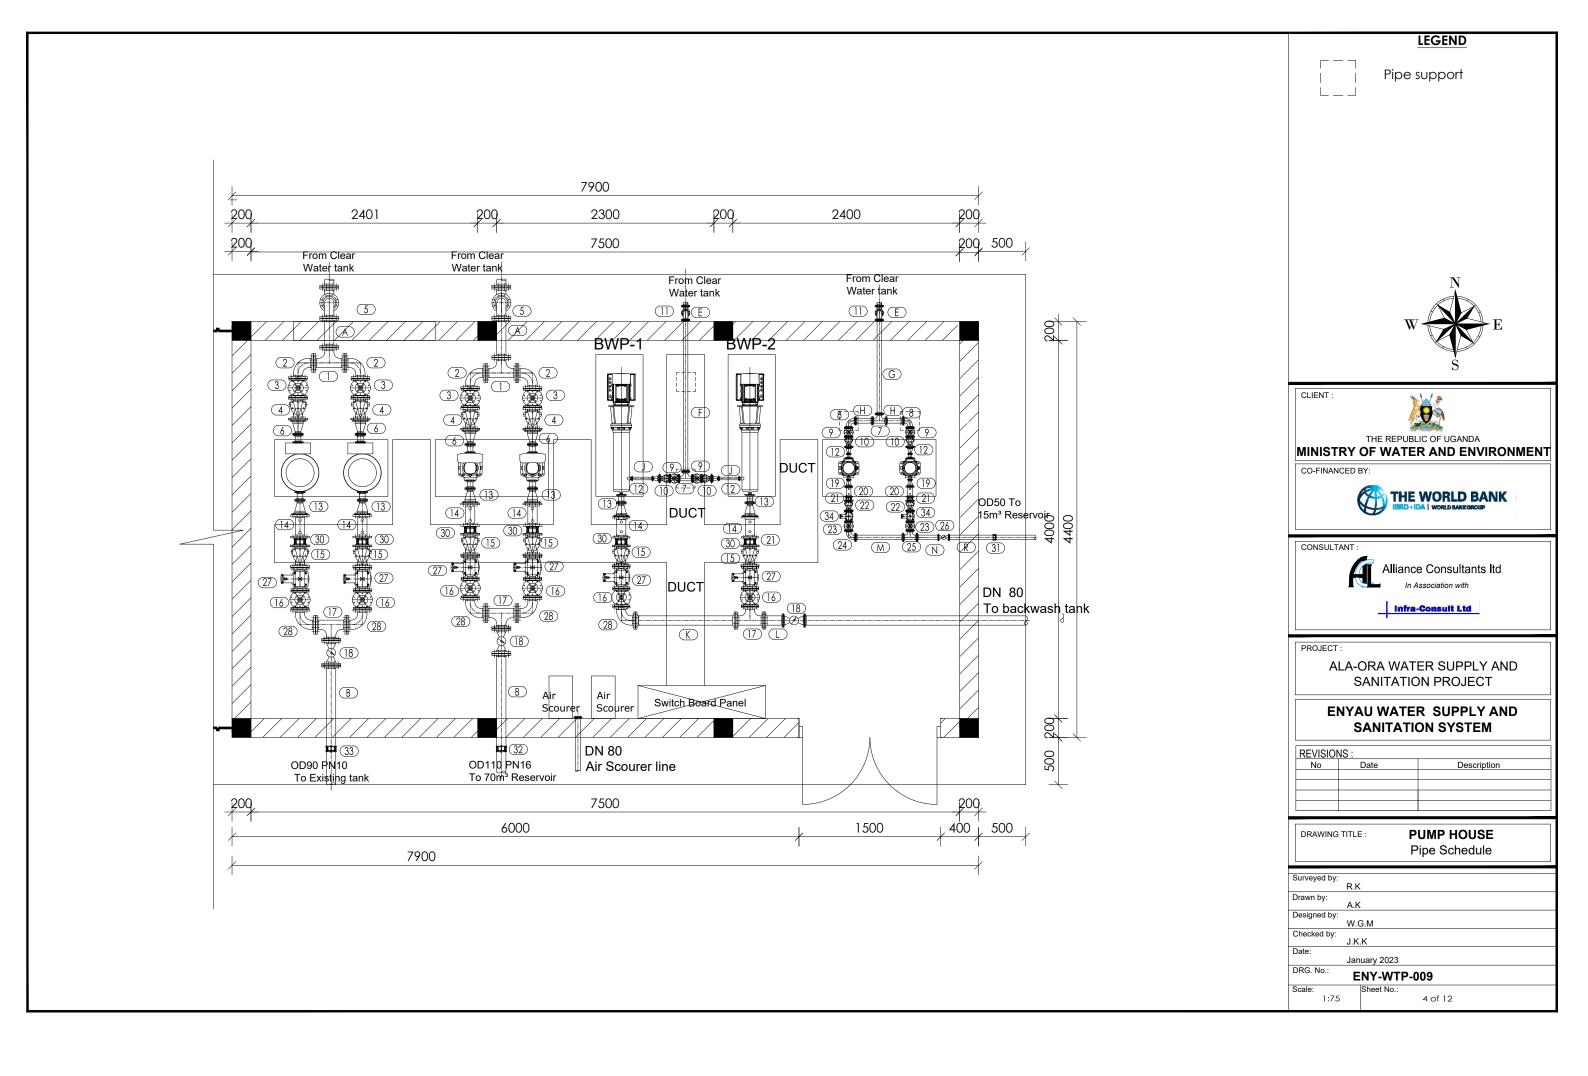
DRAWING TITLE: CLEAR WATER TANK
Details

Surveyed by:
R.K
Drawn by:
A.K
Designed by:
W.G.M
Checked by:
J.K.K
Date:
January 2023
DRG. No.:
ENY-WTP-008
Scale:
N.T.S
Sheet No.:
3 of 3



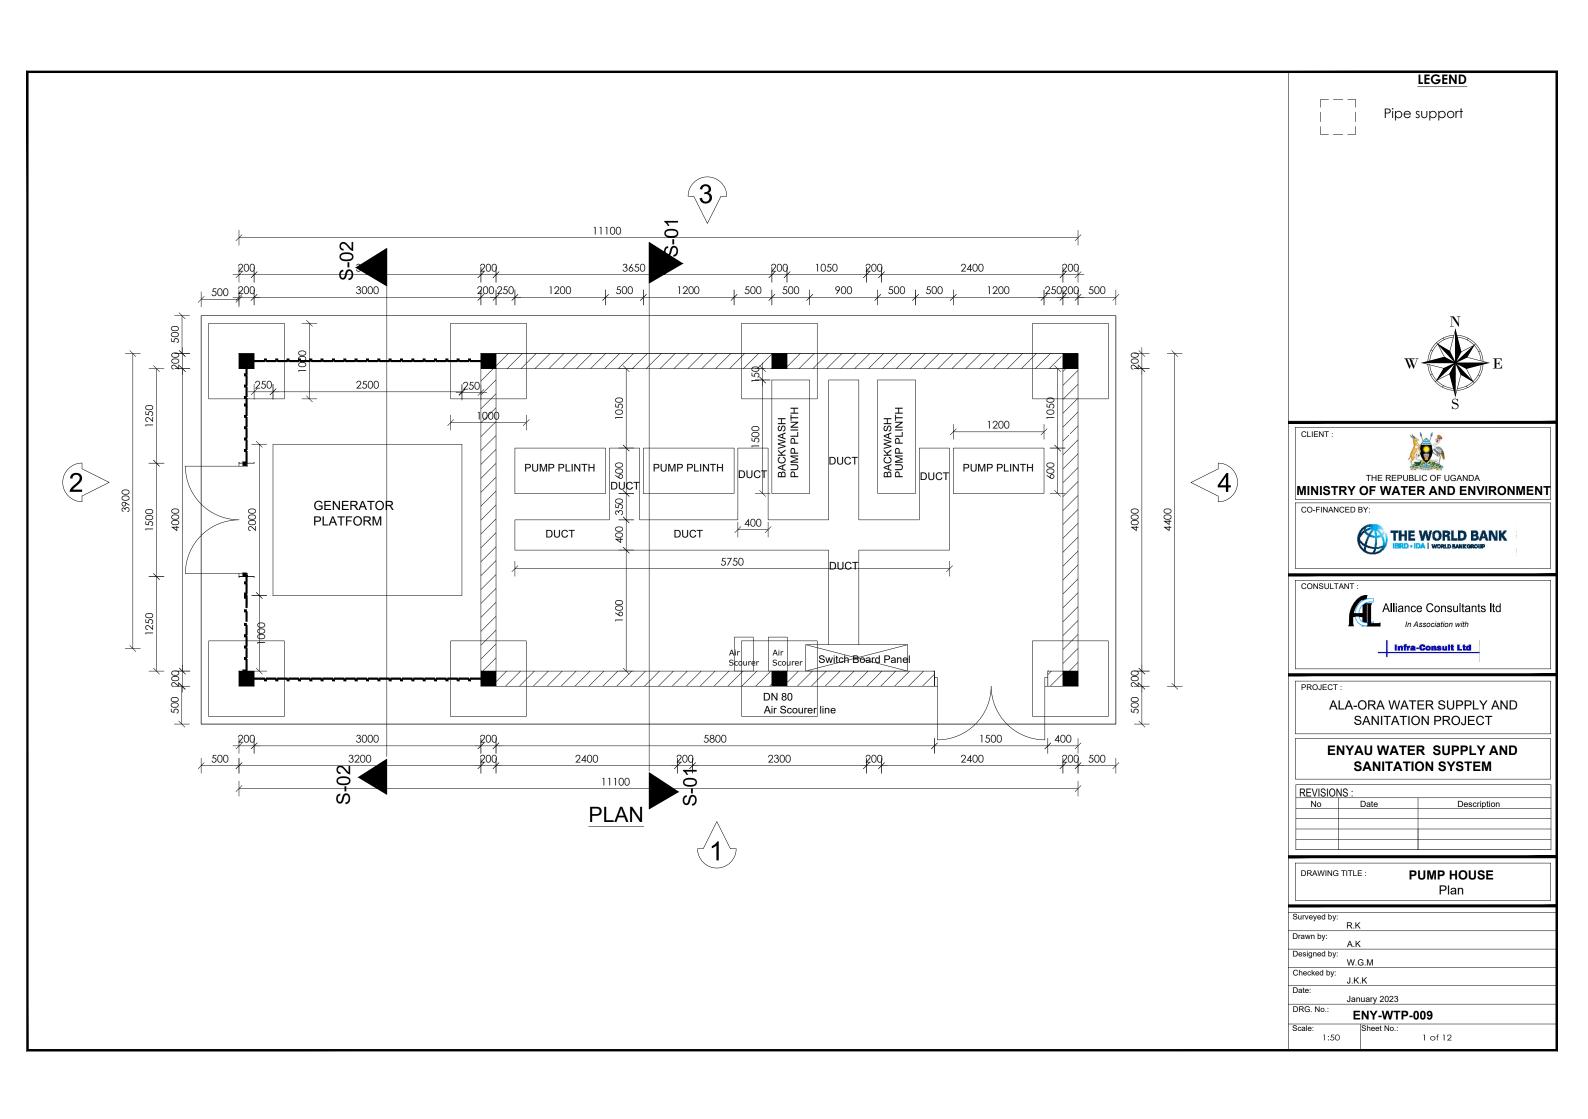

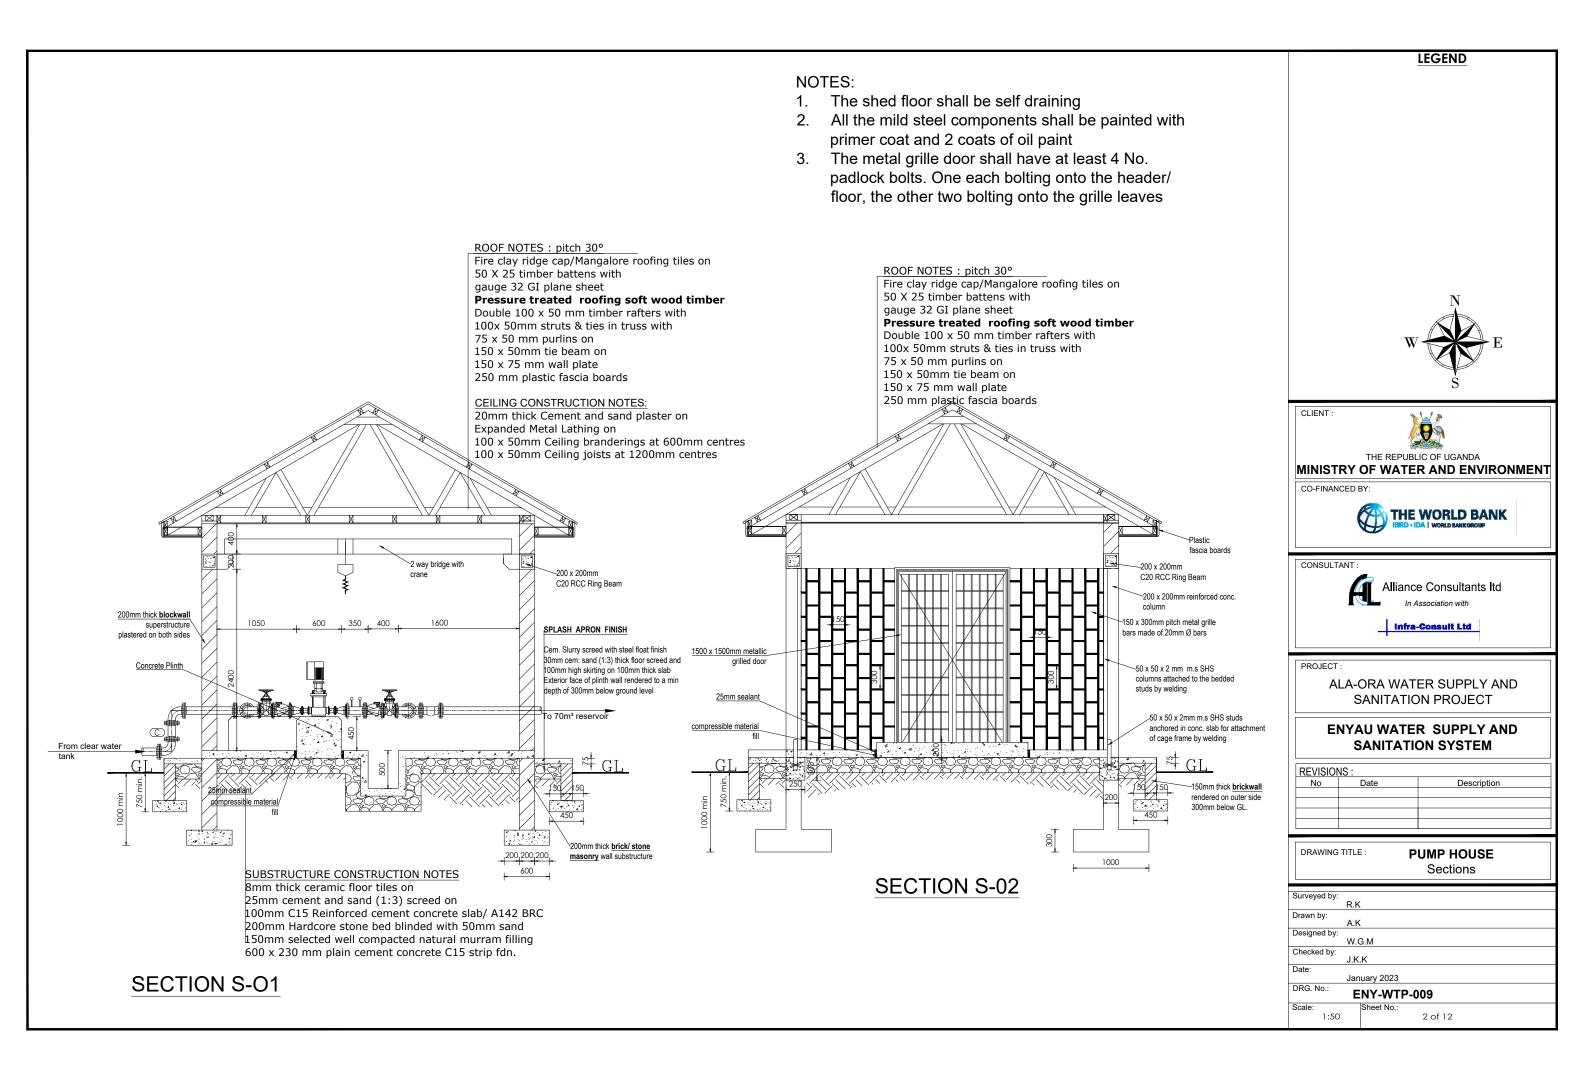


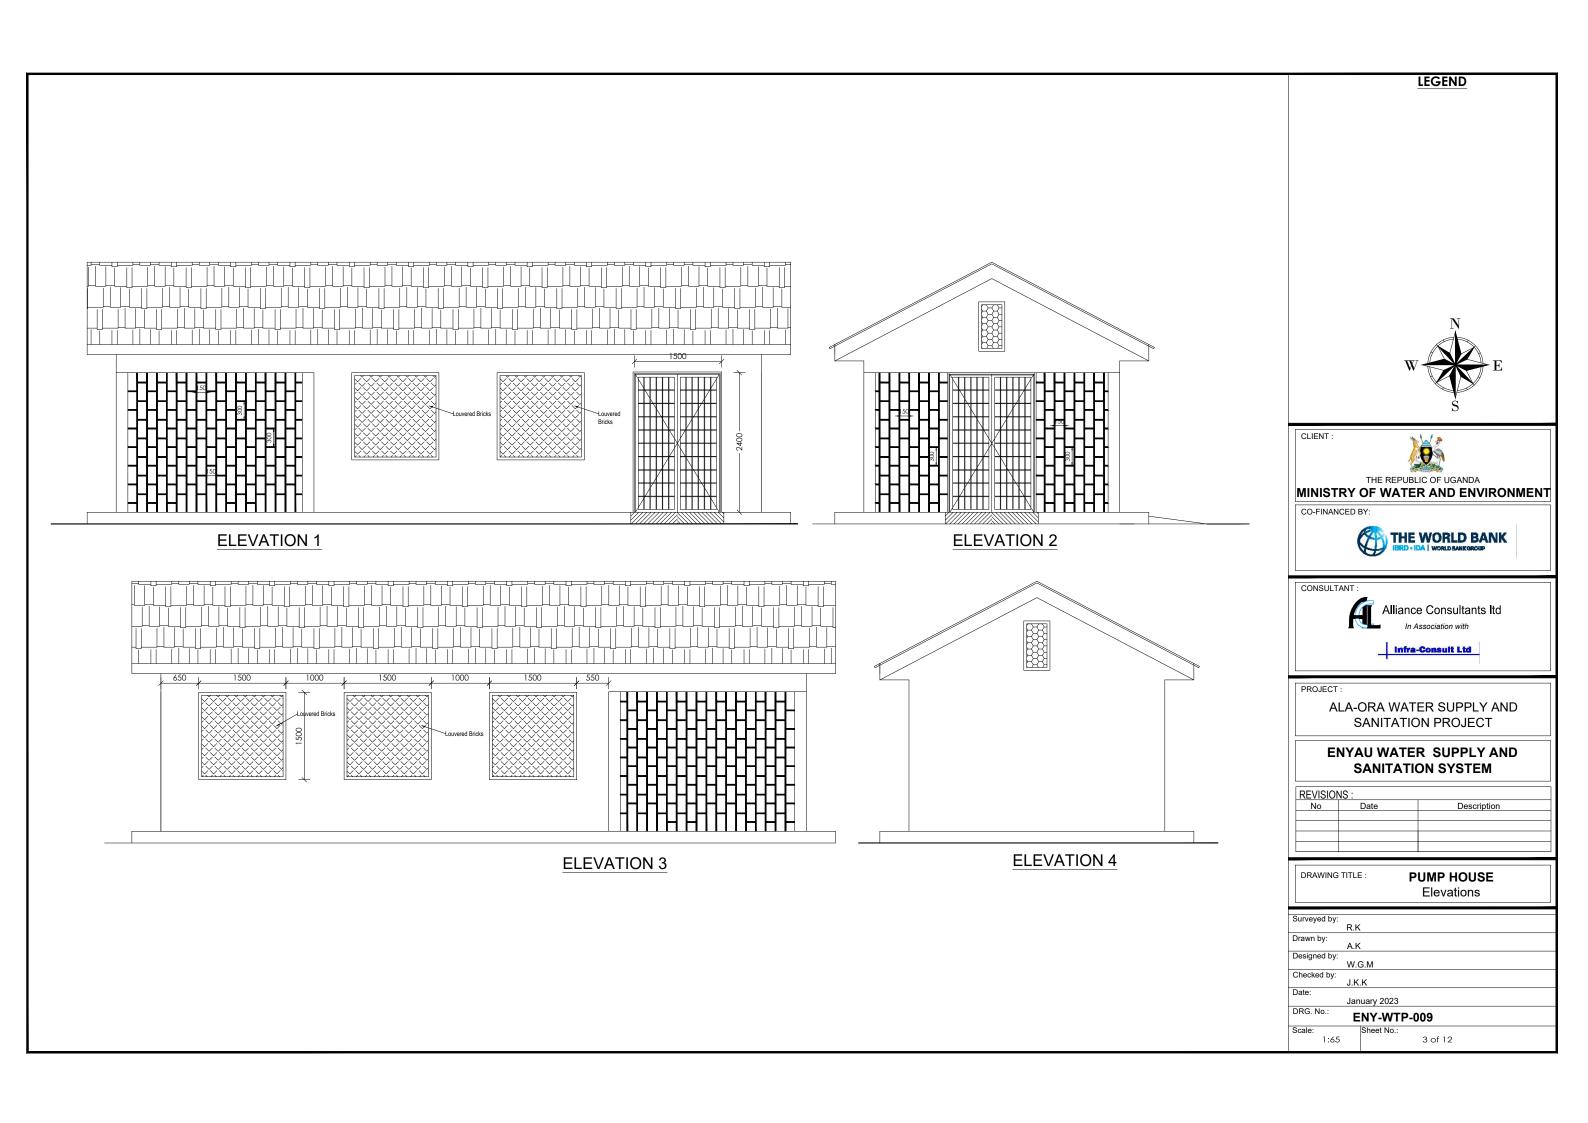

PIPES AND FITTINGS SCHEDULE				
ITEM	No. OF	DESCRIPTION		
		DN80 INLETS		
	2	DN80 ALL EQUAL TEE		
2	4	DN80 FLANGED 90° BEND		
3	4	DN80 FLANGED GATE VALVE		
4	4	D80 FLANGED NON-RETURN VALVE		
5	8	D80 FLANGED 90° BEND		
6	4	DN80/DN32 FLANGED REDUCER		
		DN50 INLETS		
7	2	D50 FLANGED EQUAL TEE		
8	2	DN50 FLANGED 90° BEND		
9	4	DN50 FLANGED GATE VALVE		
10	4	DN50 FLANGED NON-RETURN VALVE		
	4	D50 FLANGED 90° BEND		
12	2	DN50/DN25 FLANGED REDUCERS		

	PIPES AND FITTINGS SCHEDULE		
ITEM	No. OF	DESCRIPTION	
		DN80 OUTLETS	
13	6	DN80/DN32 FLANGED REDUCER	
14	6	DN80 FLANGED PRESSURE GAUGE	
15	6	D80 FLANGED NON-RETURN VALVE	
16	6	D80 FLANGED GATE VALVE	
17	3	D80 FLANGED ALL EQUAL TEE	
18	3	DN80 FLANGED BULK WATER METER	
27	6	DN80 FLANGED AIR VALVE	
28	5	DN80 FLANGED 90° BEND	
30	6	DN80 DISMANTLING JOINT	
32	1	DN80/OD110 COUPLING	
33	1	DN80/OD90 COUPLING	
		DN50 OUTLETS	
19	2	D50/DN25 FLANGED REDUCER	
20	2	DN50 FLANGED PRESSURE GAUGE	
21	2	DN50 DISMANTLING JOINT	
22	2	DN50 FLANGED NON-RETURN VALVE	
23	2	DN50 FLANGED GATE VALVE	
24	1	D50 FLANGED 90° BEND	
25	1	D50 FLANGED ALL EQUAL TEE	
26	1	D50 FLANGED BULK WATER METER	
31	1	D50/OD50 COUPLING	
34	2	D50 FLANGED AIR VALVE	

	PIPES AND FITTINGS SCHEDULE				
ITEM	No. OF	DESCRIPTION			
		DN80 PIPE SPECIALS			
A	2	DN 80 FLANGED PIPE LENGTH n.e 0.5m			
В	2	DN 80 FLANGED PIPE LENGTH n.e 1m			
С	2	DN 80 FLANGED PIPE LENGTH n.e 0.25m			
		DN50 PIPE SPECIALS			
E	2	DN 50 FLANGED PIPE LENGTH n.e 0.4m			
F	1	DN 50 FLANGED PIPE LENGTH n.e 2m			
G	1	DN 50 FLANGED PIPE LENGTH n.e 1.2m			
H	2	DN 50 FLANGED PIPE LENGTH n.e 0.25m			
J	2	DN 50 FLANGED PIPE LENGTH n.e 0.3m			
K	1	DN 50 FLANGED PIPE LENGTH n.e 1.2m			
	1	DN 50 FLANGED PIPE LENGTH n.e 0.25m			
M	1	DN 50 FLANGED PIPE LENGTH n.e 0.75m			
N	1	DN 50 FLANGED PIPE LENGTH n.e 0.3m			
R	1	DN 50 FLANGED PIPE LENGTH n.e 0.5m			

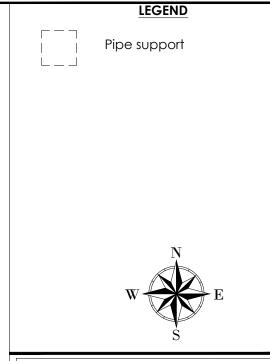

THE REPUBLIC OF UGANDA

MINISTRY OF WATER AND ENVIRONMENT

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THE WORLD BANK

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ALA-ORA WATER SUPPLY AND
SANITATION PROJECT

ENYAU WATER SUPPLY AND SANITATION SYSTEM

REVISIONS:			
No	Date	Description	

PUMP HOUSE

Pipe parts Details

Surveyed by:
R.K

Drawn by:
A.K

Designed by:
W.G.M

Checked by:

DRAWING TITLE :

Drawn by:

A.K

Designed by:

W.G.M

Checked by:

J.K.K

Date:

January 2023

DRG. No.:


ENY-WTP-009

Scale:


1:50

Sheet No.:

5 of 12

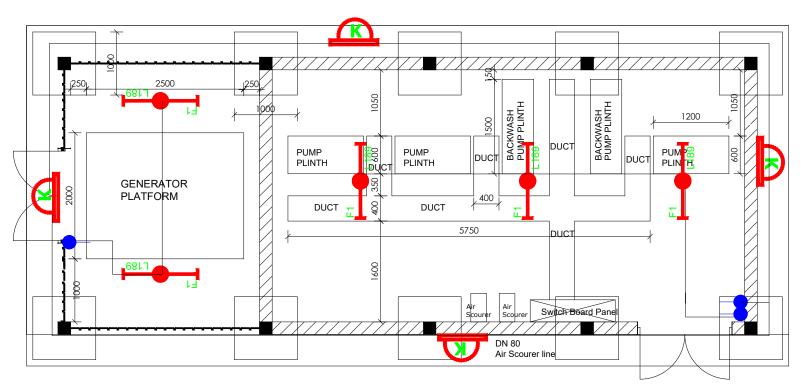

- 1). ALL WALL BRACKETS SHALL BE MOUNTED 1800mm ABOVE FINISHED FLOOR LEVEL
- 2). TELEPHONE, SOCKETS, T.V AND COMPUTER OUTLETS SHALL BE MOUNTED 300mm
- ABOVE FINISHED FLOOR LEVEL EXCEPT WHERE THEIR IS A WORKTOP.
- $3). \ WHERE \ THEIR IS A WORKTOP, TELEPHONE, SOCKETS, T.V \ AND \ COMPUTER \ OUTLETS \ SHALL \ BE \ MOUNTED \ 150mm \ ABOVE \ WORKTOPS.$
- 4). CONSUMER UNITS SHALL BE 1800mm ABOVE FINISHED FLOOR LEVEL
- 5). ALL SWITCHES SHALL BE 1400mm ABOVE FINISHED FLOOR LEVEL
- 6). ALL OUTSIDE SOCKETS SHOULD BE WEATHER PROOF
- 7). ALL SHAVER SOCKETS SHOULD BE ON THE RIGHT HAND SIDE OF THE WASH HAND BASIN
- 8). ALL CABLES MUST BE STRANDED

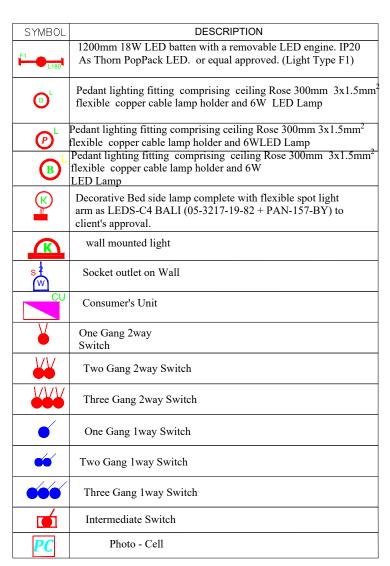



LEGEND



CLIENT :



THE REPUBLIC OF UGANDA
MINISTRY OF WATER AND ENVIRONMENT

CO-FINANCED BY:



CONSULTANT :



Alliance Consultants Itd

Infra-Consult Ltd


PROJECT


ALA-ORA WATER SUPPLY AND SANITATION PROJECT


ENYAU WATER SUPPLY AND SANITATION SYSTEM


REVISION	NS:	
No	Date	Description


DRAWING TITLE: PUMP HOUSE Electrical Layout

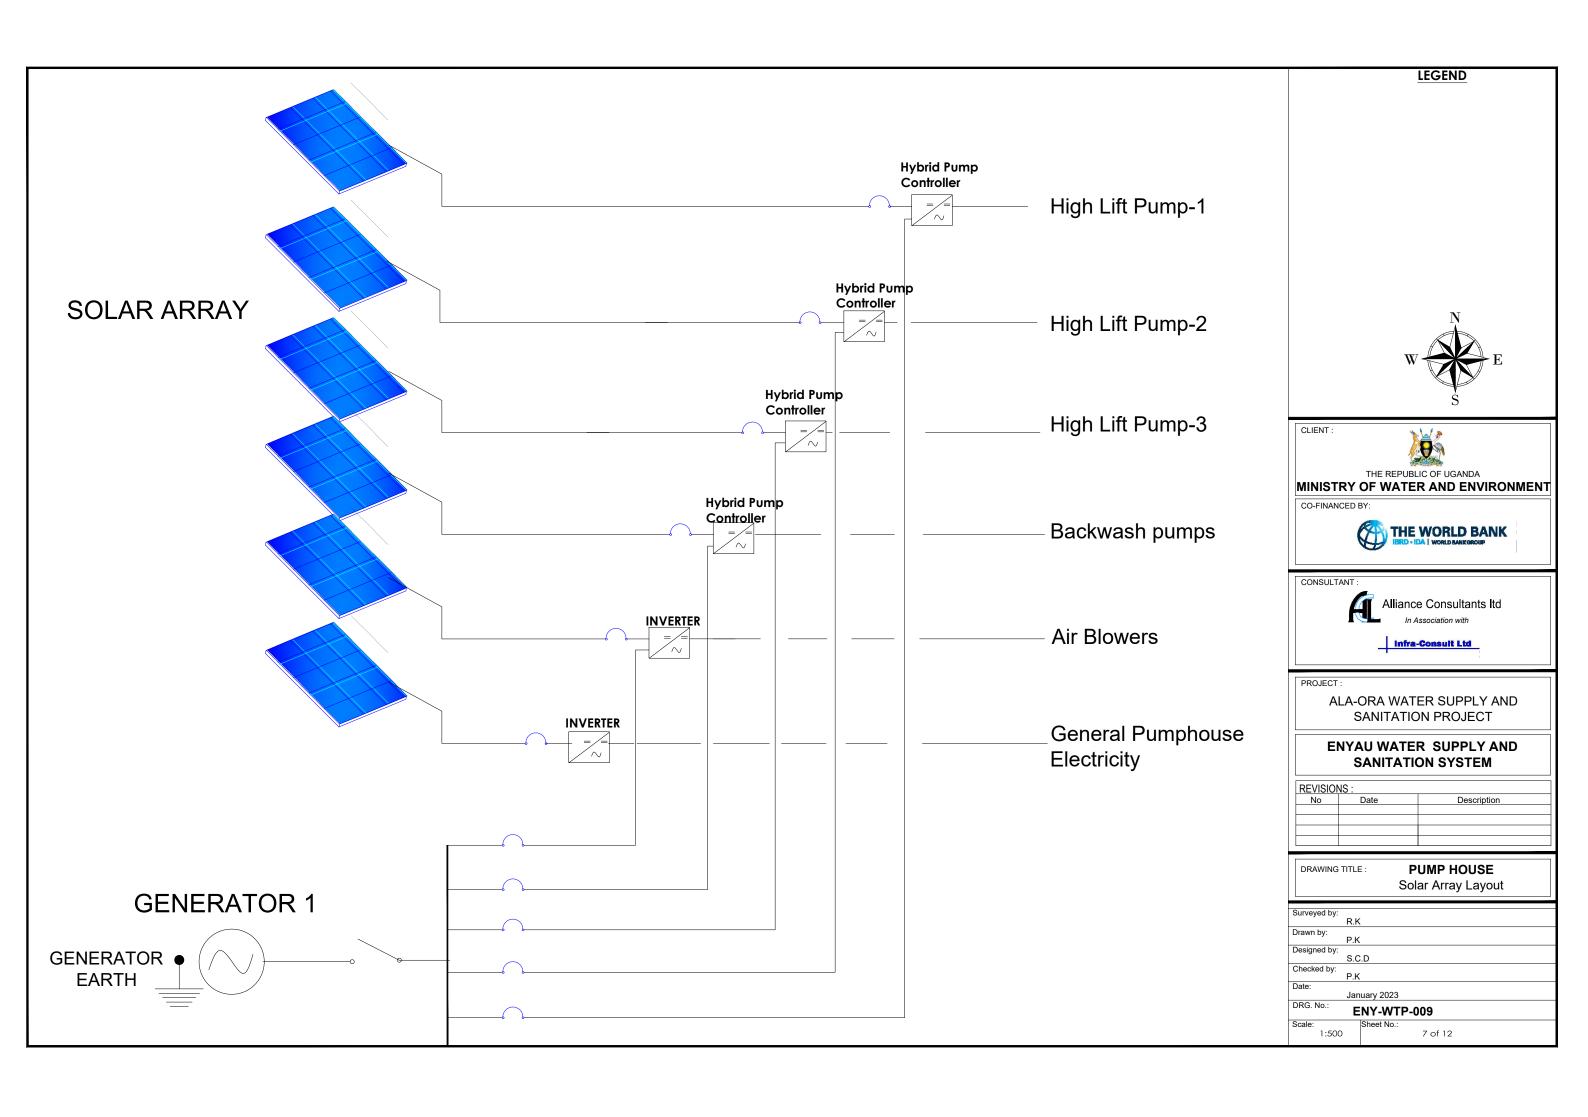


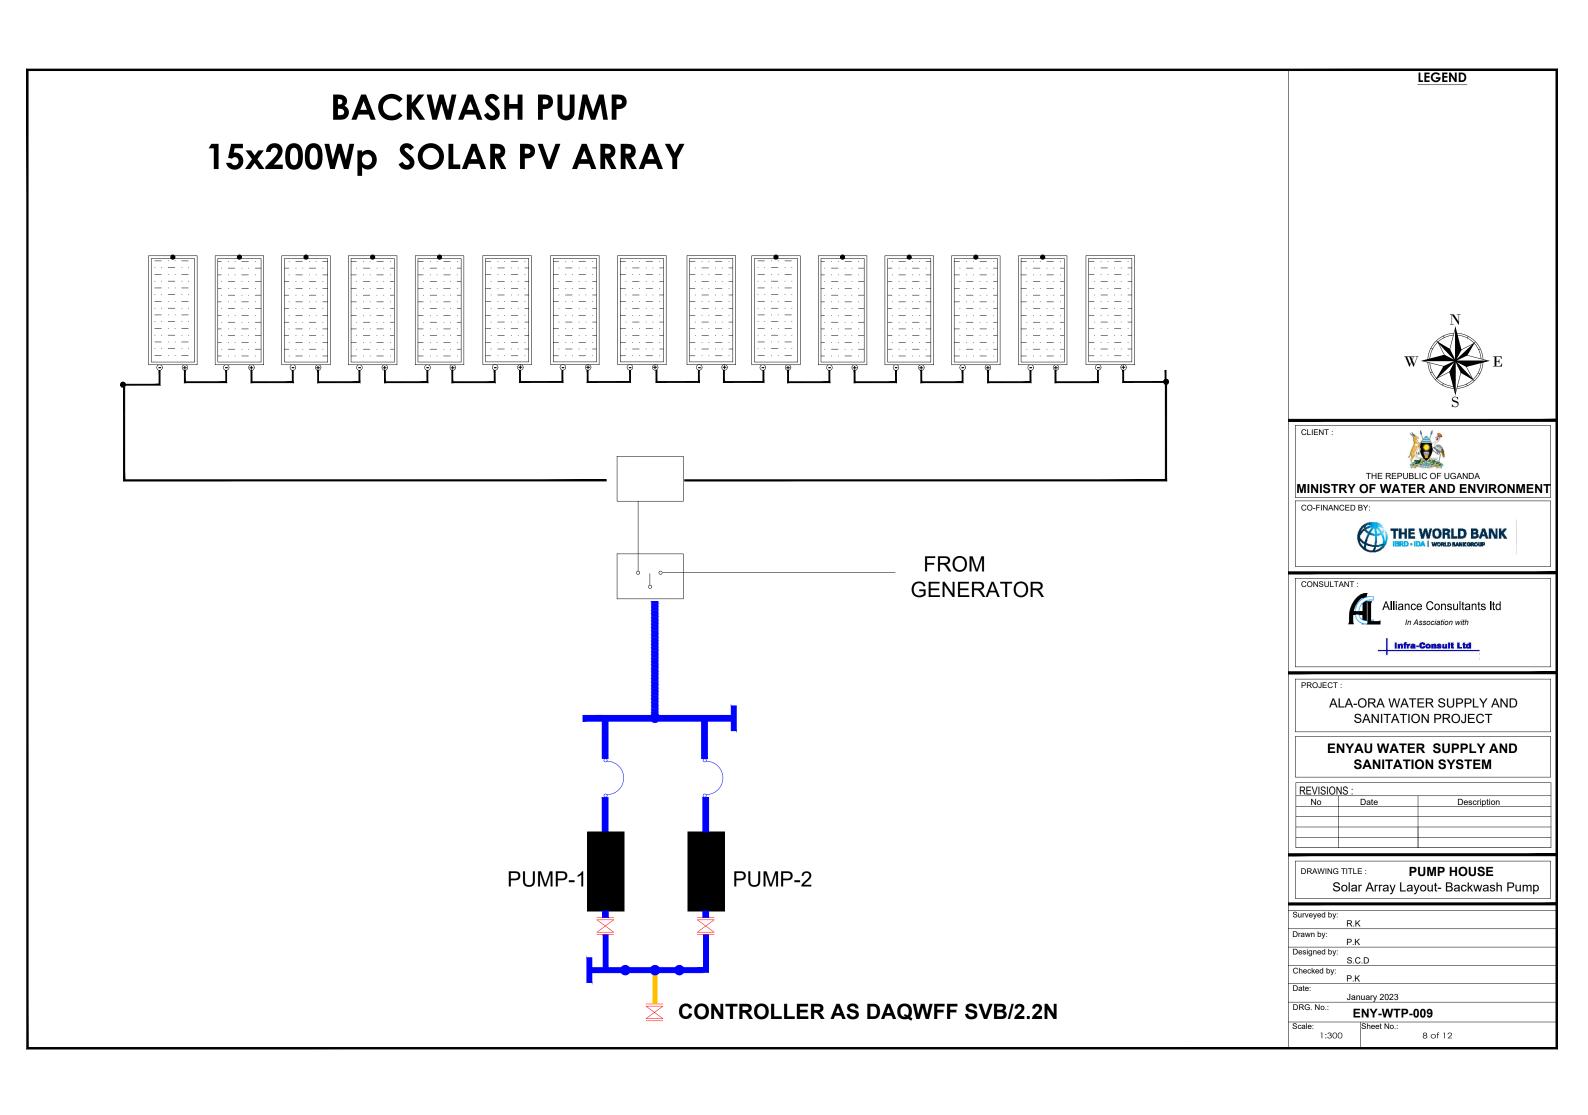


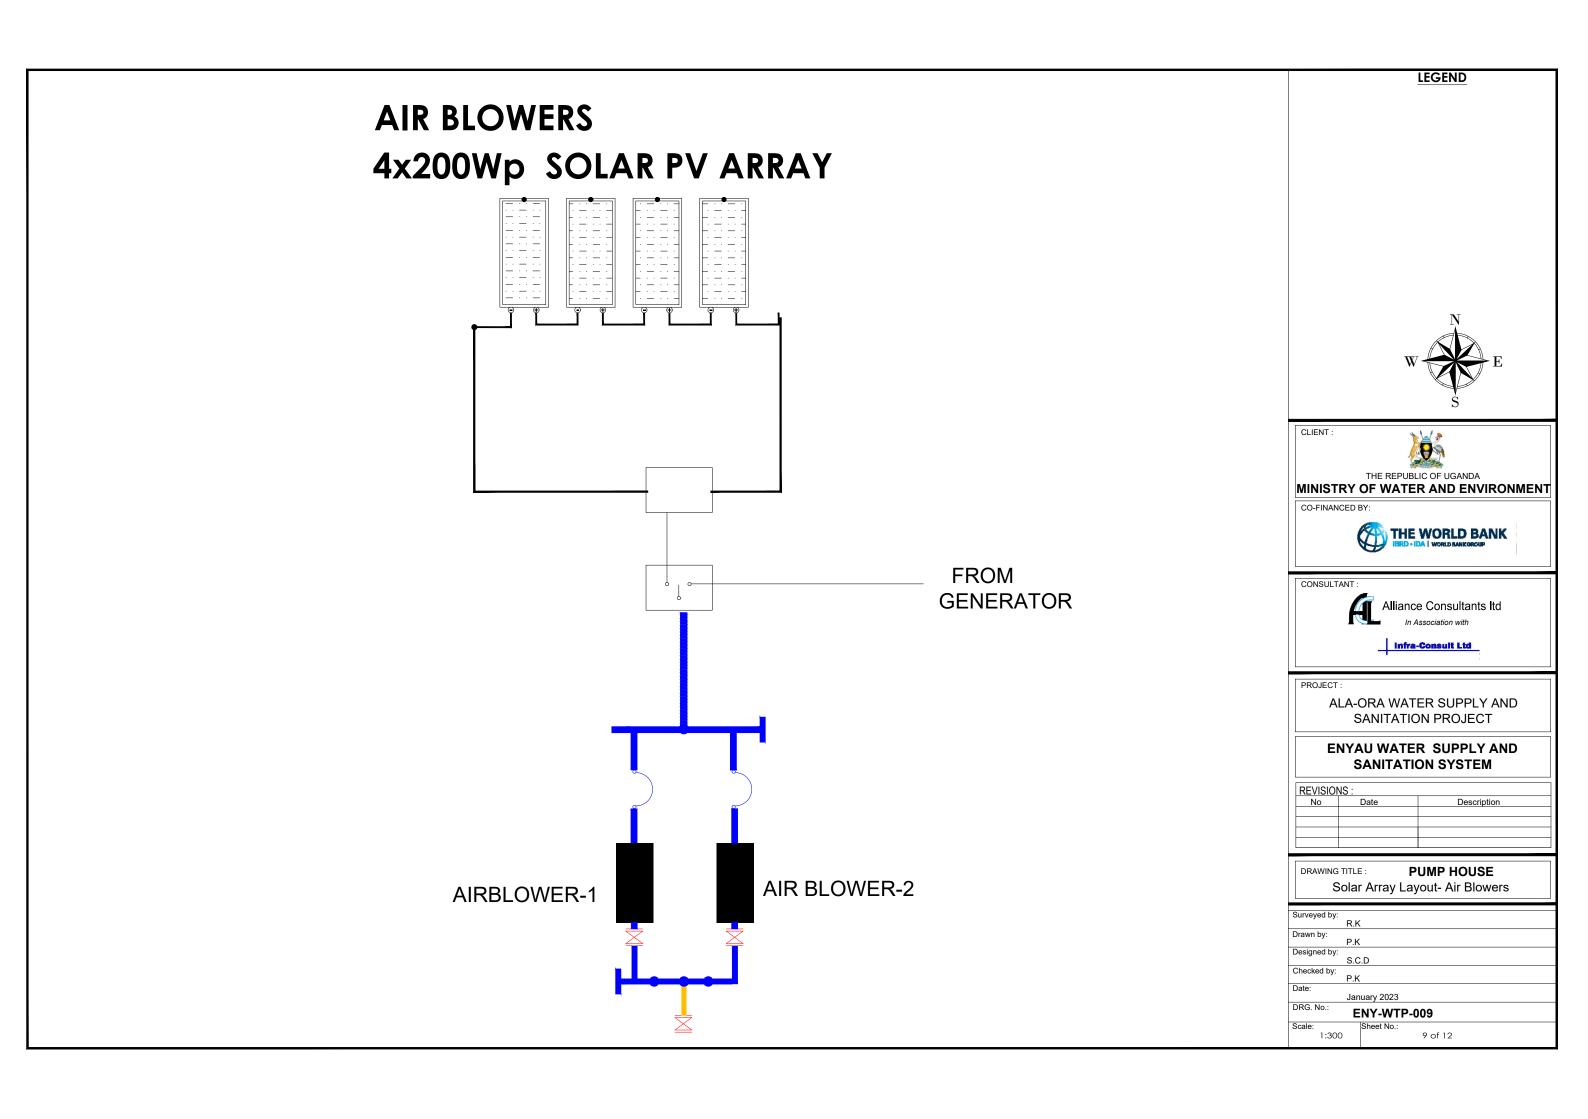


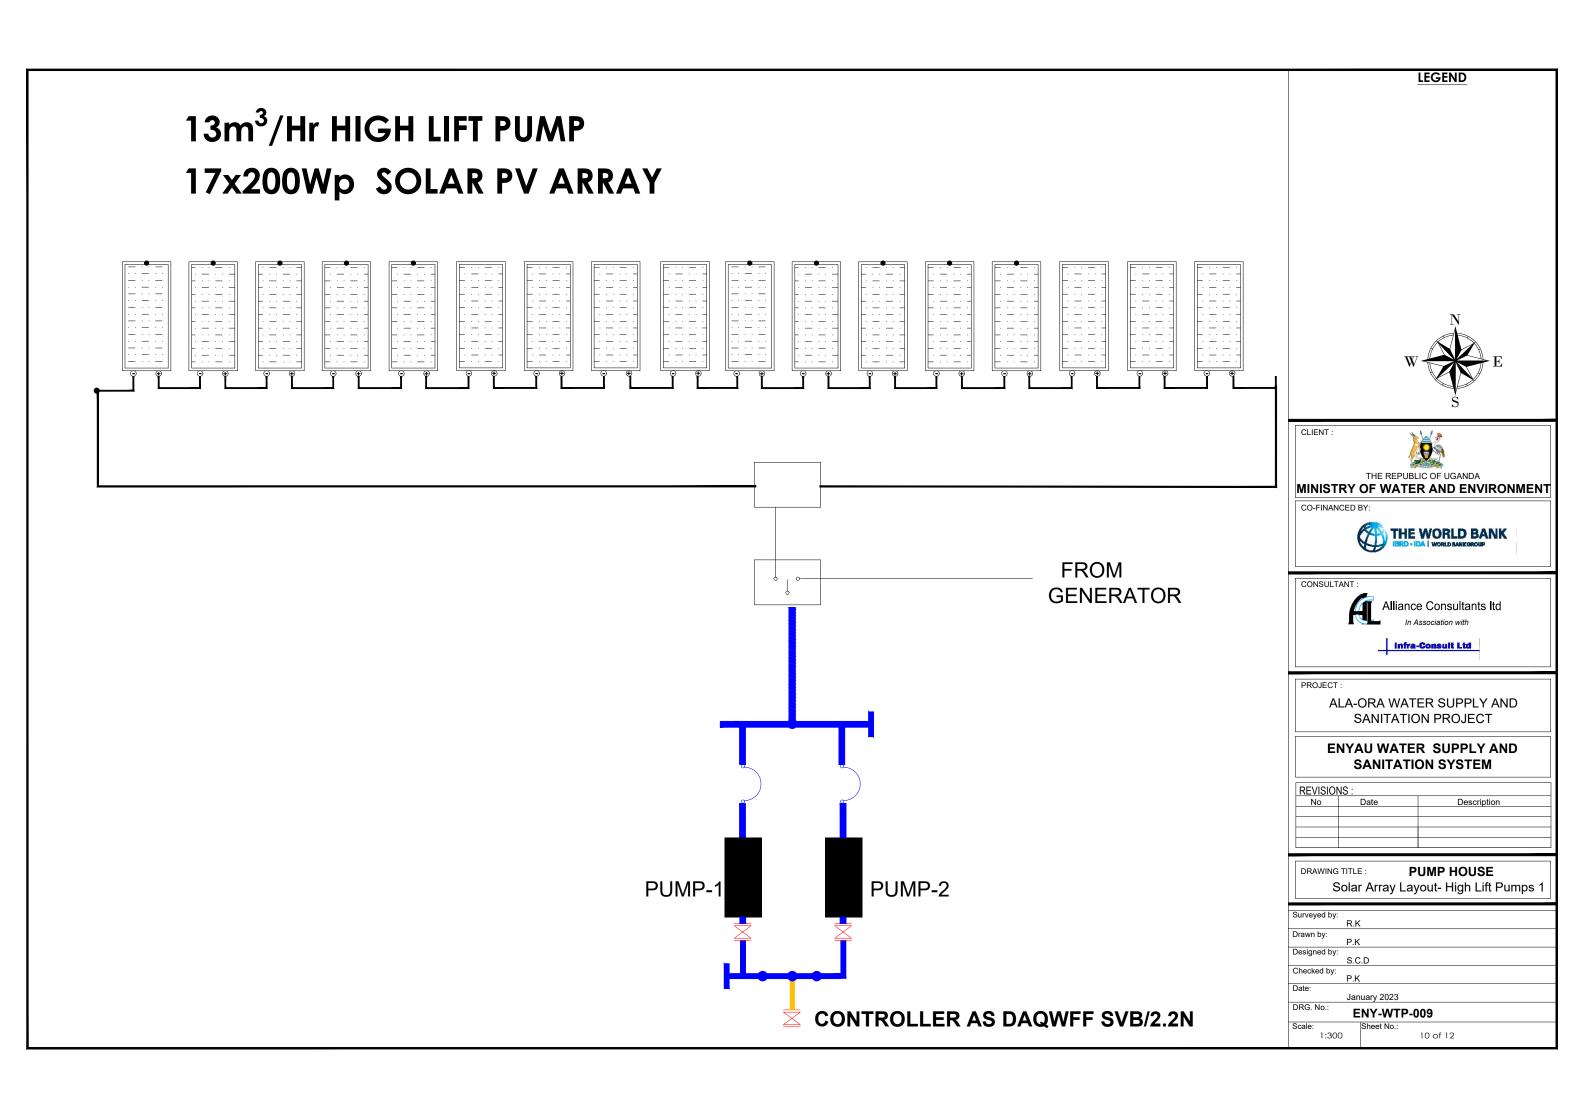

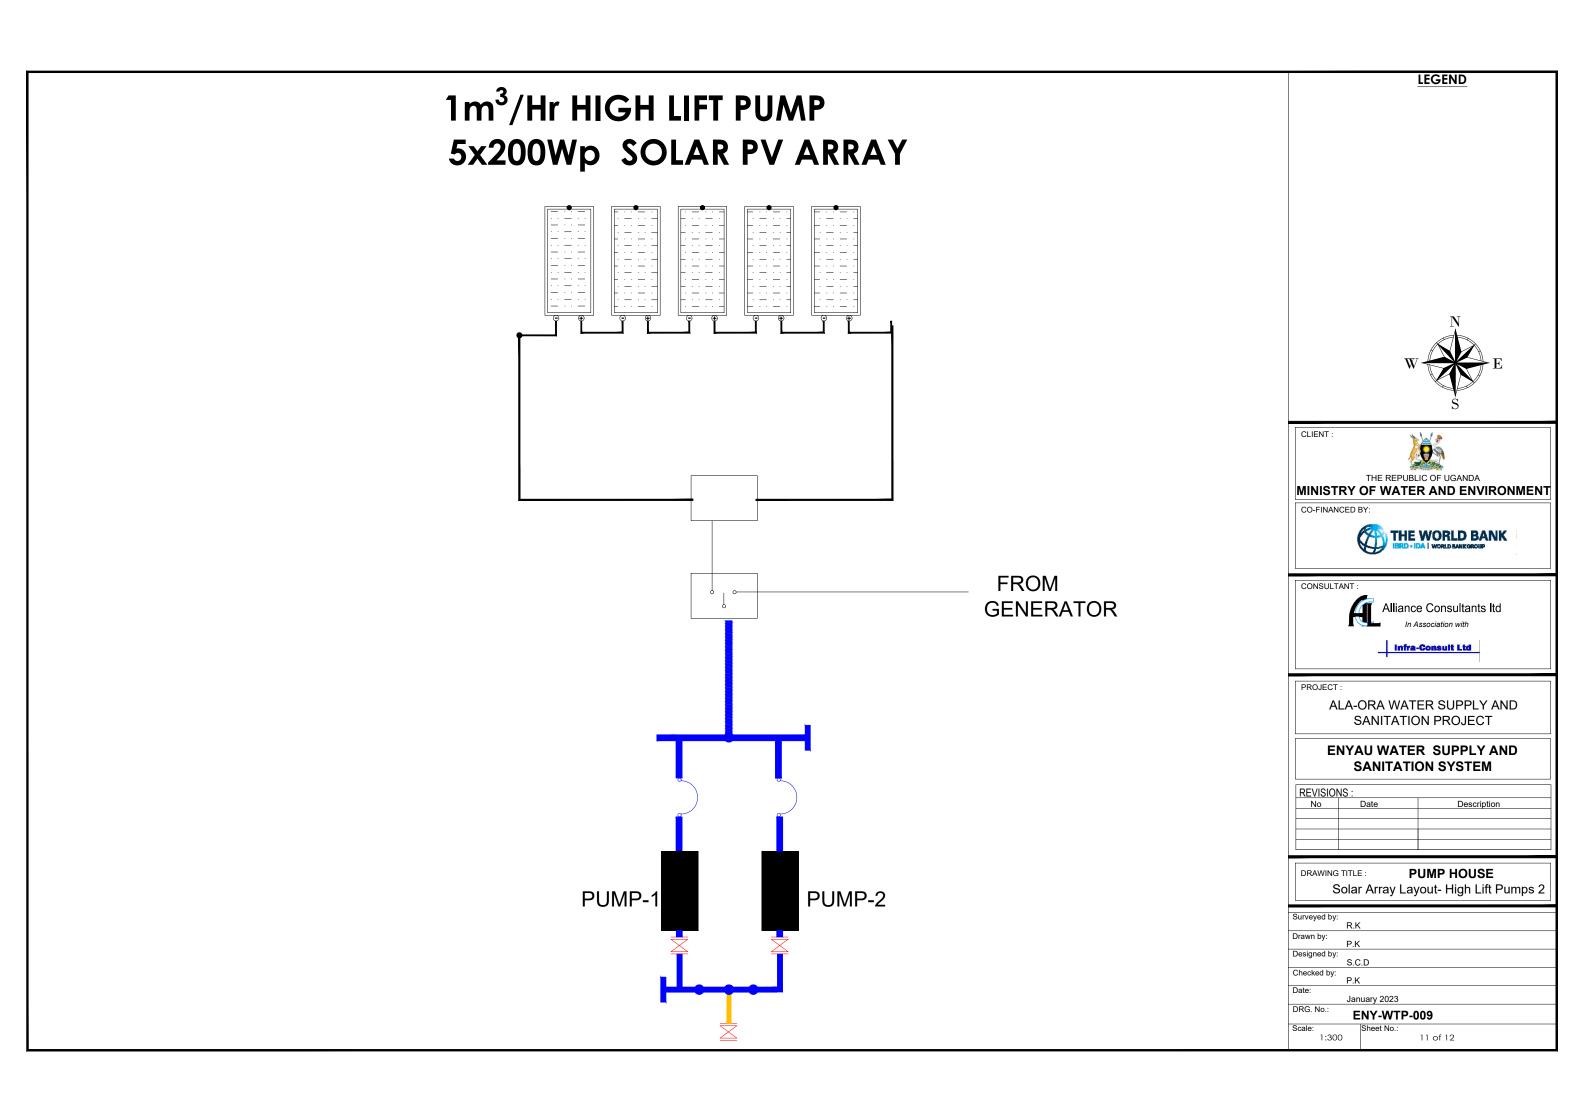

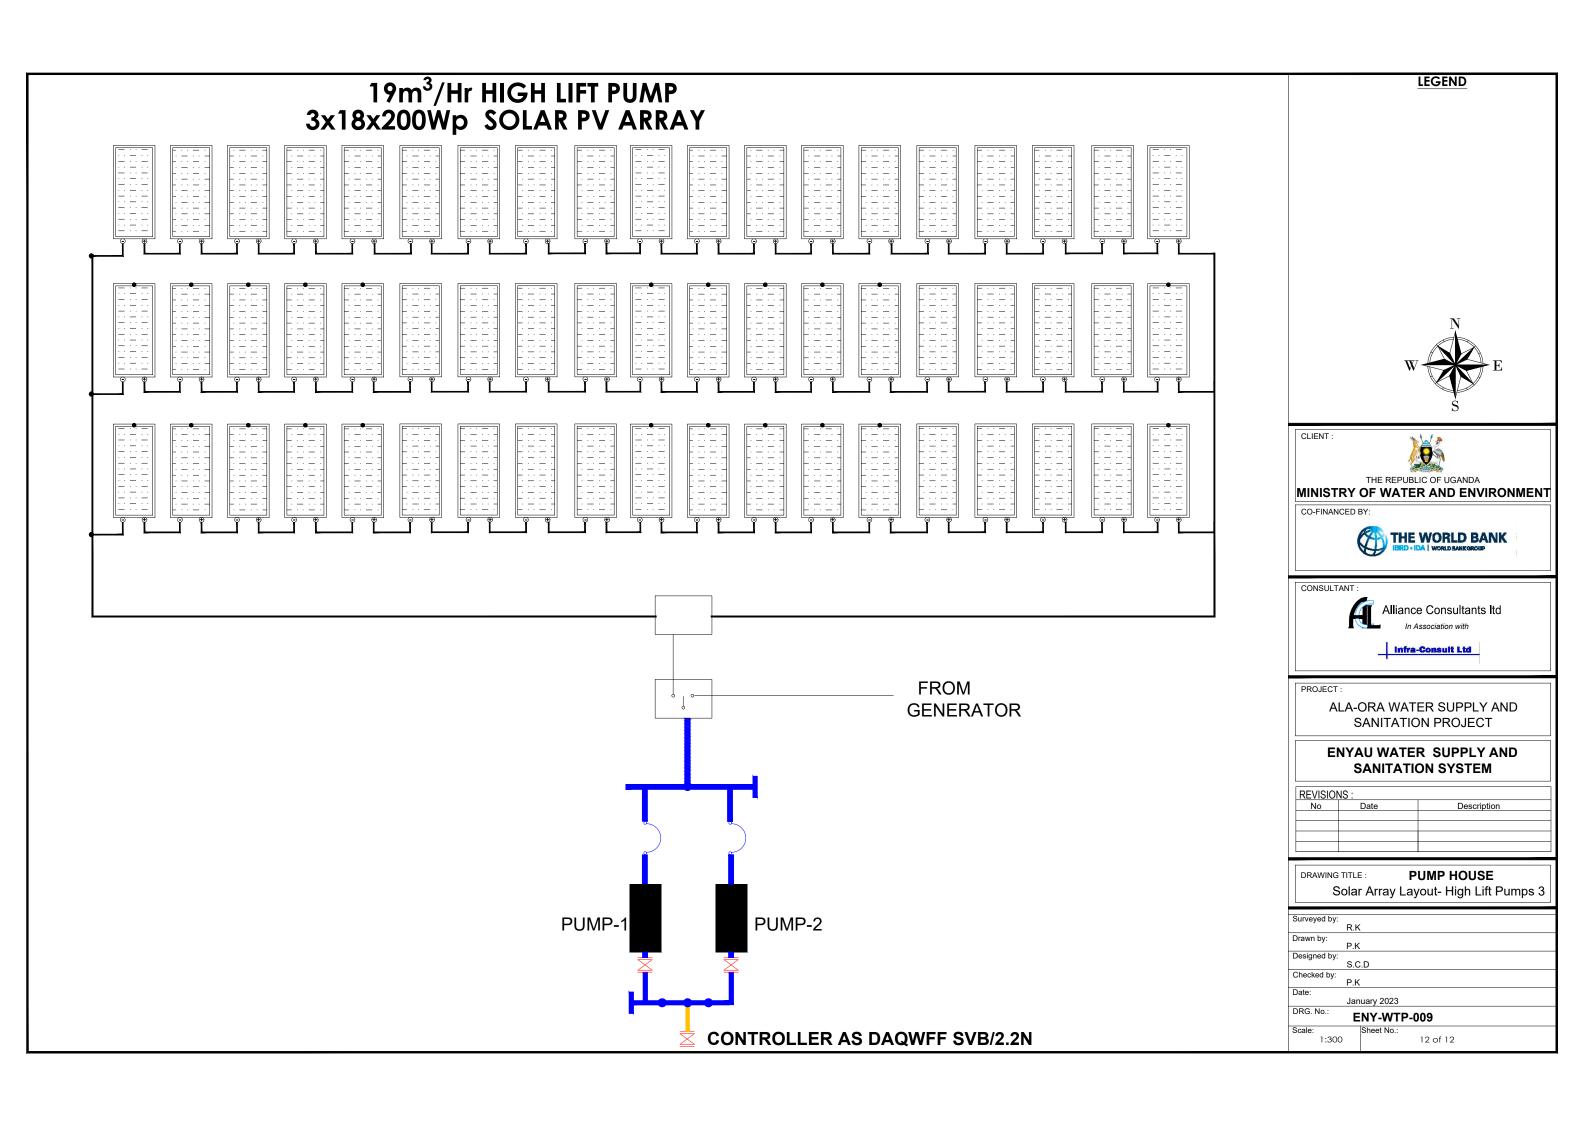

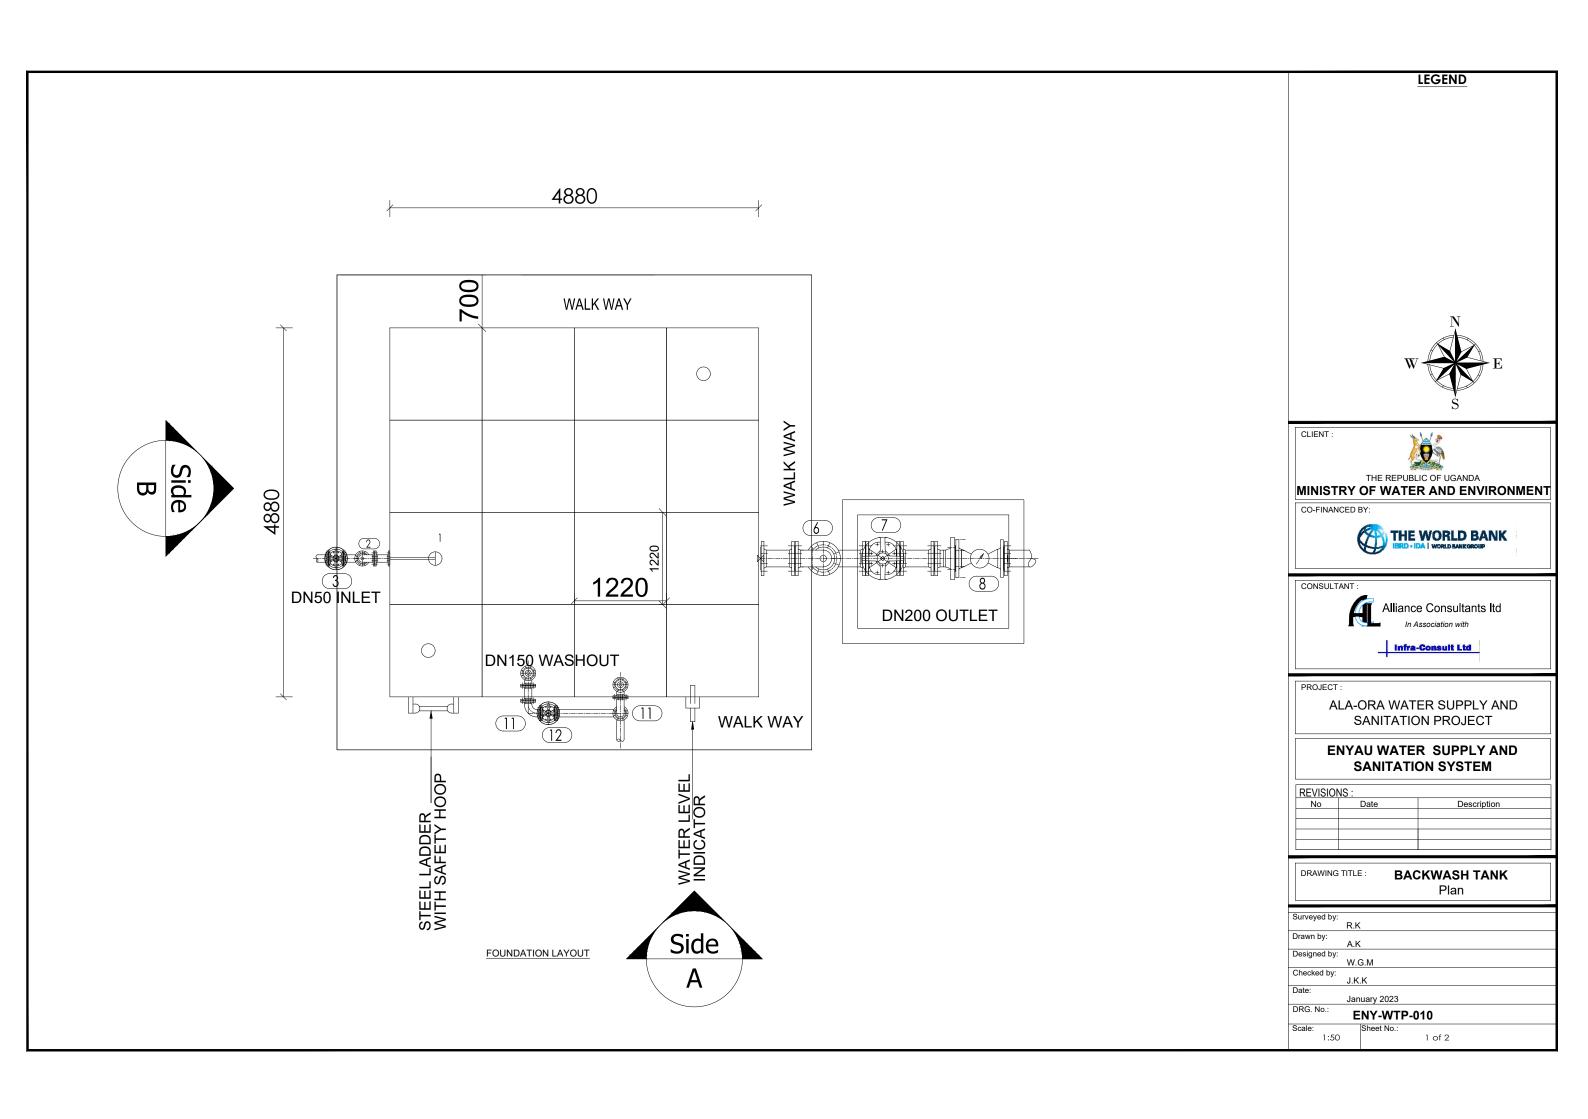

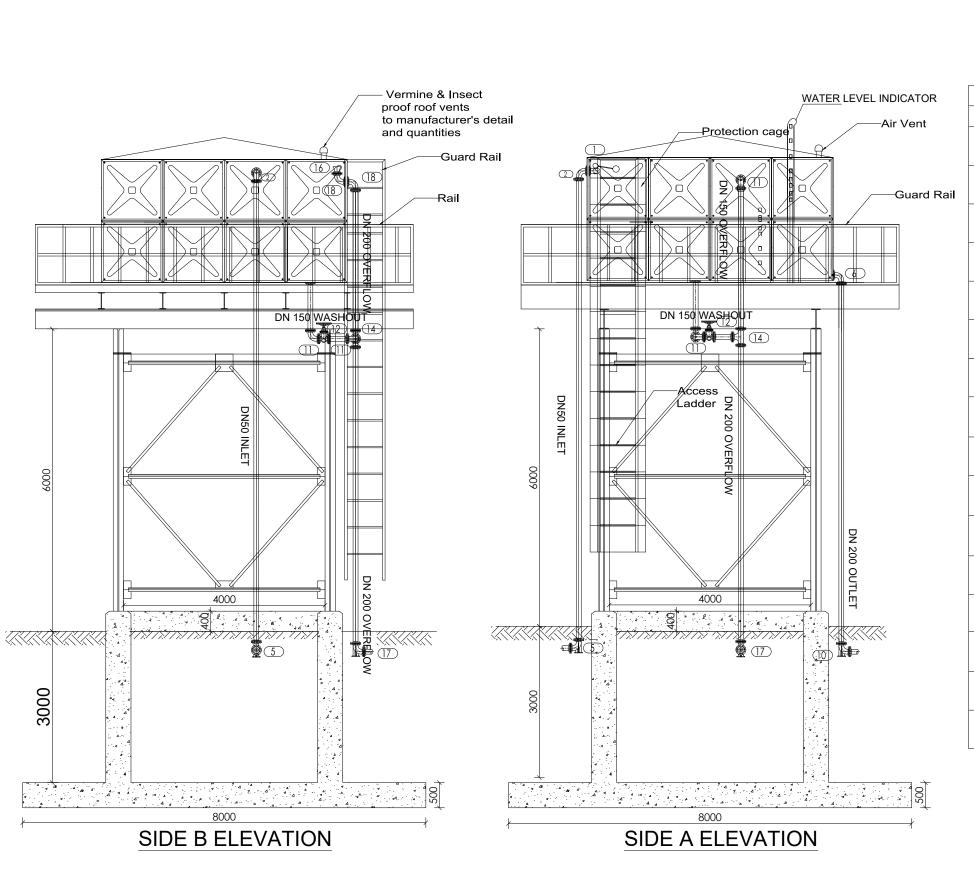

	PIPES AND FITTINGS SCHEDULE (INLE		FITTINGS SCHEDULE (INLET)
	ITEM	No. OF	DESCRIPTION
		1	DN50 FLOAT VALVE
	2	1	DN50 FLANGED 90° BEND
	3	1	DN50 FLANGED GATE VALVE
	5	1	DN50 90° DUCKFOOT BEND
	PIPE	ES AND F	FITTINGS SCHEDULE (OUTLET)
	6	1	DN200 FLANGED 90° BEND
	7	1	DN200 FLANGED GATE VALVE
	8	1	DN200 BULK WATER METER
		1	DN200 90° DUCKFOOT BEND
PIPES AND FITTINGS SCHEDULE (WASHOUT & OVERFLOW)		I	
		2	DN150 FLANGED 90° BEND
	12	1	DN150 FLANGED GATE VALVE
	(14)	1	DN200/150 ALL FLANGED TEE
	16	1	DN200 BELL MOUTH
	(17)	1	DN200 90° DUCKFOOT BEND
	18)	2	DN200 90° BEND







THE REPUBLIC OF UGANDA MINISTRY OF WATER AND ENVIRONMENT

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CONSULTANT:



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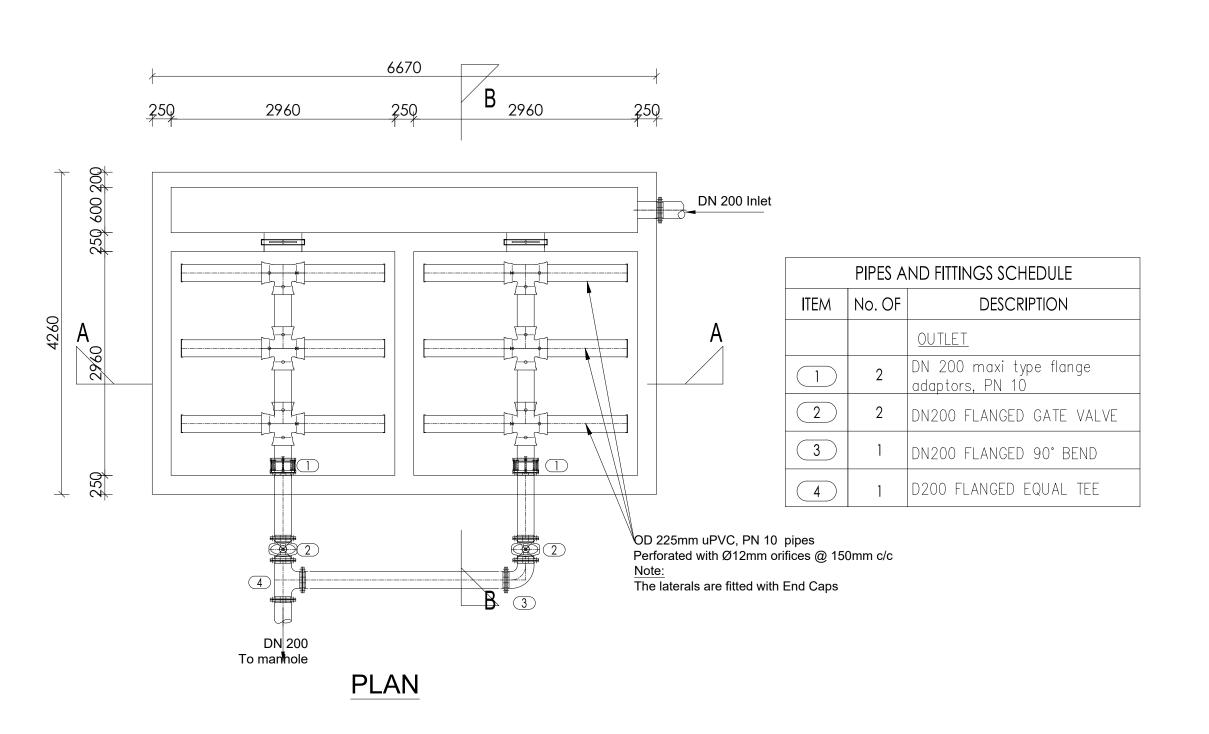
ALA-ORA WATER SUPPLY AND SANITATION PROJECT

ENYAU WATER SUPPLY AND SANITATION SYSTEM

REVISIO	NS:	
No	Date	Description
		·

DRAWING TITLE: BACKWASH TANK
Elevations

Surveyed by:				
, ,	R.K			
Drawn by:				
,	A.K			
Designed by:				
	W.G	.M		
Checked by:				
,	J.K.k	(
Date:				
	Janu	ary 2023		
DRG. No.:		IV W/TD	040	
	Er	NY-WTP-	010	
Scale:	S	Sheet No.:		
1:75			2 of 2	



LEGEND



CLIENT :



THE REPUBLIC OF UGANDA
MINISTRY OF WATER AND ENVIRONMENT

CO-FINANCED BY:



CONSULTANT:



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ALA-ORA WATER SUPPLY AND SANITATION PROJECT


ENYAU WATER SUPPLY AND SANITATION SYSTEM

REVISIONS:				
No	Date	Description		
		· ·		

DRAWING TITLE: SLUDGE DRYING BEDS
Plan

Surveyed by:
R.K
Drawn by:
A.K
Designed by:
W.G.M
Checked by:
J.K.K
Date:
January 2023
DRG. No.:
ENY-WTP-011
Scale:
1:50
1 of 2

Opening for 2960 2960 handstock fitting 1230 500 1230 1230 , 500 Inlet 1000 Filter media Filter media 2 Graviel's upport 22 Gravel support 375 6520 75 SECTION A-A

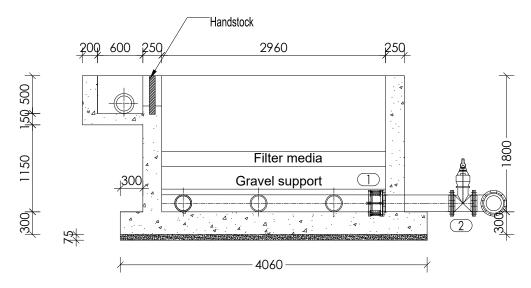

SECTION B-B





CLIENT:



THE REPUBLIC OF UGANDA
MINISTRY OF WATER AND ENVIRONMENT

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CONSULTANT :



Alliance Consultants Itd

Infra-Consult Ltd

PROJECT:


ALA-ORA WATER SUPPLY AND SANITATION PROJECT

ENYAU WATER SUPPLY AND SANITATION SYSTEM

REVISIONS:			
No	Date	Description	

DRAWING TITLE: SLUDGE DRYING BEDS
Sections

Surveyed by:	
	R.K
Drawn by:	
,	A.K
Designed by:	
,	W.G.M
Checked by:	
,	J.K.K
Date:	
	January 2023
DRG. No.:	
	ENY-WTP-011
Scale:	Sheet No.:
1:50	2 of 3
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DETAIL a
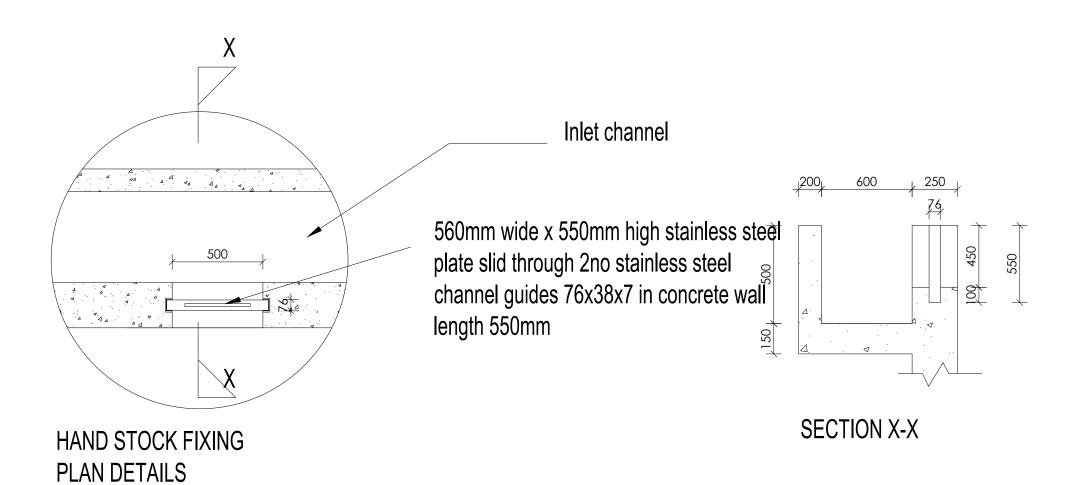
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LEGEND

THE REPUBLIC OF UGANDA

MINISTRY OF WATER AND ENVIRONMENT

CO-FINANCED BY:

THE WORLD BANK



PROJECT:


ALA-ORA WATER SUPPLY AND
SANITATION PROJECT


ENYAU WATER SUPPLY AND SANITATION SYSTEM


REVISIONS:			
No	Date	Description	
		·	

DRAWING TITLE: SLUDGE DRYING BEDS
Sections

Surveyed by:	
, ,	R.K
Drawn by:	
Diawii by.	A.K
Designed by:	
3 ,	W.G.M
Checked by:	
	J.K.K
Date:	
	January 2023
DRG. No.:	
	ENY-WTP-011
Scale:	Sheet No.:
1:50	3 of 3

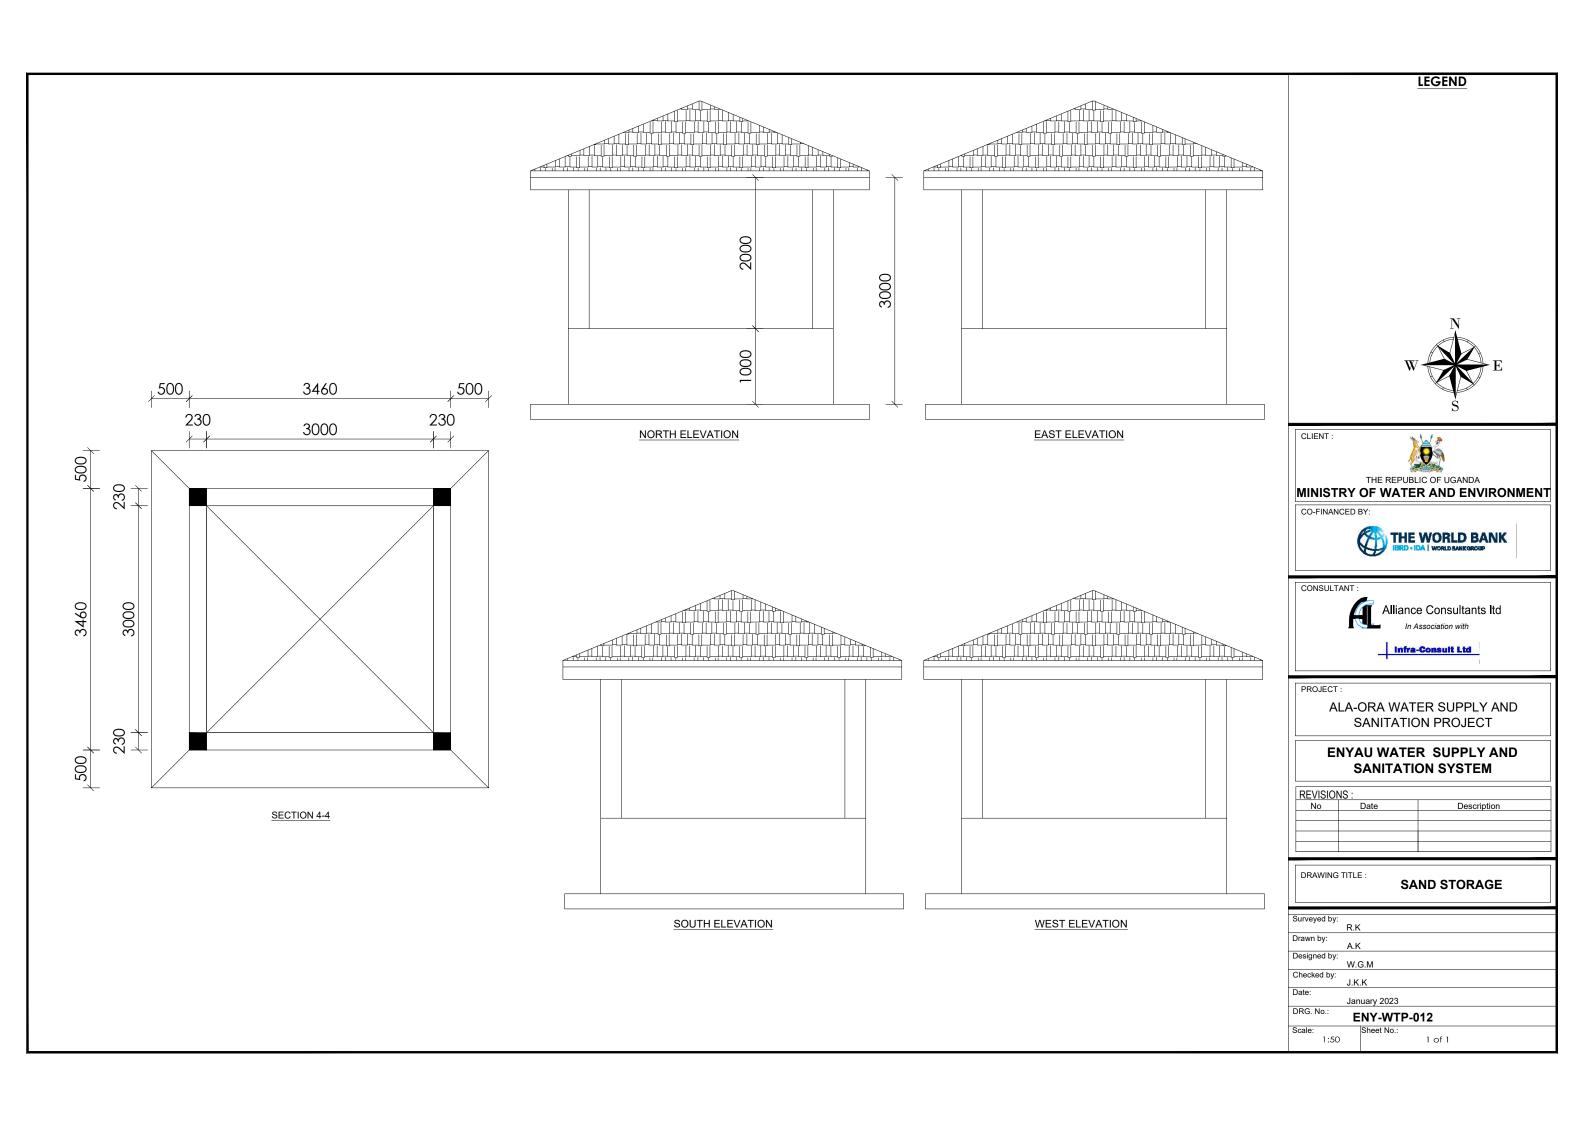

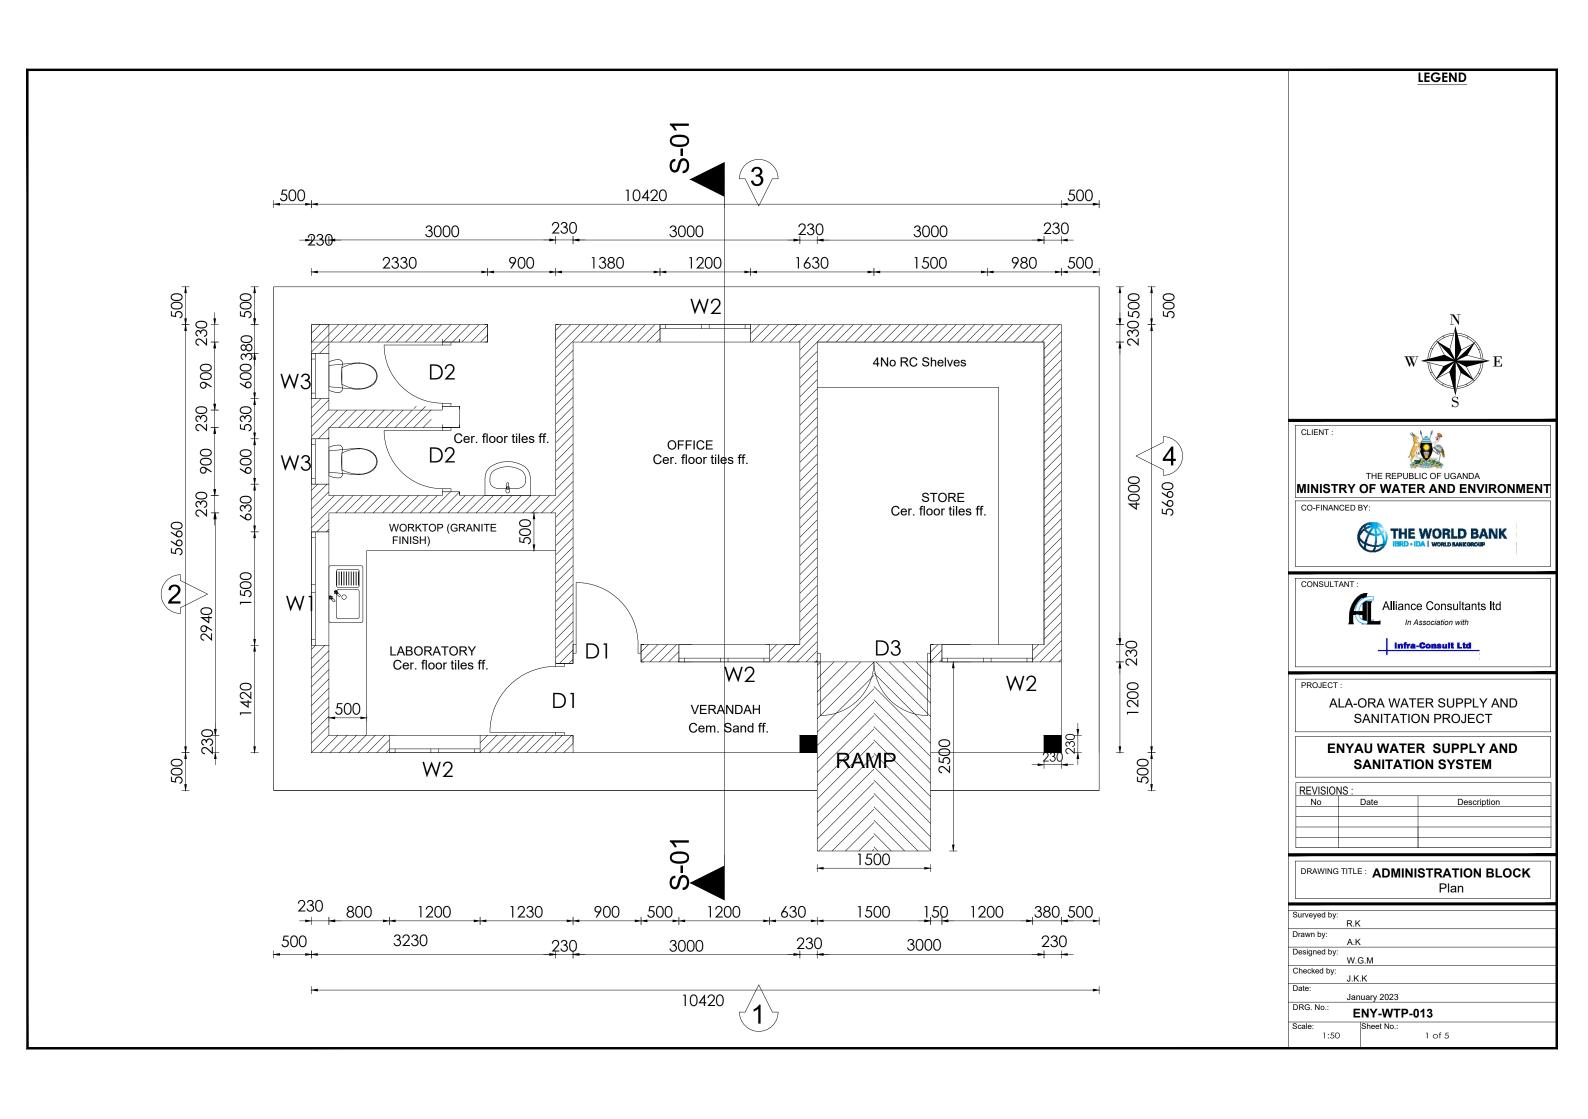

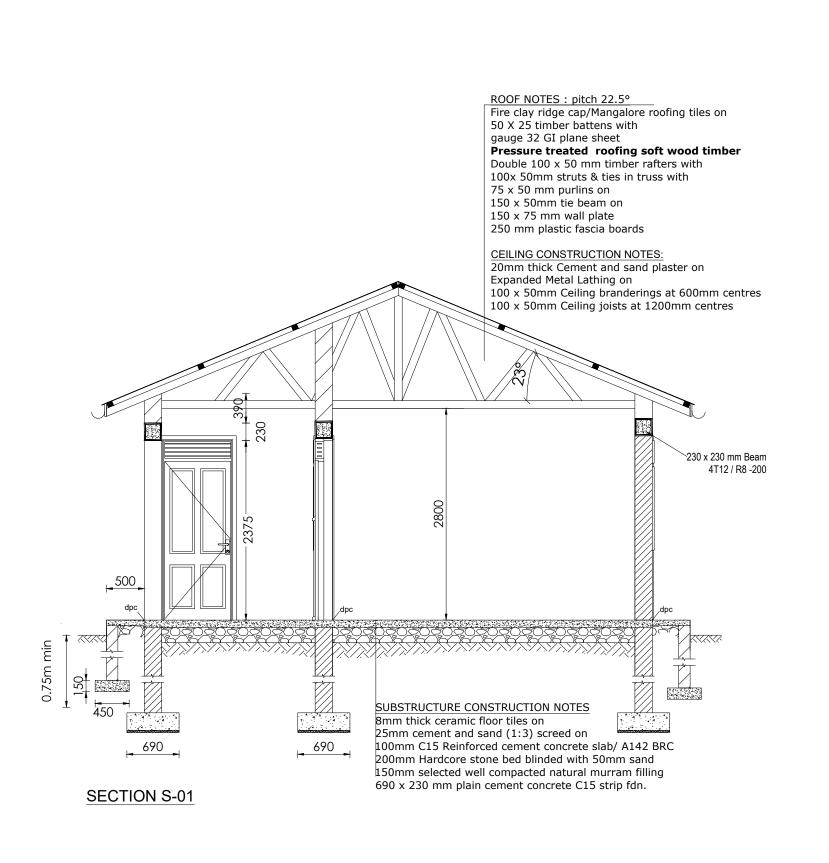

LEGEND



CLIENT :



THE REPUBLIC OF UGANDA
MINISTRY OF WATER AND ENVIRONMENT

CO-FINANCED BY:



CONSULTANT:



Alliance Consultants Itd

Infra-Consult Ltd

PROJEC


ALA-ORA WATER SUPPLY AND SANITATION PROJECT

ENYAU WATER SUPPLY AND SANITATION SYSTEM

REVISIONS:			
No	Date	Description	

DRAWING TITLE: ADMINISTRATION BLOCK
Section

Surveyed by:			
, ,	R.K		
Drawn by:			
,	A.K		
Designed by:			_
-	W.G.M		
Checked by:			
,	J.K.K		
Date:			
	January 2023		
DRG. No.:	ENIX 14/E	D 040	
	ENY-WT	P-013	
Scale:	Sheet No.:		_
1:50		2 of 5	

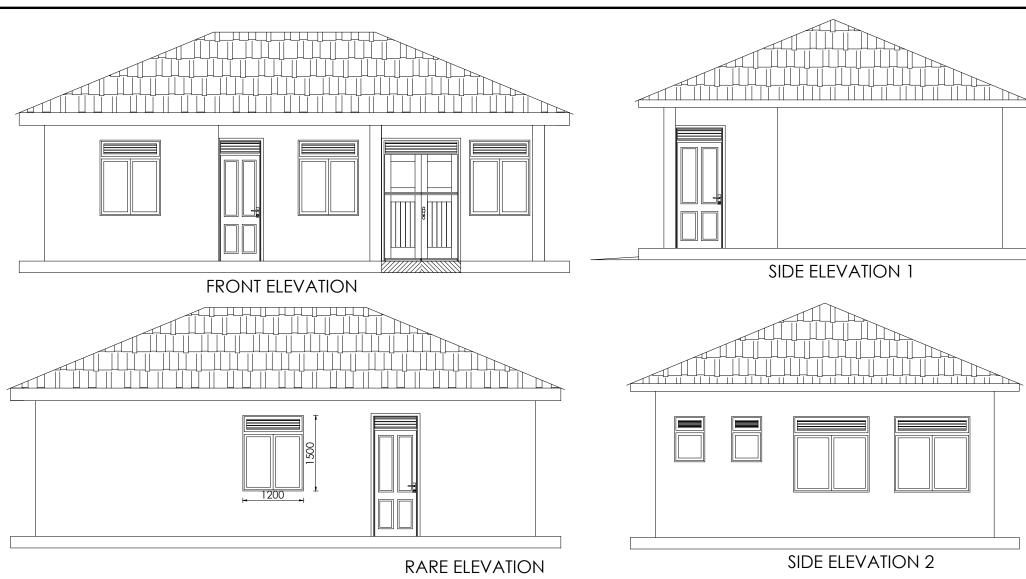

DOOR SCHEDULE			WINDOW SCHEDULE				
Item	D1	D2	D3	Item	Window (W1)	Window (W2)	Window (W3)
Size	900 X 2400	800X 2400	1500 X 2400	Size	1500 X 1500	1200 X 1500	600 X 900
Number	2	2	1	Number	1	4	2
3D Symbol	2100	2100	1500	3D Symbol Description	Double sash		Top Hung metallic casement
Description	Single leaf wooden paneled door	Single leaf wooden paneled door	Double leaf metallic door		panes to be ≤ 0.2n		le with 175v300mm nit
DASCEDUM - I DAUMA IOSE MAESII		Double lear metallic door	• Burgla	r proofing to be of	า ⁻ i a 25x3mm flat bar grill be fitted with mosquito		

sandwiched with coffeetray mesh.

All metallic window & Door sections to be 3.0mm minimum thickness





CLIENT :



THE REPUBLIC OF UGANDA MINISTRY OF WATER AND ENVIRONMENT

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CONSULTANT



Alliance Consultants Itd


ALA-ORA WATER SUPPLY AND SANITATION PROJECT


ENYAU WATER SUPPLY AND SANITATION SYSTEM

REVISIONS:			
No	Date	Description	

DRAWING TITLE: ADMINISTRATION BLOCK Elevations

Surveyed by:	
ourroyou by.	R.K
	N.N
Drawn by:	
	A.K
D ! 1 l	7
Designed by:	
	W.G.M
Checked by:	
Checked by.	LIVIV
	J.K.K
Date:	
	January 2023
DD0 11	oundary 2020
DRG. No.:	CNIV MITD 042
	ENY-WTP-013
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MINISTRY OF WATER AND ENVIRONMENT
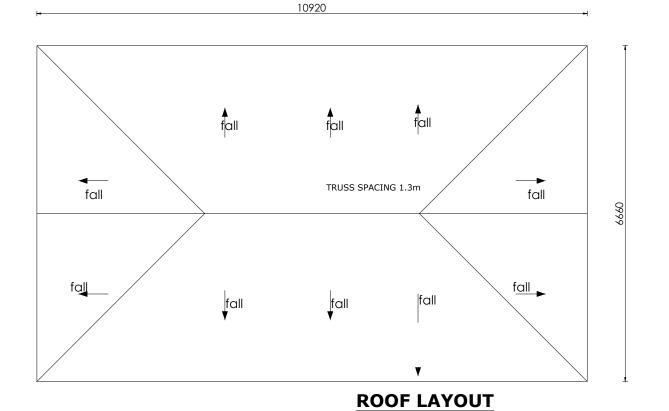
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Infra-Consult I td

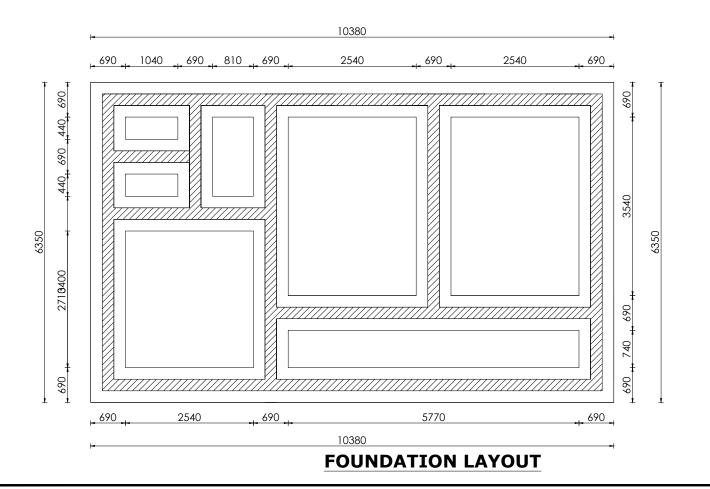PROJECT :


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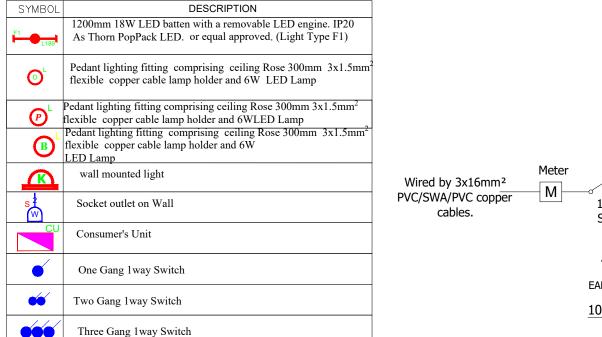
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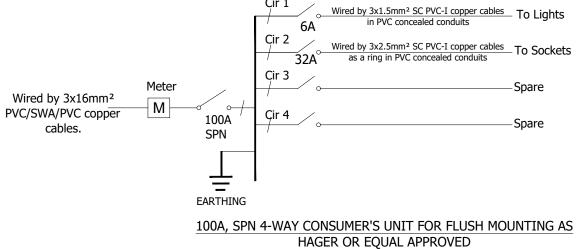
REVISIONS:				
No	Date	Description		

DRAWING TITLE: **ADMINISTRATION BLOCK**Foundation & Roof Layout

Surveyed by:	
, ,	R.K
Drawn by:	
	A.K
Designed by:	
,	W.G.M
Checked by:	
,	J.K.K
Date:	
	January 2023
DRG. No.:	
	ENY-WTP-013
Scale:	Sheet No.:
1:75	4 of 5





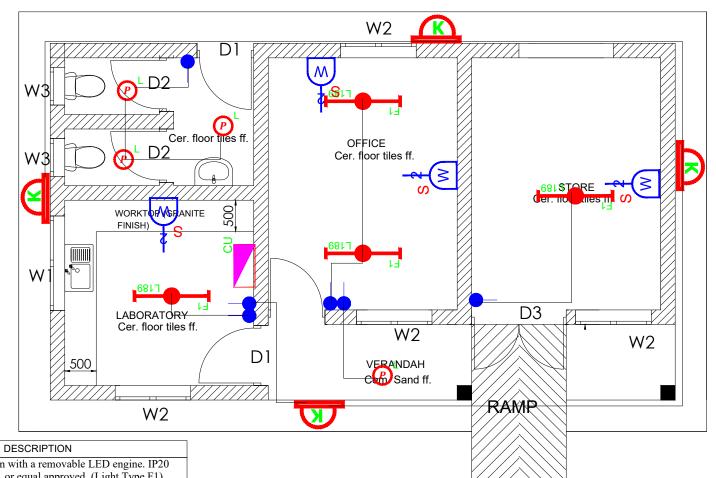





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MINISTRY OF WATER AND ENVIRONMENT

CO-FINANCED BY:



CONSULTANT :



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PROJECT


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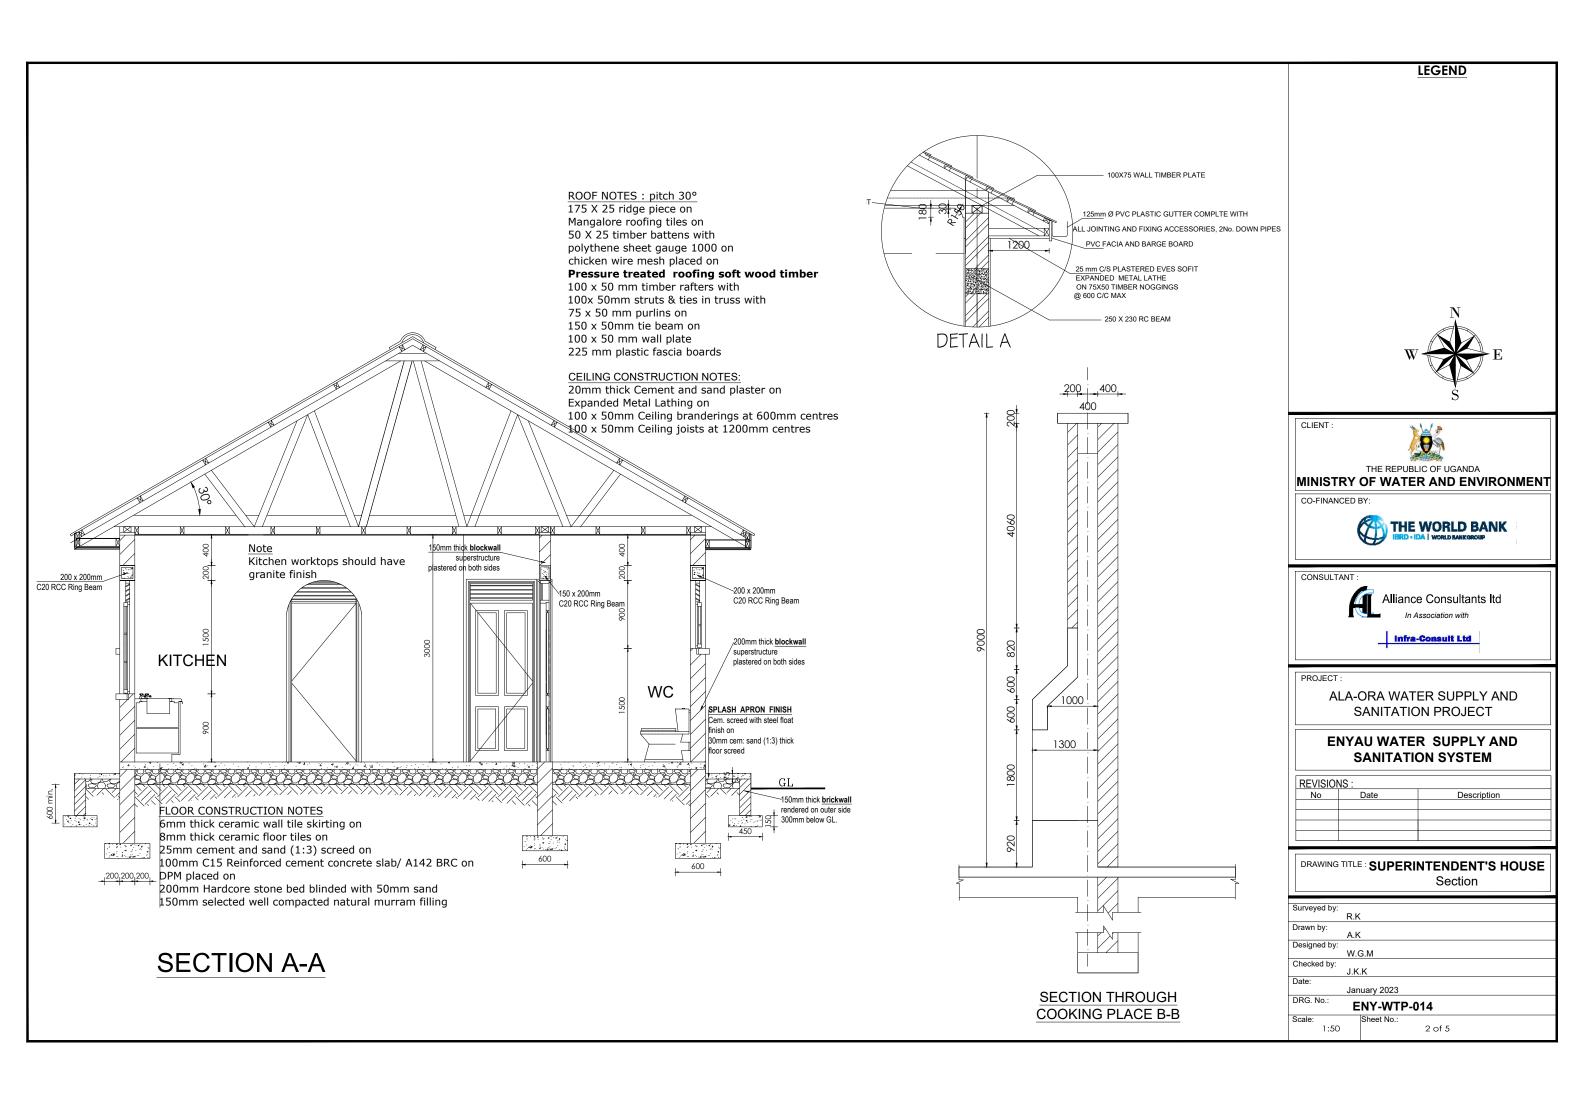
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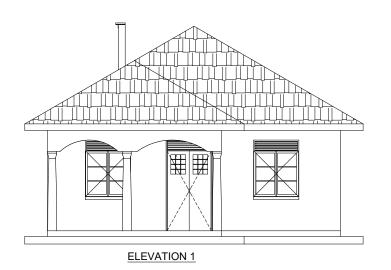
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No	Date	Description	


DRAWING TITLE: ADMINISTRATION BLOCK
Electrical Layout


Surveyed by:		
Drawn by:	P.K	
Designed by:	P.K	
Checked by:	S.C.D	
Date:	January 2023	
DRG. No.:	ENY-WT	P-013
Scale: 1:60	Sheet No.:	5 of 5





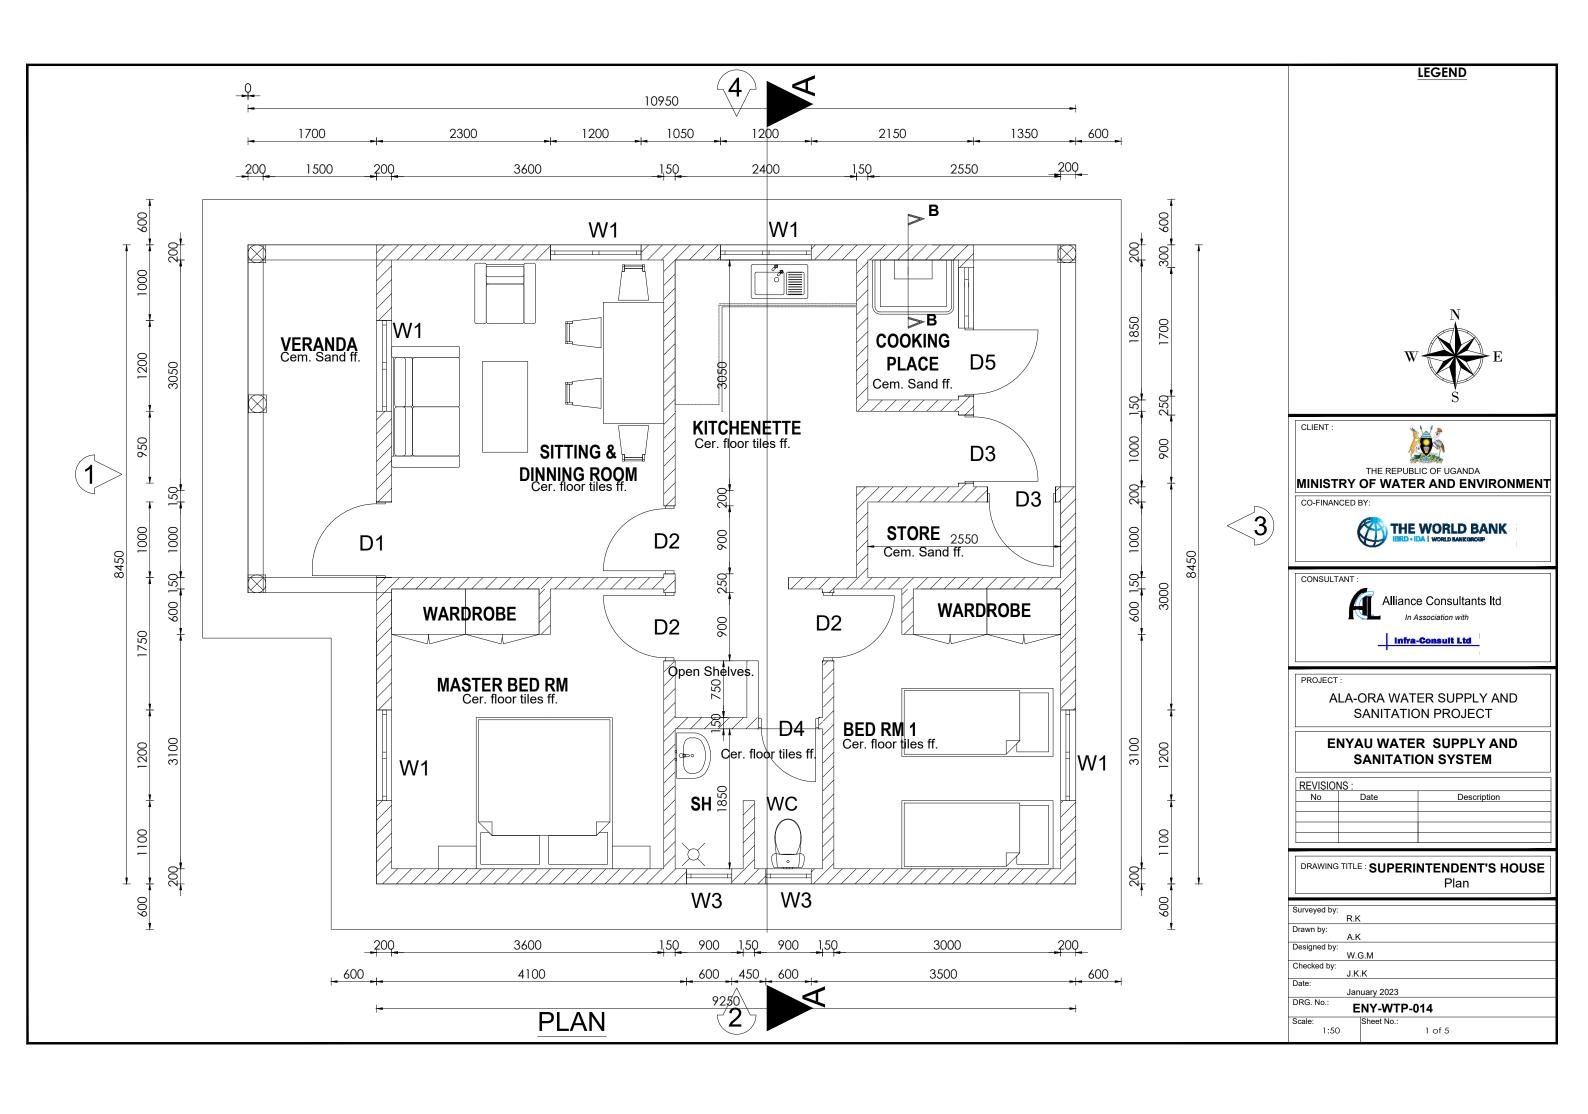

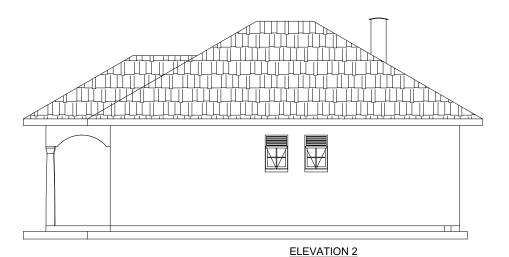

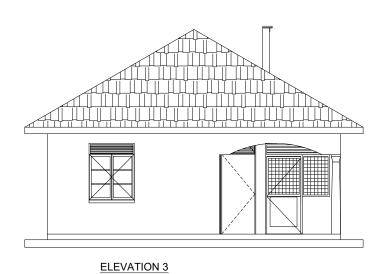



All metallic window & Door sections to be 3.0mm minimum thickness

Door Schedule Window Schedule Door Name D1 D2 D3 D4 D5 Window Name W1 W2 3 Quantity 2 Quantity 3 W x H Size 800x2400 W x H Size 600x900 1000x2400 900x2400 900x2400 900x2400 1200x1500 **Elevation View Elevation View** Double Sash Glazed Top Hung Metalic

Metalic Casement Glass panes to be ≤ 0.2m Single Leaf Half Single Leaf half steel plate door with metallic Burglar proofing to be of a 25x3mm flat bar grille with 175x300mm pitch. Single Leaf Metalic Single Leaf Woode Glazed/ Half Steel Permanent Vents are to be fitted with mosquito proofing nets i.e plastic net plate Door Paneled Door sandwiched with coffeetray mesh.

LEGEND



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ALA-ORA WATER SUPPLY AND SANITATION PROJECT


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REVISIO	NS:				
No	Date	Description			

DRAWING TITLE: SUPERINTENDENT'S HOUSE Elevations

Surveyed by:				
	R.K			
Drawn by:				
•	A.K			
Designed by:				
	W.G	i.M		
Checked by:				
•	J.K.I	K		
Date:				
	Janu	uary 2023		
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1:100			3 of 5	

TRUSS SPACING 1.3m fall fall



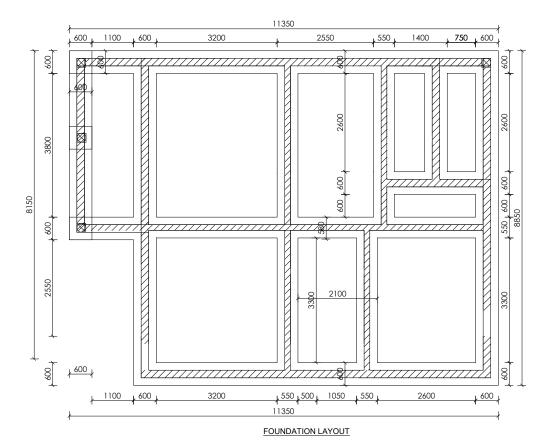



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PROJEC


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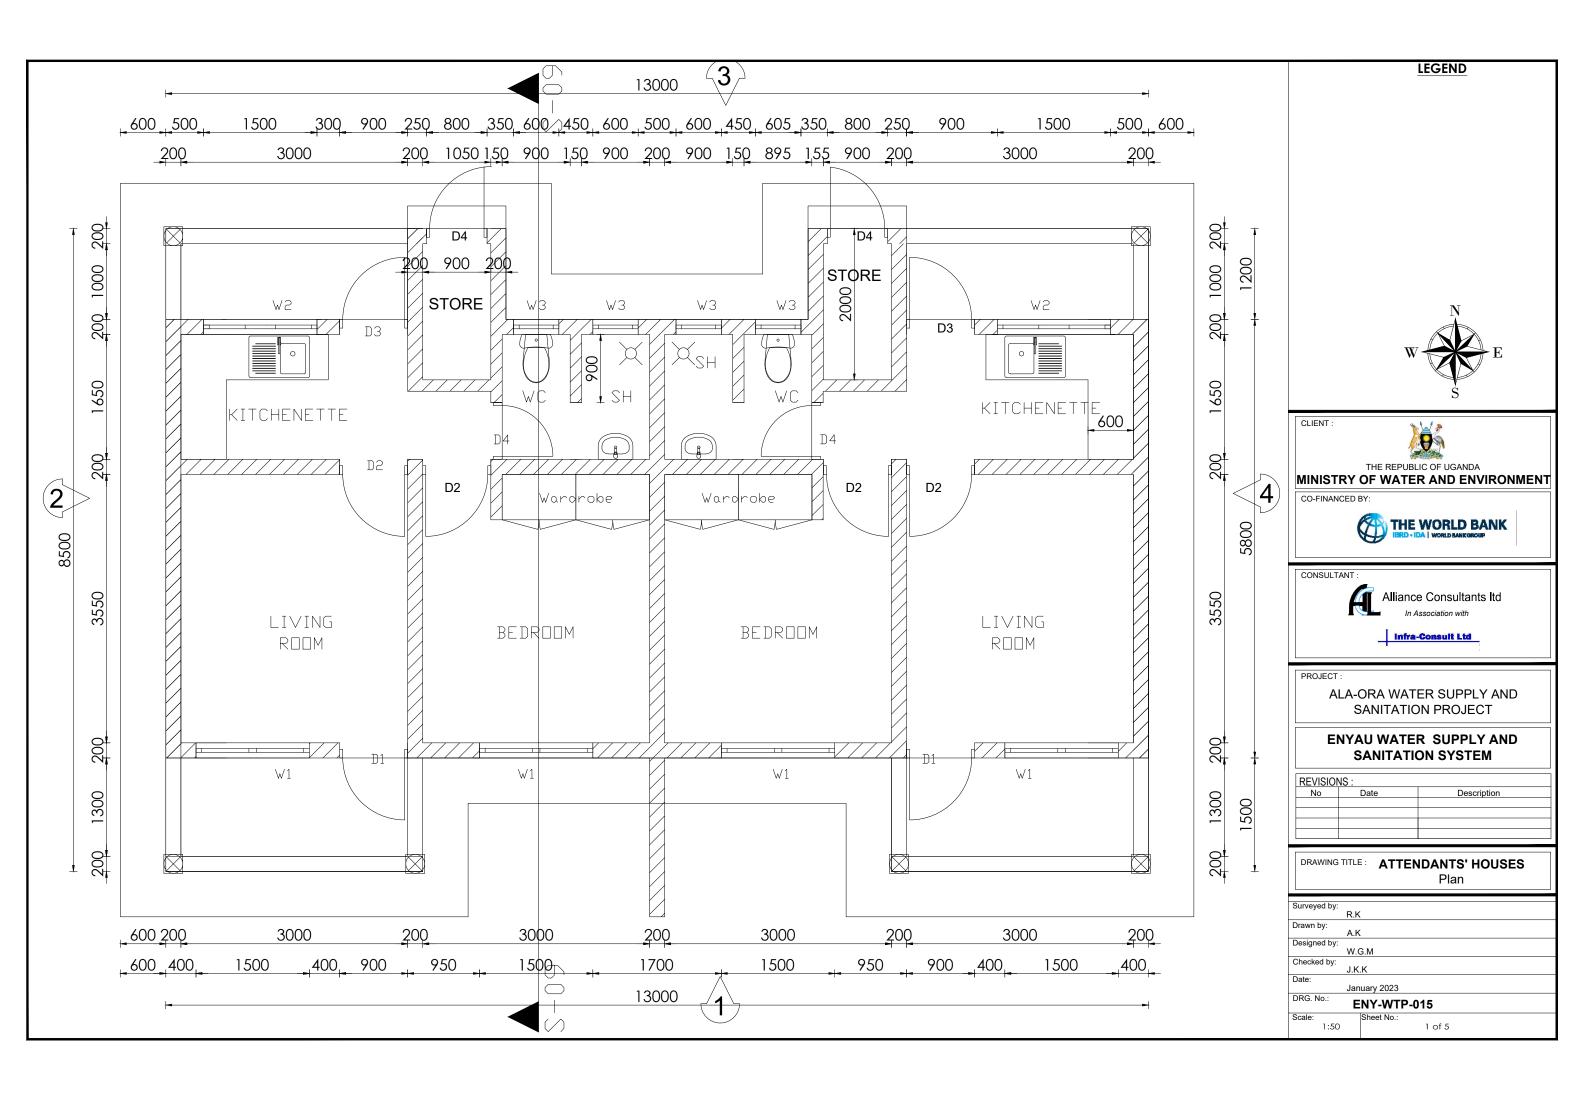
ENYAU WATER SUPPLY AND SANITATION SYSTEM


REVISIO	REVISIONS:			
No	Date	Description		

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Surveyed by:	
, ,	R.K
Drawn by:	
,	A.K
Designed by:	
,	W.G.M
Checked by:	
,	J.K.K
Date:	
	January 2023
DRG. No.:	END/14/ED 04.4
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1:100	4 of 5





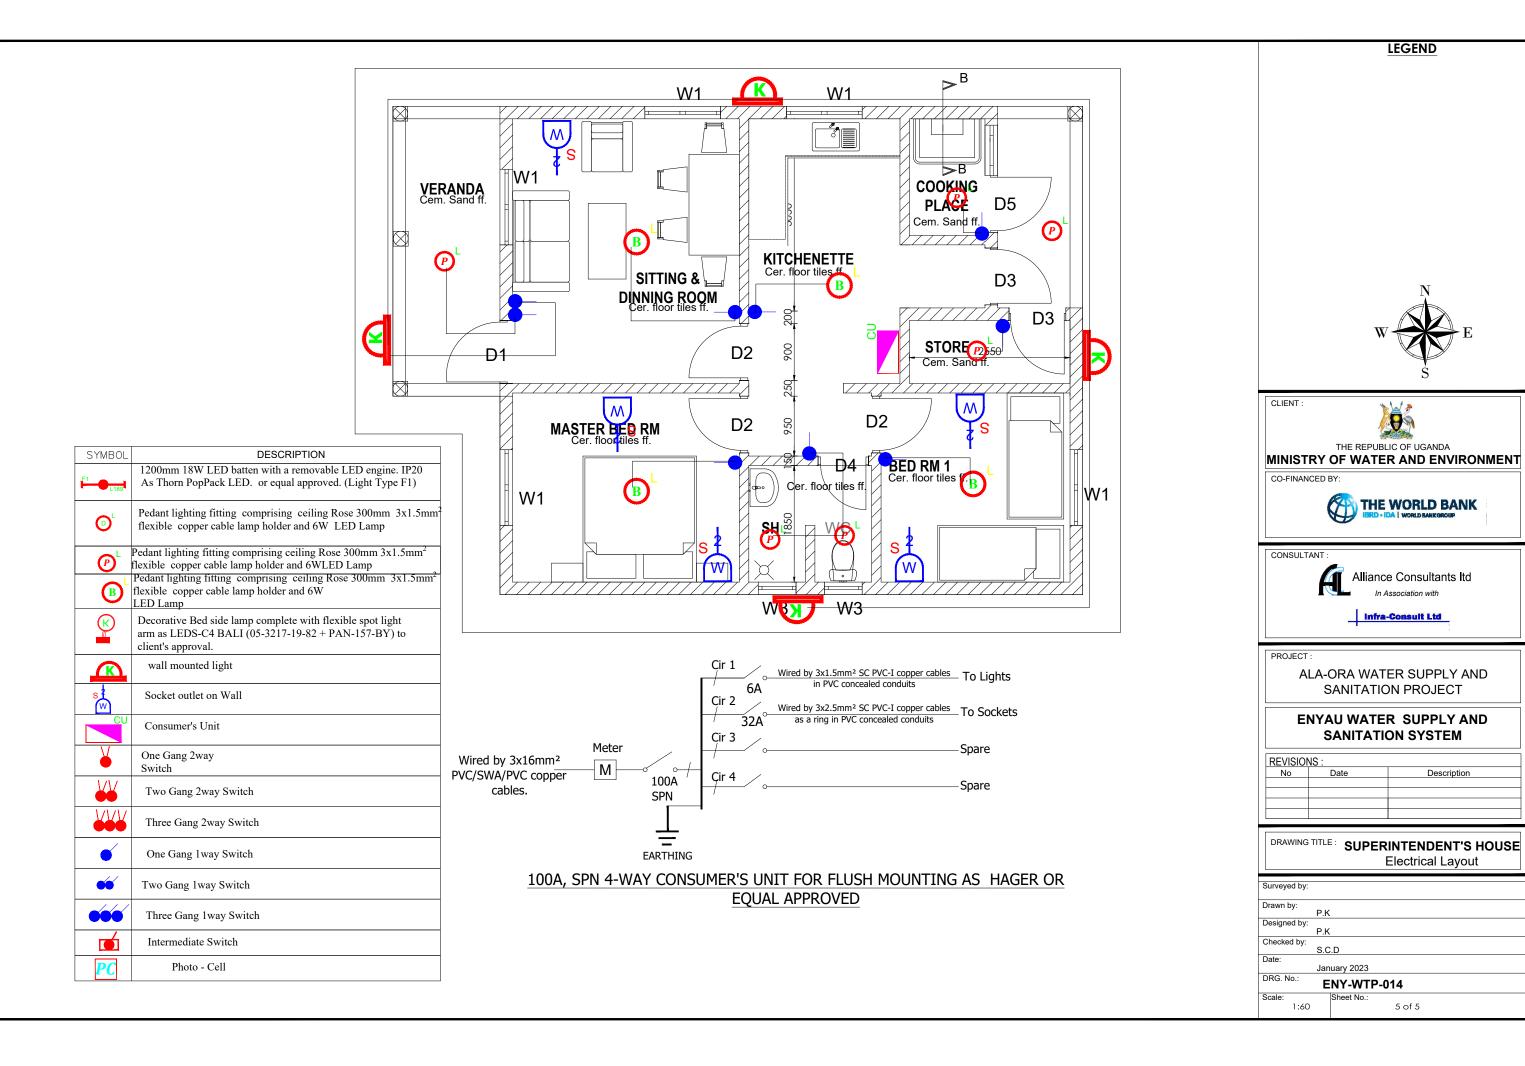

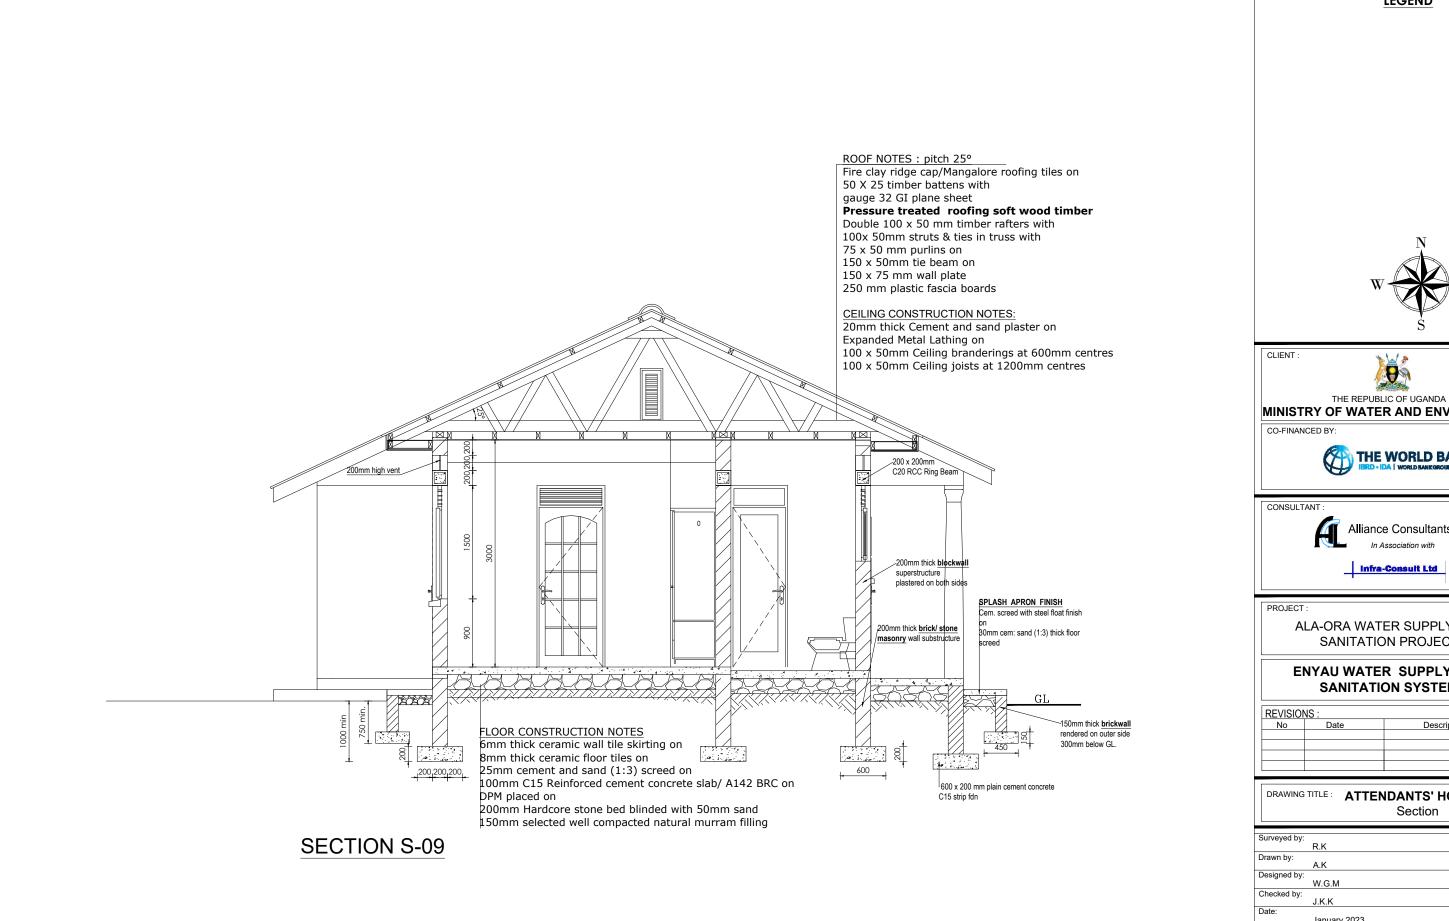





MINISTRY OF WATER AND ENVIRONMENT



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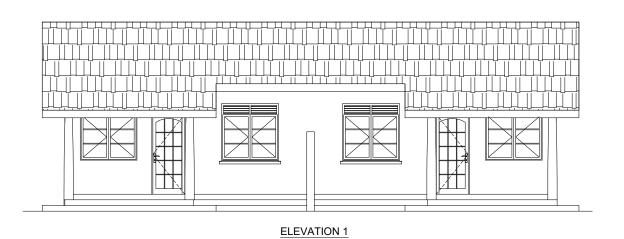
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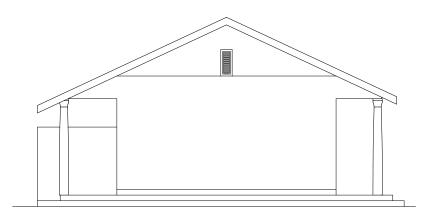
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REVISIONS:				
No	Date	Description		
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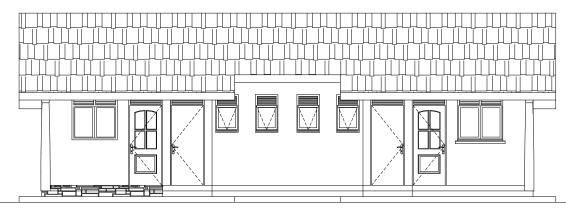
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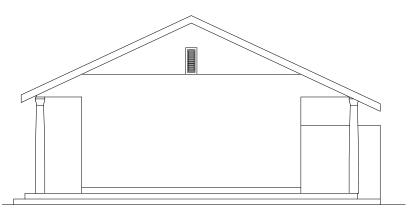
Surveyed by:	
, ,	R.K
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,	A.K
Designed by:	
-	W.G.M
Checked by:	
•	J.K.K
Date:	
	January 2023
DRG. No.:	ENV MED A45
	ENY-WTP-015
Scale:	Sheet No.:
1:50	2 of 5





ELEVATION 2





ELEVATION 4 ELEVATION 3

Door Schedule				
Door Name	D1	D2	D3	D4
Quantity	2	4	2	2
W x H Size	1000x2400	900x2400	900x2400	800x2400
Elevation View	Single Leaf Metalic Casement Door	Single Leaf Wooden Paneled Door	Single Leaf Half Glazed/ Half Steel plate Door	Single Leaf Wooden Paneled Door

	Window Schedule		
	Window Name	W1	W2
	Quantity	6	4
00	W x H Size	1500x1500	600x900
	Elevation View	Double Sash Glazed	Top Hung Metalic
	NR	Metalic Casement	Casement

- Glass panes to be ≤ 0.2m²
- Burglar proofing to be of a 25x3mm flat bar grille with 175x300mm pitch. Permanent Vents are to be fitted with mosquito proofing nets i.e plastic net sandwiched with coffeetray mesh.
- All window & Door sections to be 3.0mm minimum thickness

LEGEND



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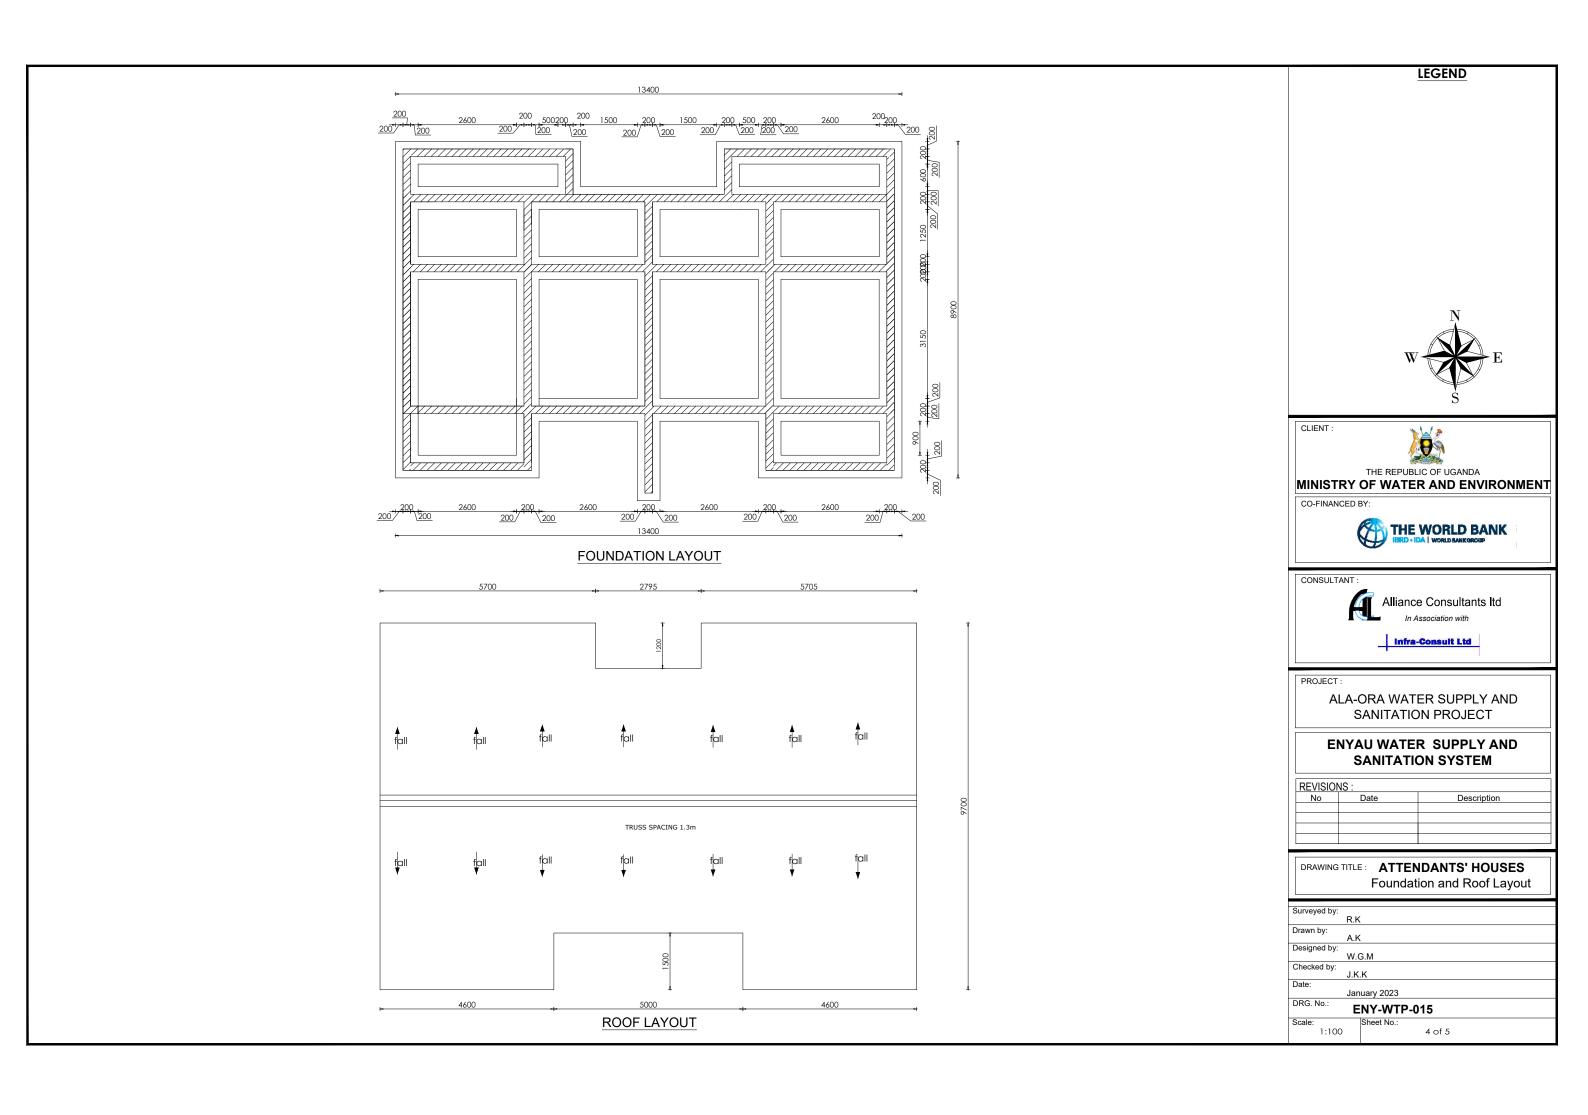
ALA-ORA WATER SUPPLY AND SANITATION PROJECT


ENYAU WATER SUPPLY AND SANITATION SYSTEM

REVISIONS:			
No	Date	Description	
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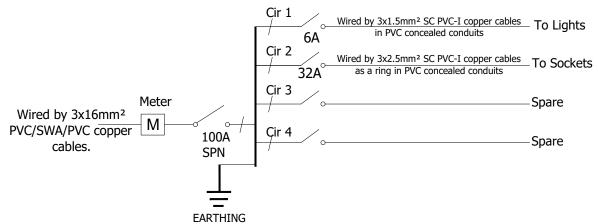
DRAWING TITLE: ATTENDANTS' HOUSES Elevations

Surveyed by:	
, ,	R.K
Drawn by:	
Diam. Dy.	A.K
Designed by:	
o ,	W.G.M
Checked by:	
,	J.K.K
Date:	
	January 2023
DRG. No.:	
	ENY-WTP-015
Scale:	Sheet No.:
1:100	3 of 5



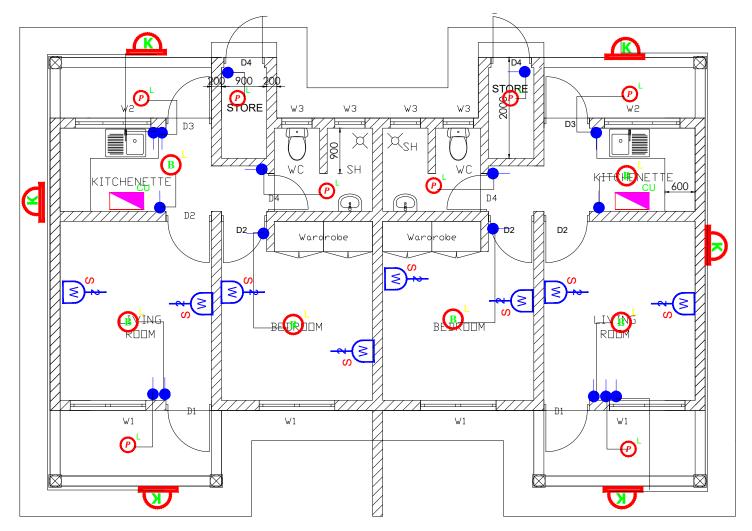

SYMBOL	DESCRIPTION
F1 L189	1200mm 18W LED batten with a removable LED engine. IP20 As Thorn PopPack LED. or equal approved. (Light Type F1)
© ^L	Pedant lighting fitting comprising ceiling Rose 300mm 3x1.5mm flexible copper cable lamp holder and 6W LED Lamp
	Pedant lighting fitting comprising ceiling Rose 300mm 3x1.5mm ² flexible copper cable lamp holder and 6WLED Lamp
B	Pedant lighting fitting comprising ceiling Rose 300mm 3x1.5mm ² flexible copper cable lamp holder and 6W LED Lamp
K	Decorative Bed side lamp complete with flexible spot light arm as LEDS-C4 BALI (05-3217-19-82 + PAN-157-BY) to client's approval.
<u> </u>	wall mounted light
s‡ W	Socket outlet on Wall
CU	Consumer's Unit
¥	One Gang 2way Switch
W.	Two Gang 2way Switch
MAN	Three Gang 2way Switch
•	One Gang 1way Switch
«	Two Gang Iway Switch
666	Three Gang Iway Switch
	Intermediate Switch
PC	Photo - Cell



100A, SPN 4-WAY CONSUMER'S UNIT FOR FLUSH MOUNTING AS HAGER OR EQUAL APPROVED

LEGEND



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PROJEC1


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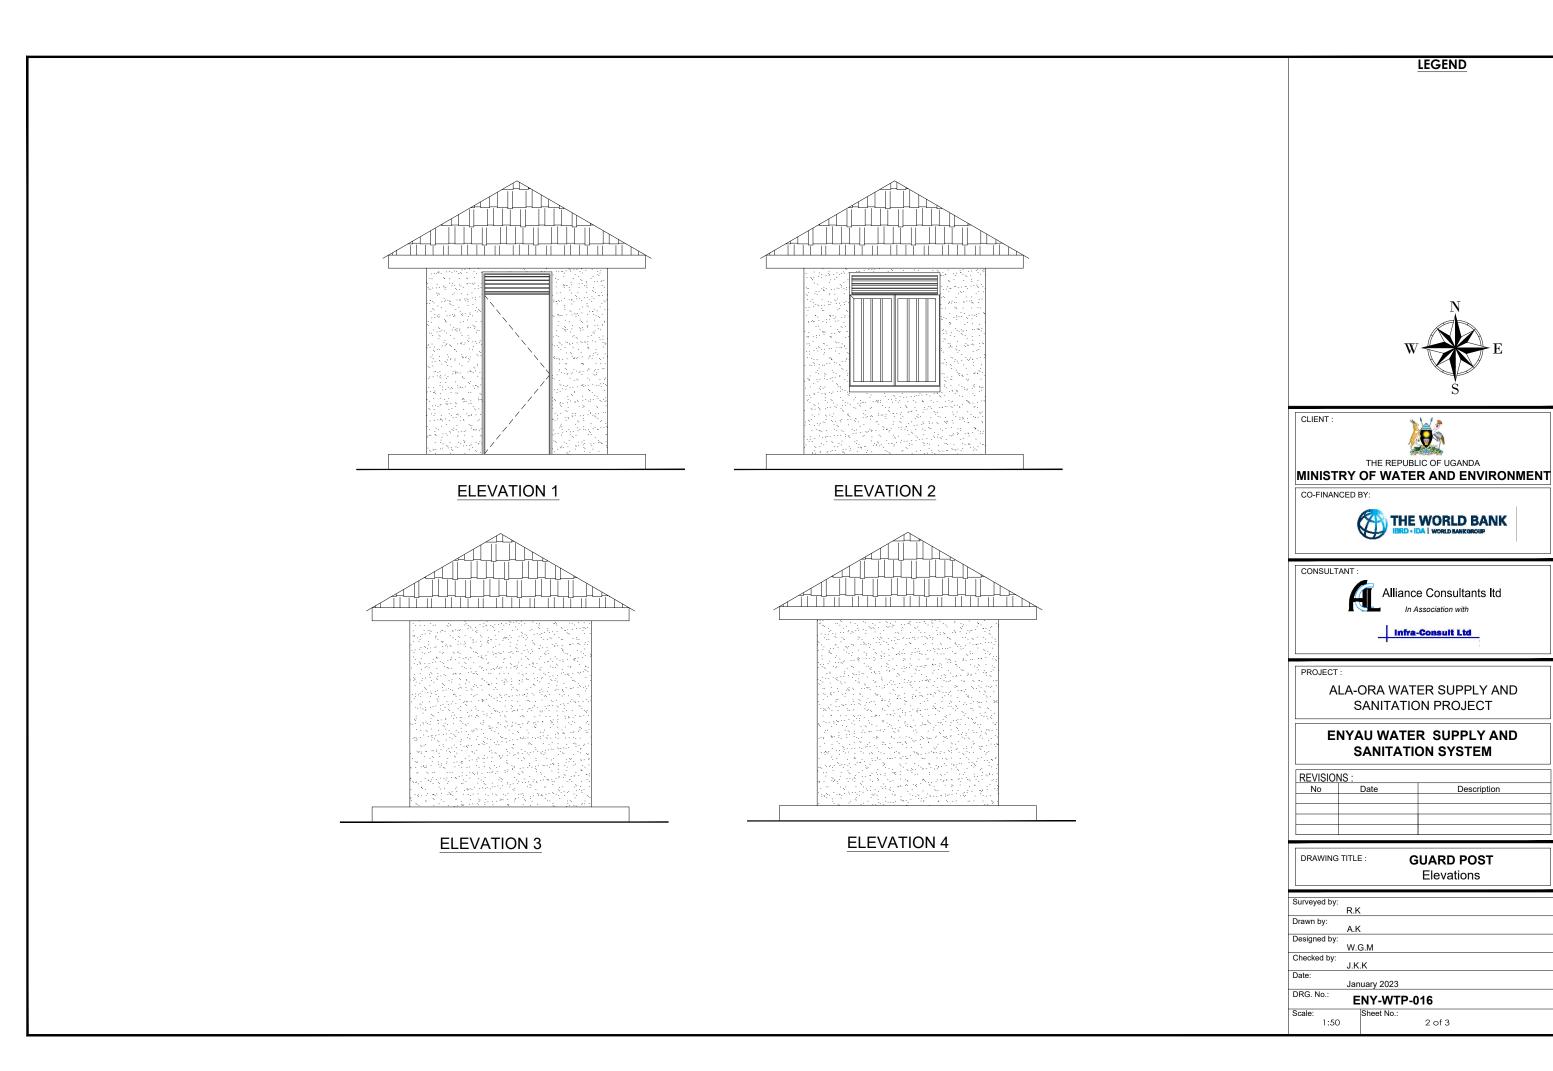
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REVISIONS:			
	No	Date	Description


DRAWING TITLE: ATTENDANTS' HOUSES
Electrical Layout


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Drawn by:	P.K
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Checked by:	S.C.D
Date:	January 2023
DRG. No.:	ENY-WTP-015
Scale: 1:75	Sheet No.: 5 of 5




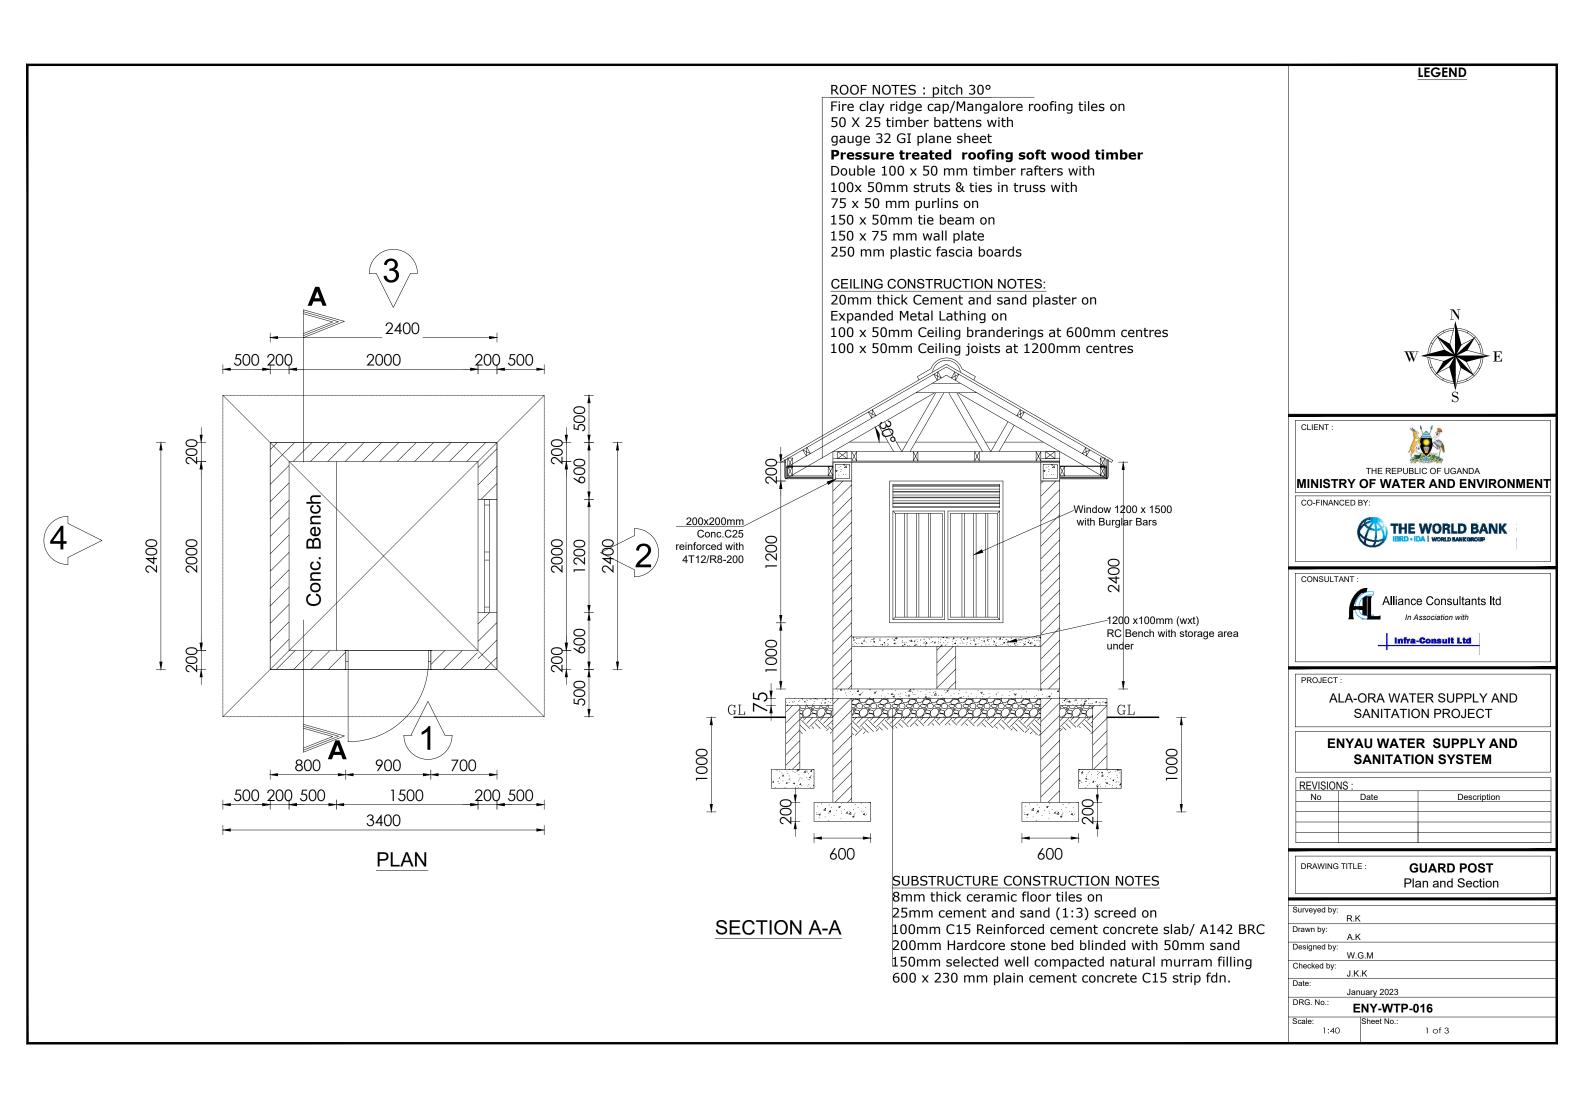

Description

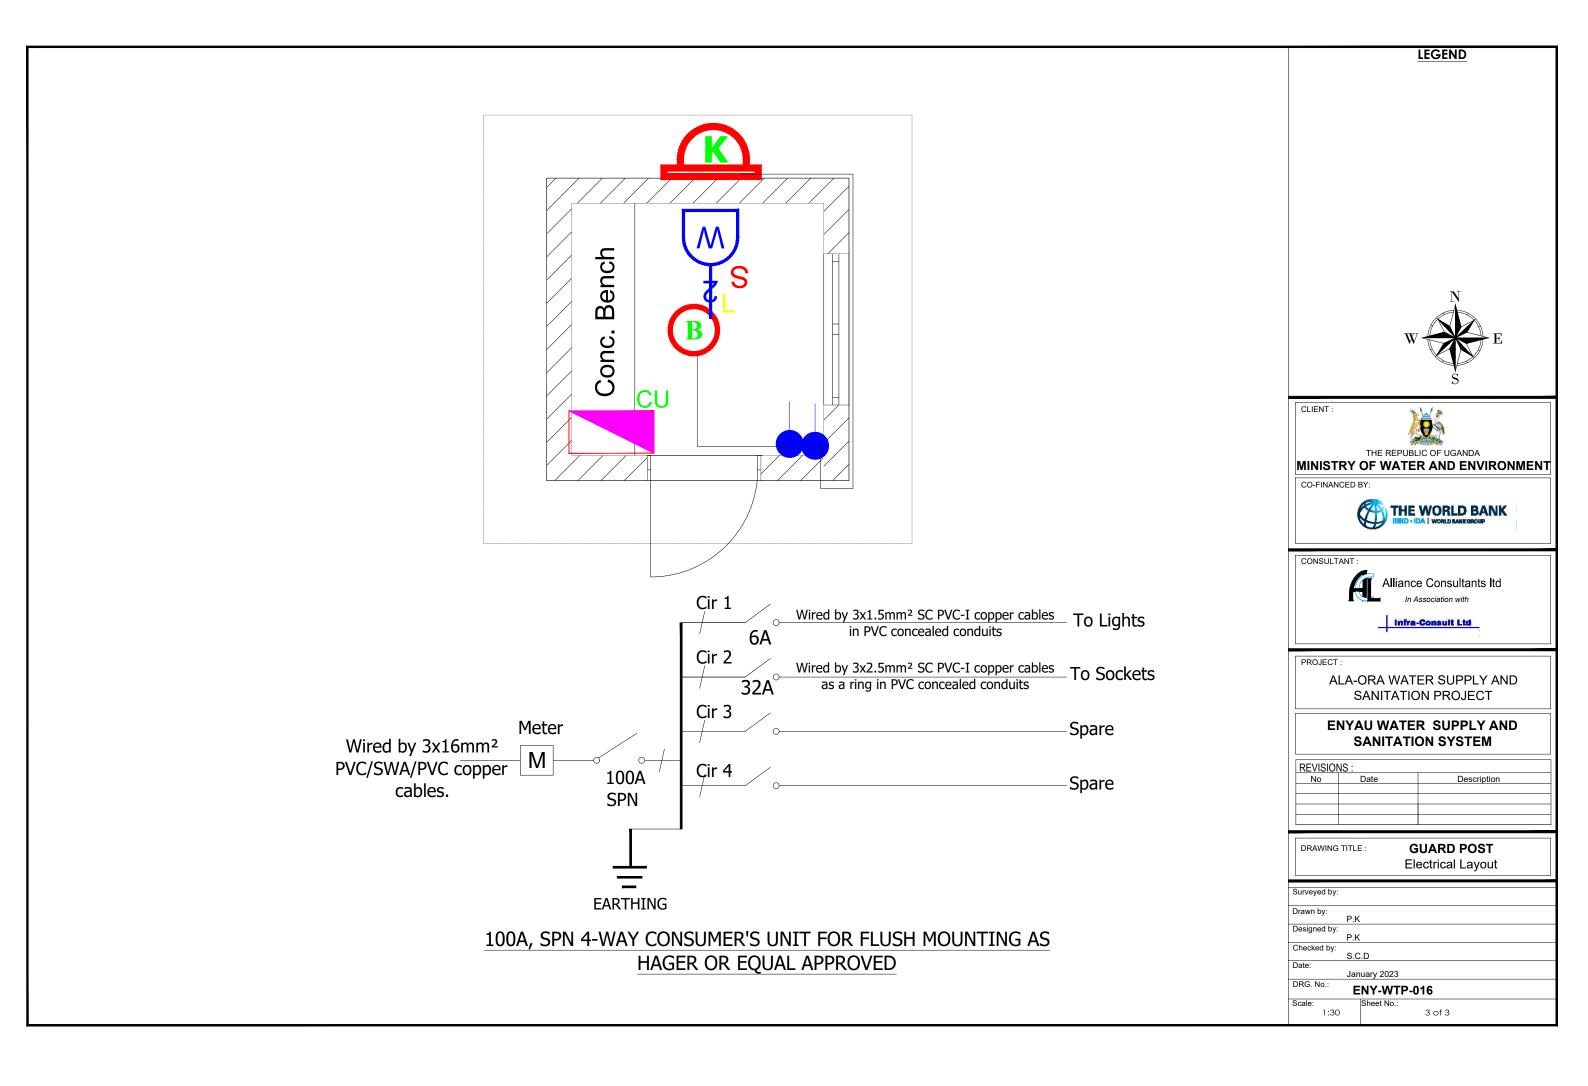

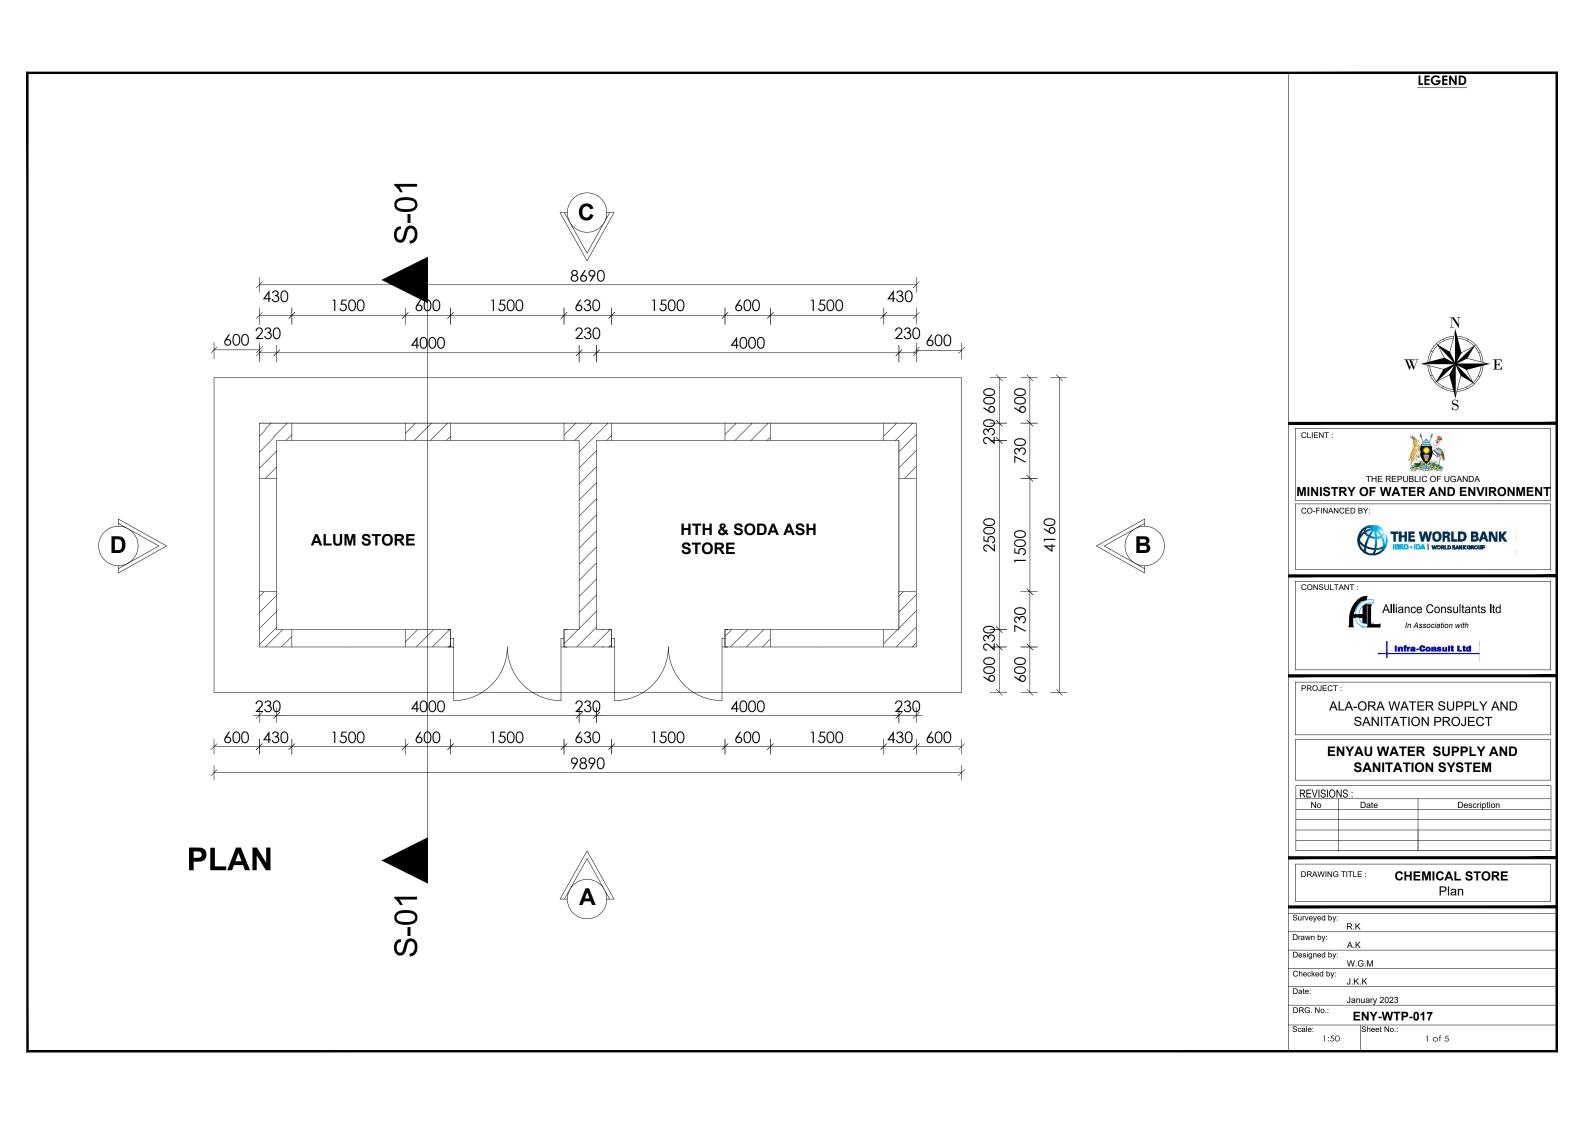

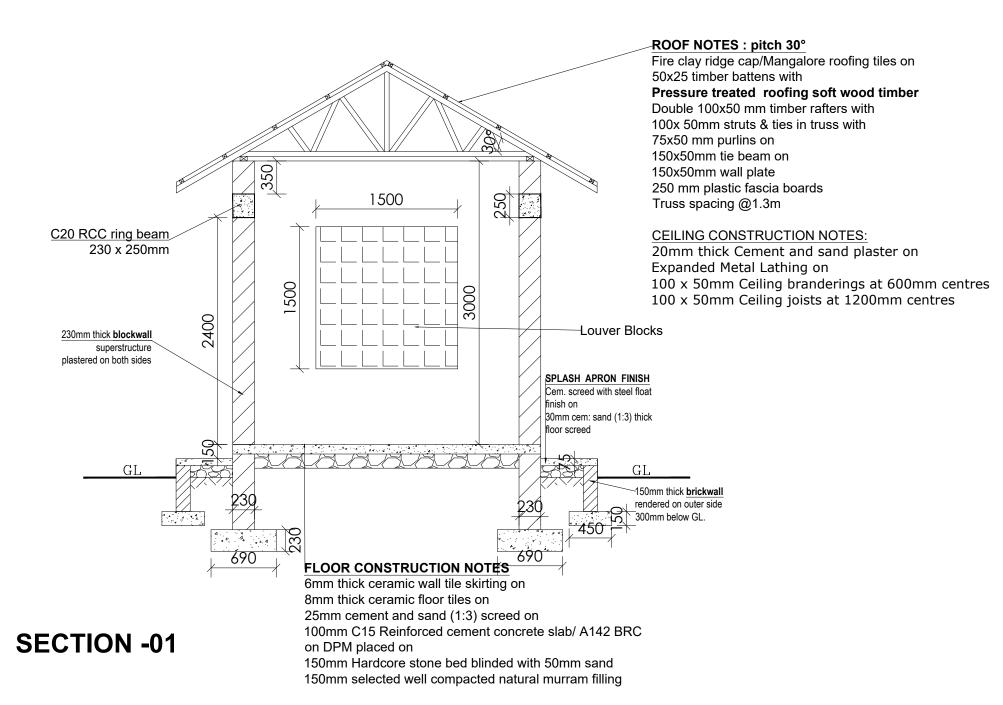

LEGEND



CLIENT :



THE REPUBLIC OF UGANDA
MINISTRY OF WATER AND ENVIRONMENT

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CONSULTANT :



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PRO IECT

ALA-ORA WATER SUPPLY AND SANITATION PROJECT

ENYAU WATER SUPPLY AND SANITATION SYSTEM

REVISIONS:		
No	Date	Description

DRAWING TITLE: CHEMICAL STORE
Sections

Surveyed by:

R.K

Drawn by:

A.K

Designed by:

W.G.M

Checked by:

J.K.K

Date:

January 2023

DRG. No.:


ENY-WTP-017

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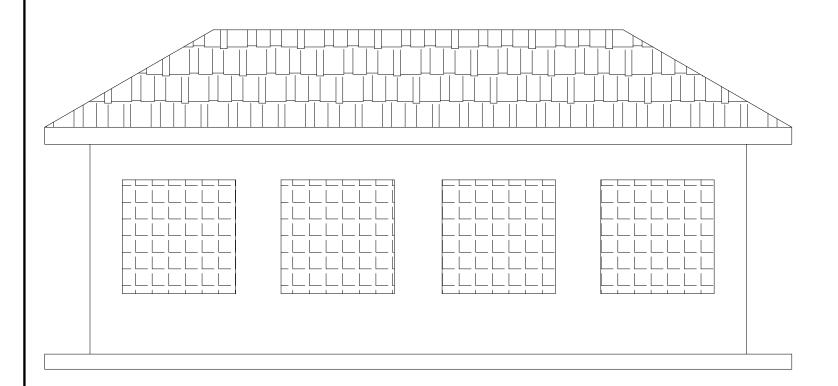
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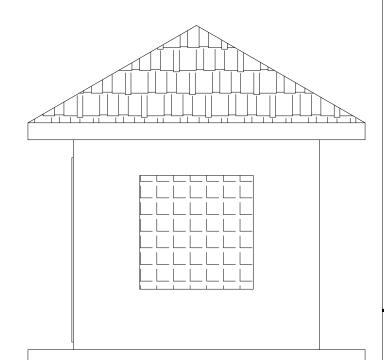
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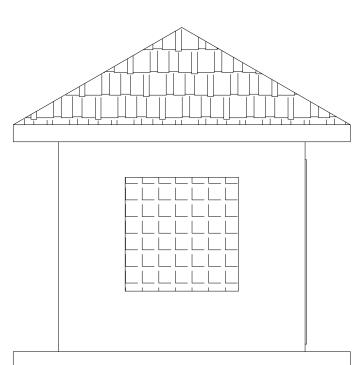
ELEVATION - A



ELEVATION - C

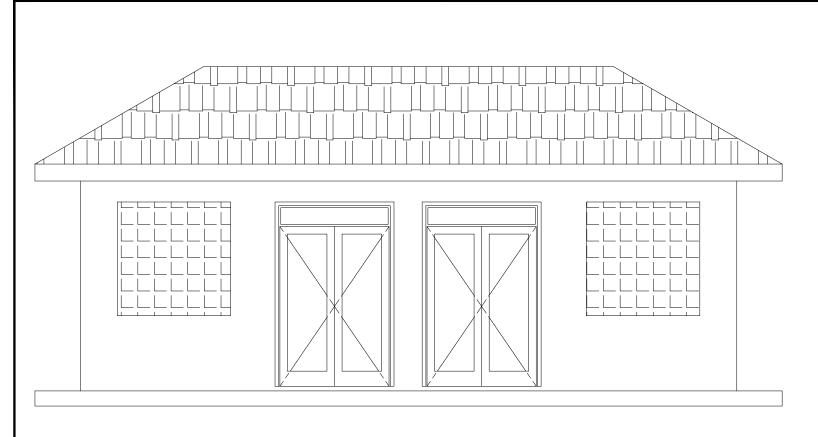

ELEVATION - B



ELEVATION - D



LEGEND





ALA-ORA WATER SUPPLY AND SANITATION PROJECT

ENYAU WATER SUPPLY AND SANITATION SYSTEM


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No	Date	Description

CHEMICAL STORE

DRAWING TITLE :

	Lievations
Surveyed by:	D.V.
	R.K
Drawn by:	A.K
	A.N
Designed by:	
	W.G.M
Checked by:	
,	J.K.K
Date:	
	January 2023
DRG. No.:	ENN/MED 045
	ENY-WTP-017
Scale:	Sheet No.:
1:40	3 of 5

FOUNDATION LAYOUT

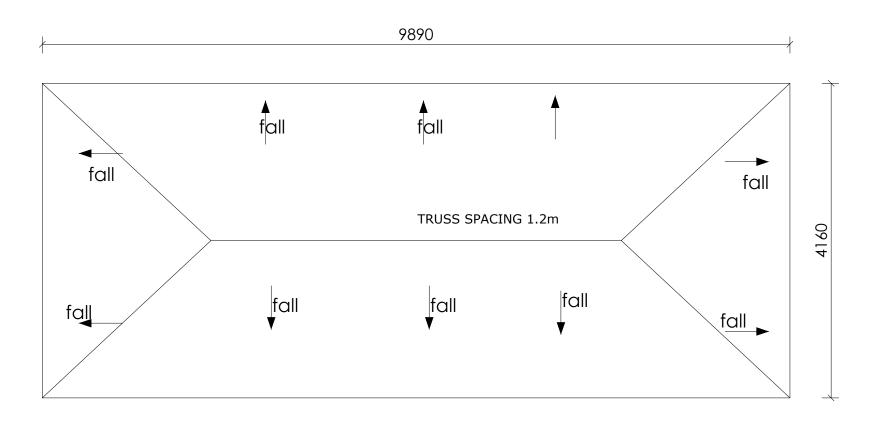

ROOF LAYOUT





CLIENT:



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MINISTRY OF WATER AND ENVIRONMENT

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PROJEC1


ALA-ORA WATER SUPPLY AND SANITATION PROJECT

ENYAU WATER SUPPLY AND SANITATION SYSTEM

REVISIO	NS :	
No	Date	Description
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DRAWING TITLE: CHEMICAL STORE
Foundation and Roof Layout

Surveyed by:	
	R.K
Drawn by:	
,	A.K
Designed by:	
	W.G.M
Checked by:	
•	J.K.K
Date:	
	January 2023
DRG. No.:	ENVIATE AT
	ENY-WTP-017
Scale:	Sheet No.:
1:50	4 of 5

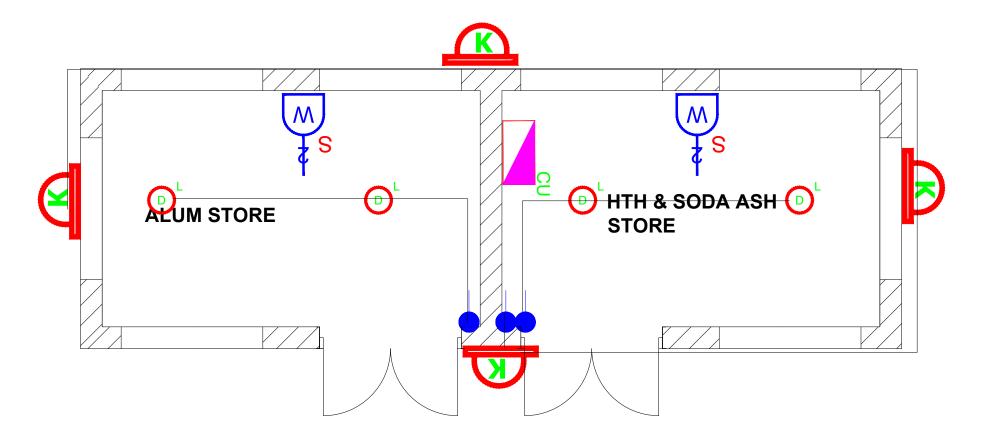

- 1). ALL WALL BRACKETS SHALL BE MOUNTED 1800mm ABOVE FINISHED FLOOR LEVEL
- 2). TELEPHONE, SOCKETS, T.V AND COMPUTER OUTLETS SHALL BE MOUNTED 300mm ABOVE FINISHED FLOOR LEVEL EXCEPT WHERE THEIR IS A WORKTOP.
- 3). WHERE THEIR IS A WORKTOP, TELEPHONE, SOCKETS, T.V AND COMPUTER OUTLETS SHALL BE MOUNTED 150mm ABOVE WORKTOPS.
- 4). CONSUMER UNITS SHALL BE 1800mm ABOVE FINISHED FLOOR LEVEL
- 5). ALL SWITCHES SHALL BE 1400mm ABOVE FINISHED FLOOR LEVEL
- 6). ALL OUTSIDE SOCKETS SHOULD BE WEATHER PROOF
- 7). ALL SHAVER SOCKETS SHOULD BE ON THE RIGHT HAND SIDE OF THE WASH HAND BASIN
- 8). ALL CABLES MUST BE STRANDED

SYMBOL	DESCRIPTION
F1 L189	1200mm 18W LED batten with a removable LED engine. IP20 As Thorn PopPack LED. or equal approved. (Light Type F1)
0	Pedant lighting fitting comprising ceiling Rose 300mm 3x1.5mm flexible copper cable lamp holder and 6W LED Lamp
Ø'	Pedant lighting fitting comprising ceiling Rose 300mm 3x1.5mm ² flexible copper cable lamp holder and 6WLED Lamp
®	Pedant lighting fitting comprising ceiling Rose 300mm 3x1.5mm flexible copper cable lamp holder and 6W LED Lamp
<u>©</u>	Decorative Bed side lamp complete with flexible spot light arm as LEDS-C4 BALI (05-3217-19-82 + PAN-157-BY) to client's approval.
	wall mounted light
<u></u>	Socket outlet on Wall
CU	Consumer's Unit
¥	One Gang 2way Switch
W	Two Gang 2way Switch
MAX	Three Gang 2way Switch
•	One Gang Iway Switch
«	Two Gang Iway Switch
₩	Three Gang Iway Switch
重	Intermediate Switch
PC	Photo - Cell

CLIENT :



MINISTRY OF WATER AND ENVIRONMENT

CO-FINANCED BY:



CONSULTANT



Alliance Consultants Itd

Infra-Consult Ltd

PROJEC


ALA-ORA WATER SUPPLY AND SANITATION PROJECT

ENYAU WATER SUPPLY AND SANITATION SYSTEM


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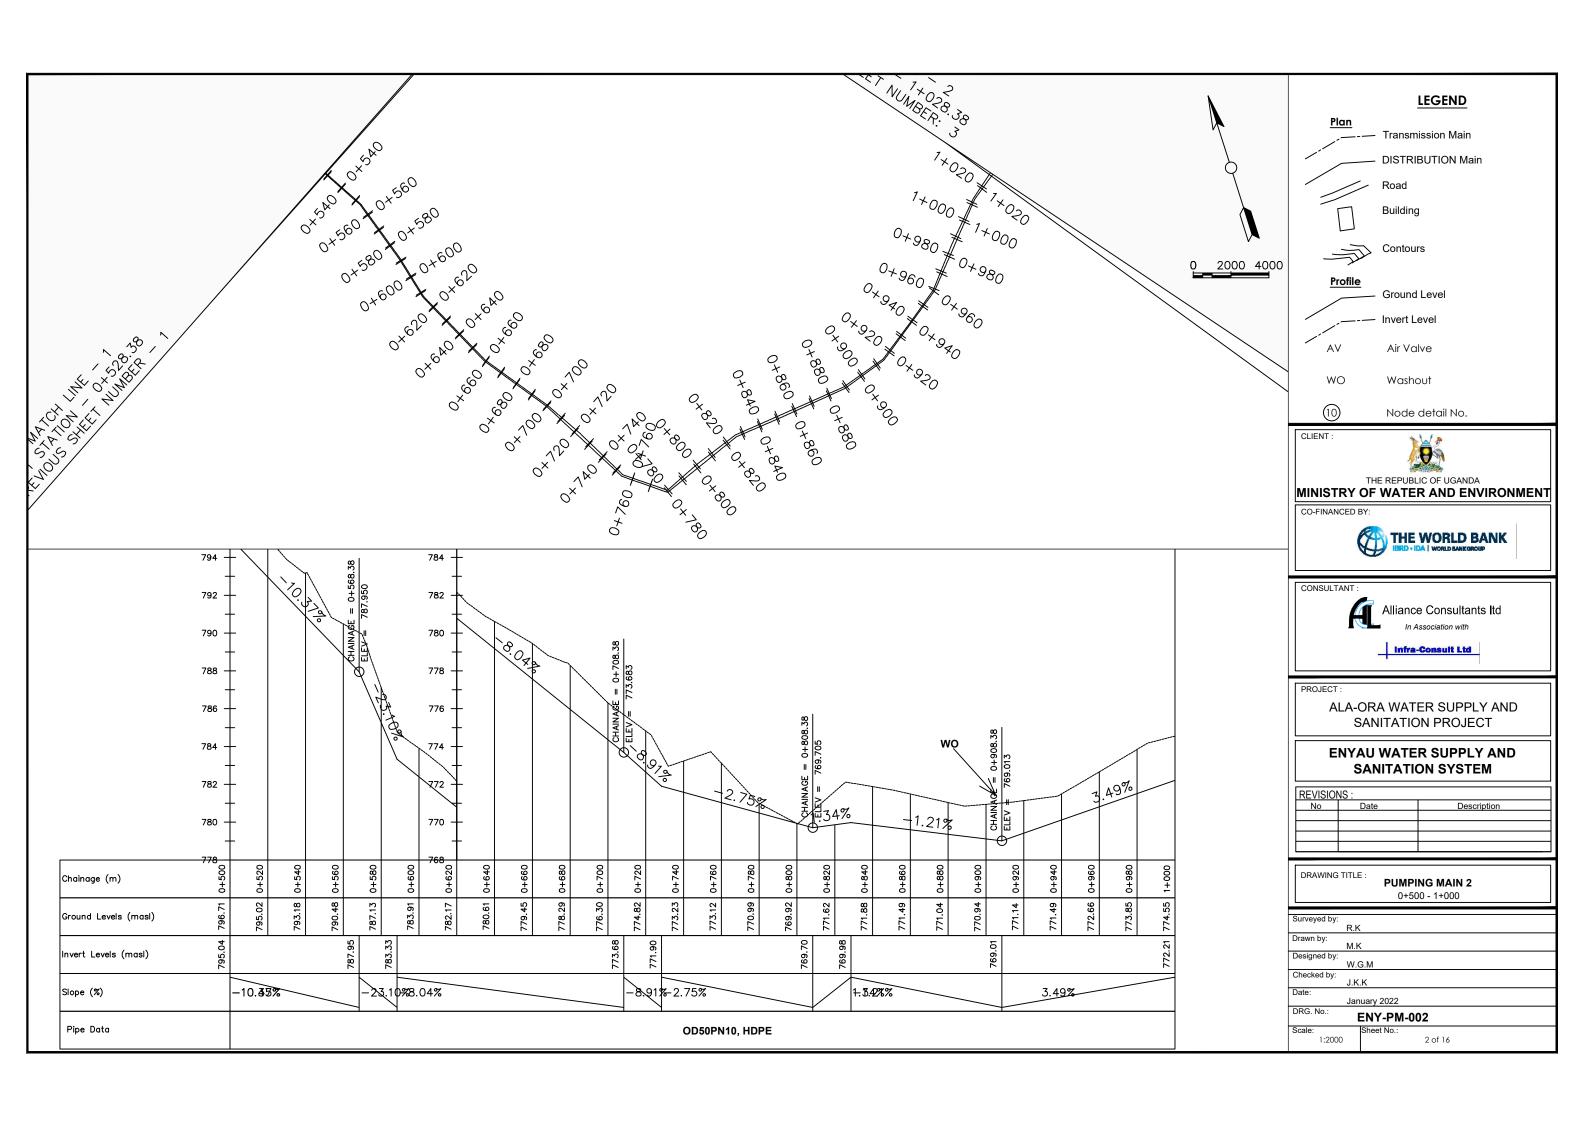
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Foundation and Roof Layout


Surveyed by:	
, ,	R.K
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Date:	
	January 2023
DRG. No.:	ENVIATE ALT
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Scale:	Sheet No.:
1:50	5 of 5

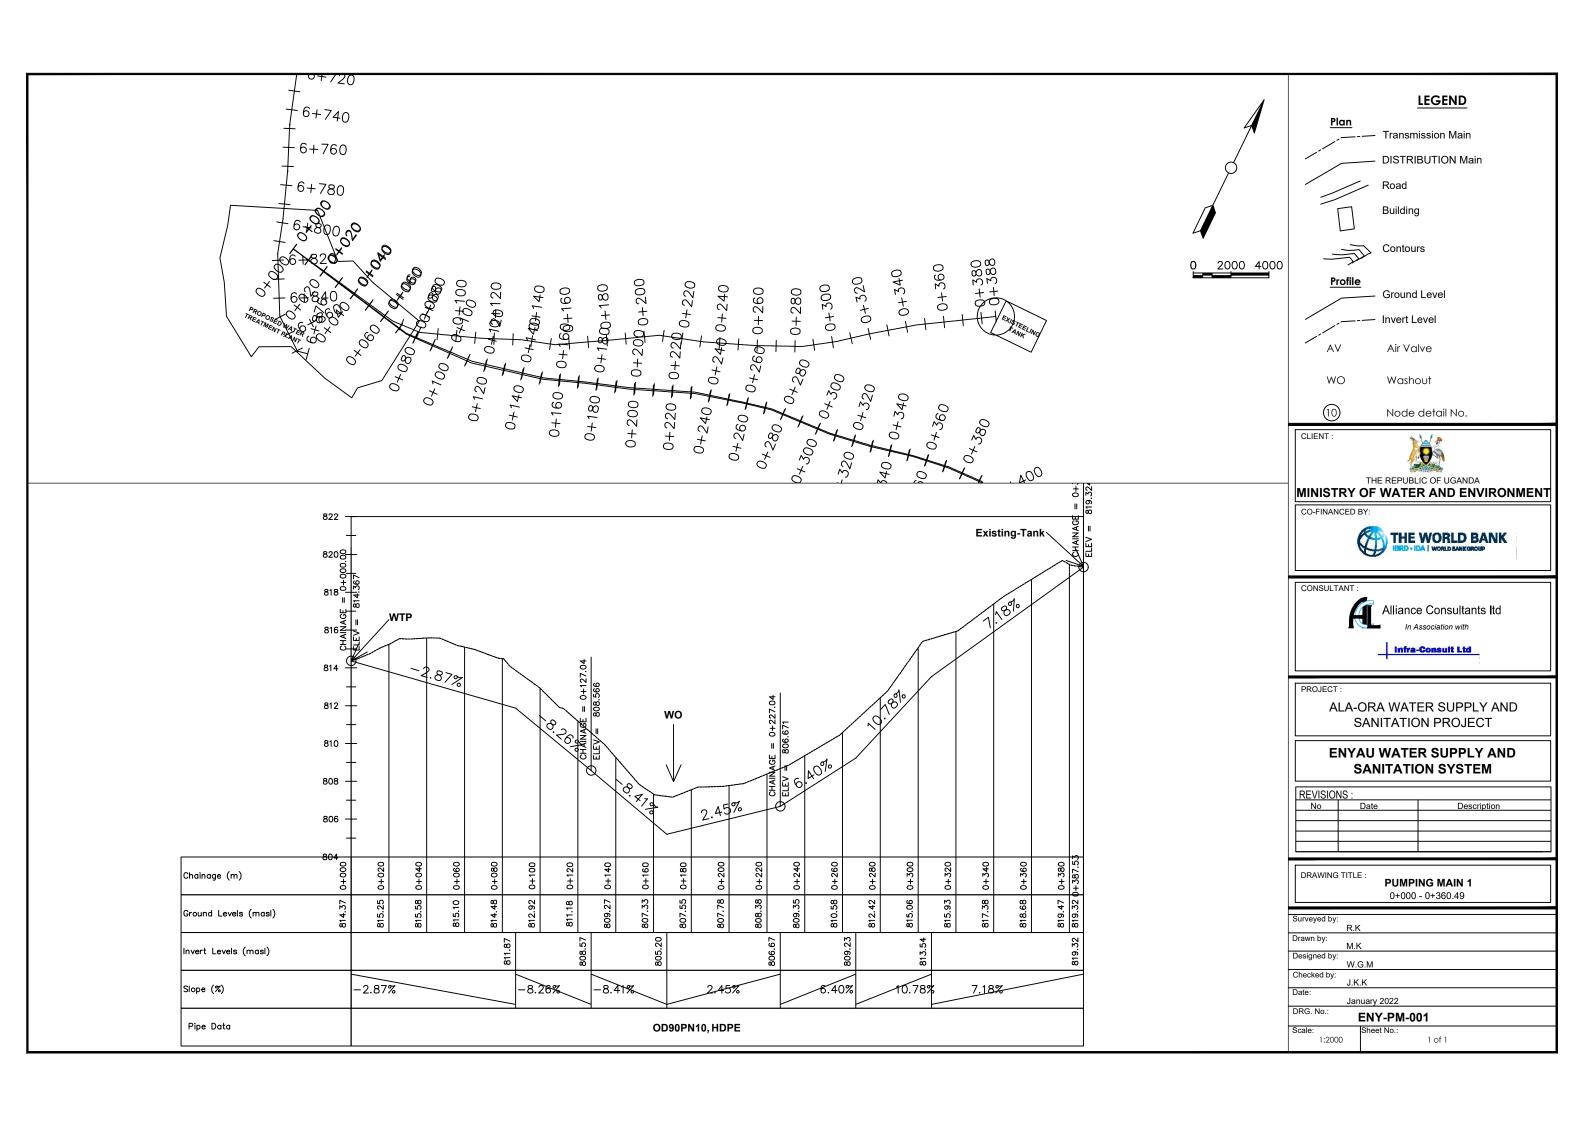



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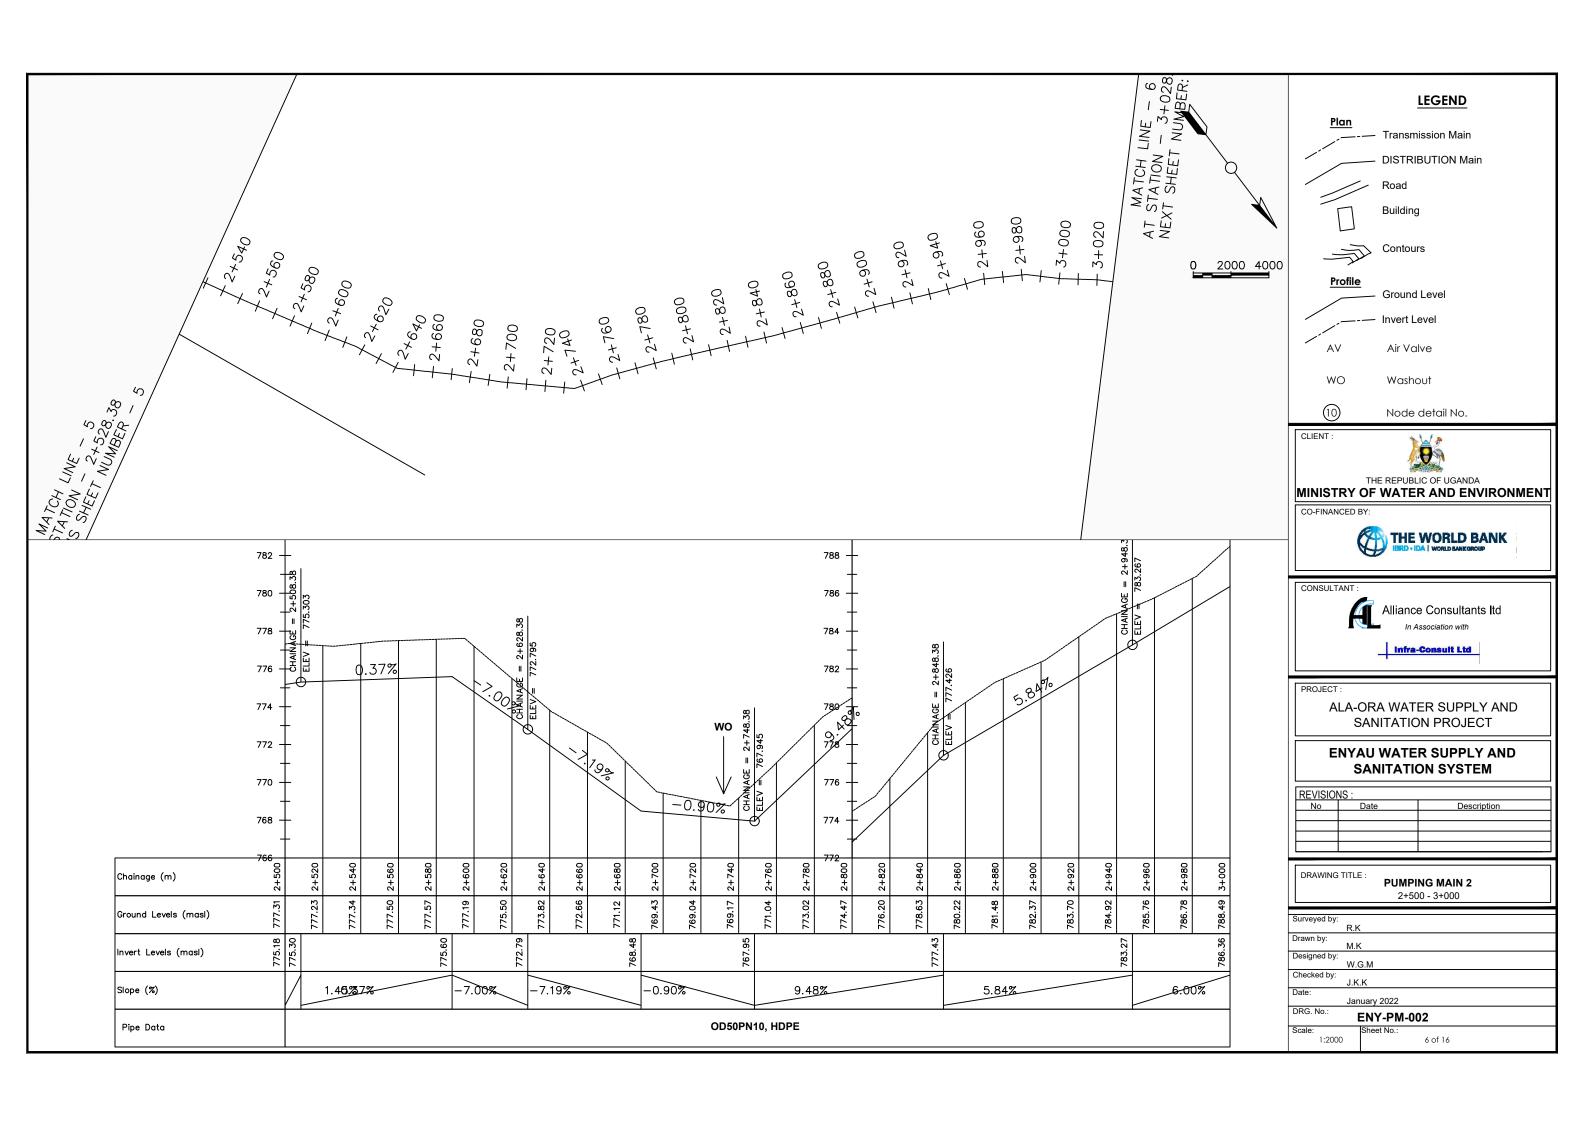





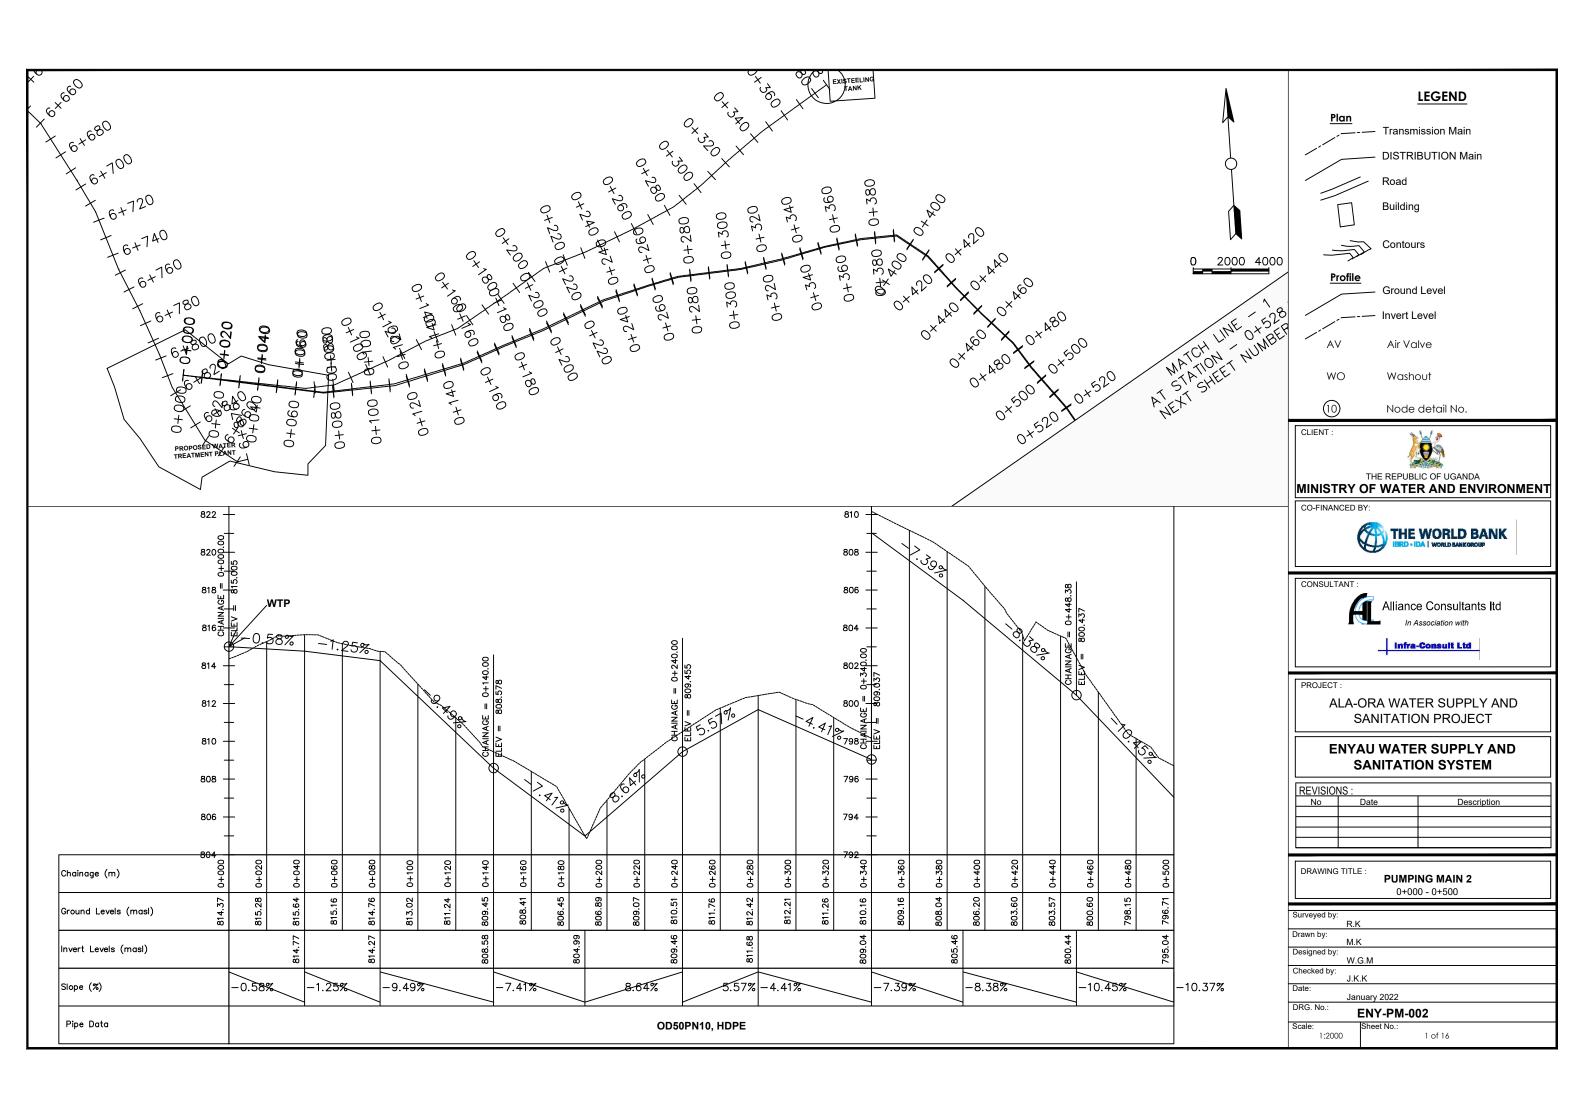


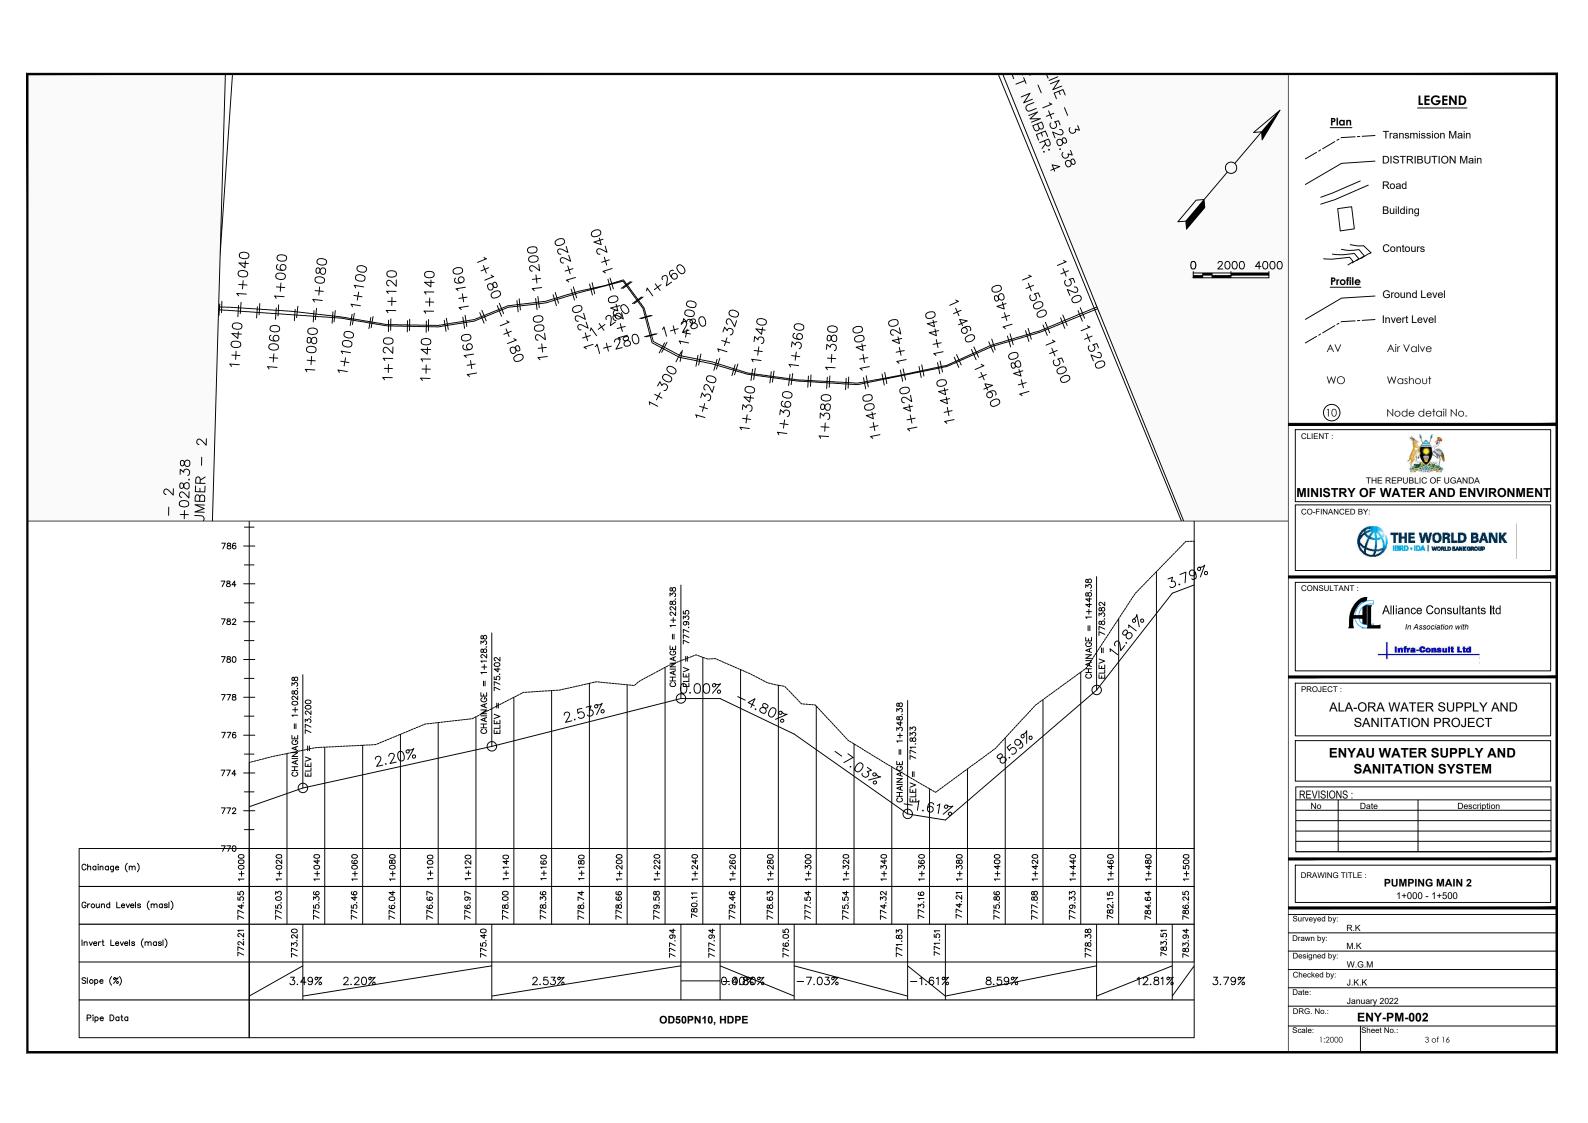


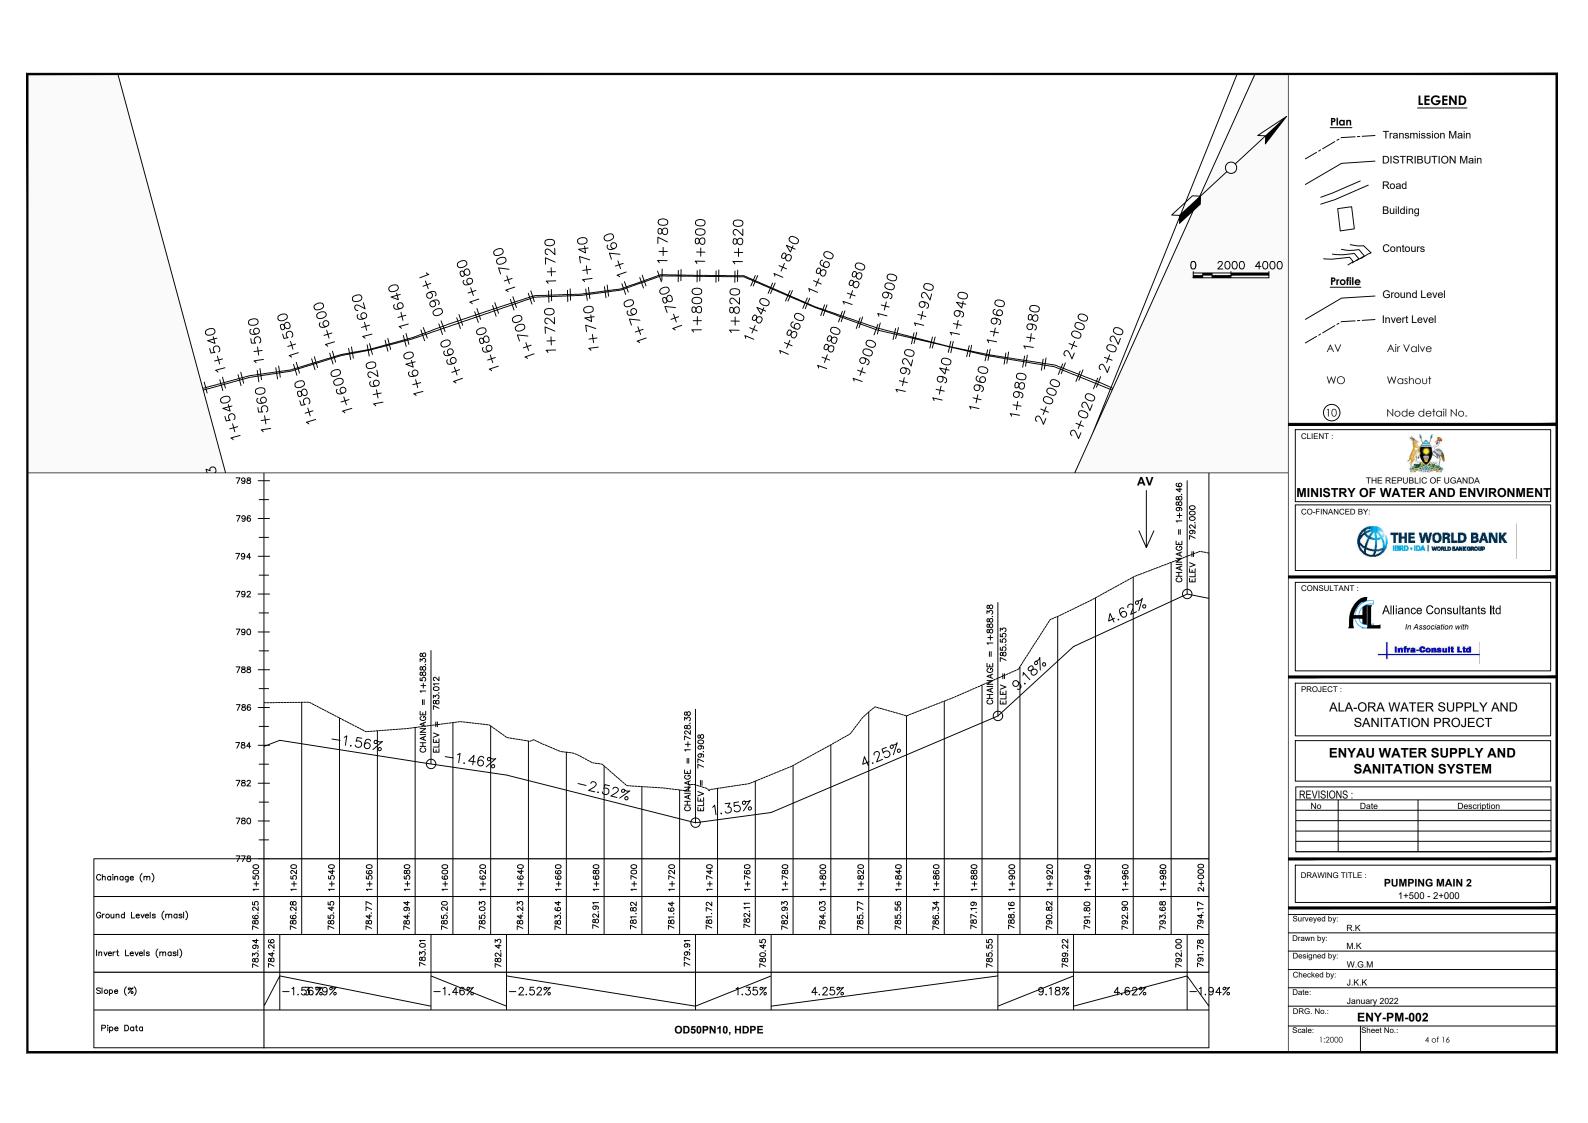


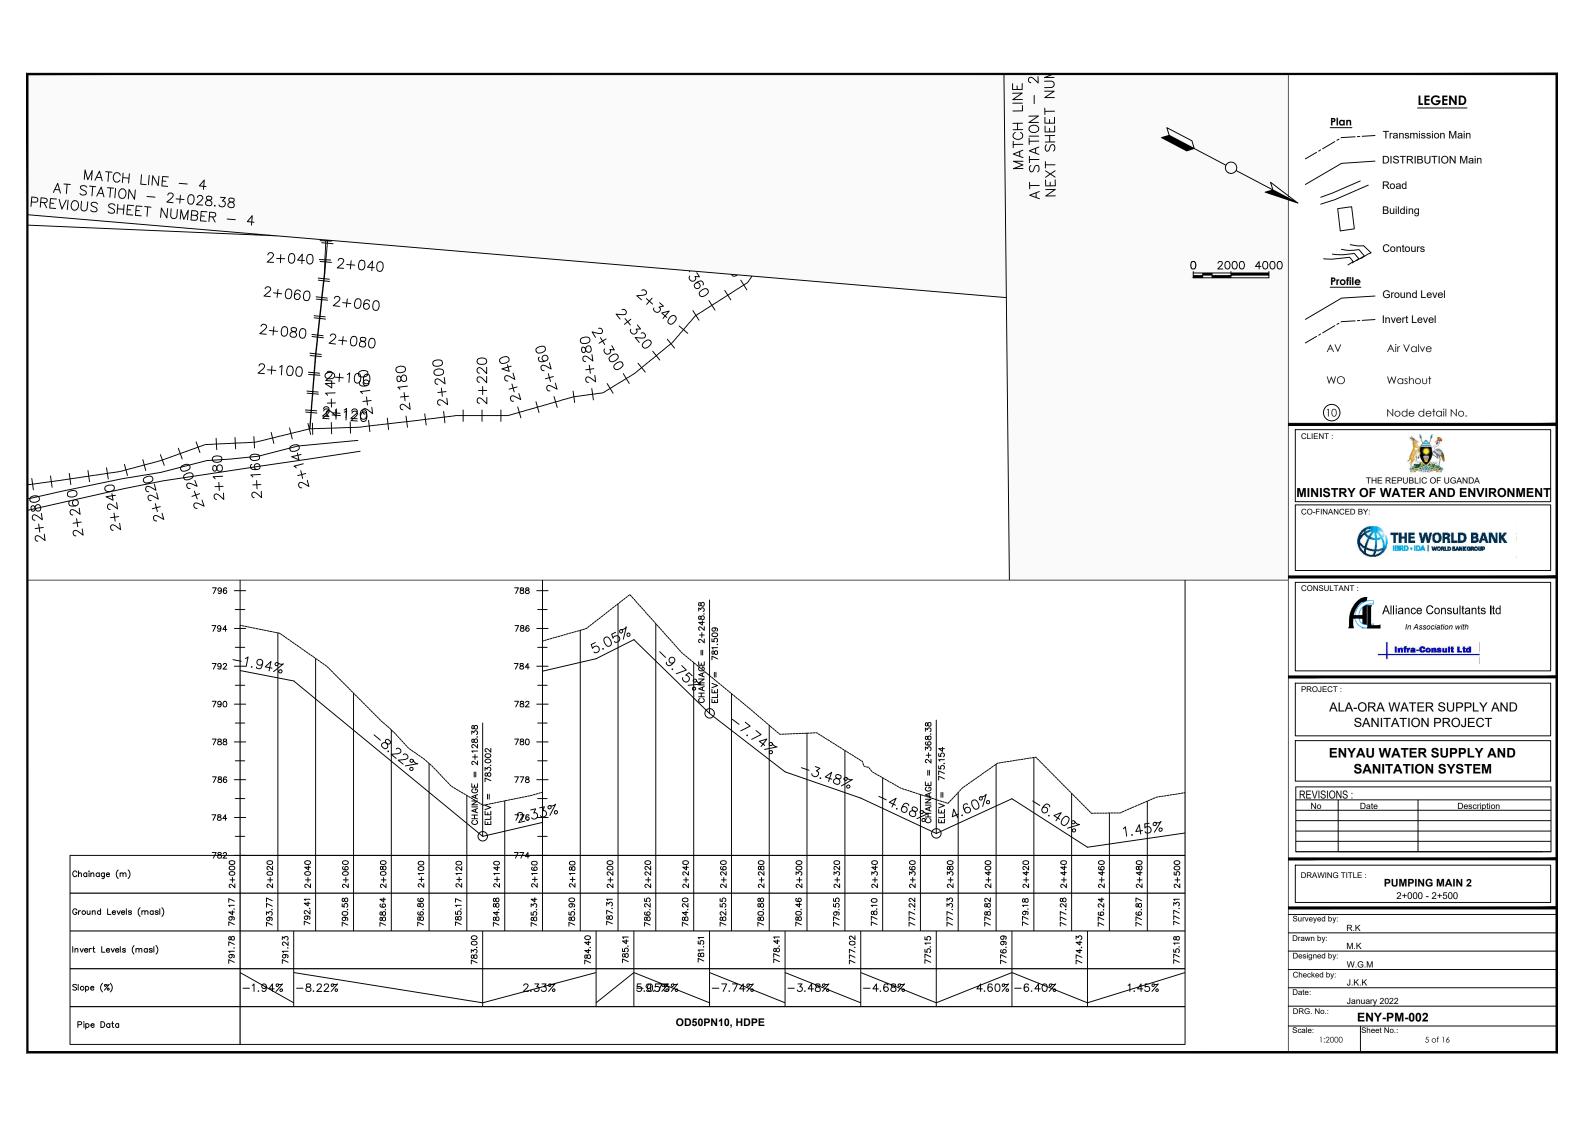


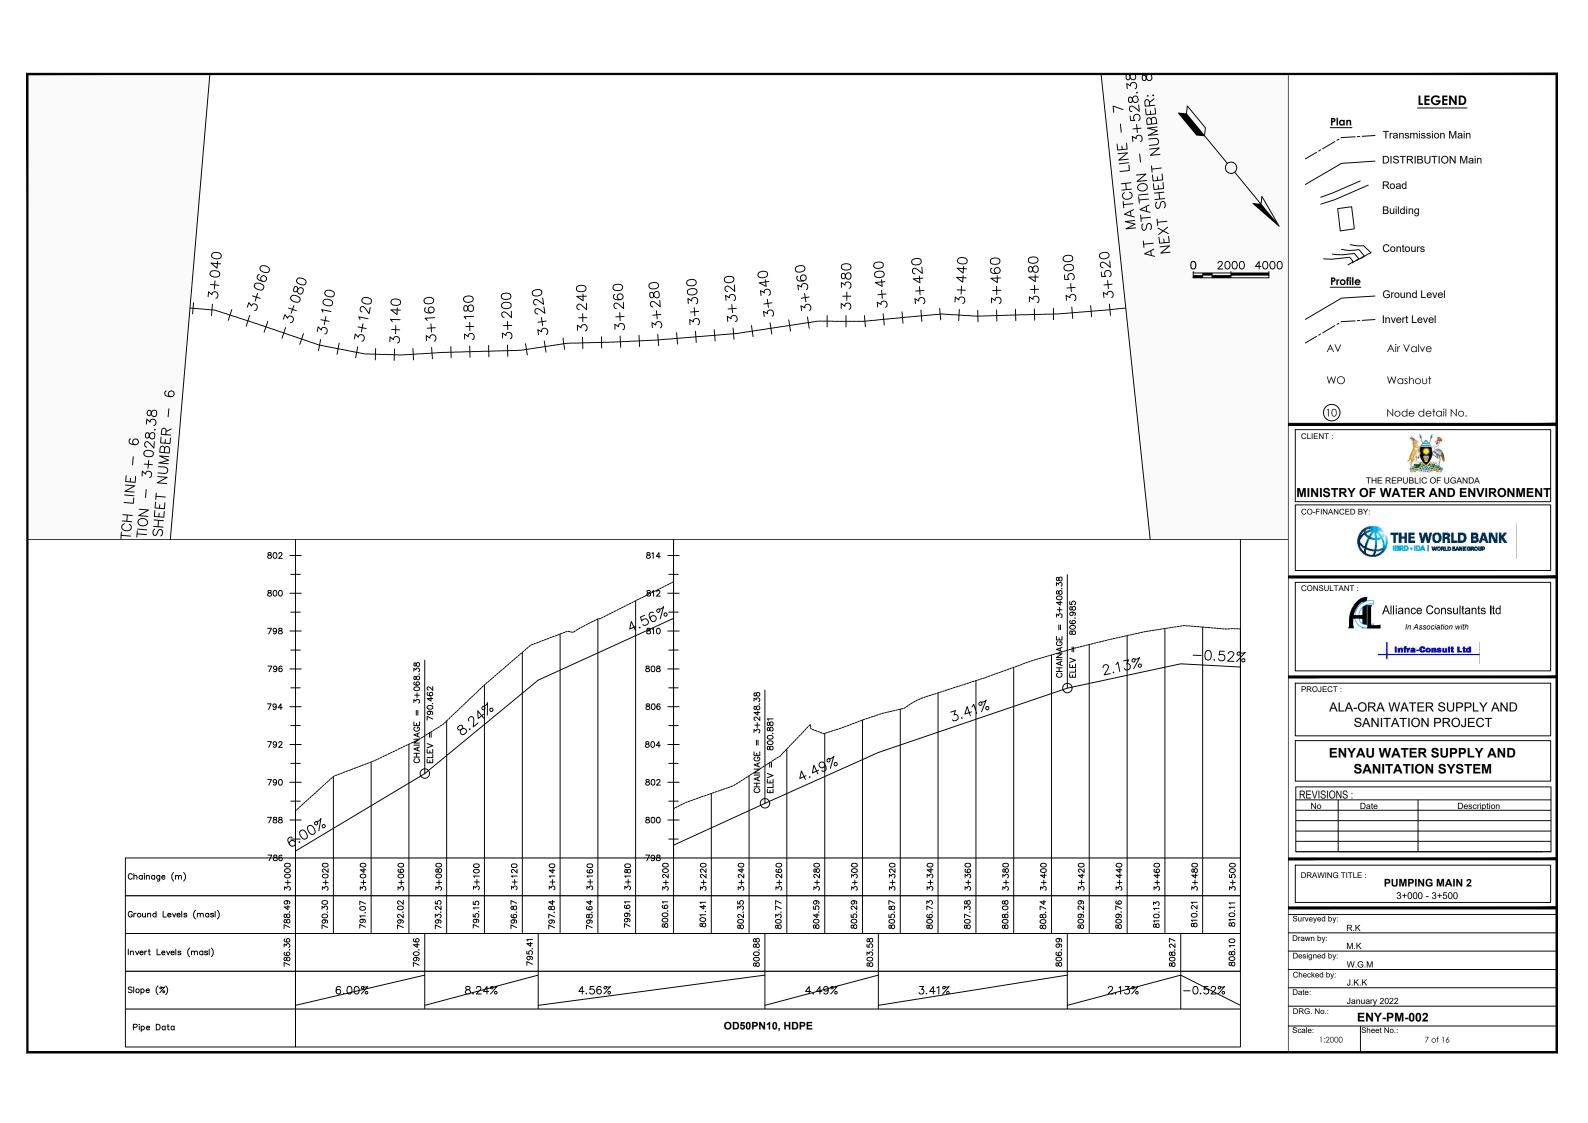


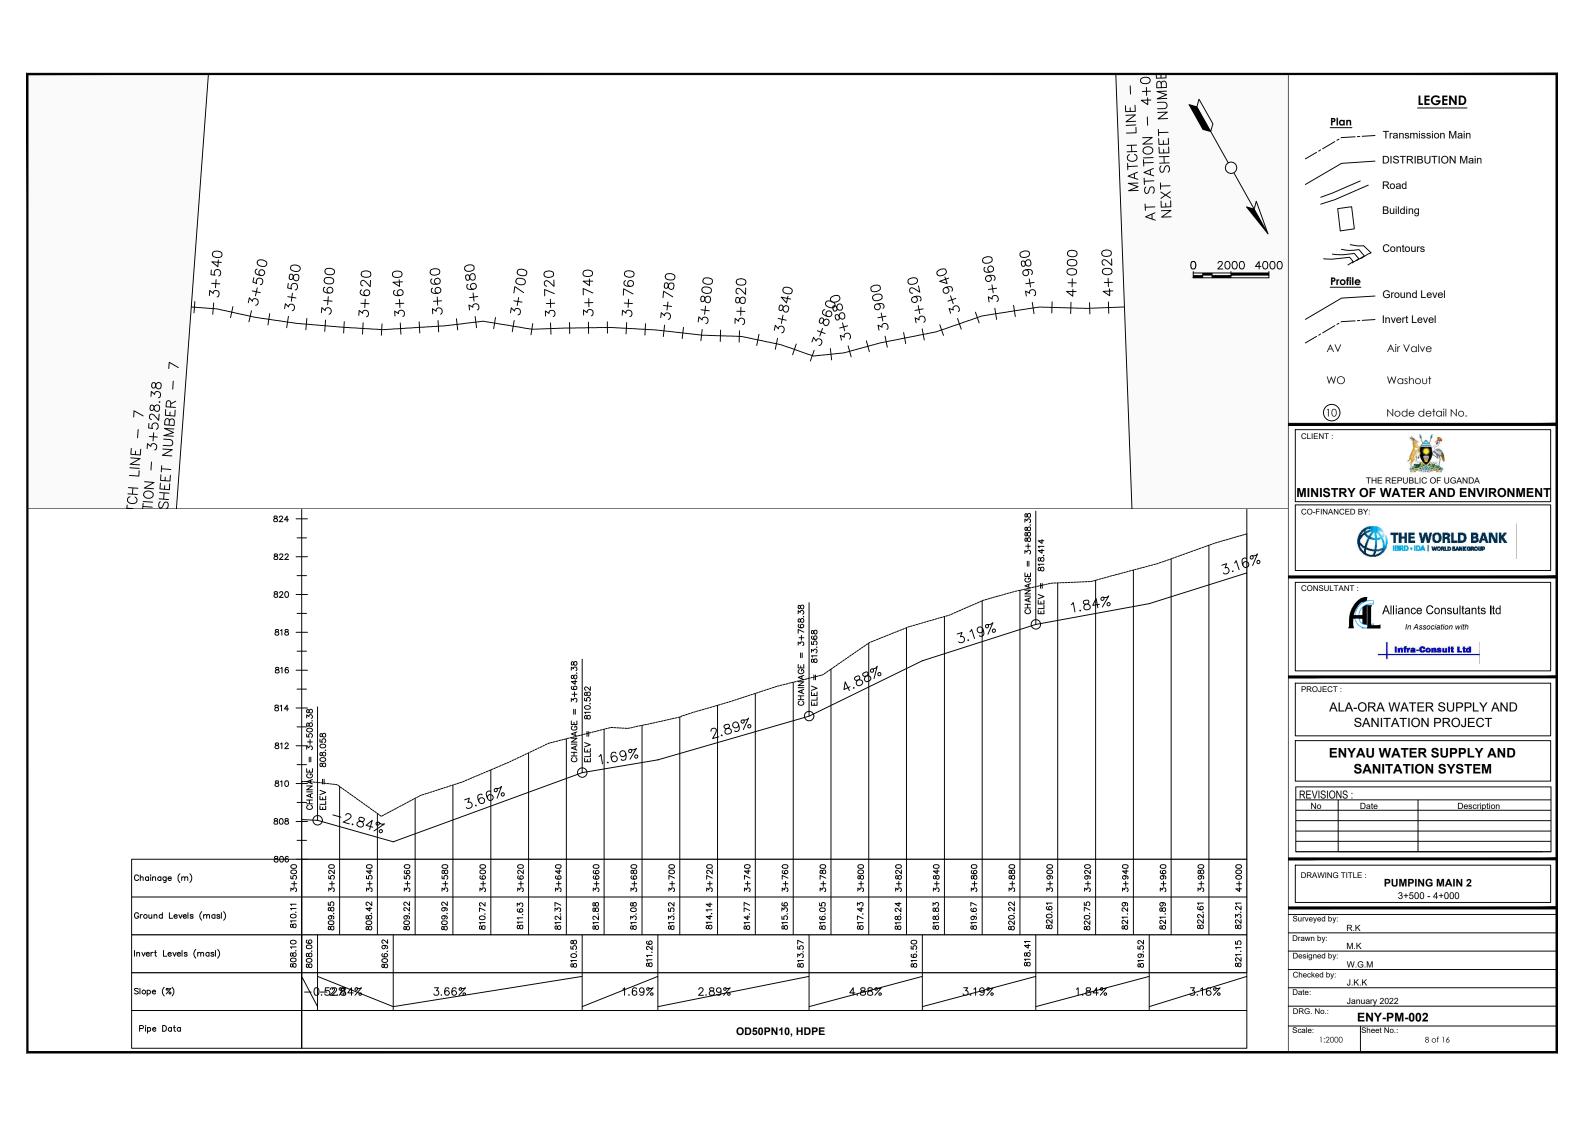


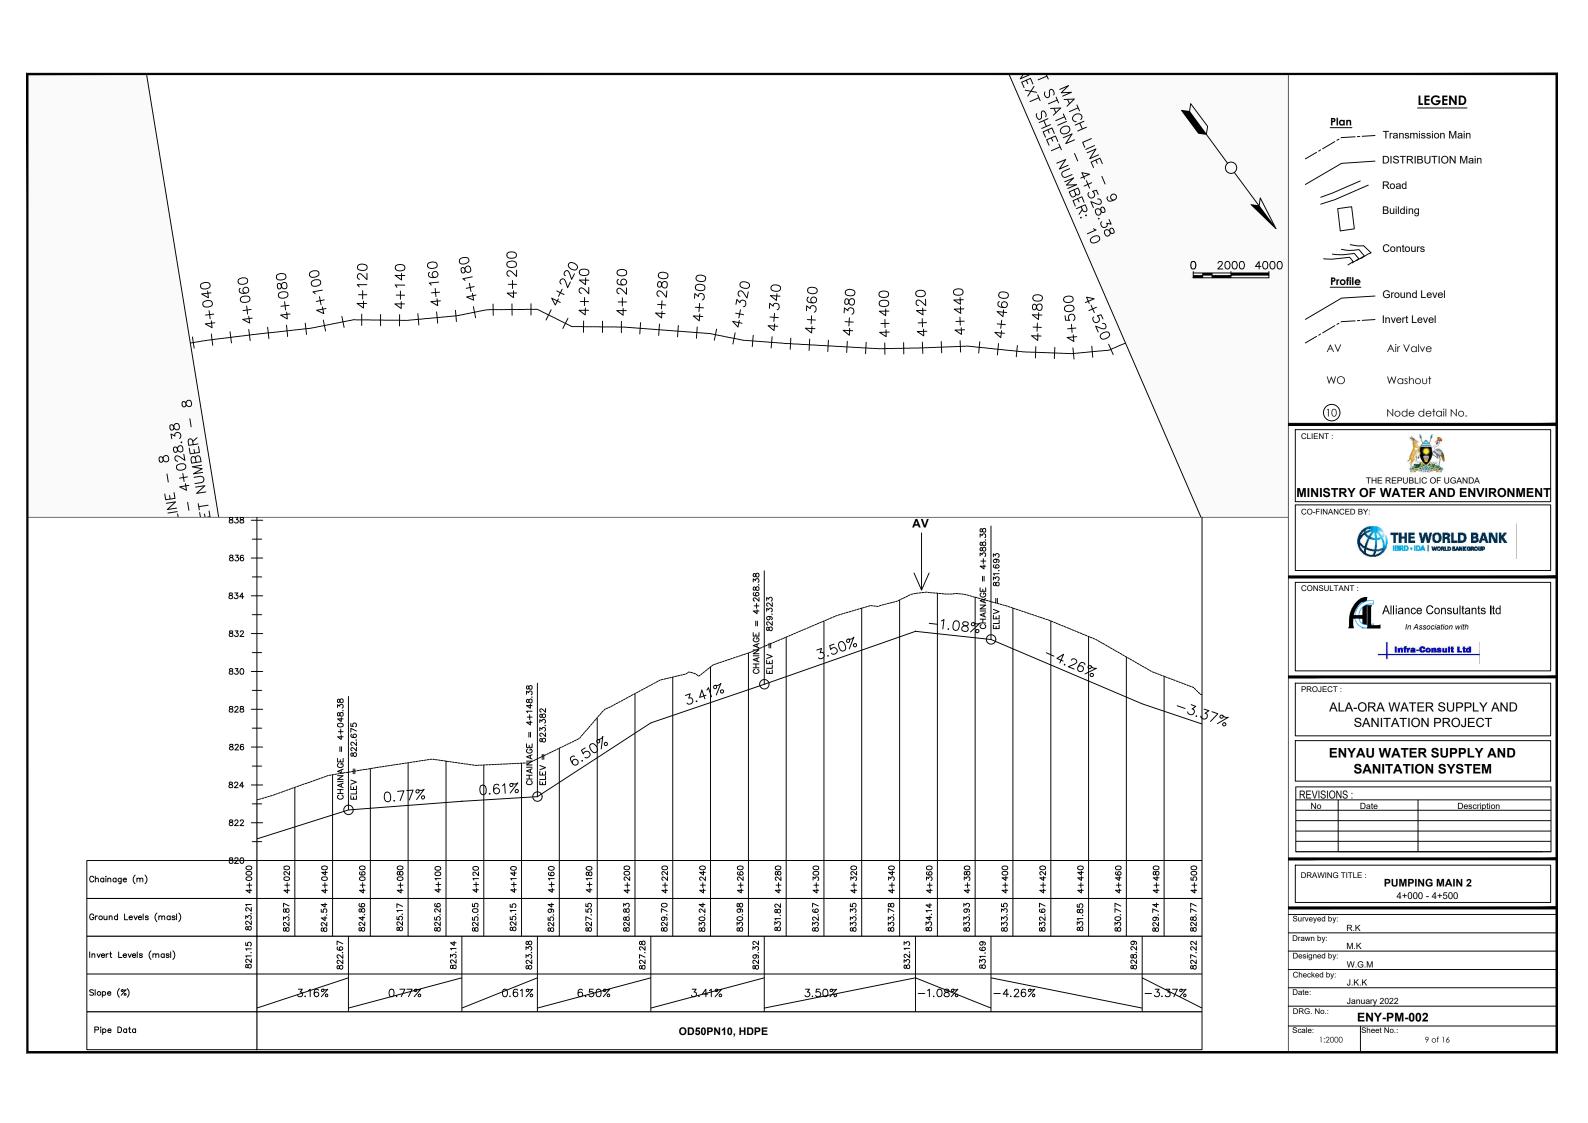


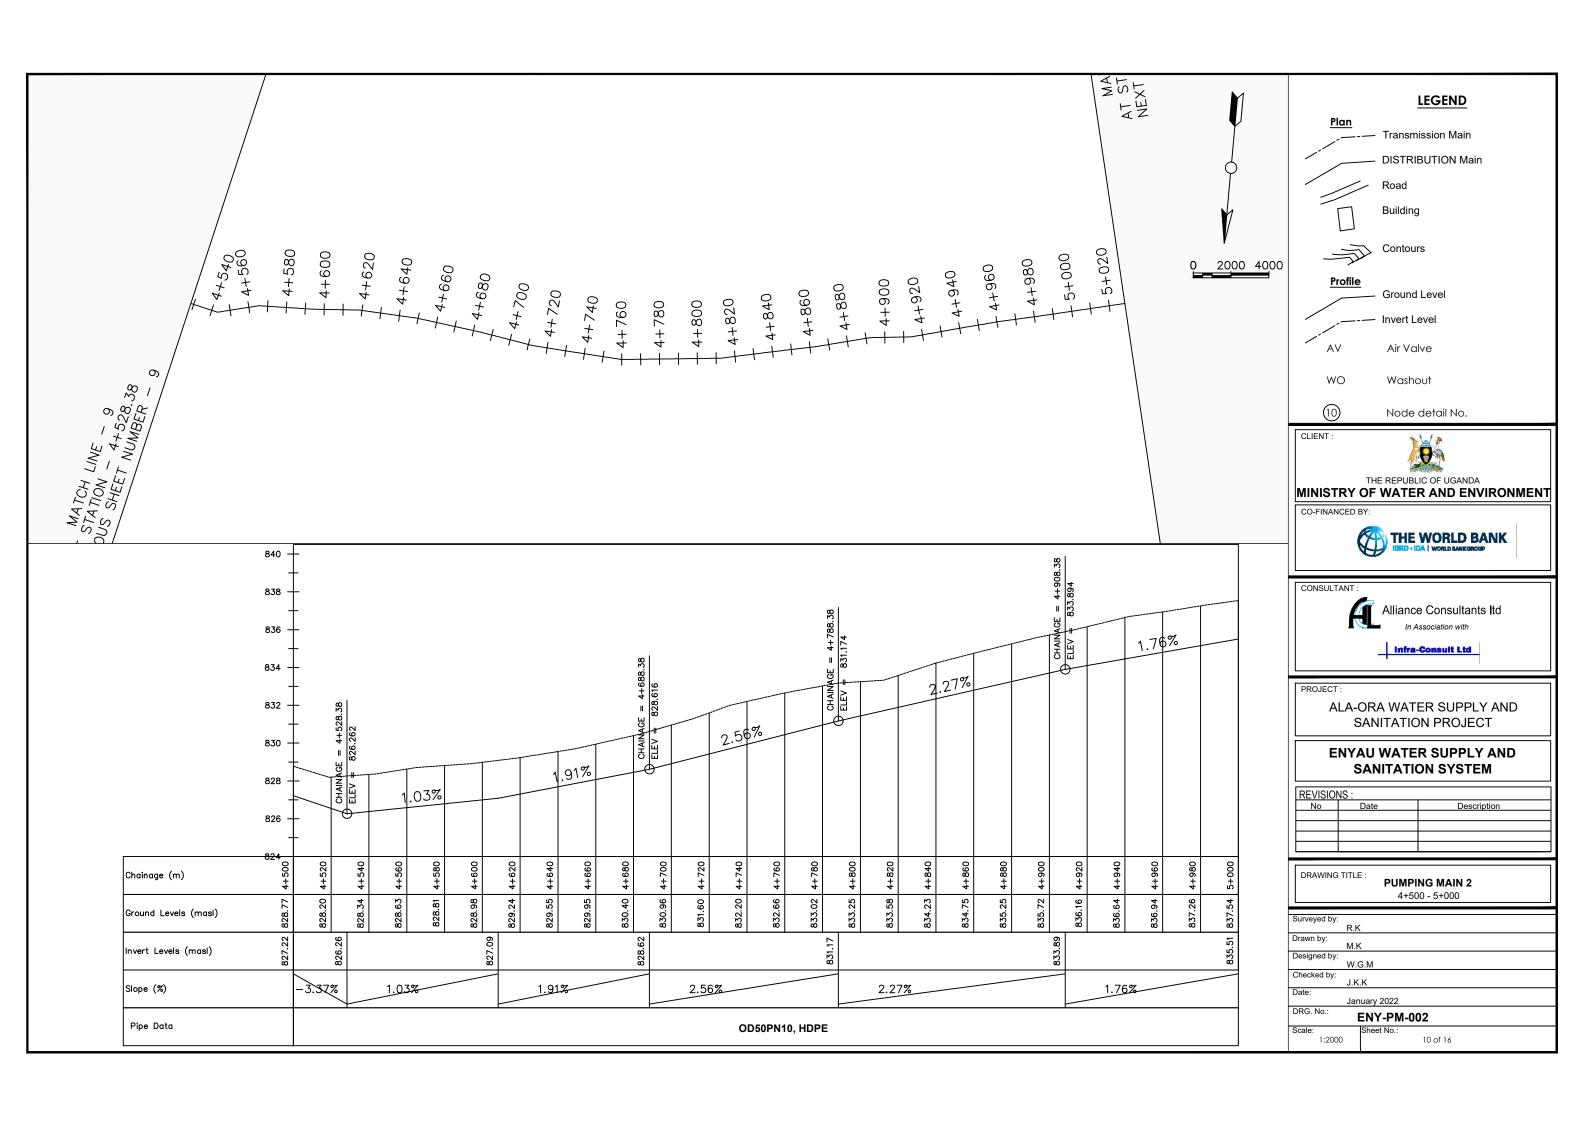


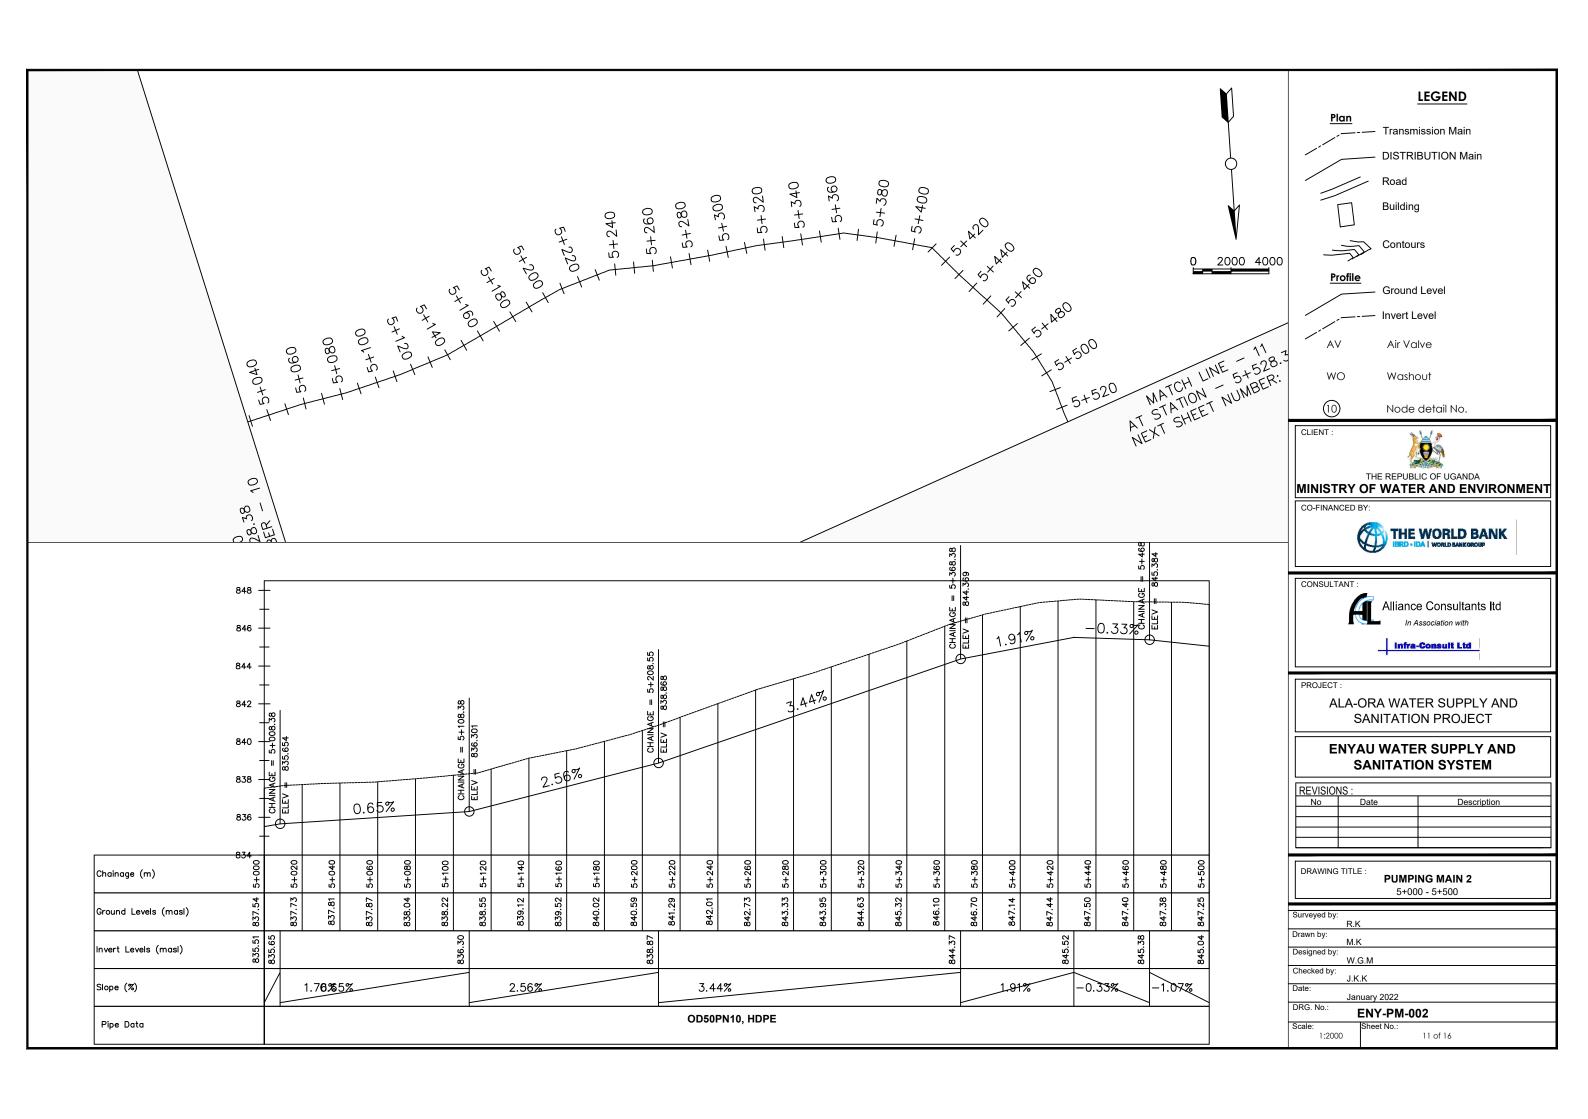


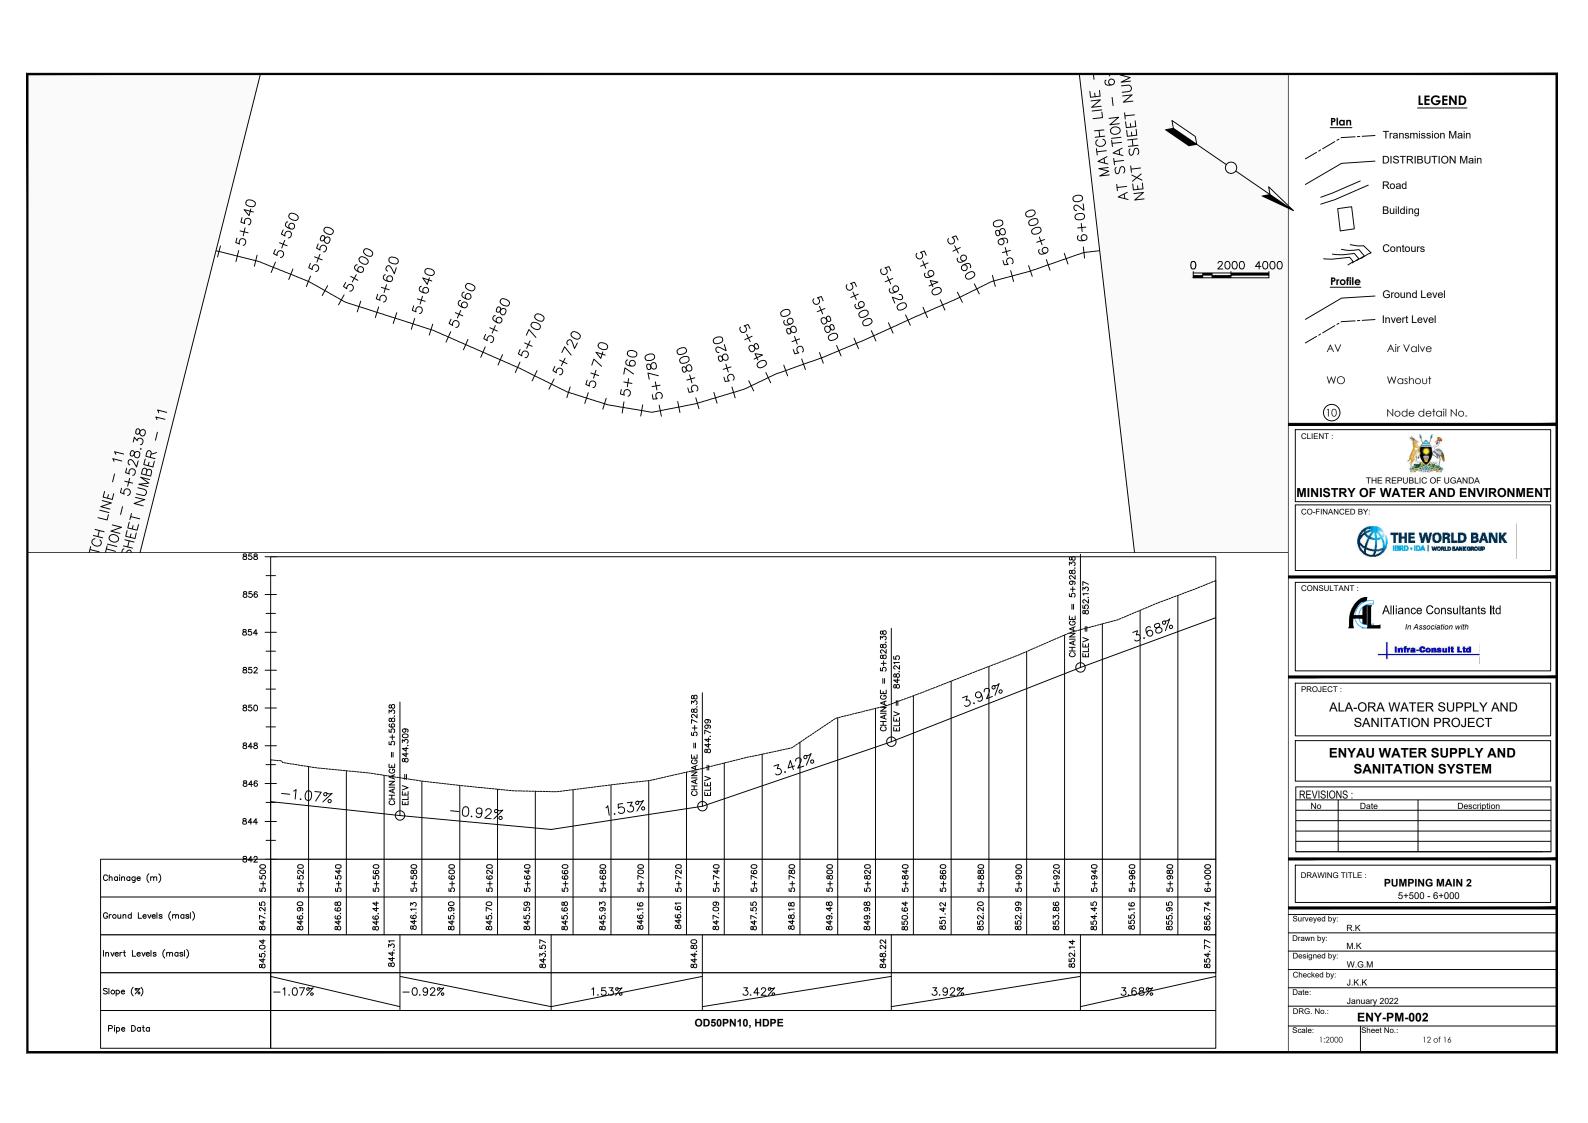


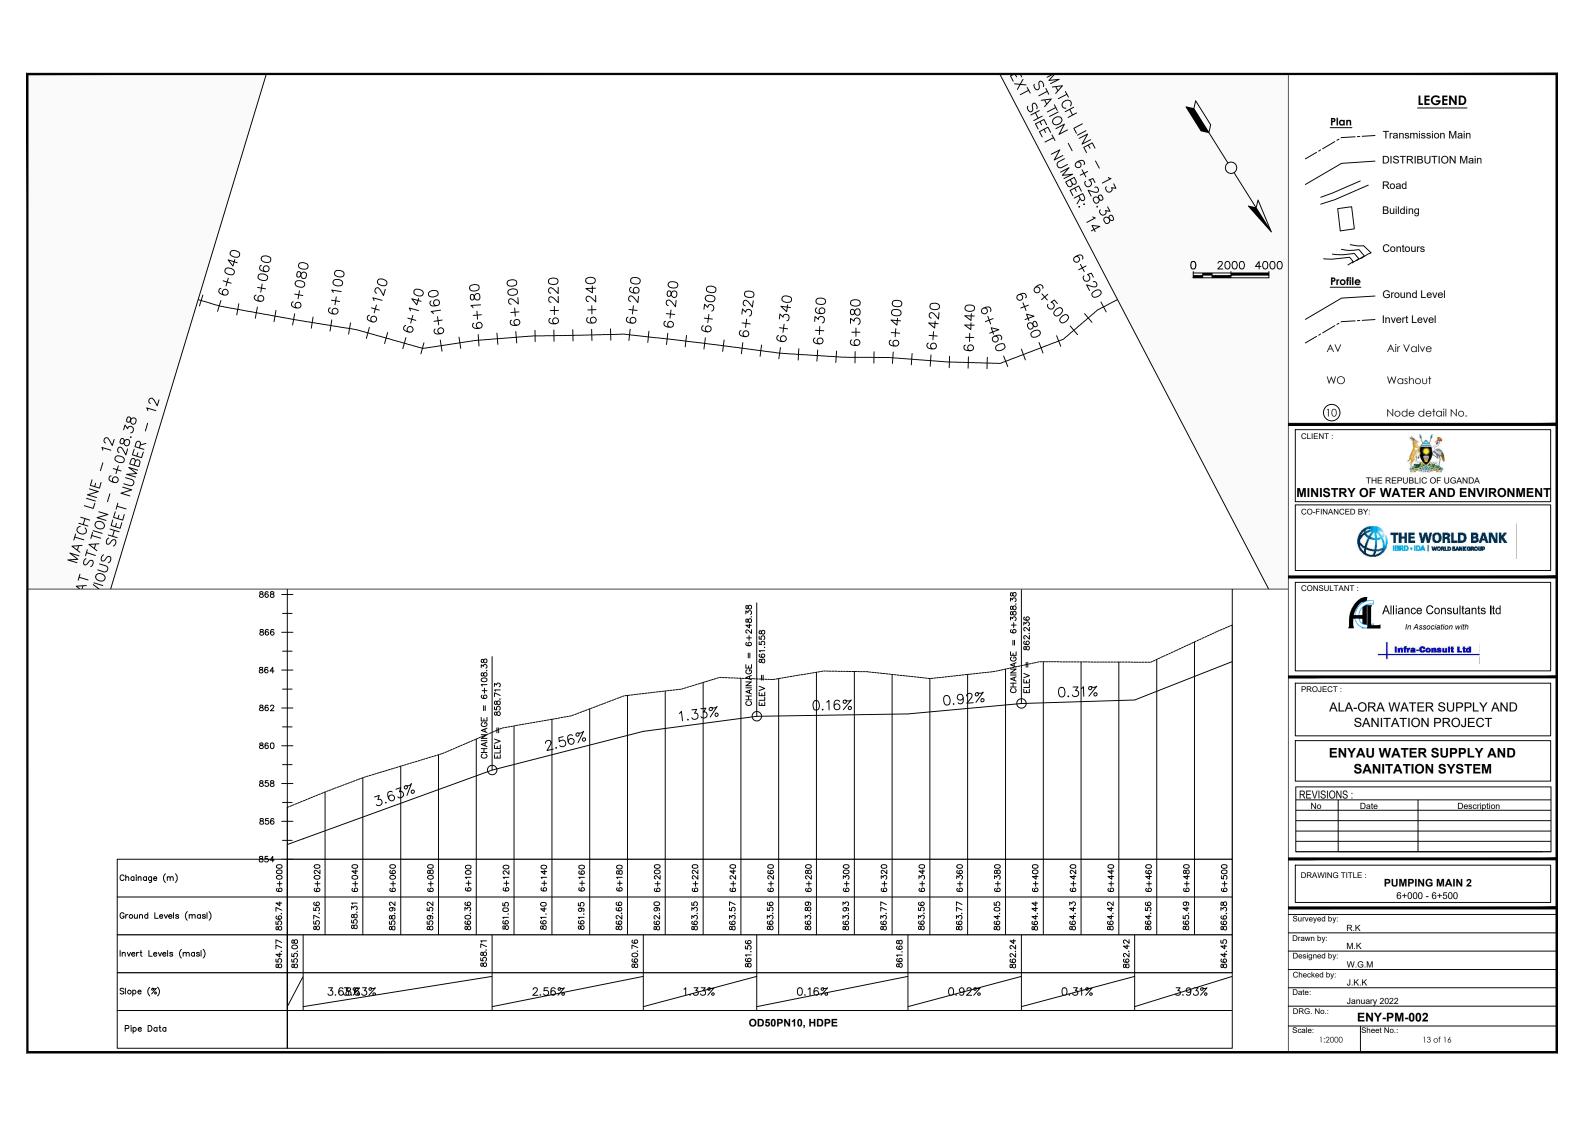


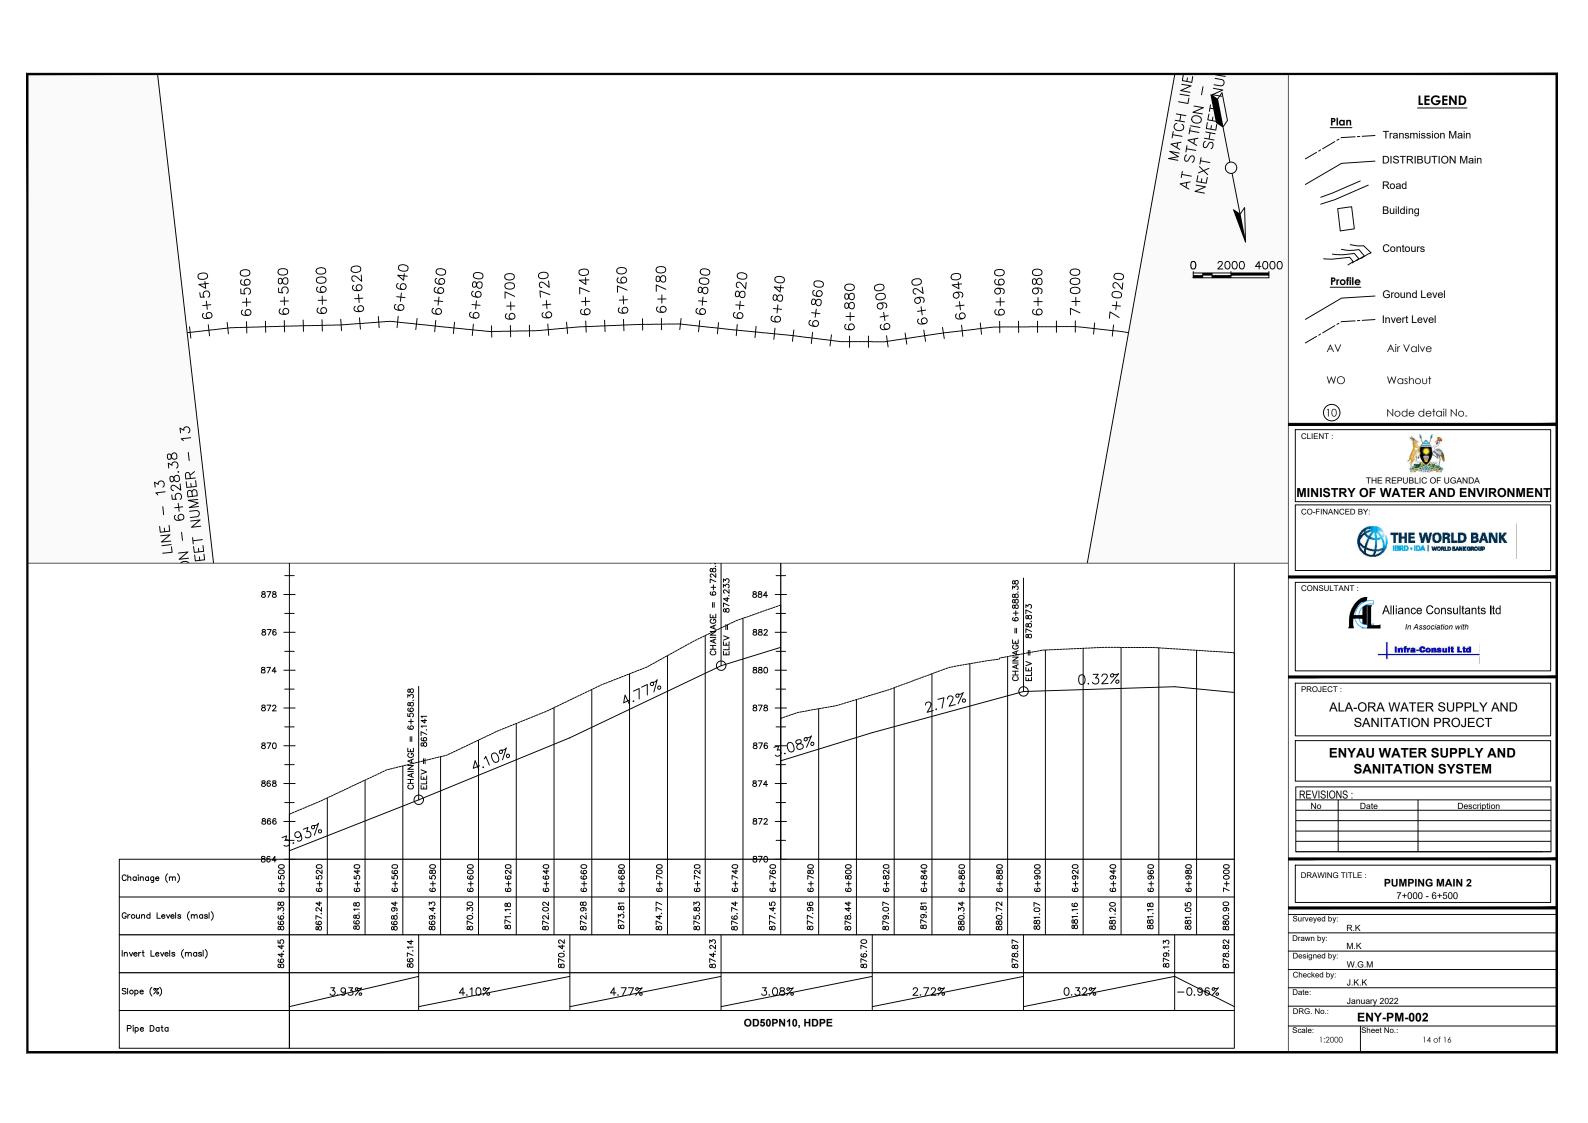


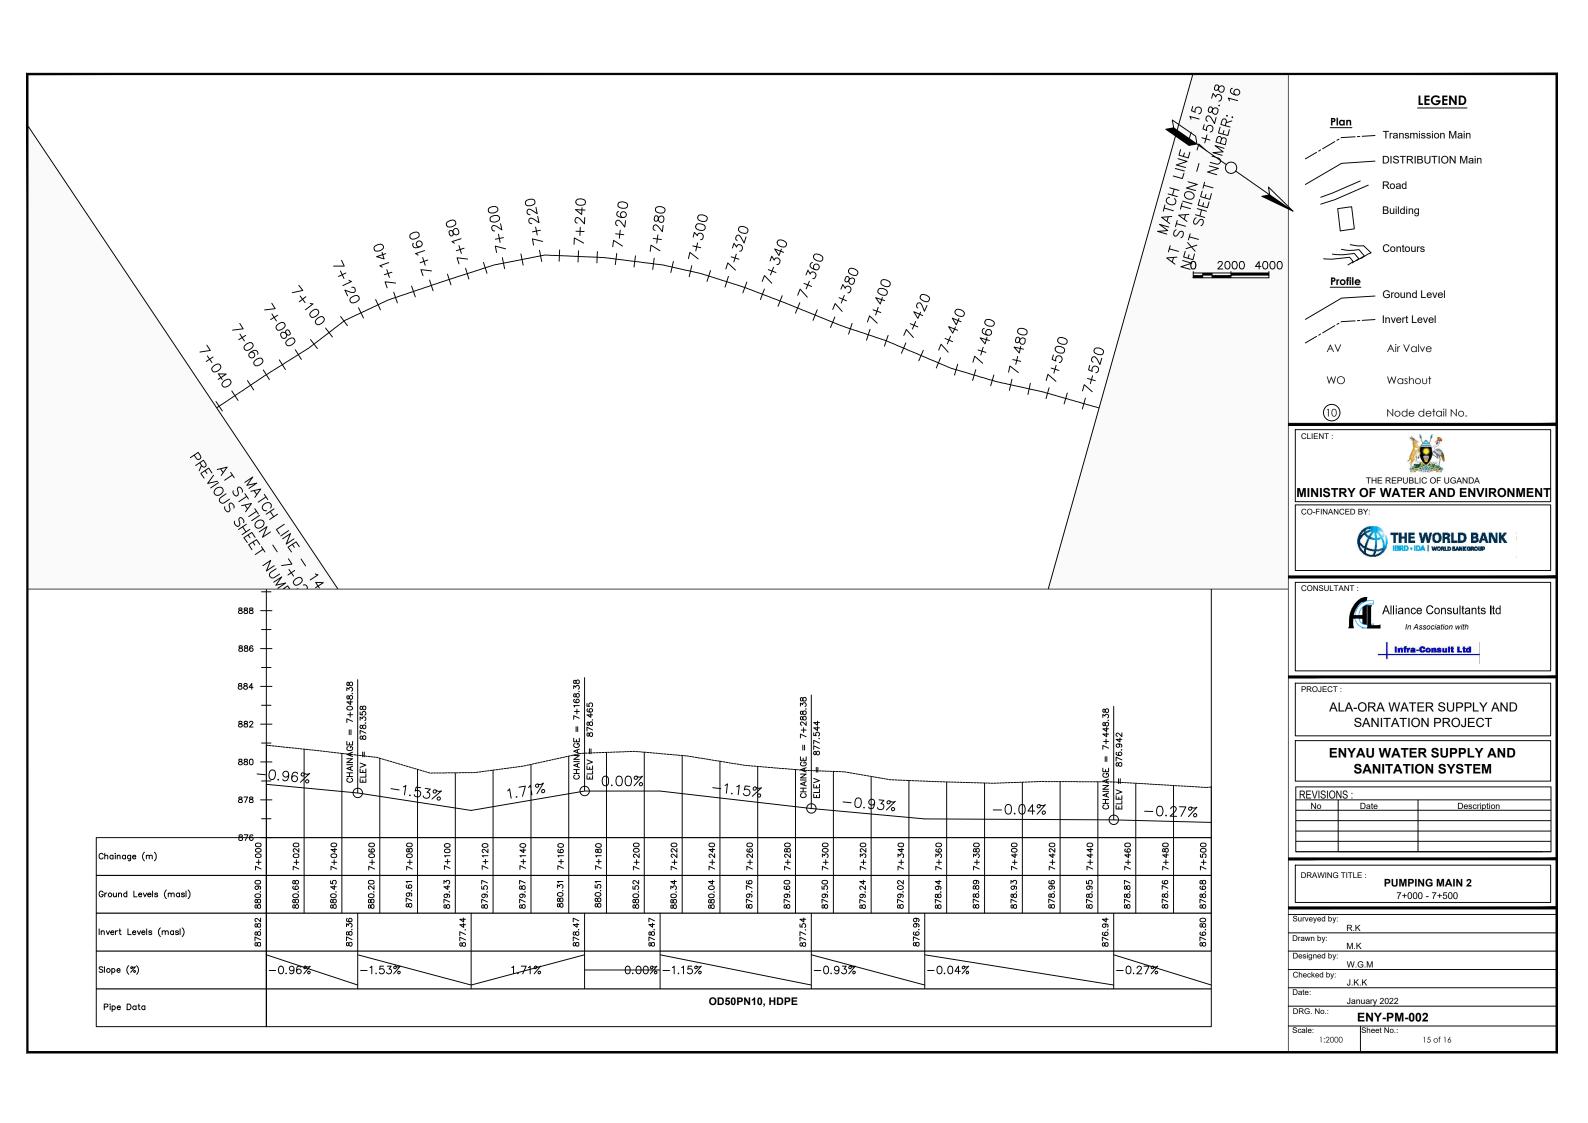


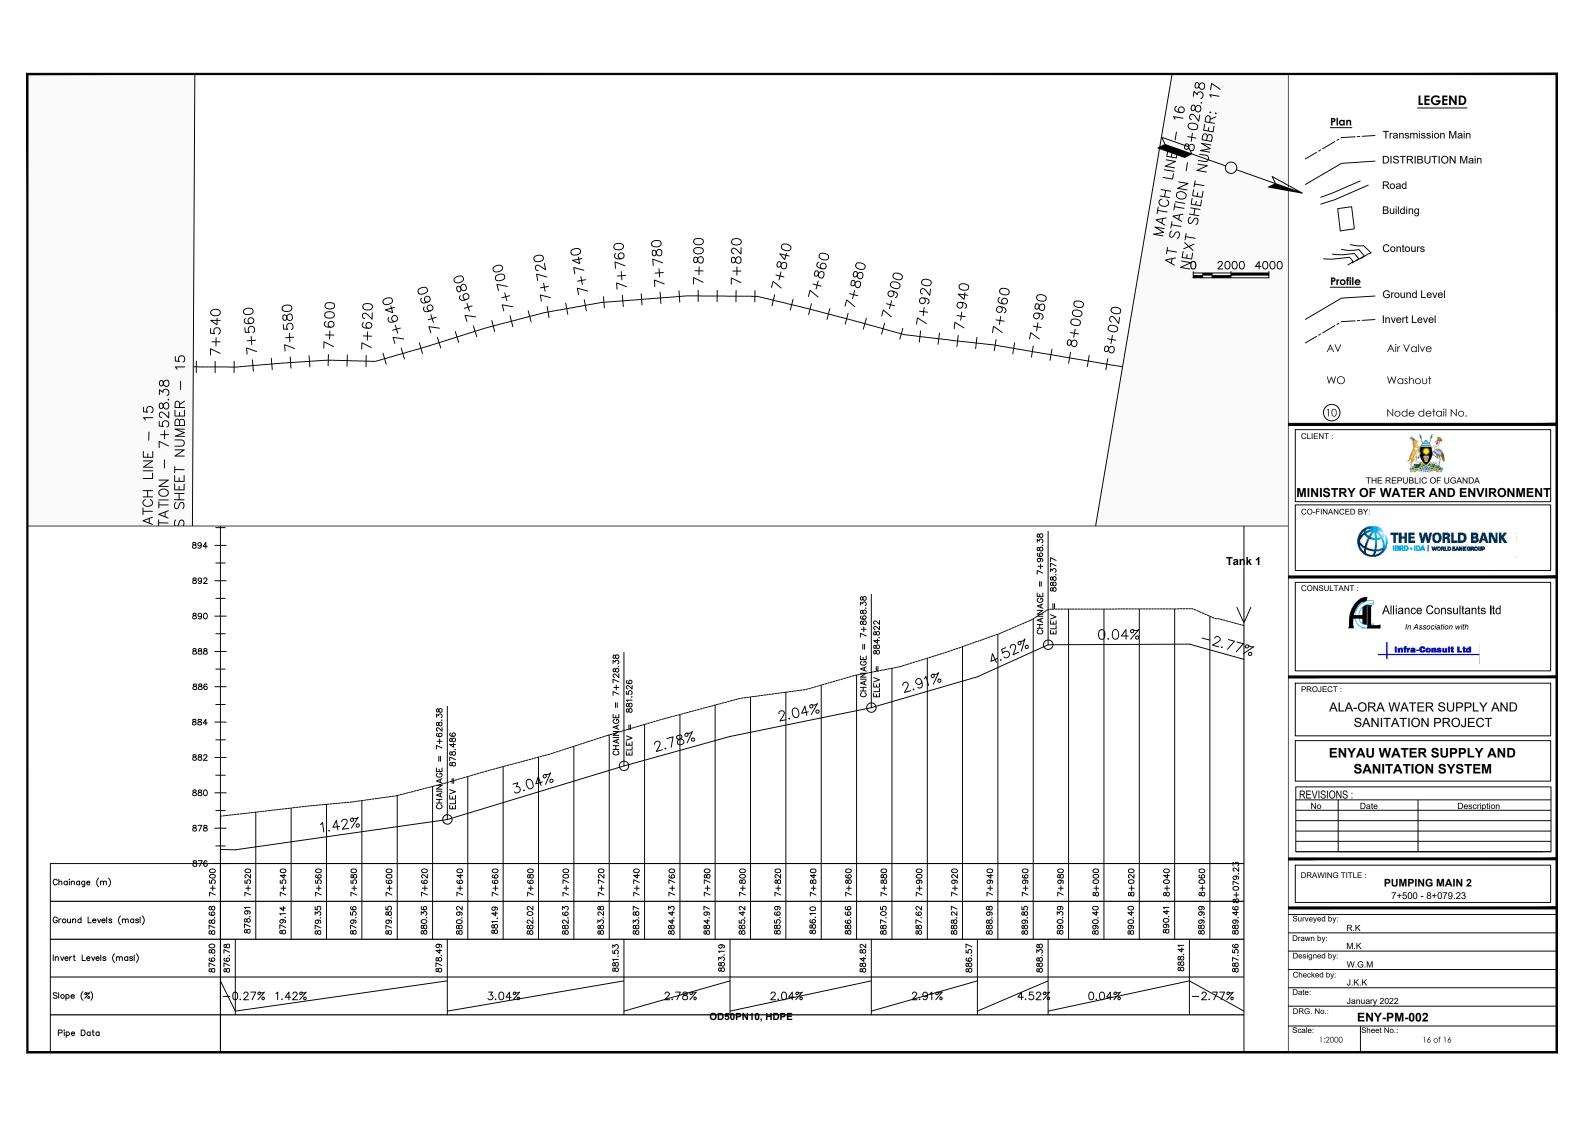

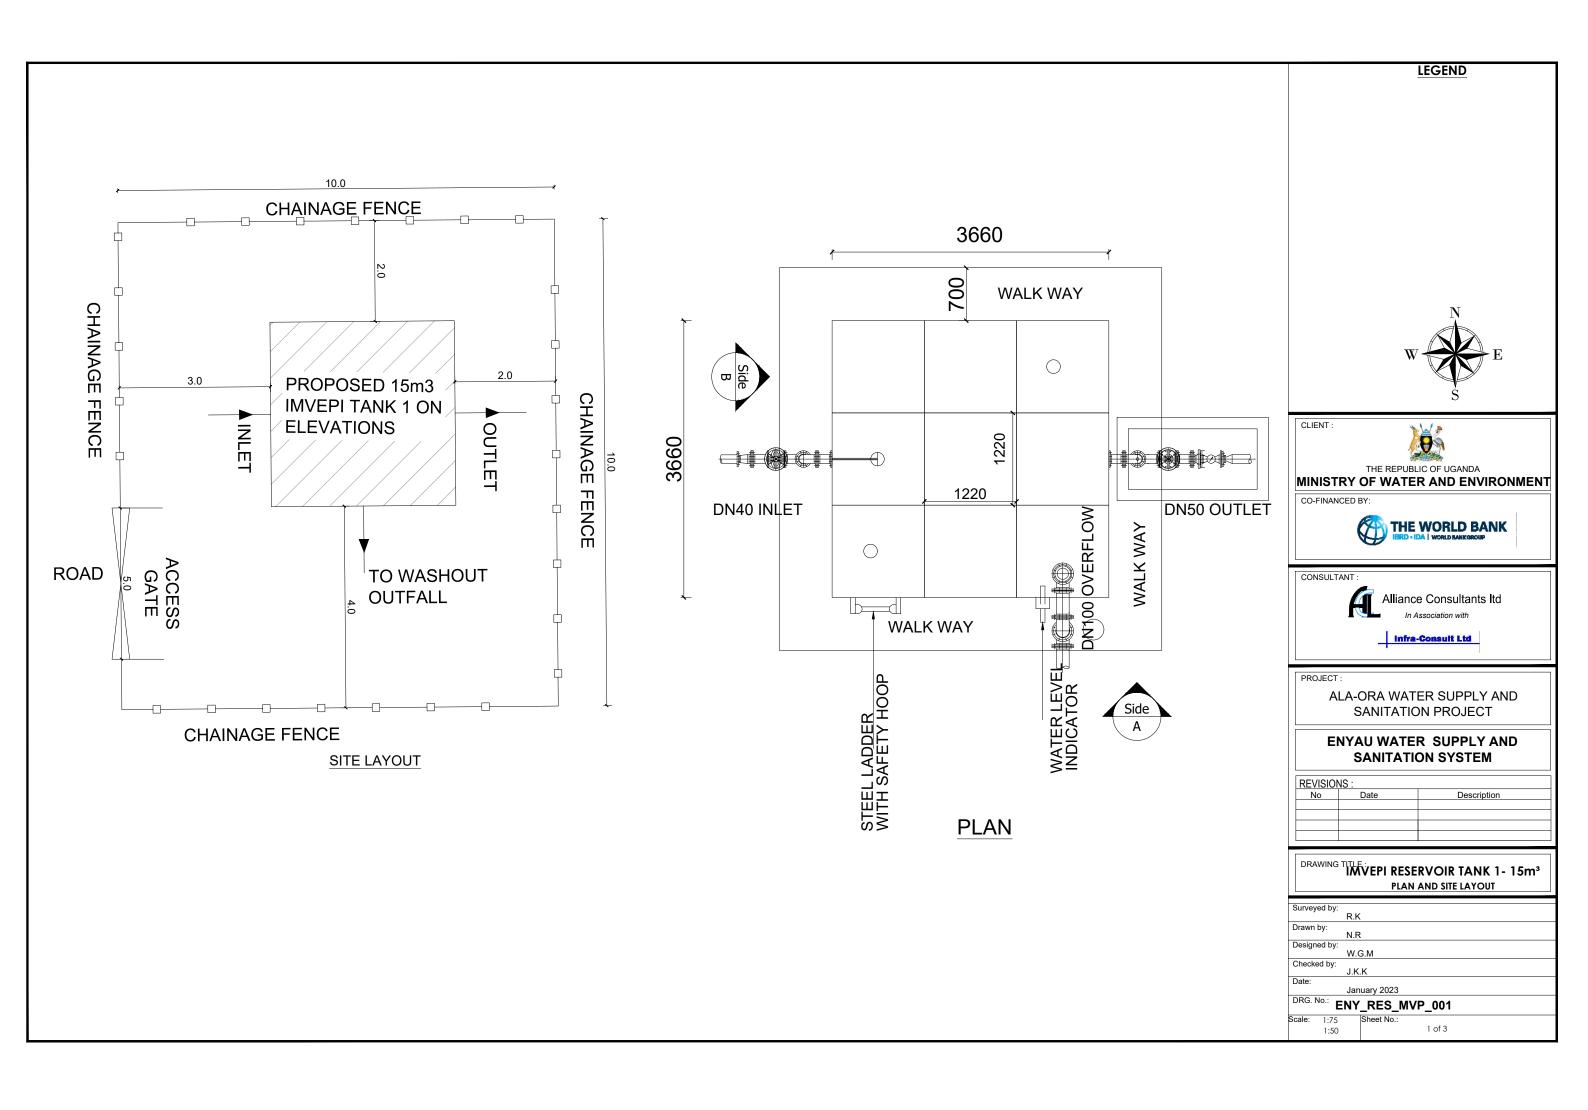

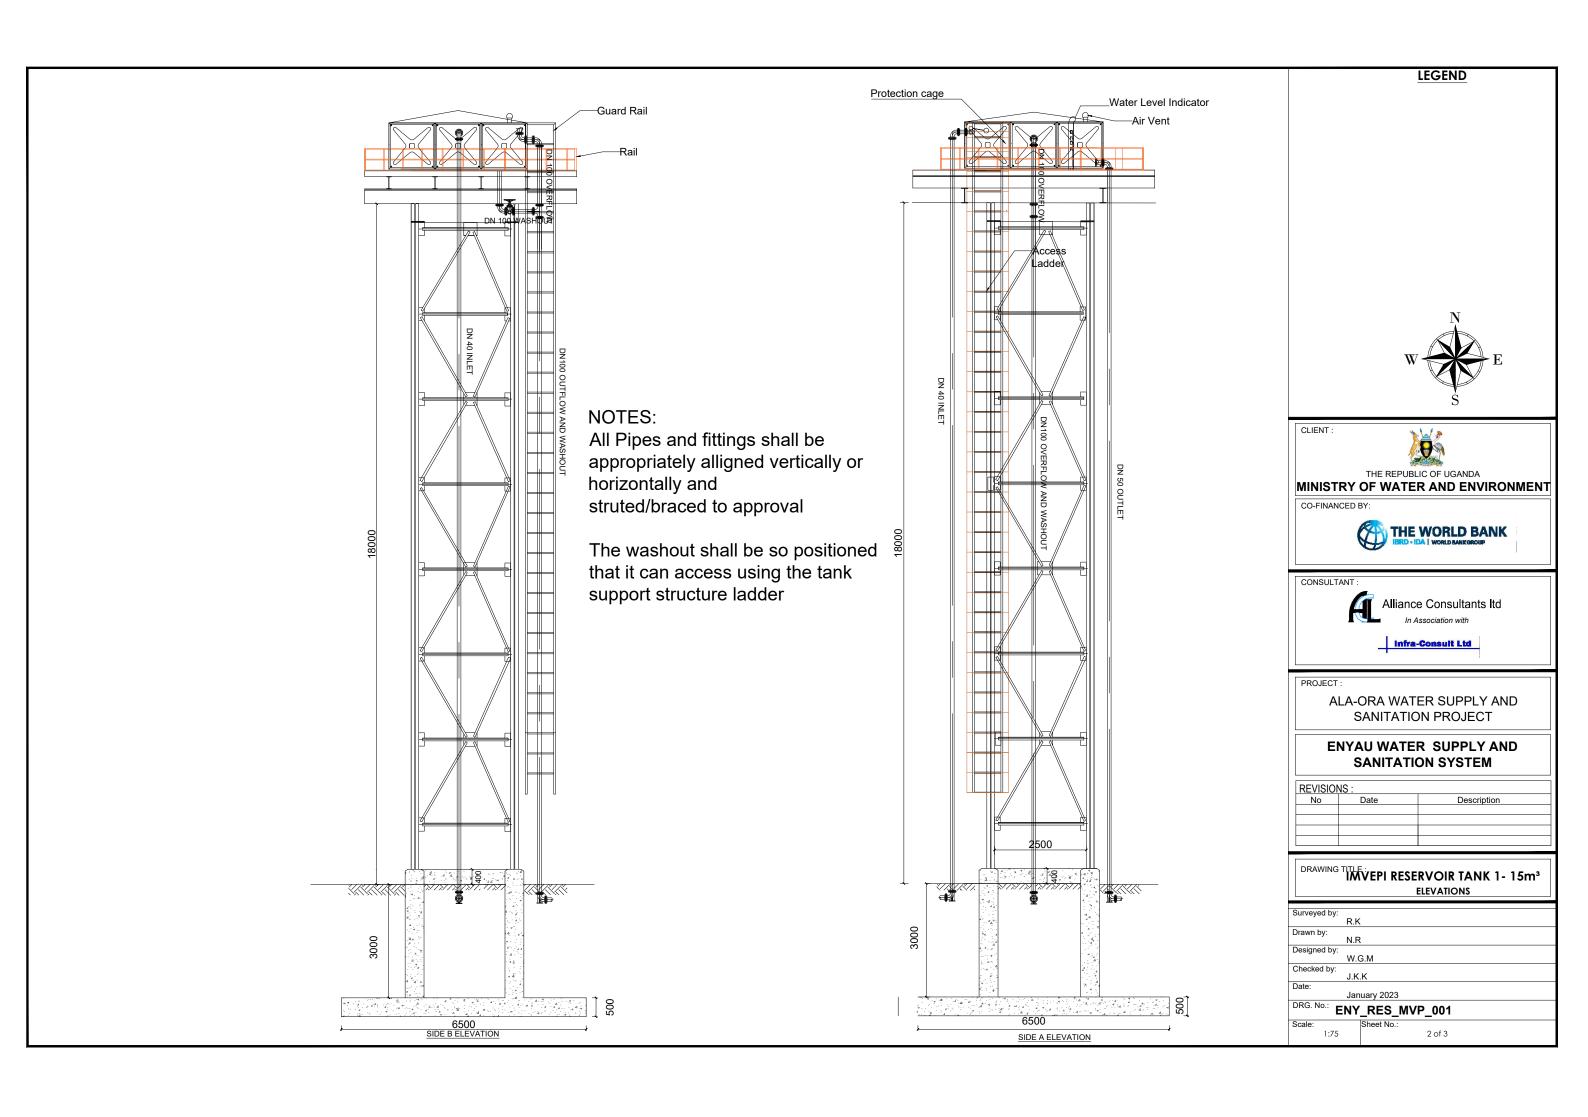

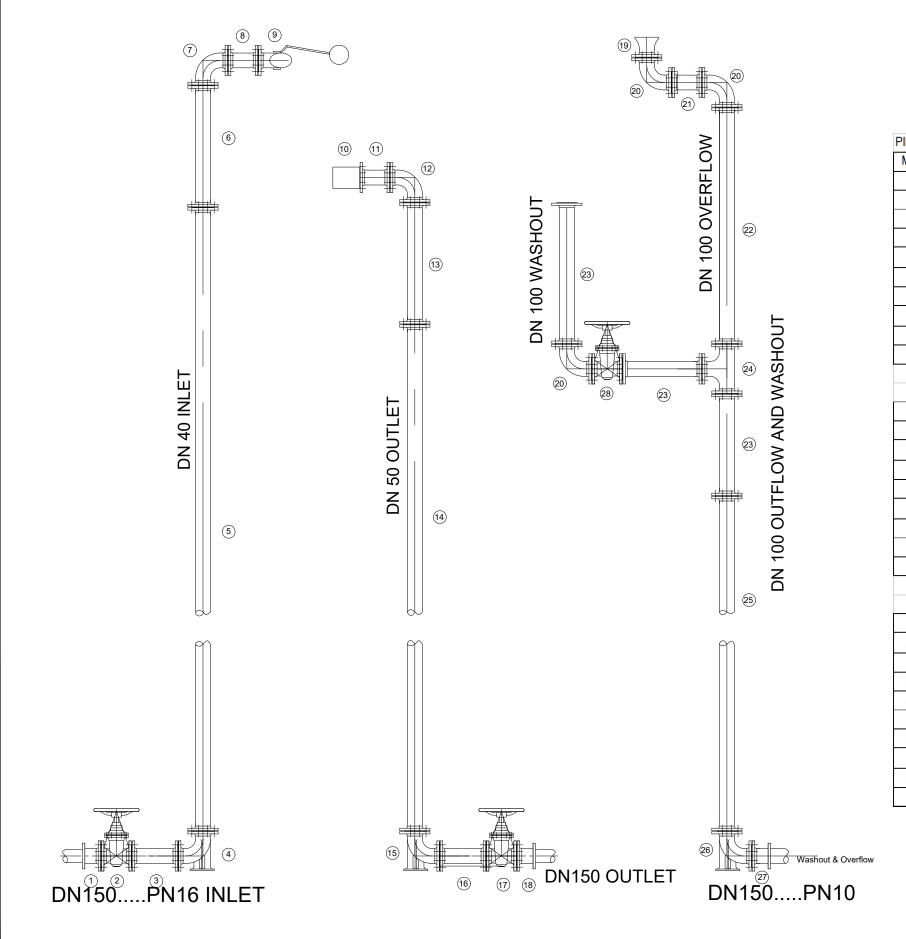

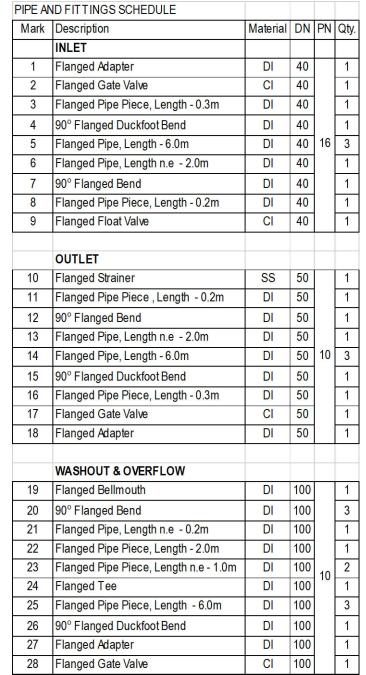







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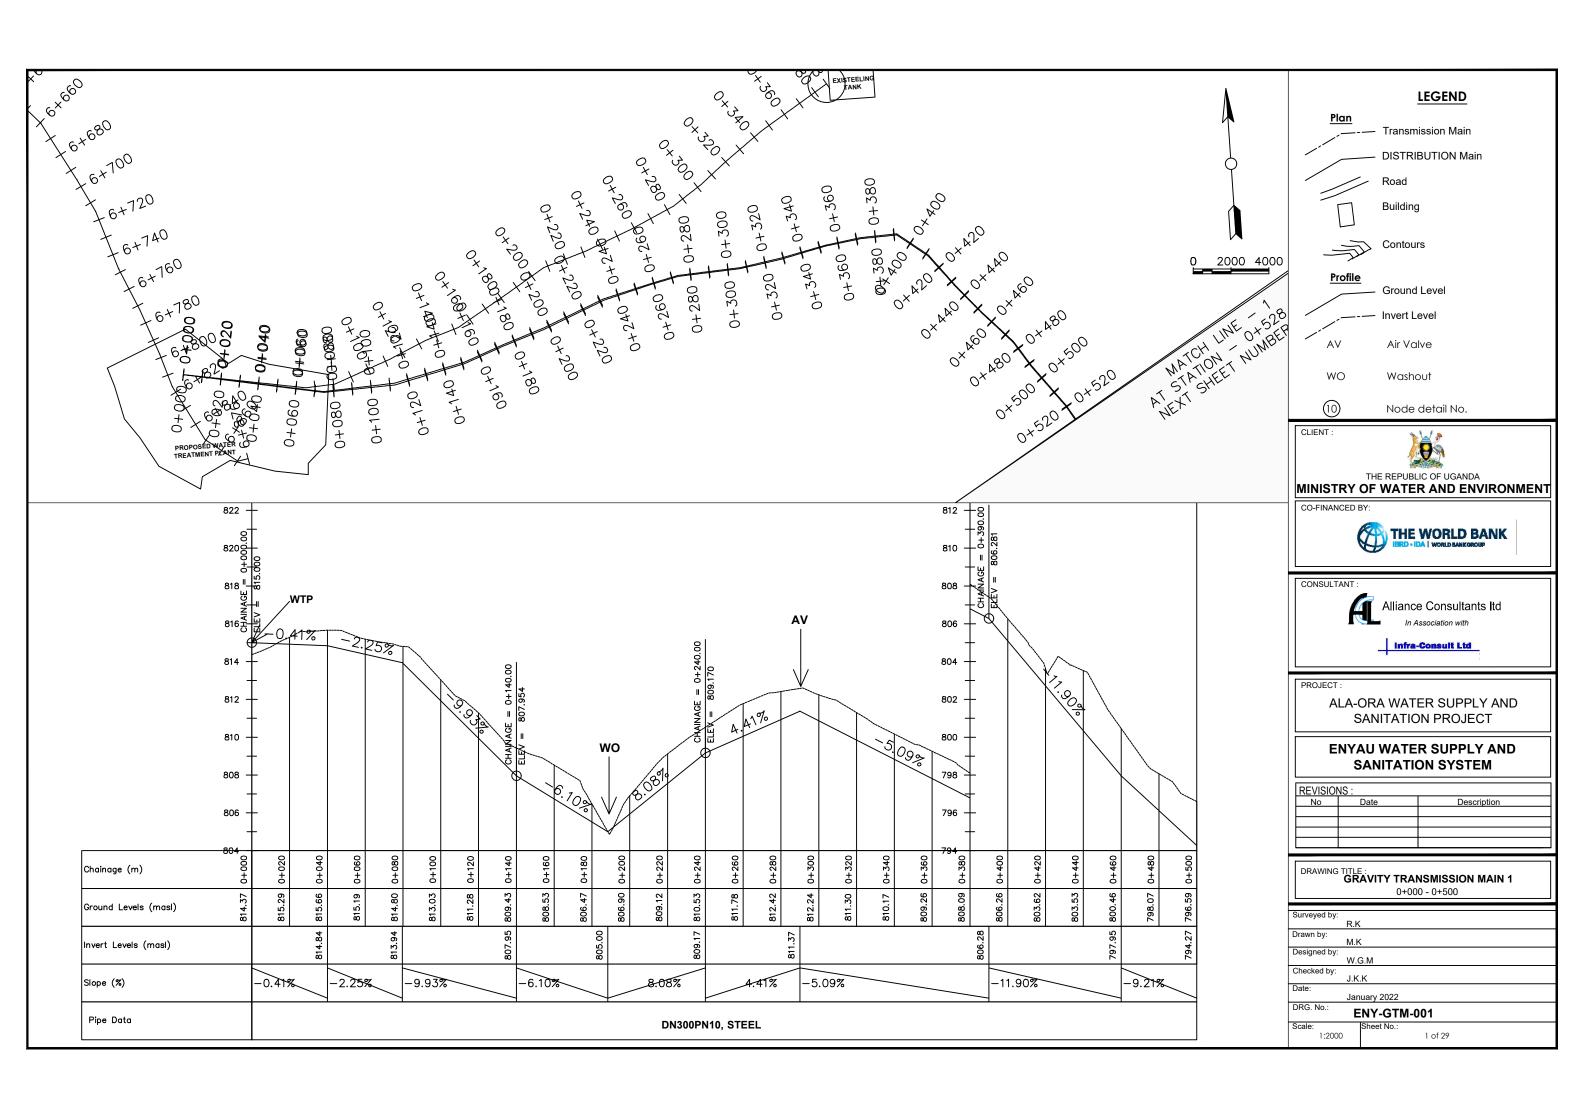
ALA-ORA WATER SUPPLY AND
SANITATION PROJECT


ENYAU WATER SUPPLY AND SANITATION SYSTEM


REVISIONS:				
Date	Description			
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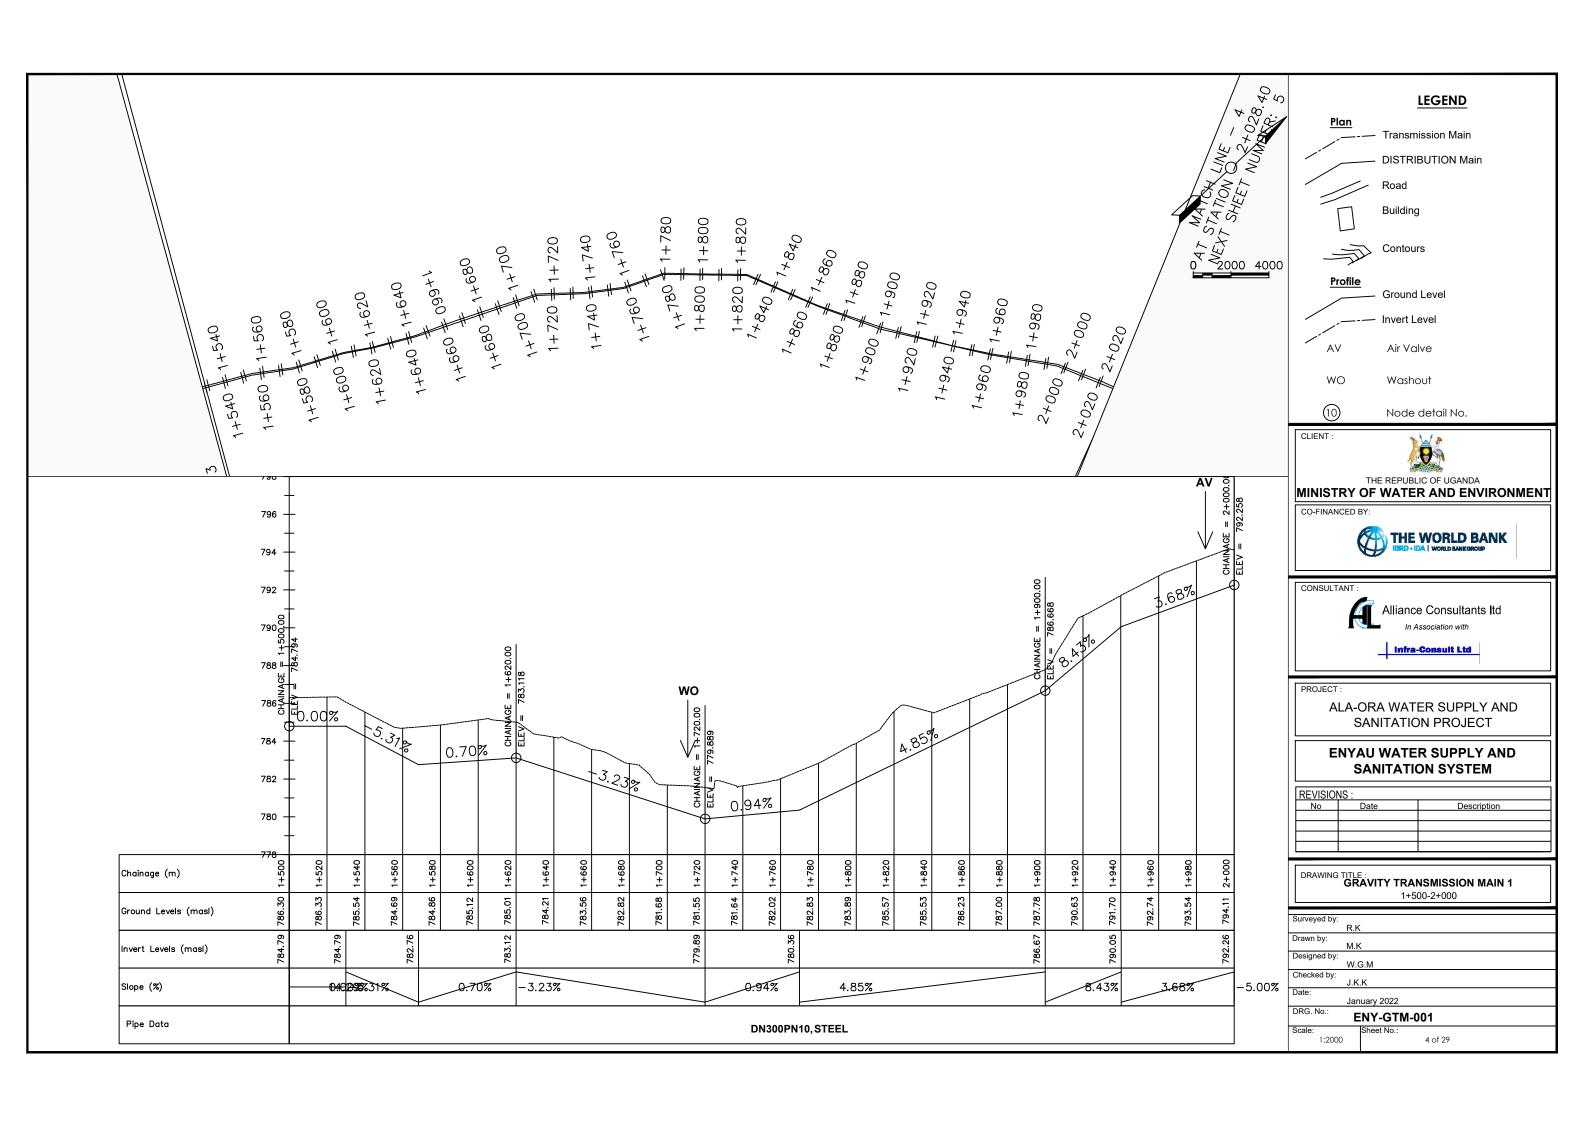
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IMVEPI RESERVOIR TANK 1- 15m³
PIPE FITTINGS


Surveyed by:	
, ,	R.K
Drawn by:	
,	N.R
Designed by:	
	W.G.M
Checked by:	
· ·	J.K.K
Date:	
	January 2023
DRG. No.: 🛌	NV DEC MVD 004
	NY_RES_MVP_001
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1:25	3 of 3






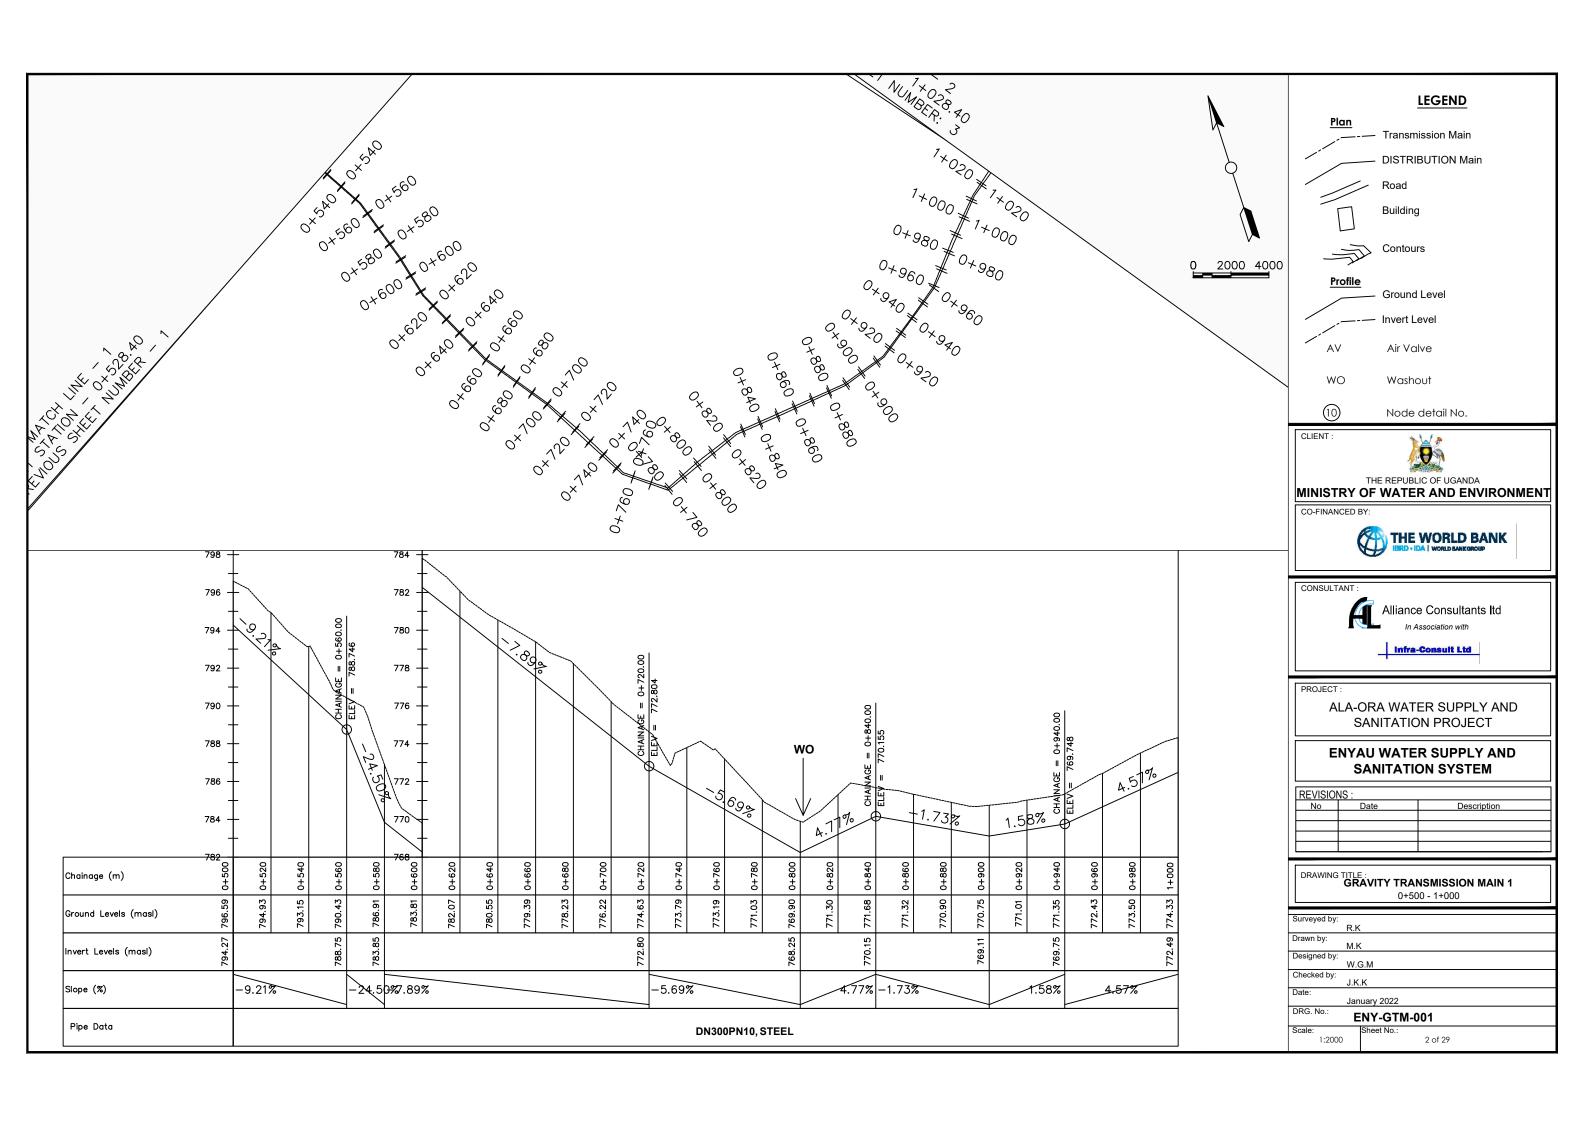


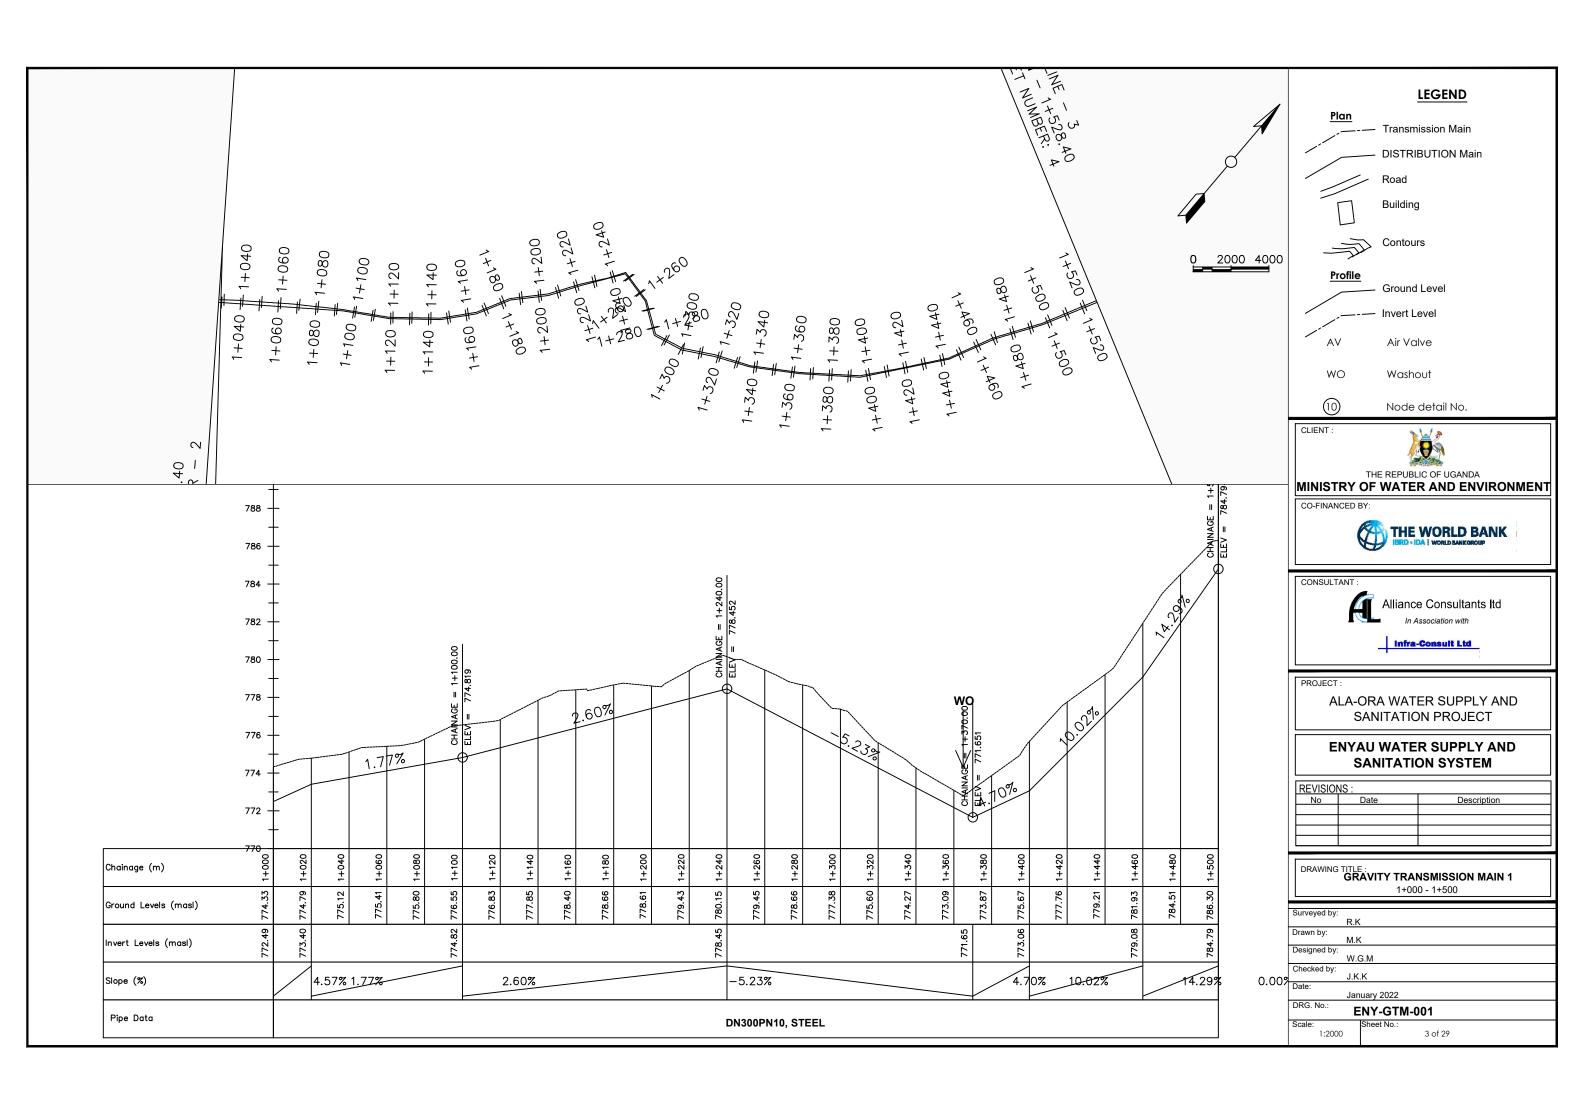


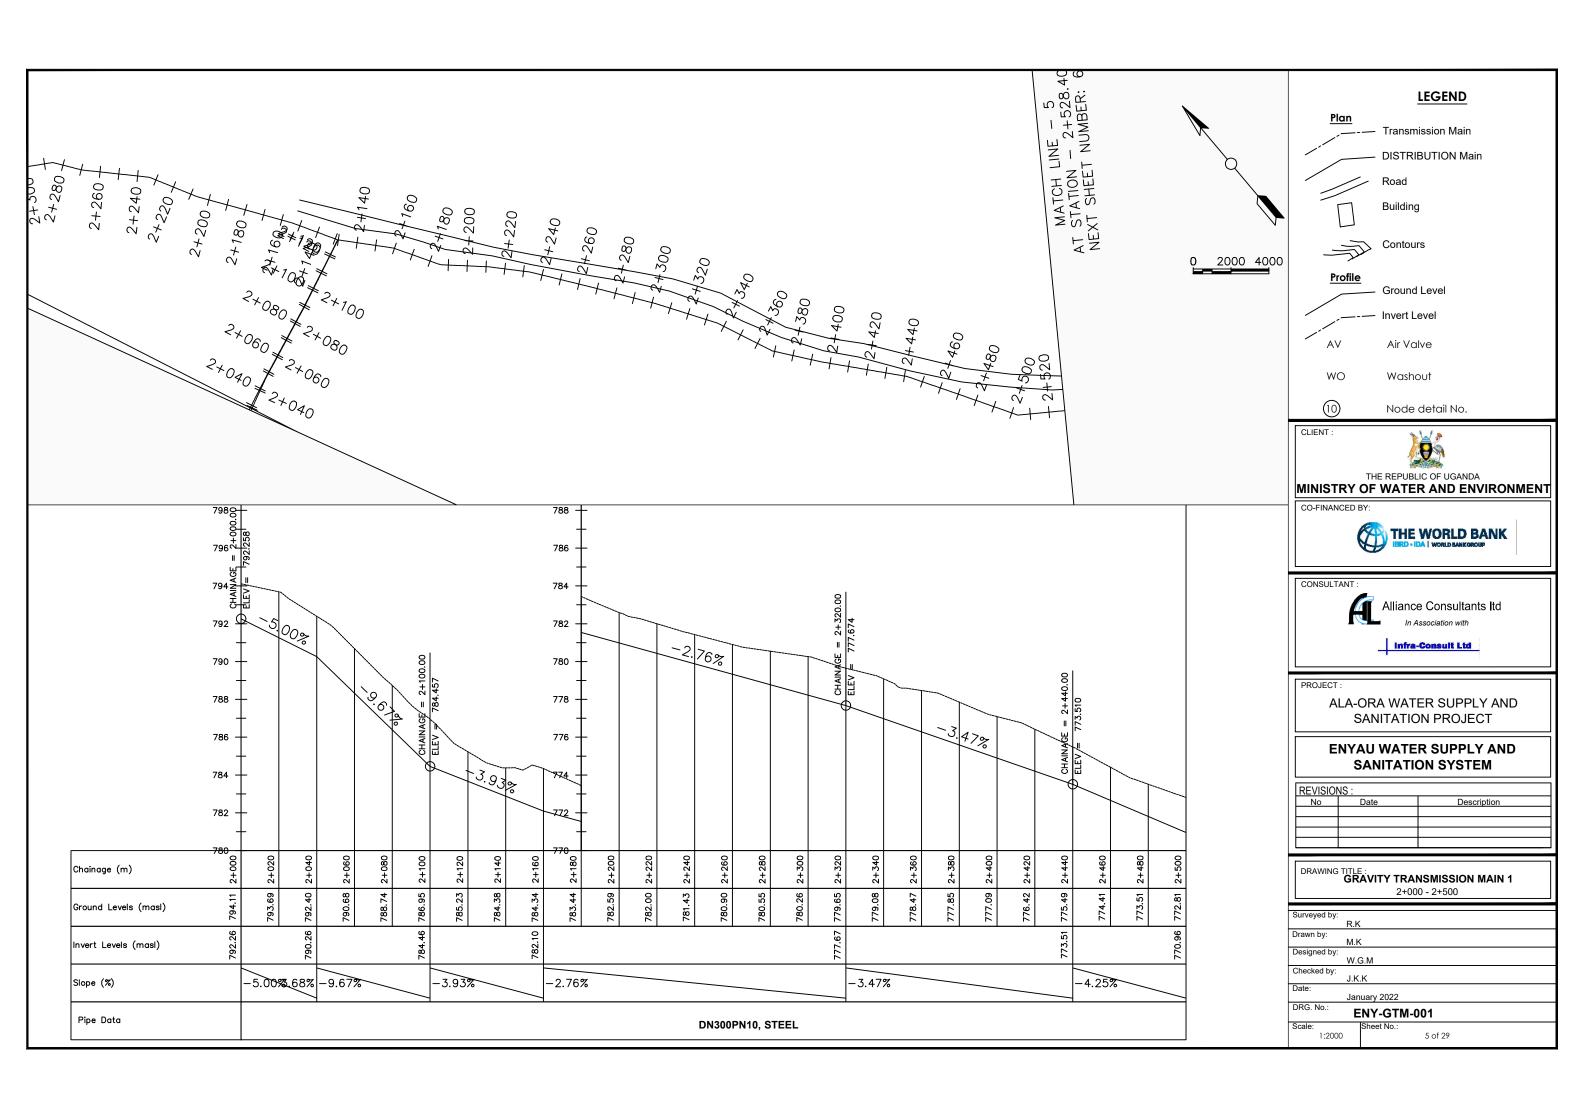


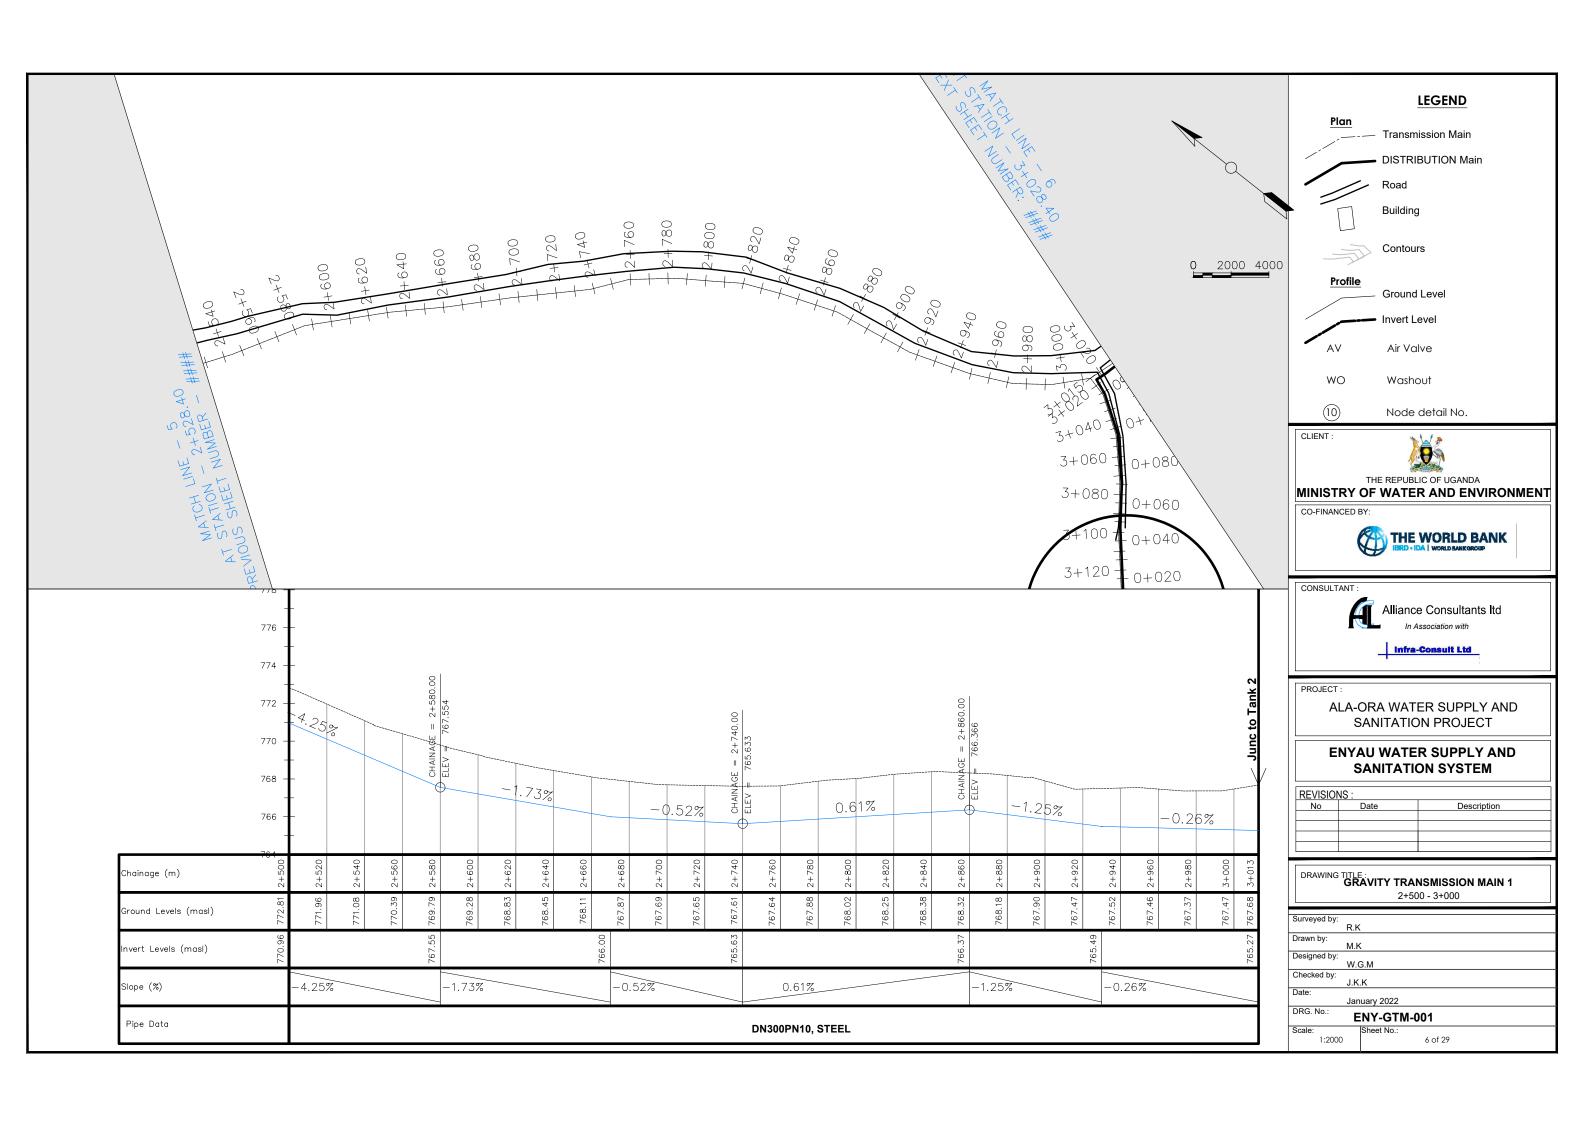


202m³ RESERVOIR (TANK 2/MVEPI ZONE 3) AREA

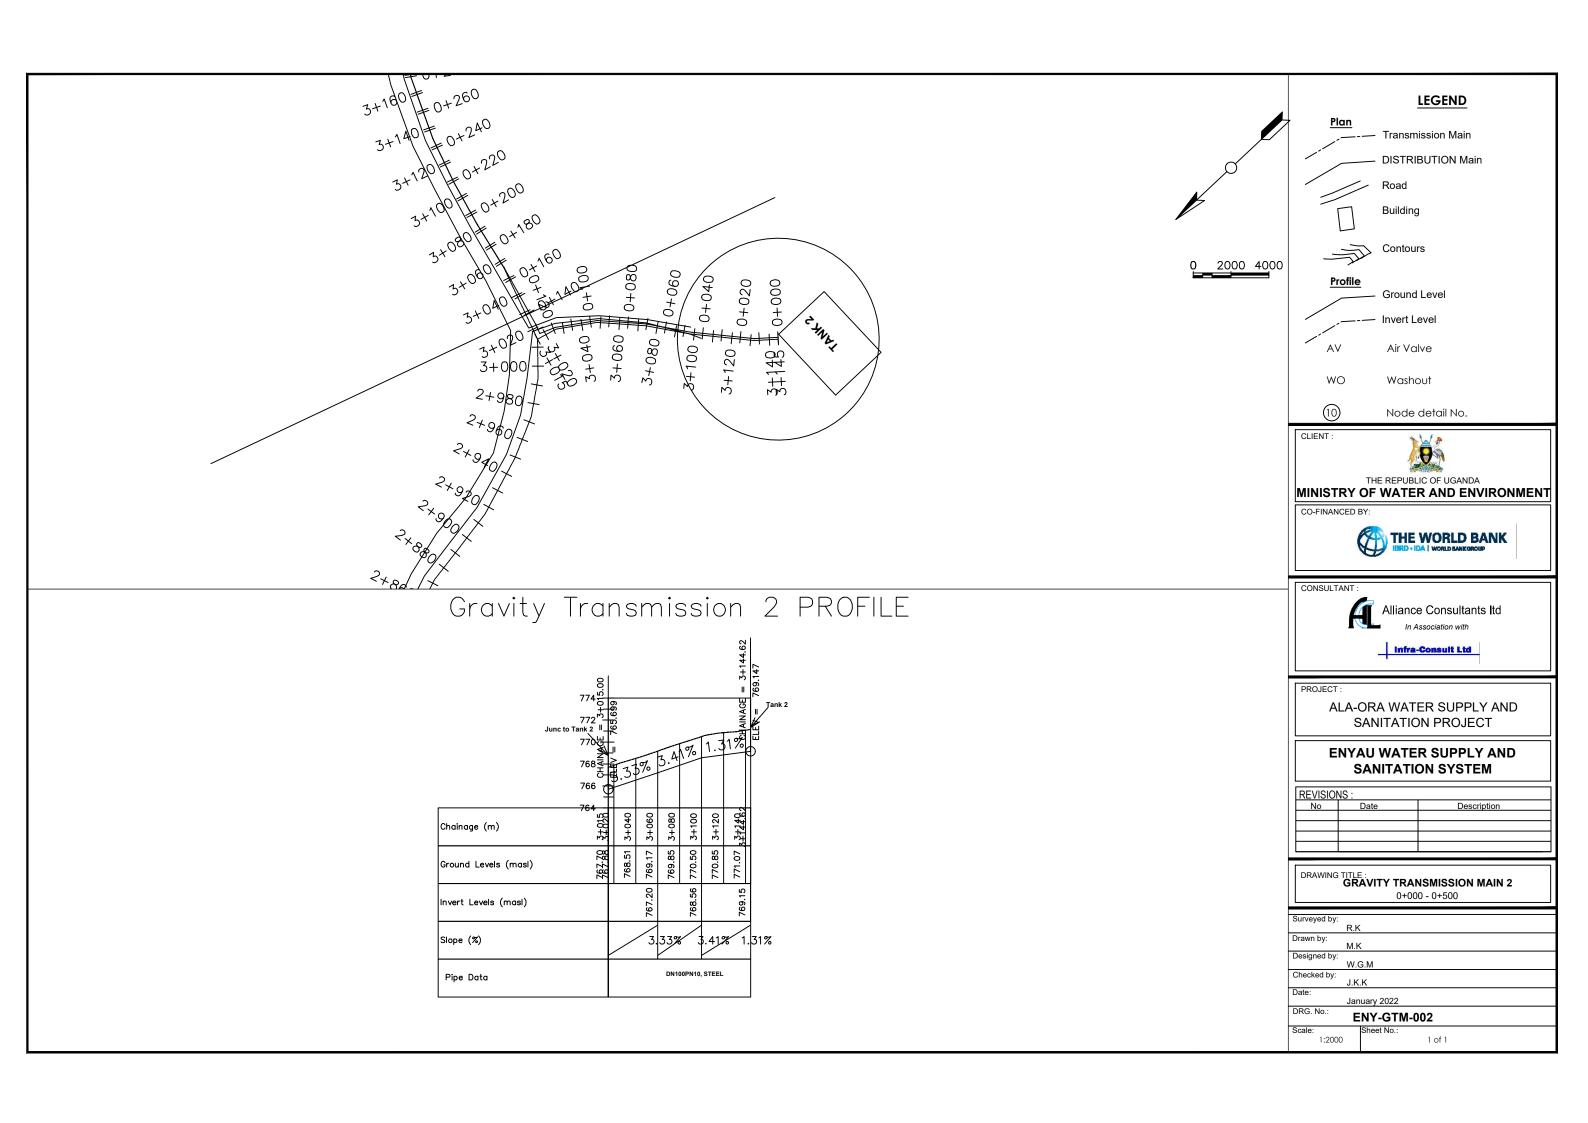

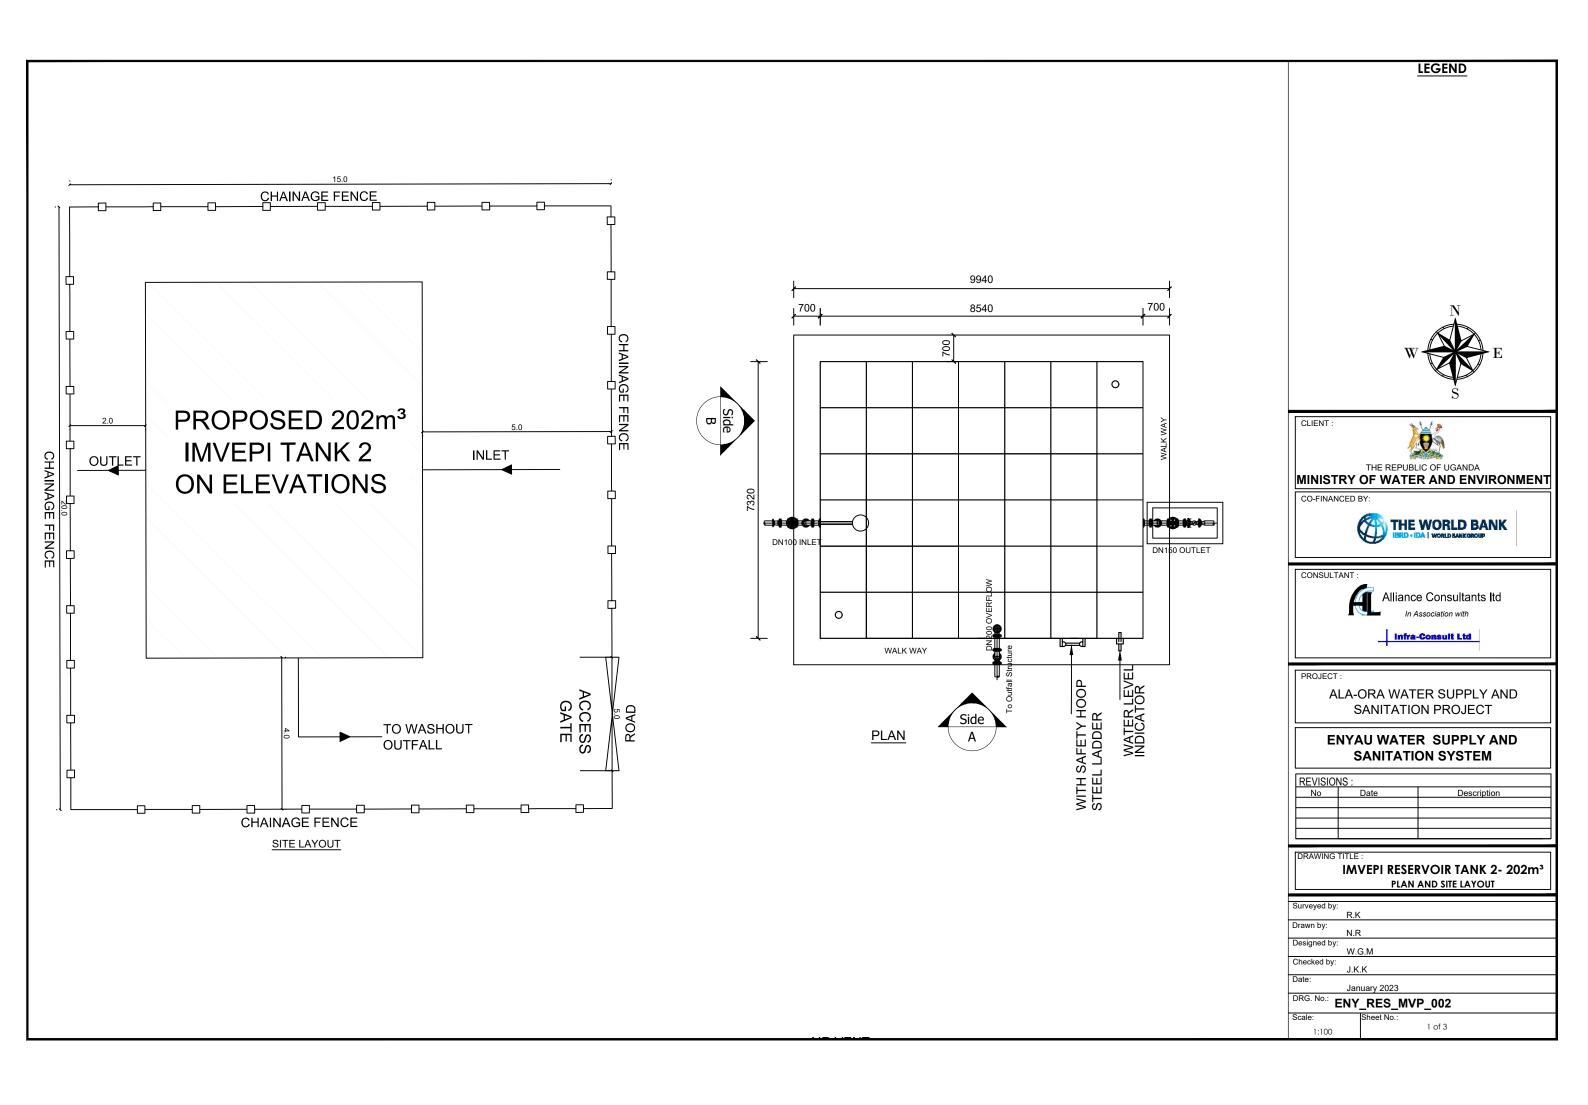

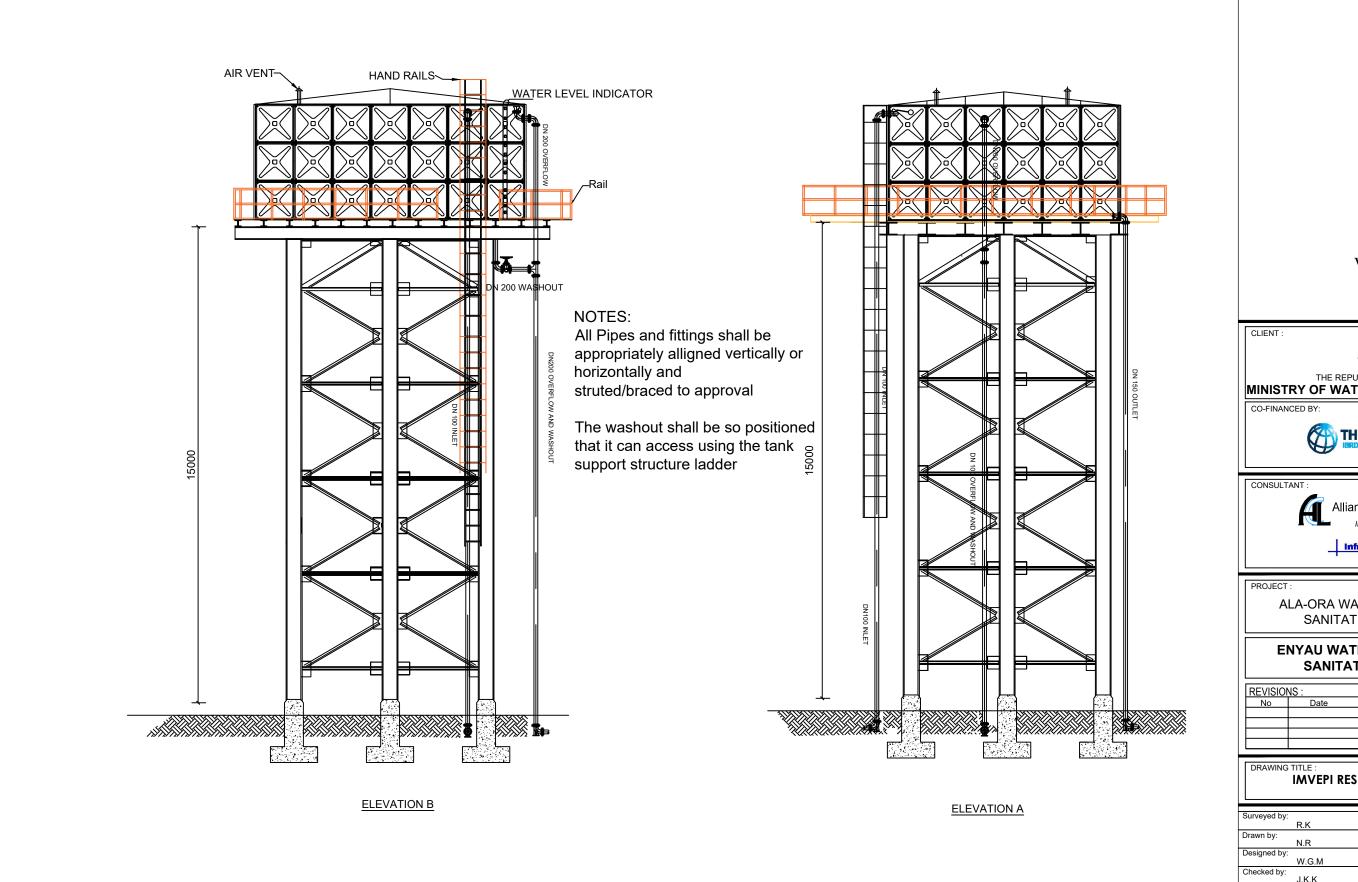

LEGEND

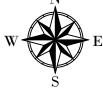

THE REPUBLIC OF UGANDA

MINISTRY OF WATER AND ENVIRONMENT

CO-FINANCED BY:

THE WORLD BANK

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Alliance Consultants Itd

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ALA-ORA WATER SUPPLY AND SANITATION PROJECT


ENYAU WATER SUPPLY AND SANITATION SYSTEM

REVISIONS:				
Date	Description			

DRAWING TITLE:


IMVEPI RESERVOIR TANK 2- 202m³

ELEVATIONS

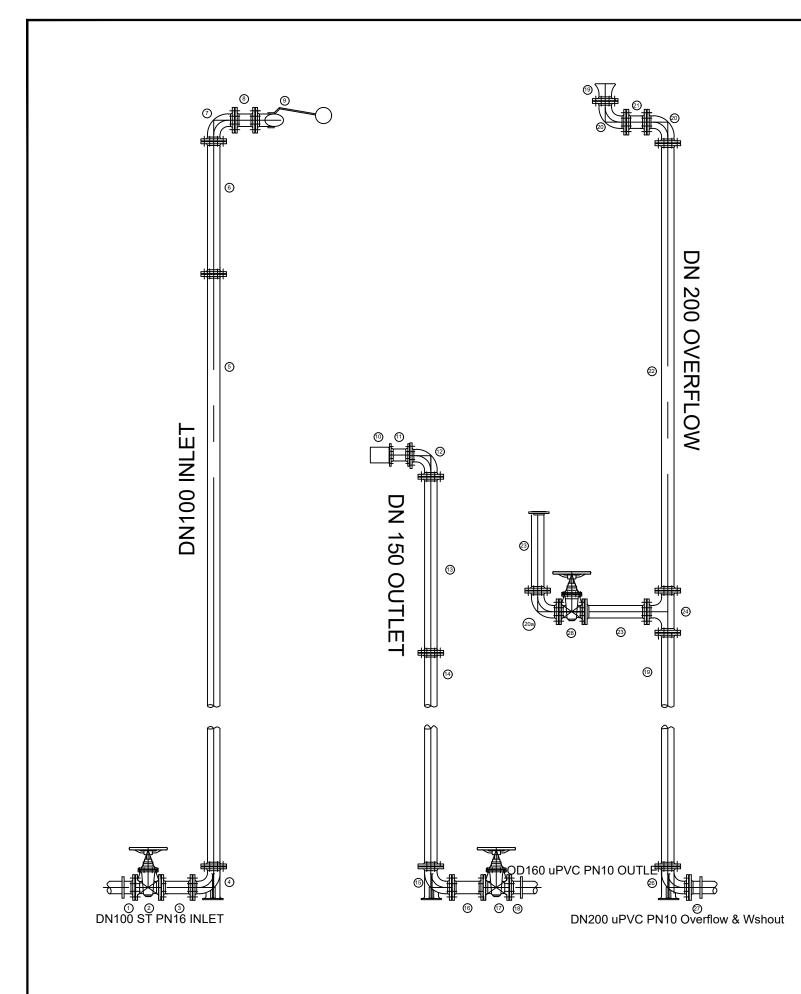

Mark	Description	Material	DN	PN	Qty
	INLET				
1	Flanged Adapter	DI	100		1
2	Flanged Gate Valve	CI	100	*	1
3	Flanged Pipe Piece, Length - 0.3m	DI	100		1
4	90° Flanged Duckfoot Bend	DI	100		1
5	Flanged Pipe, Length - 6.0m	DI	100	16	3
6	Flanged Pipe, Length n.e - 3.0m	DI	100		1
7	90° Flanged Bend	DI	100	e.	1
8	Flanged Pipe Piece, Length - 0.2m	DI	100		1
9	Flanged Float Valve	CI	100		1
	OUTLET				
10	Flanged Strainer	SS	150		1
11	Flanged Pipe Piece , Length - 0.2m	DI	150		1
12	90° Flanged Bend	DI	150	,	1
13	Flanged Pipe, Length n.e - 5.0m	DI	150		1
14	Flanged Pipe, Length - 6.0m	DI	150	10	2
15	90° Flanged Duckfoot Bend	DI	150		1
16	Flanged Pipe Piece, Length - 0.3m	DI	150		1
17	Flanged Gate Valve	CI	150		1
18	Flanged Adapter	DI	150		1
	WASHOUT & OVERFLOW				
19	Flanged Bellmouth	DI	200		1
20	90° Flanged Bend	DI	200		2
21	Flanged Pipe, Length n.e - 0.2m	DI	200		1
22	Flanged Pipe Piece, Length - 5.0m	DI	200		2
20a	90° Flanged Bend	DI	100		1
23			100	10	2
24 Flanged Tee		DI	200/100		1
25 Flanged Pipe Piece, Length - 6.0m		DI	200	ioi	3
26 90° Flanged Duckfoot Bend		DI	200	N.	1
27	Flanged Adapter	DI	200		1
28 Flanged Gate Valve		CI	100		



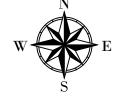



CLIENT :

CONSULTANT Alliance Consultants Itd


ALA-ORA WATER SUPPLY AND SANITATION PROJECT


ENYAU WATER SUPPLY AND SANITATION SYSTEM


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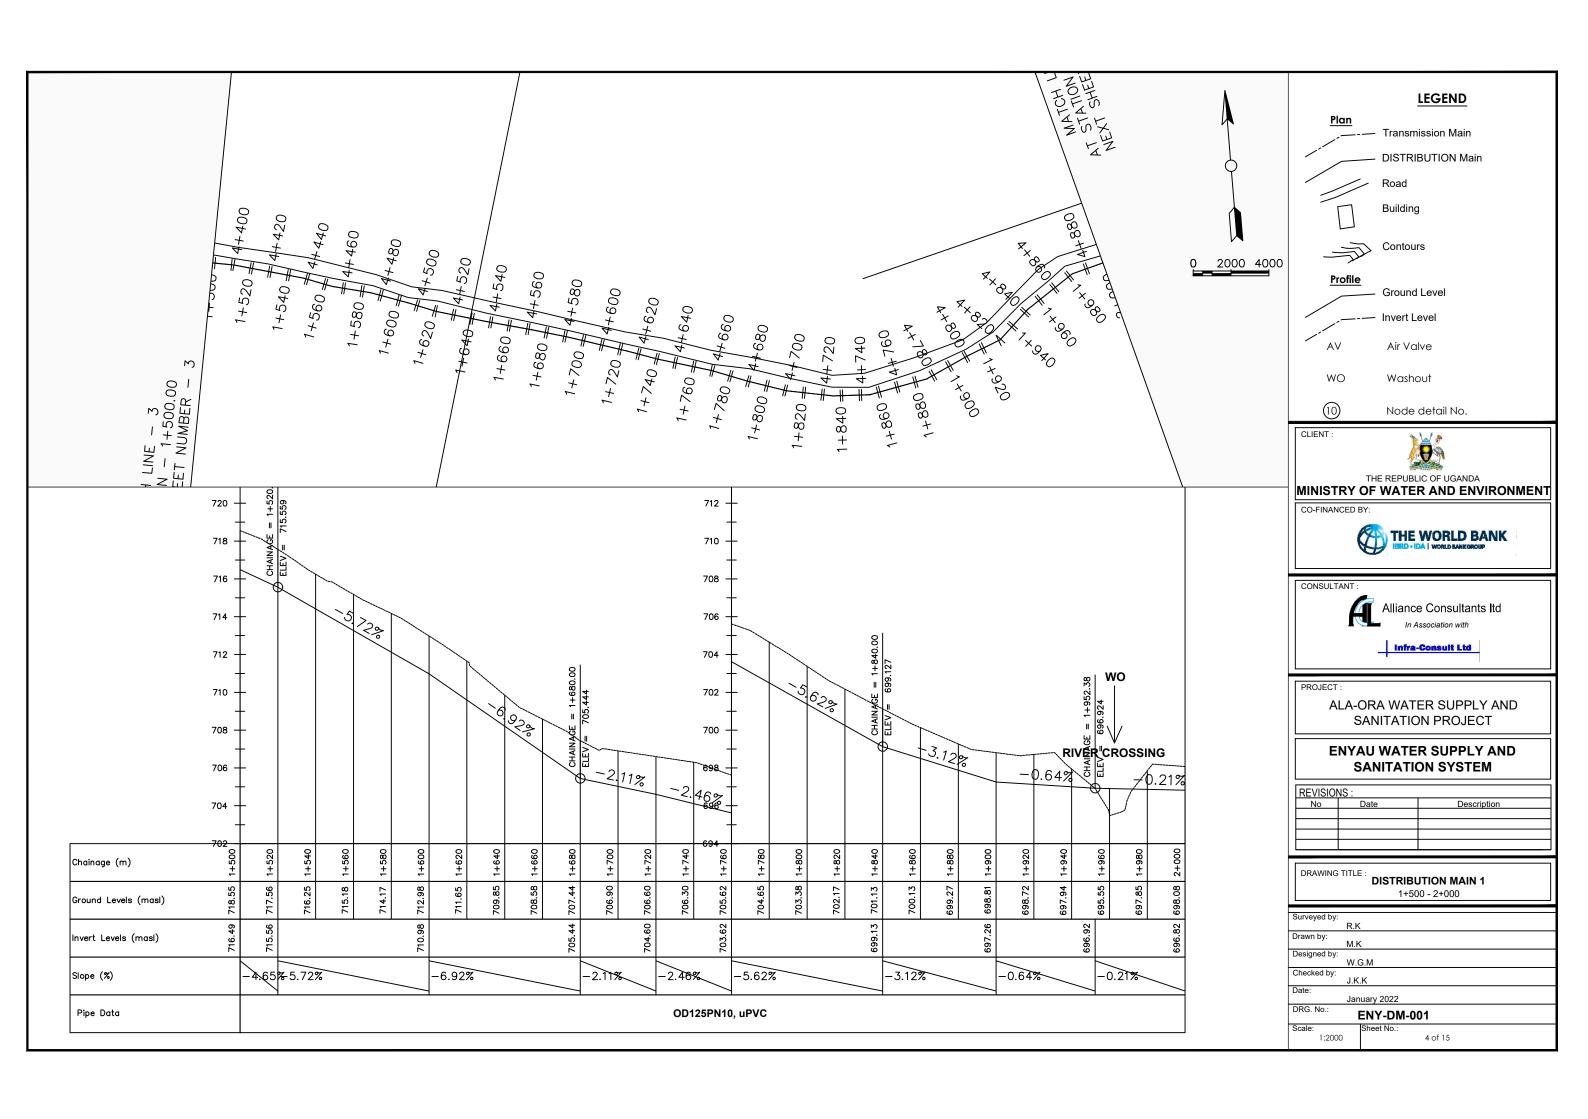
IMVEPI RESERVOIR TANK 2- 202m³ PIPE FITTINGS


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		R.K
	Drawn by:	
	'	N.R
	Designed by:	
		W.G.M
	Checked by:	
		J.K.K
	Date:	
		January 2023
	DRG. No.: _	NV DEC MVD 000
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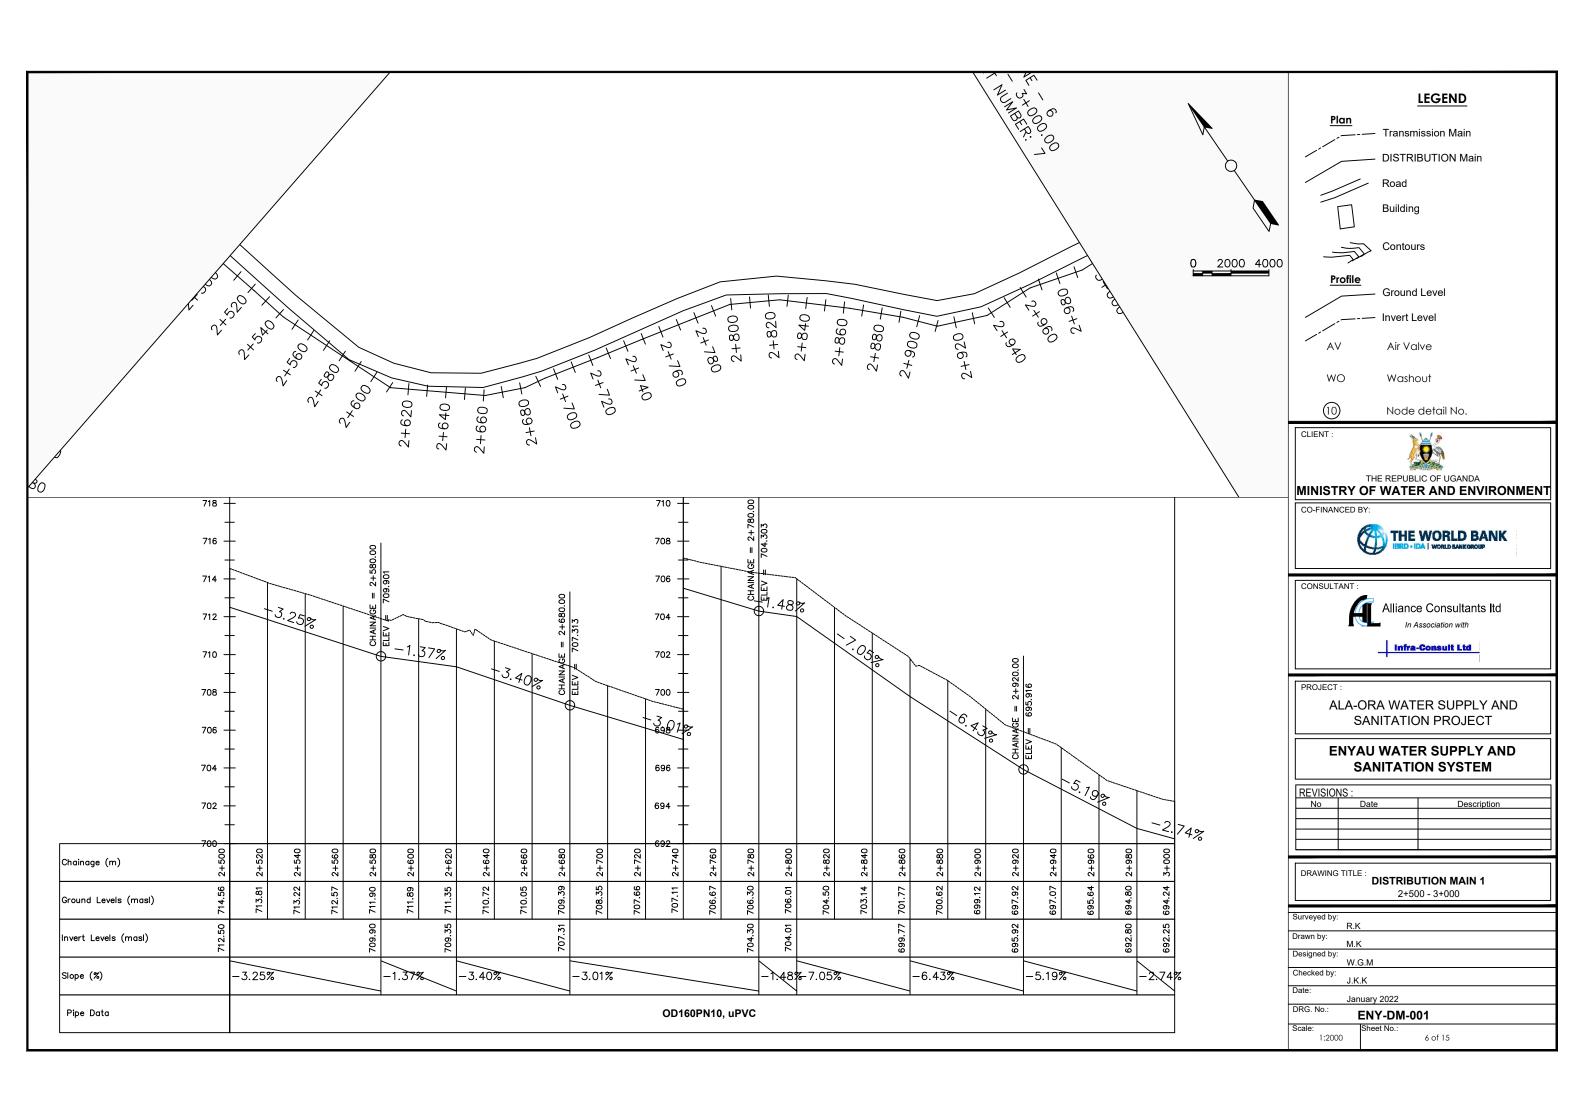





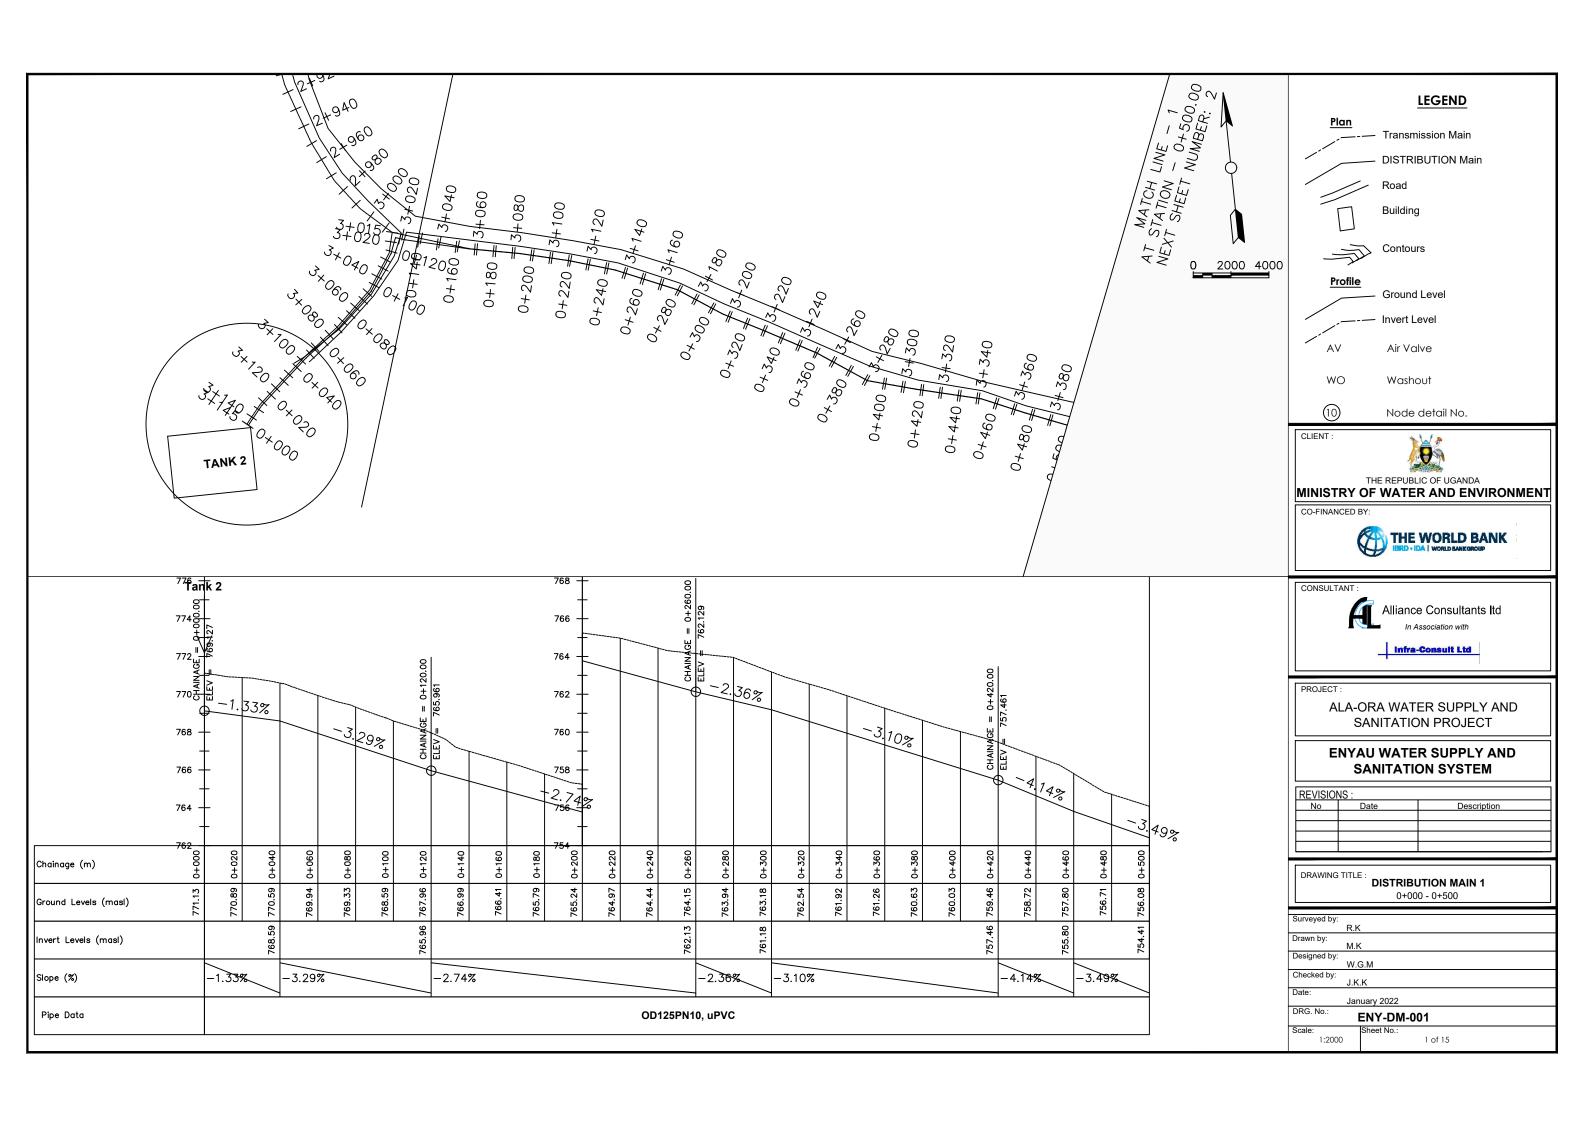


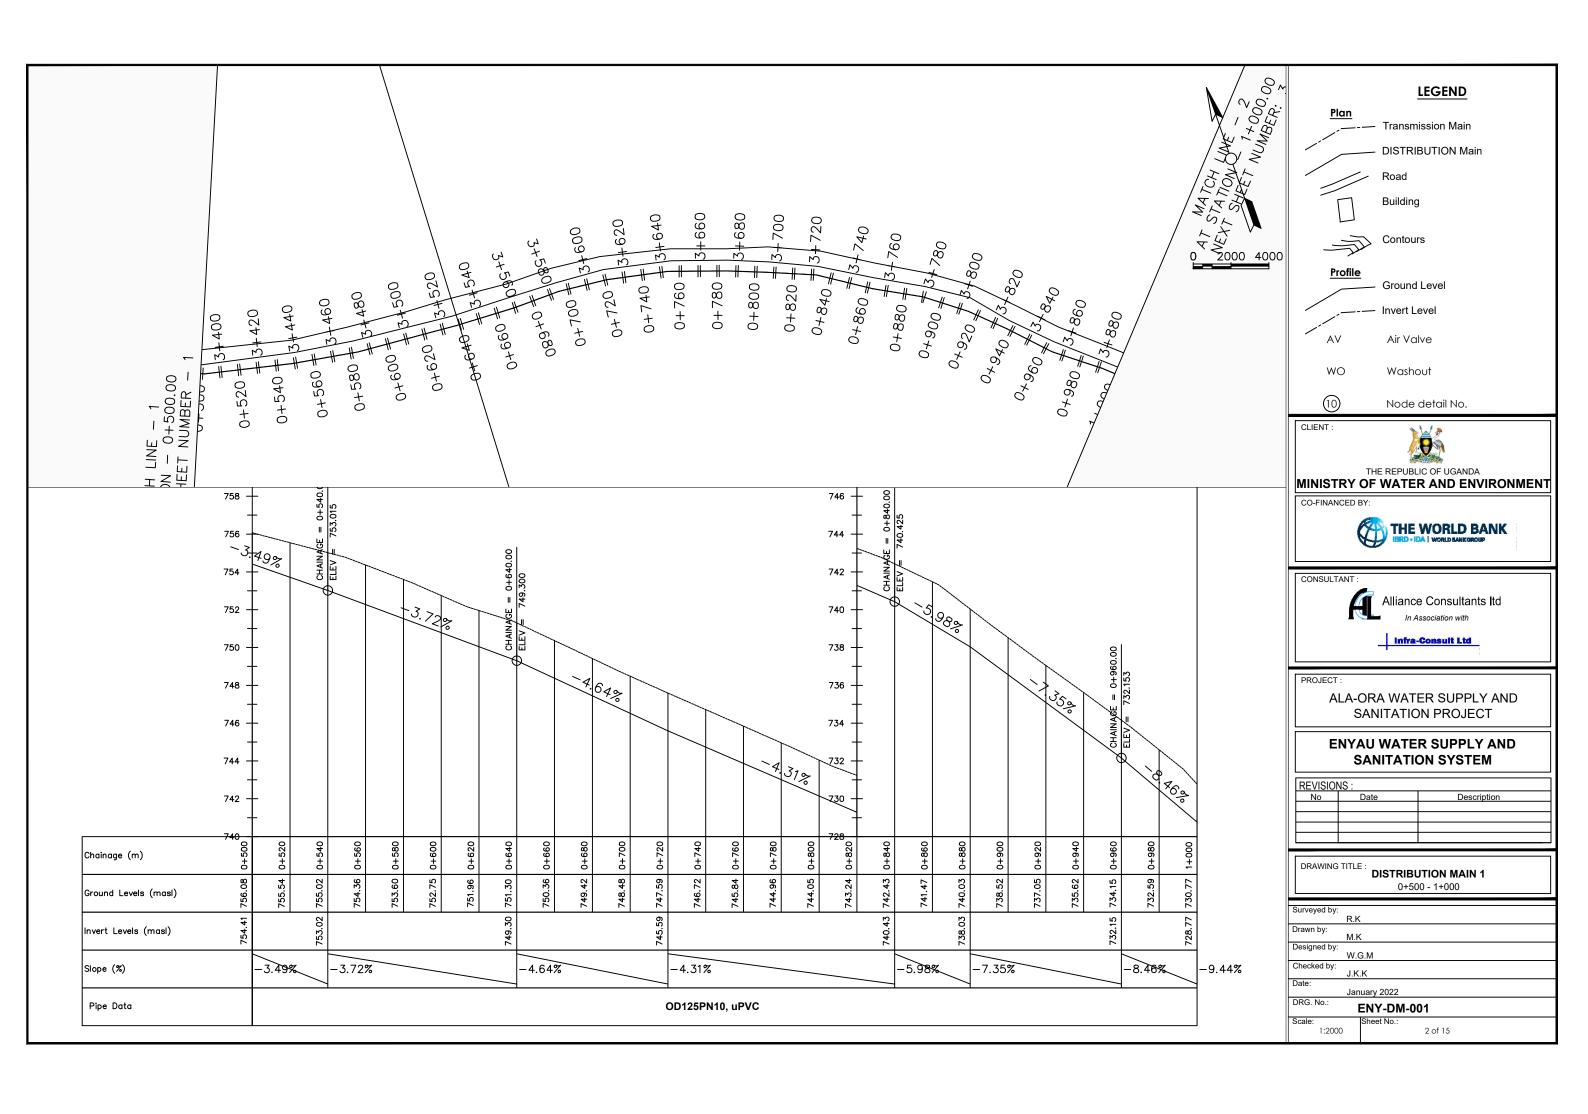


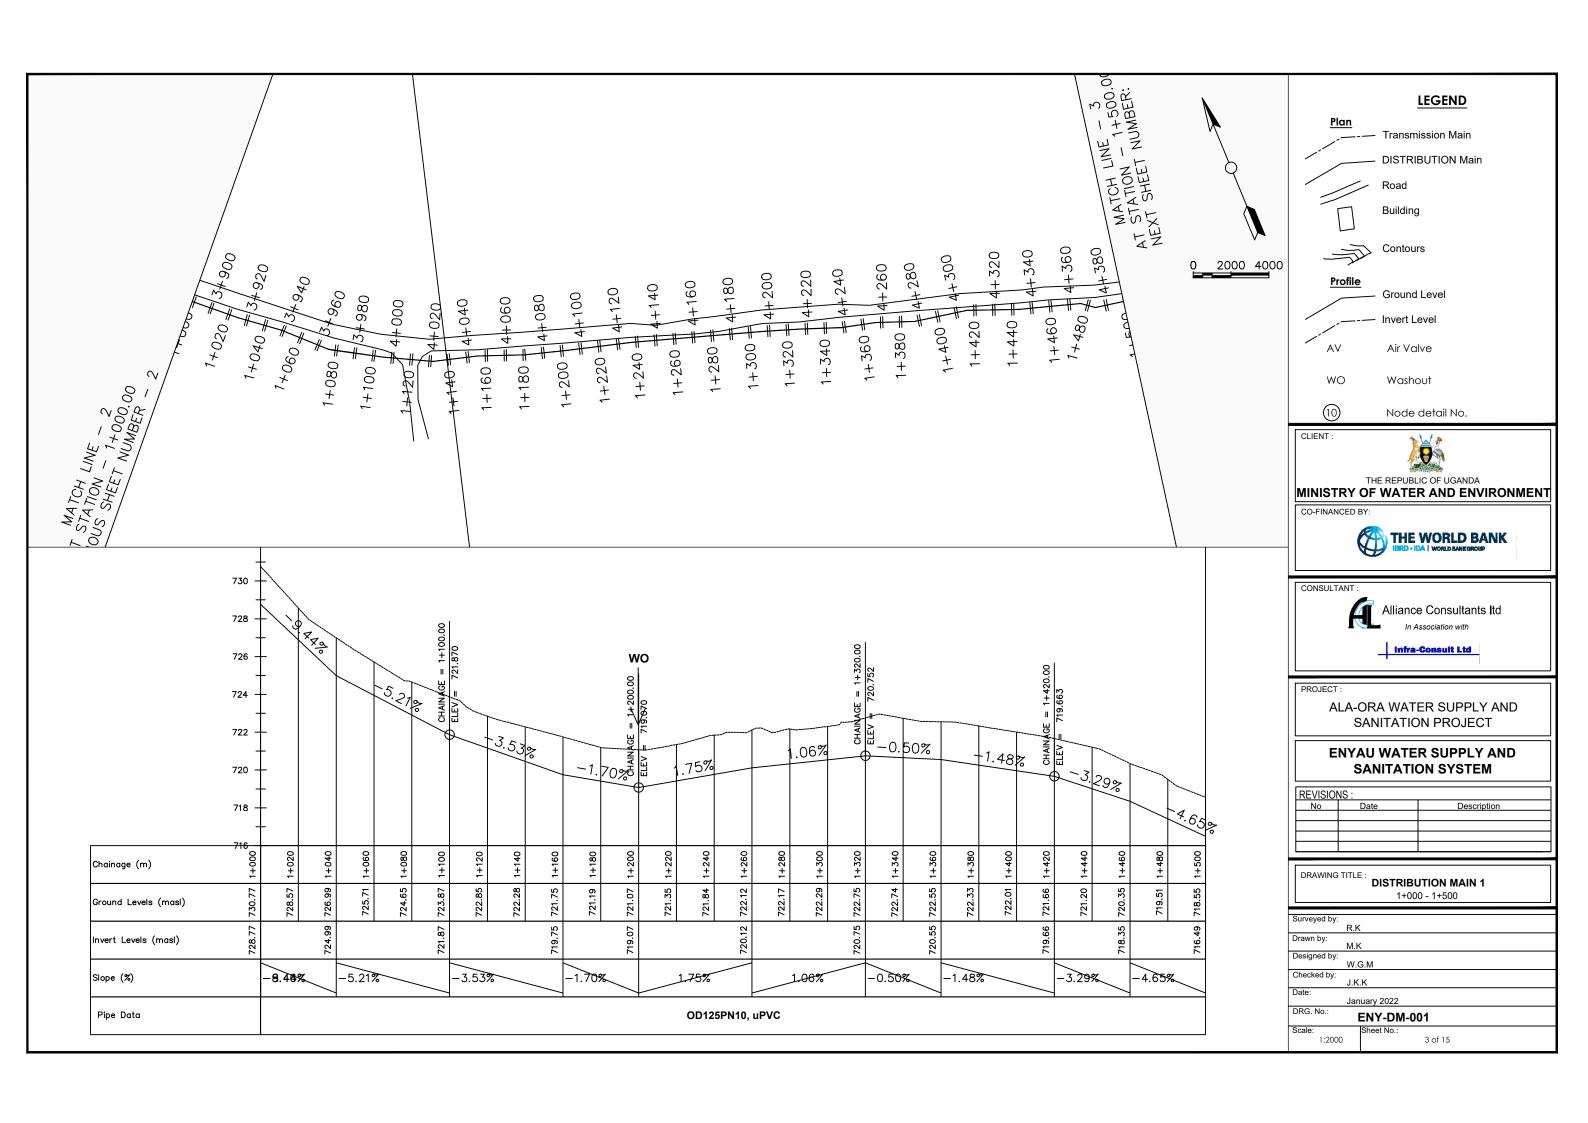


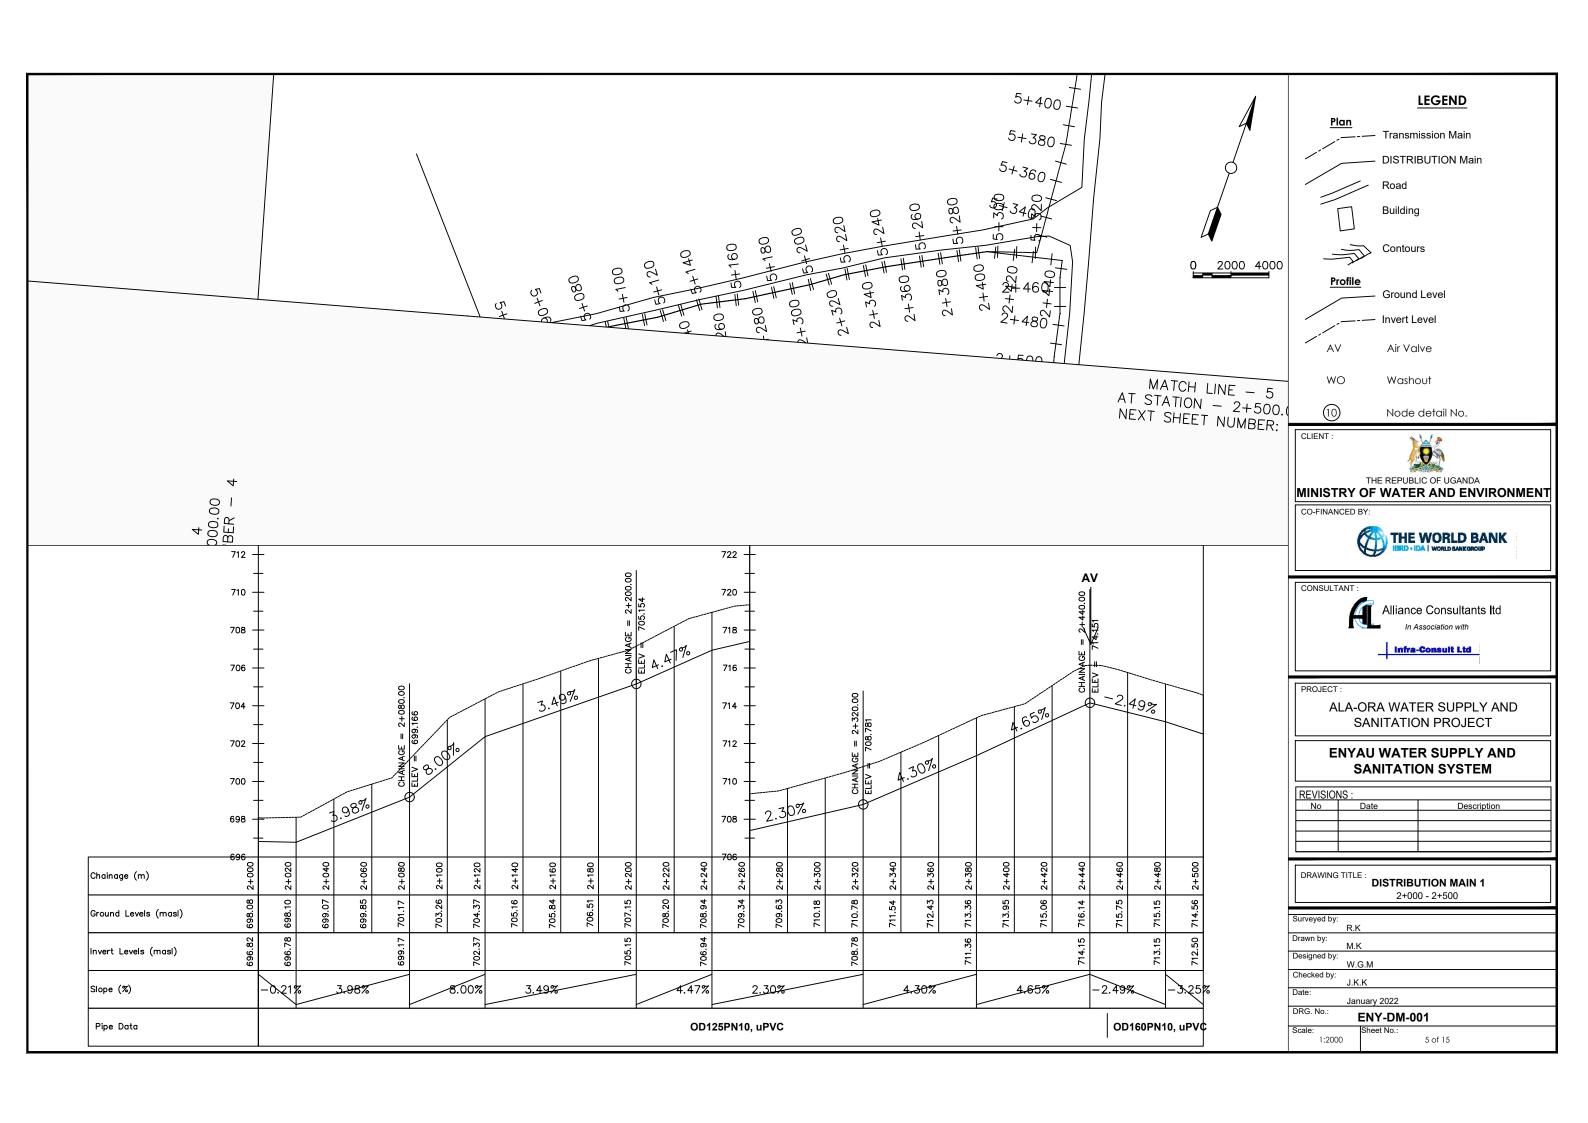


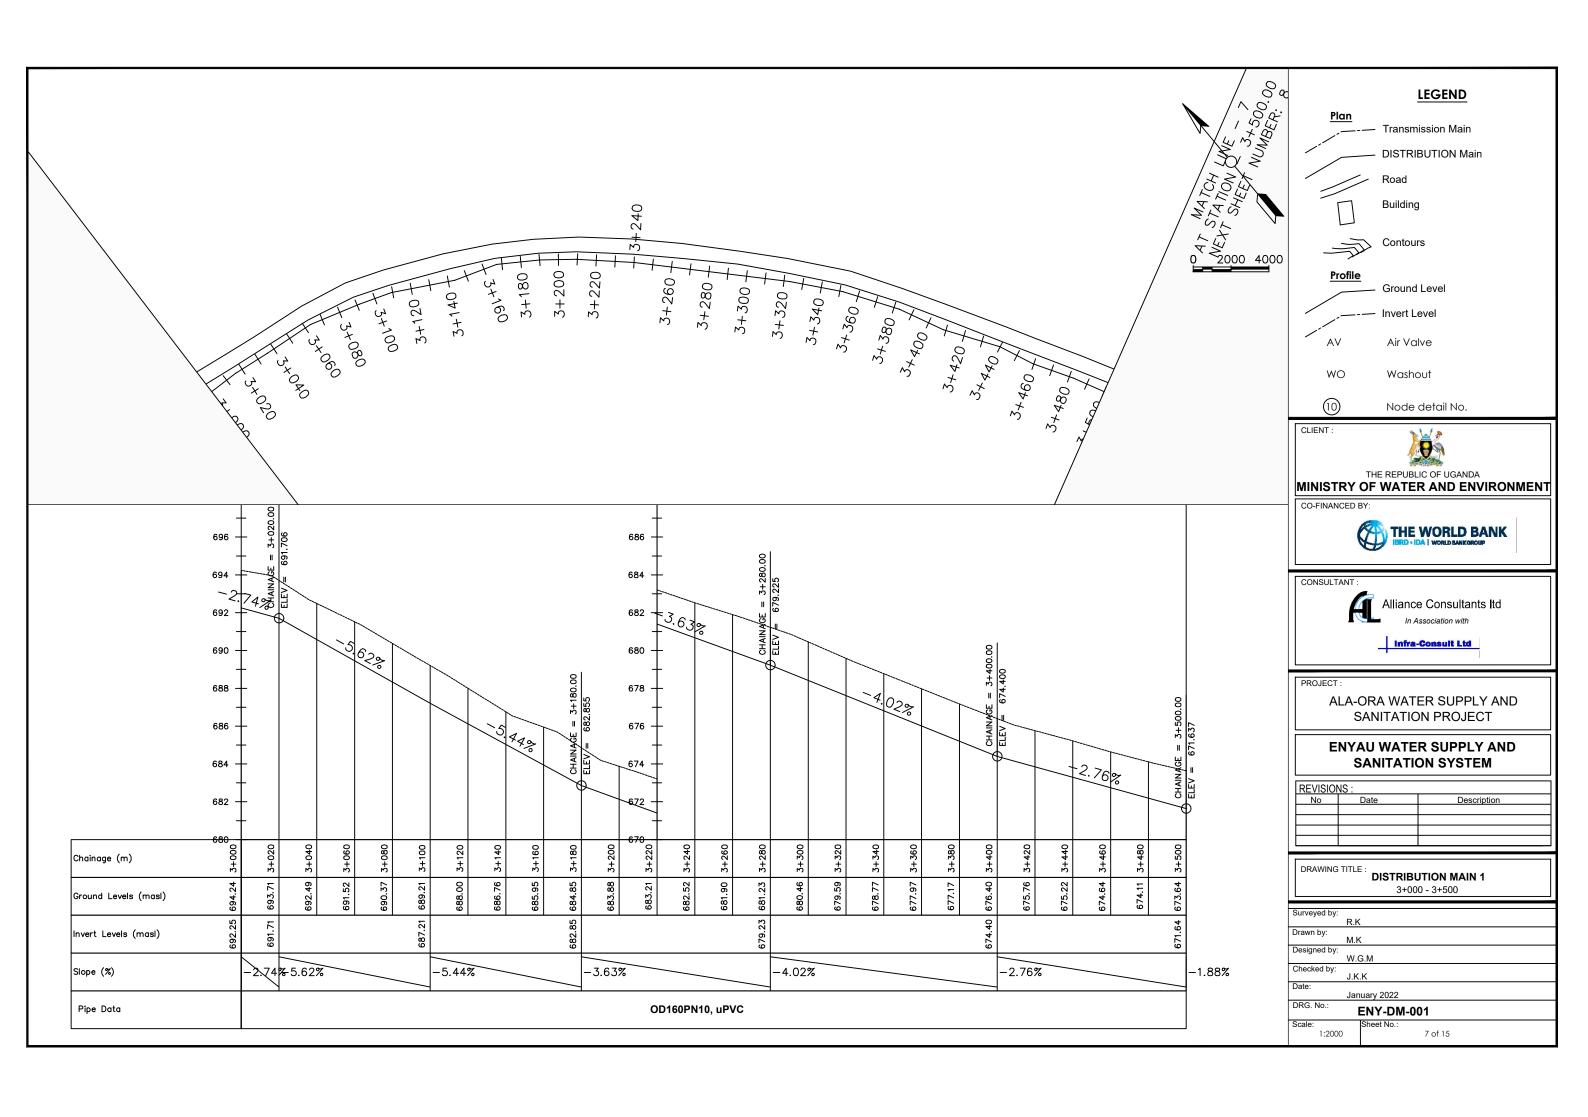


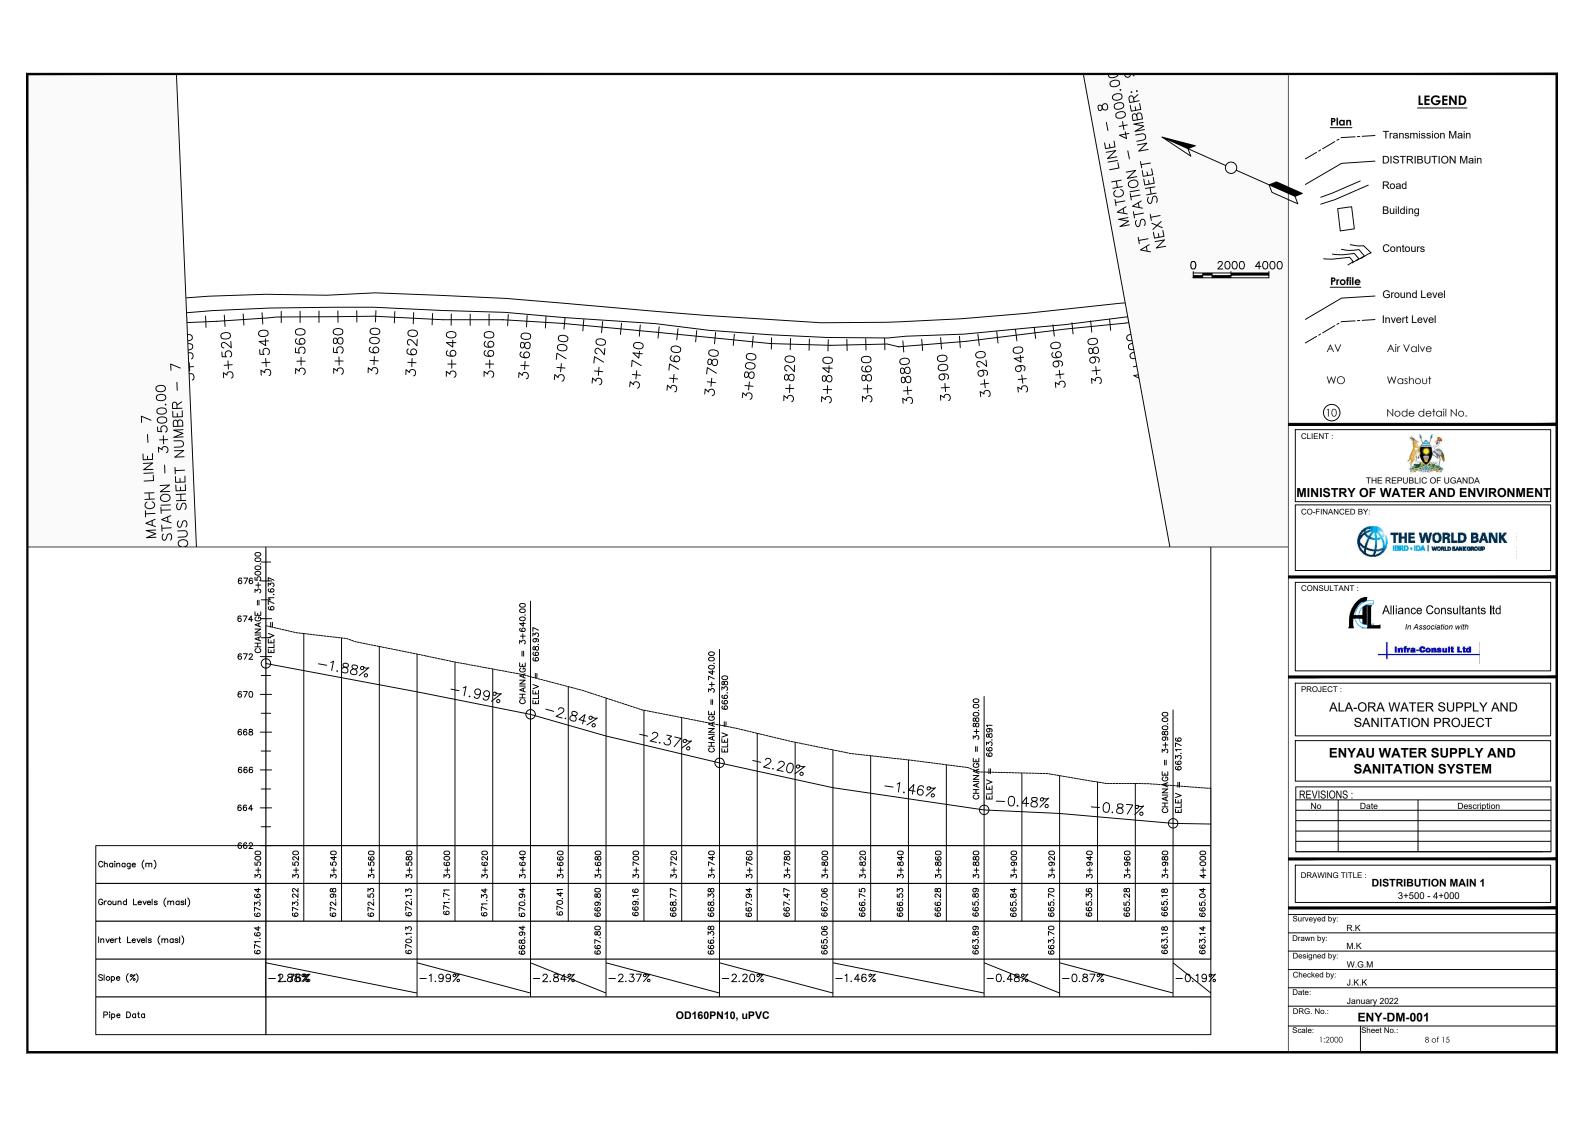


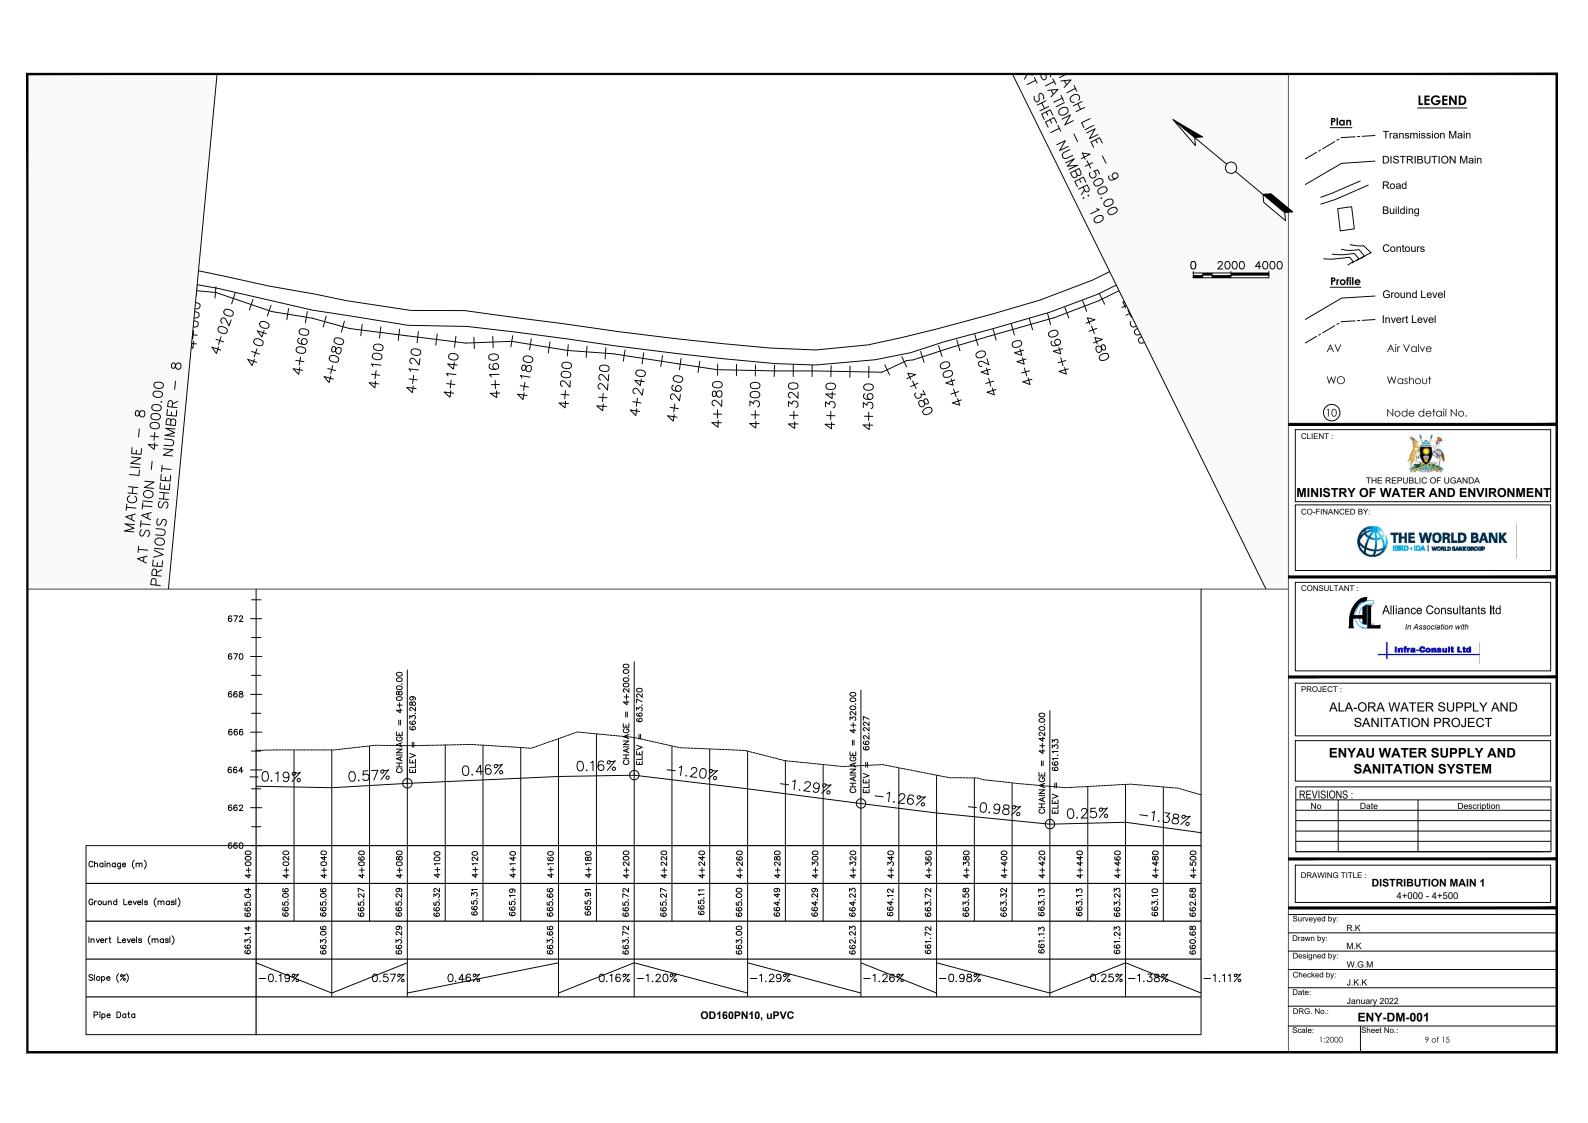


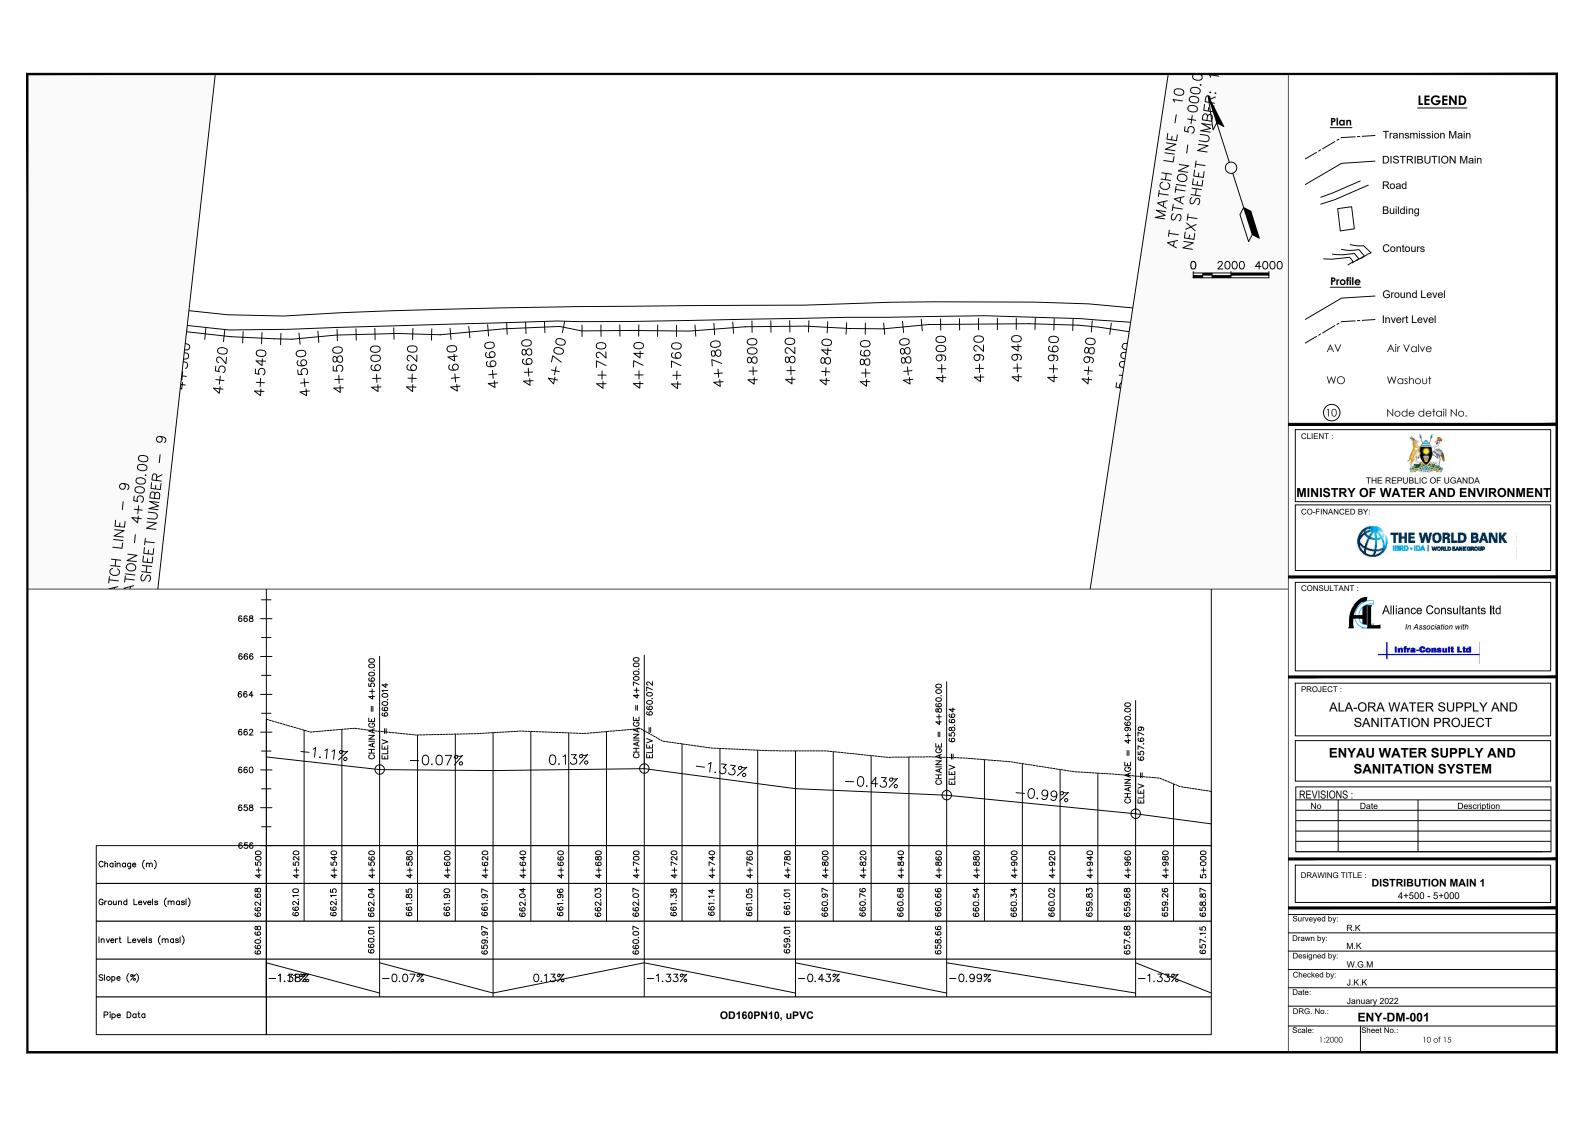


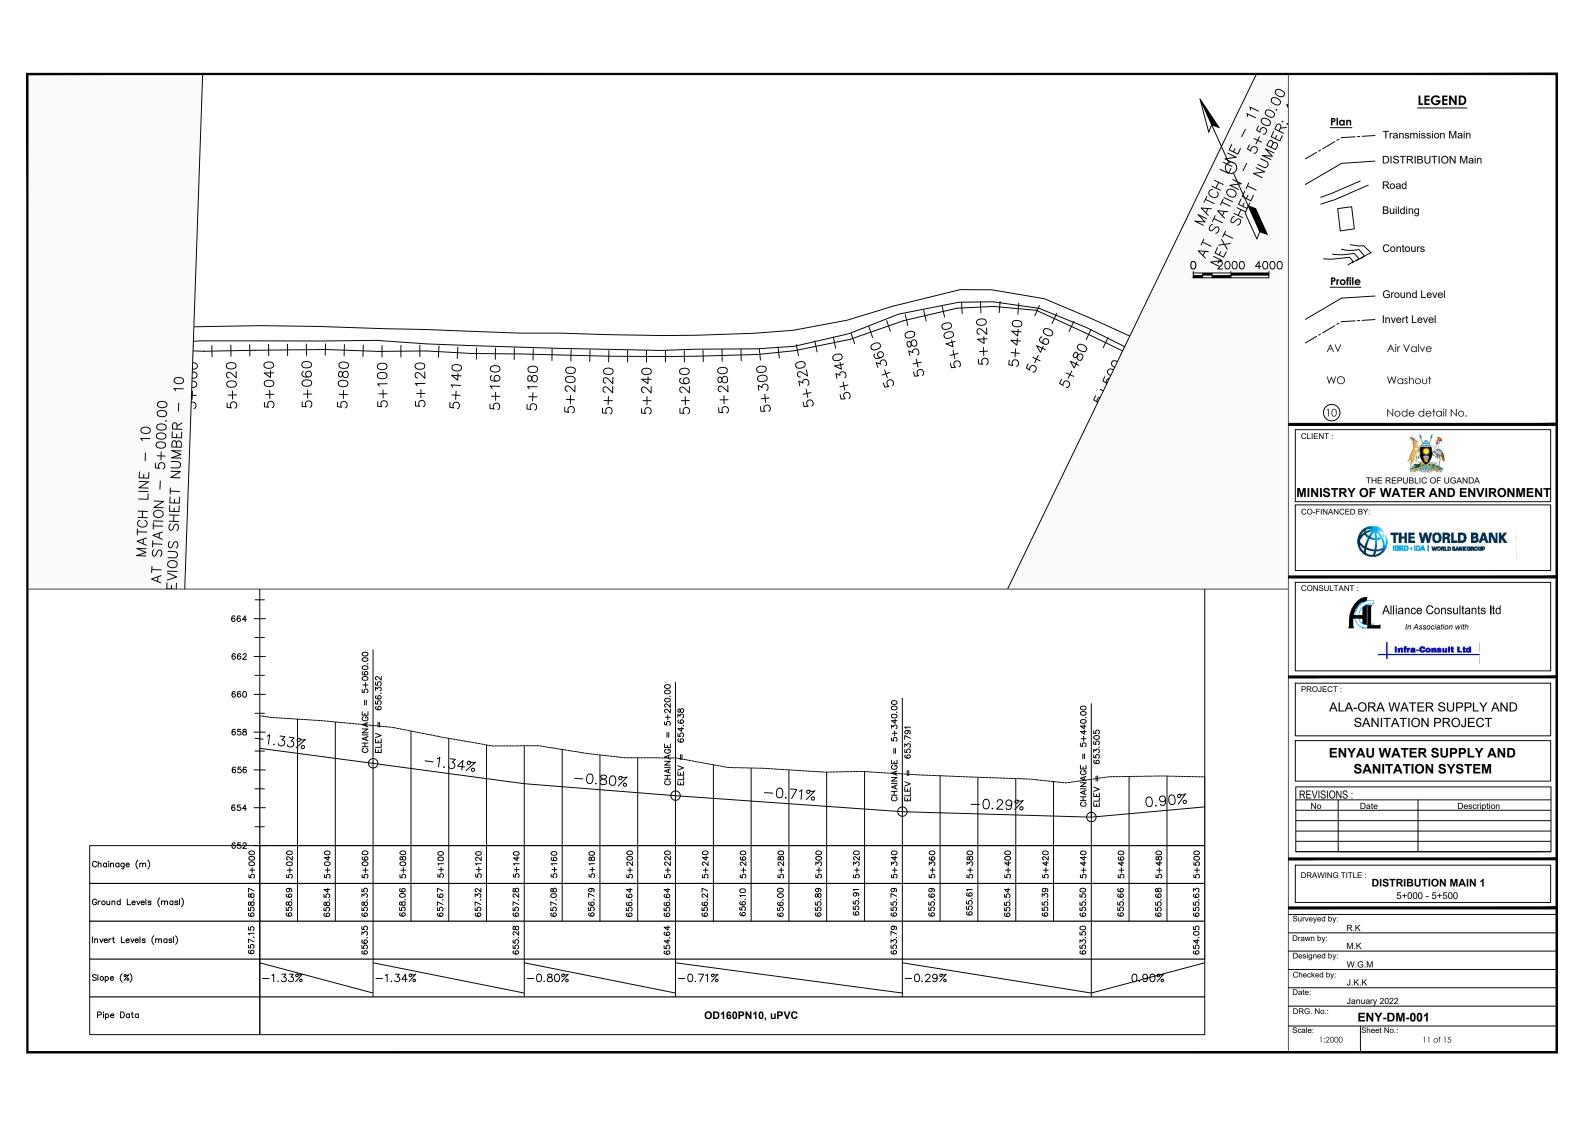

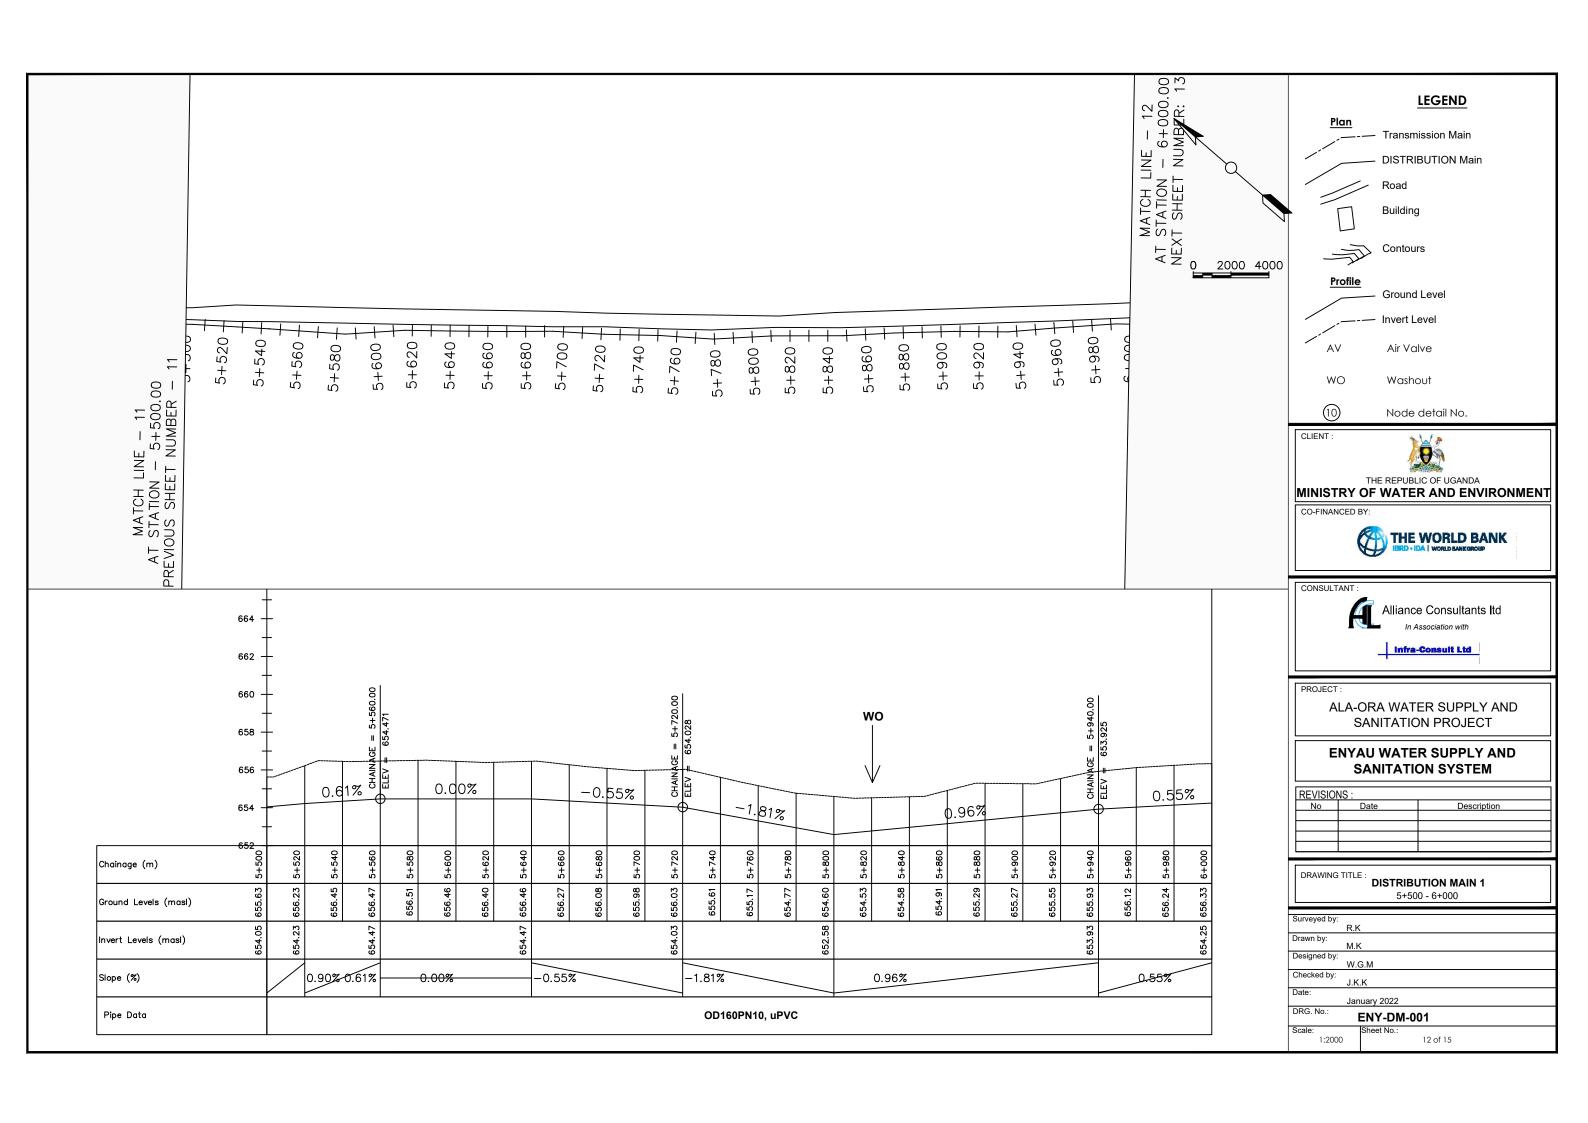


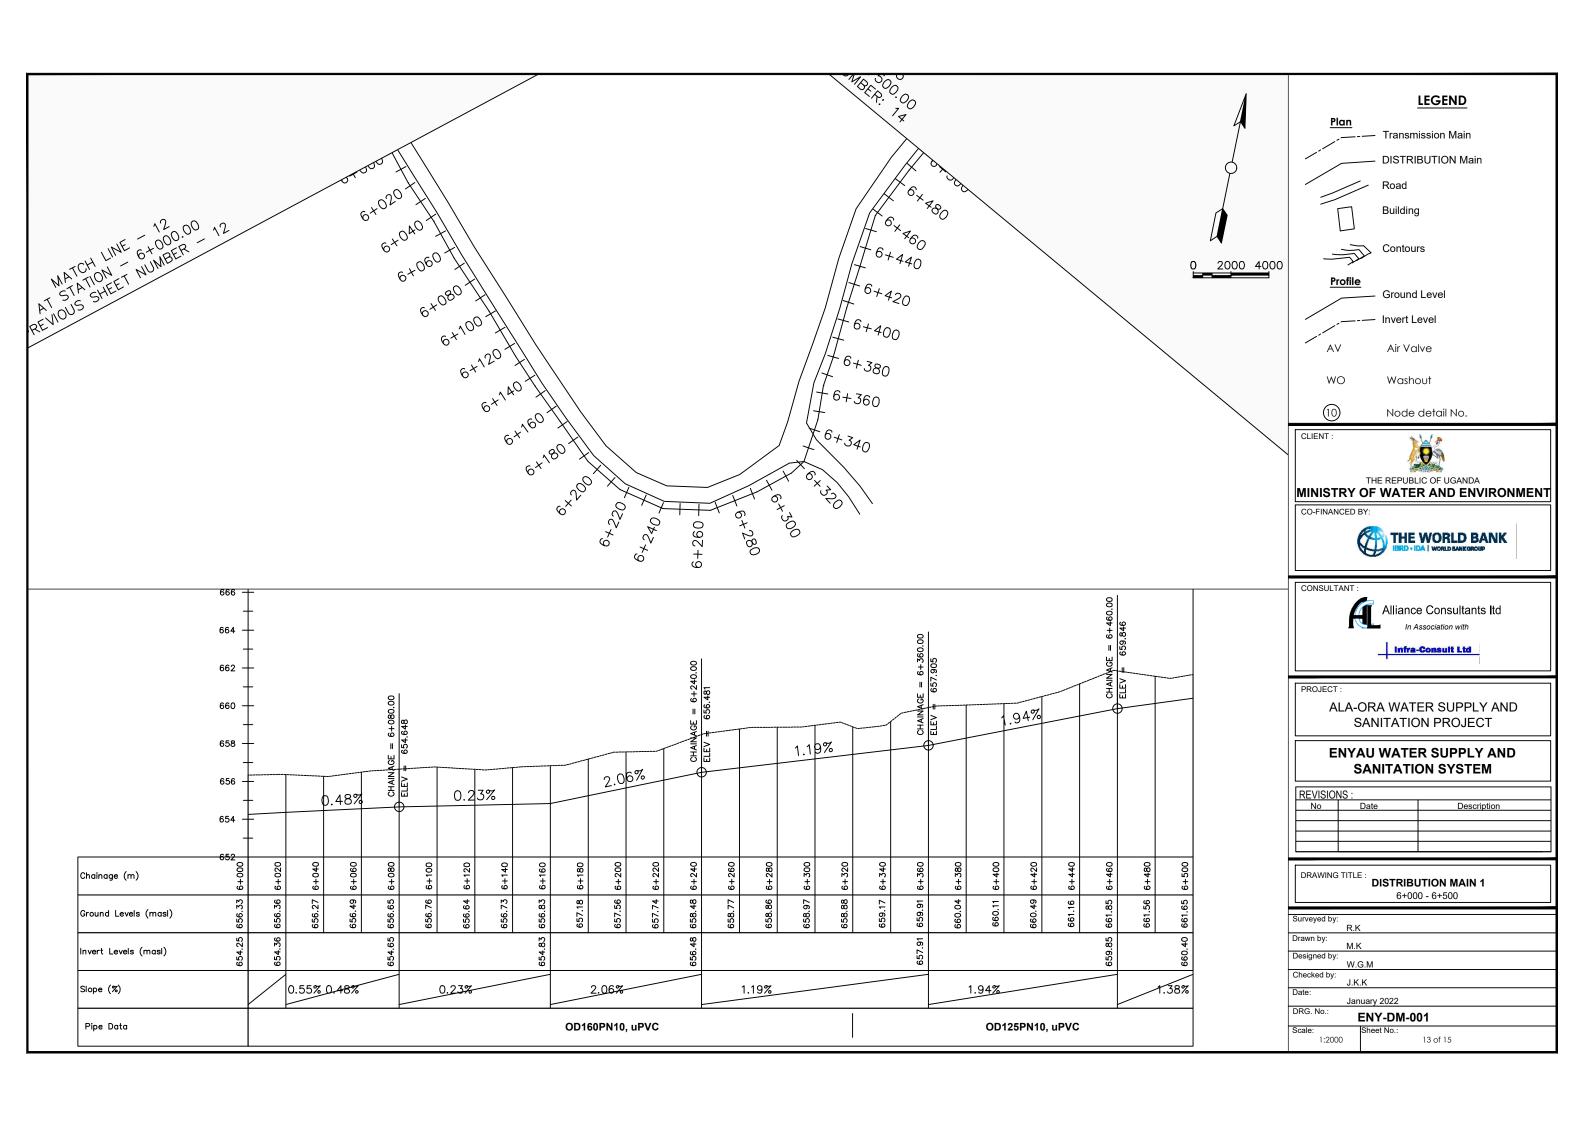


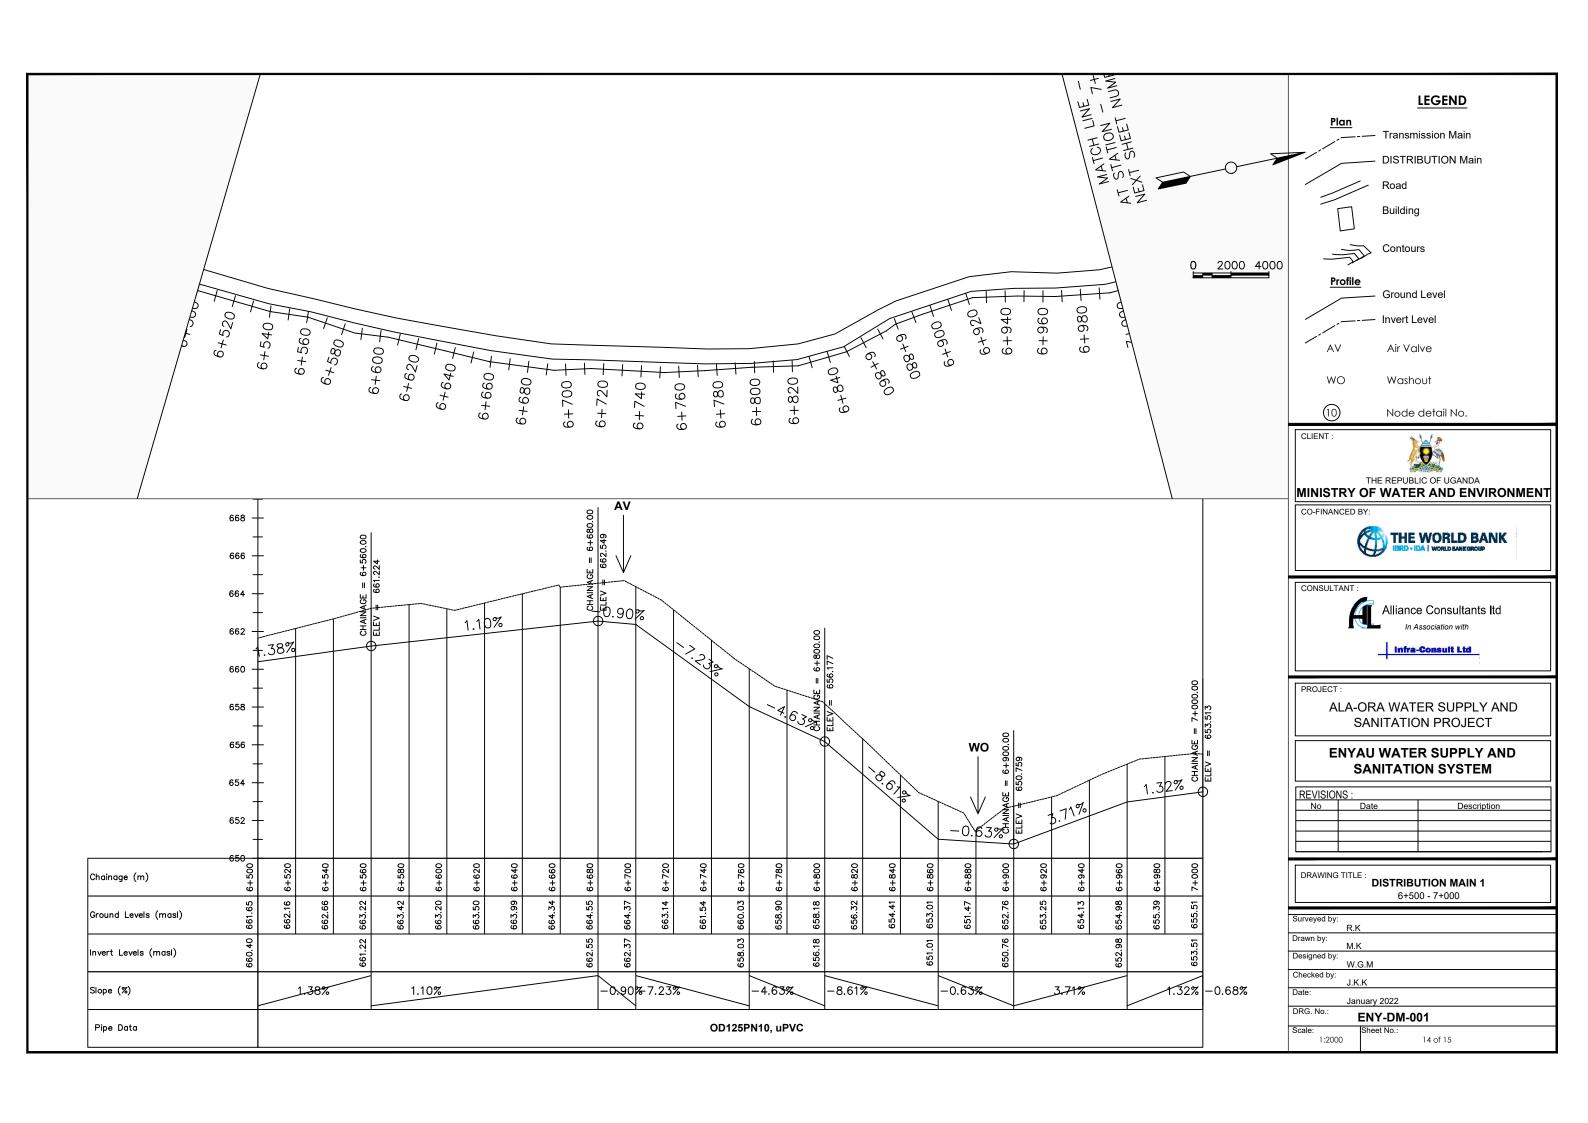


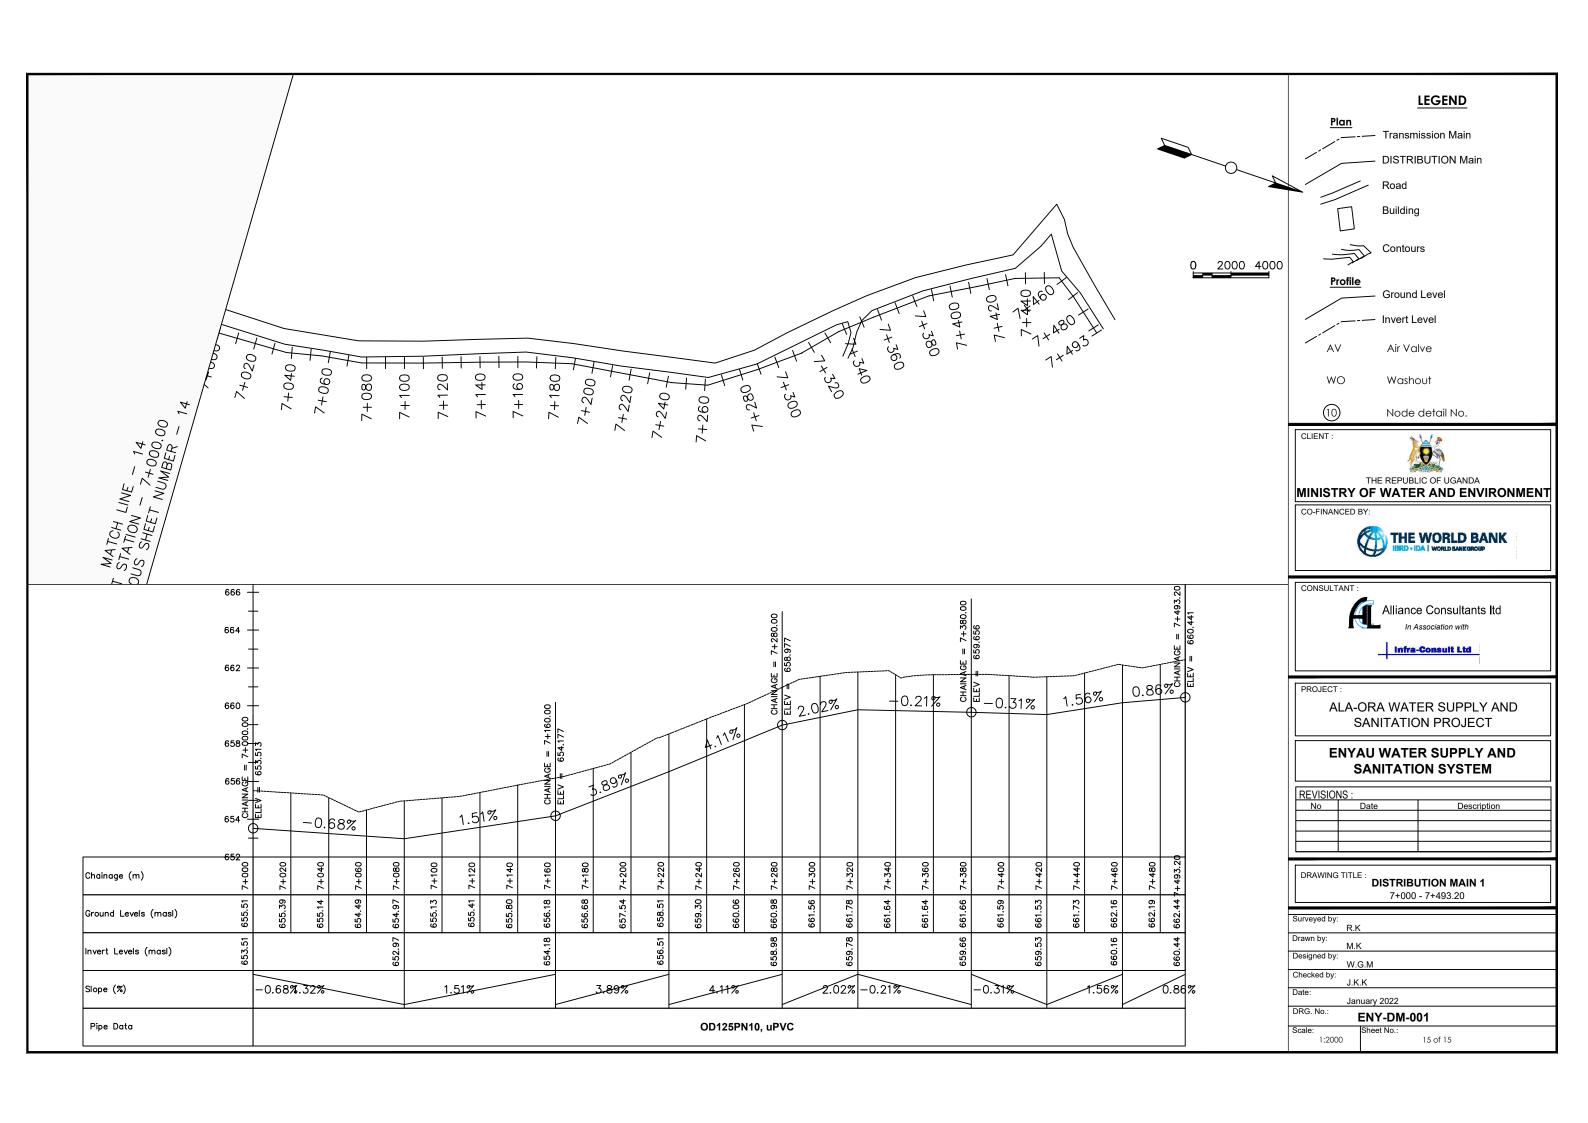



69m³ NDAAPI RESERVOIR AREA

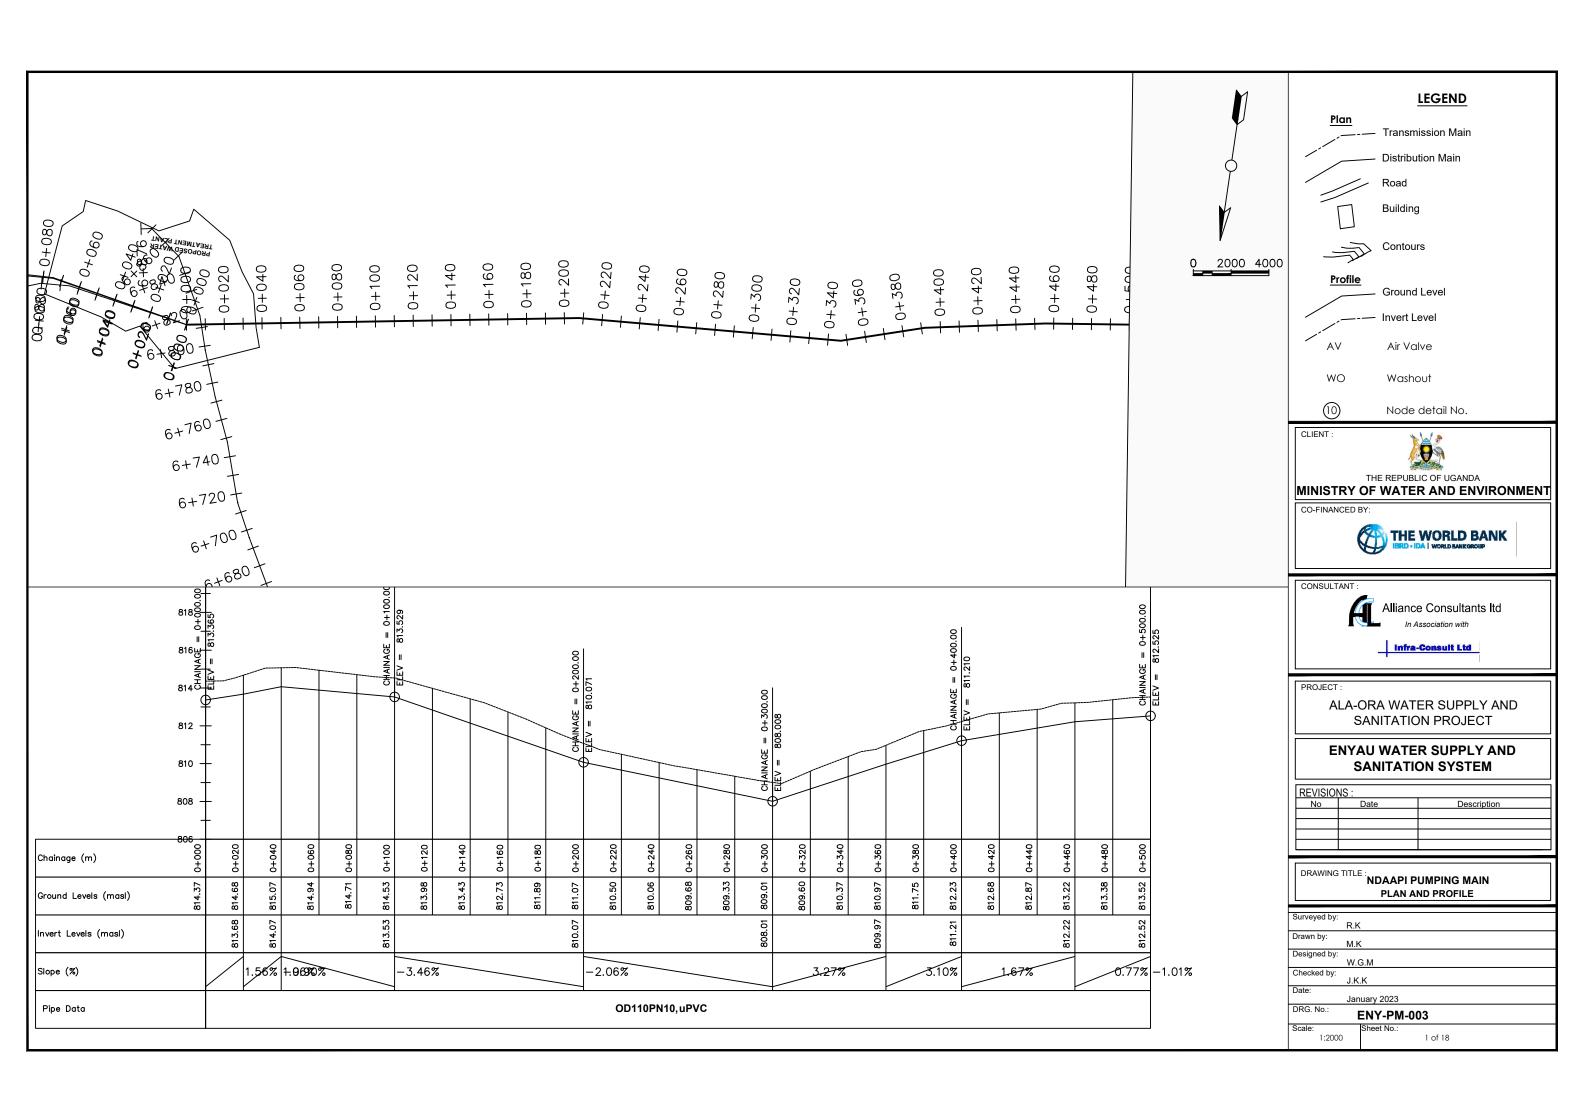


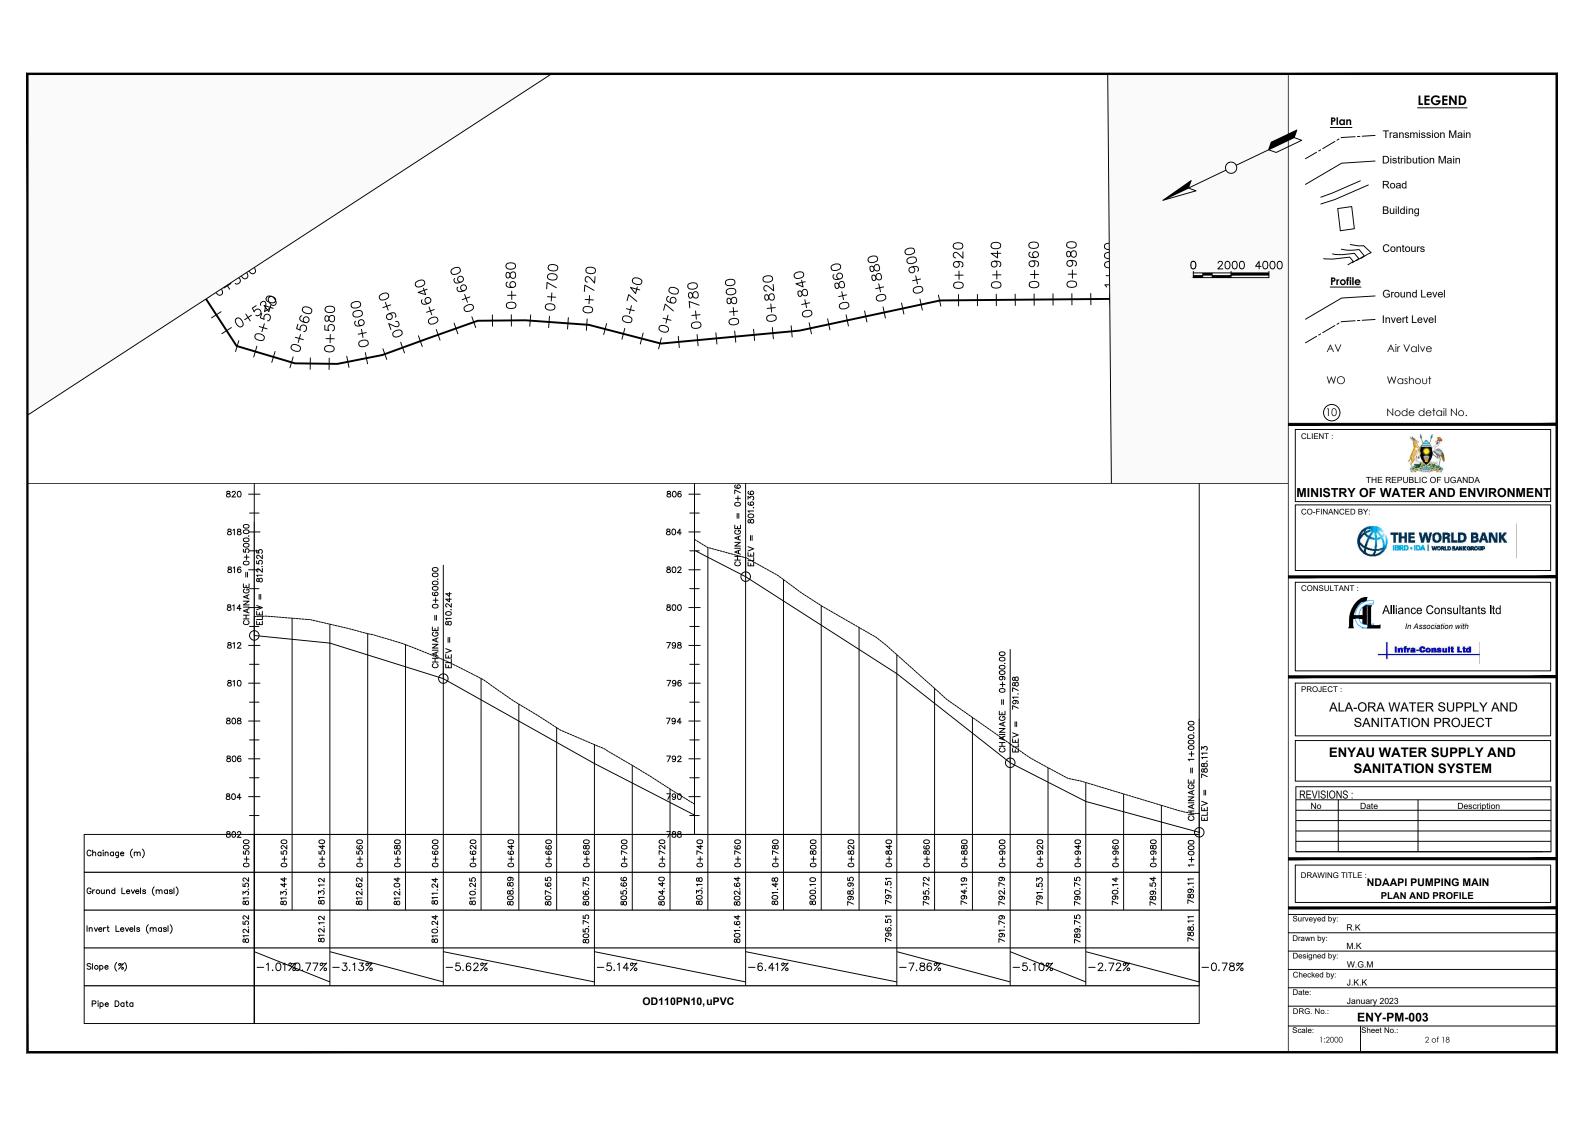


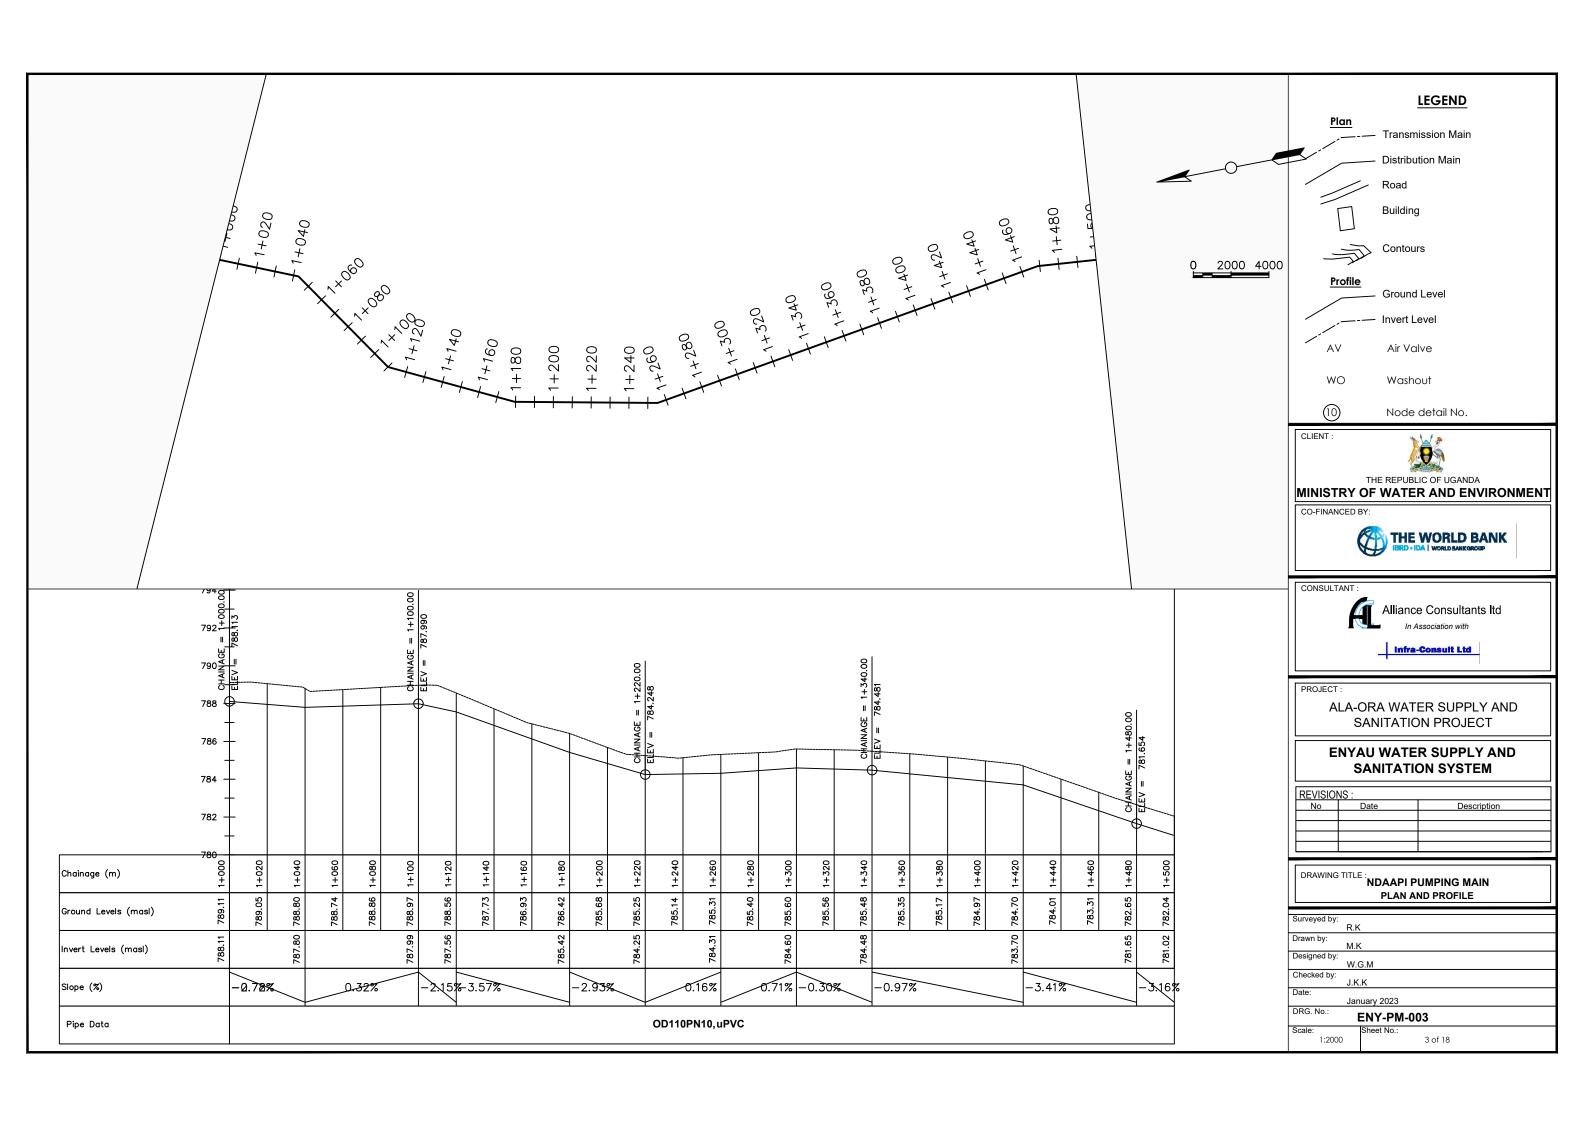


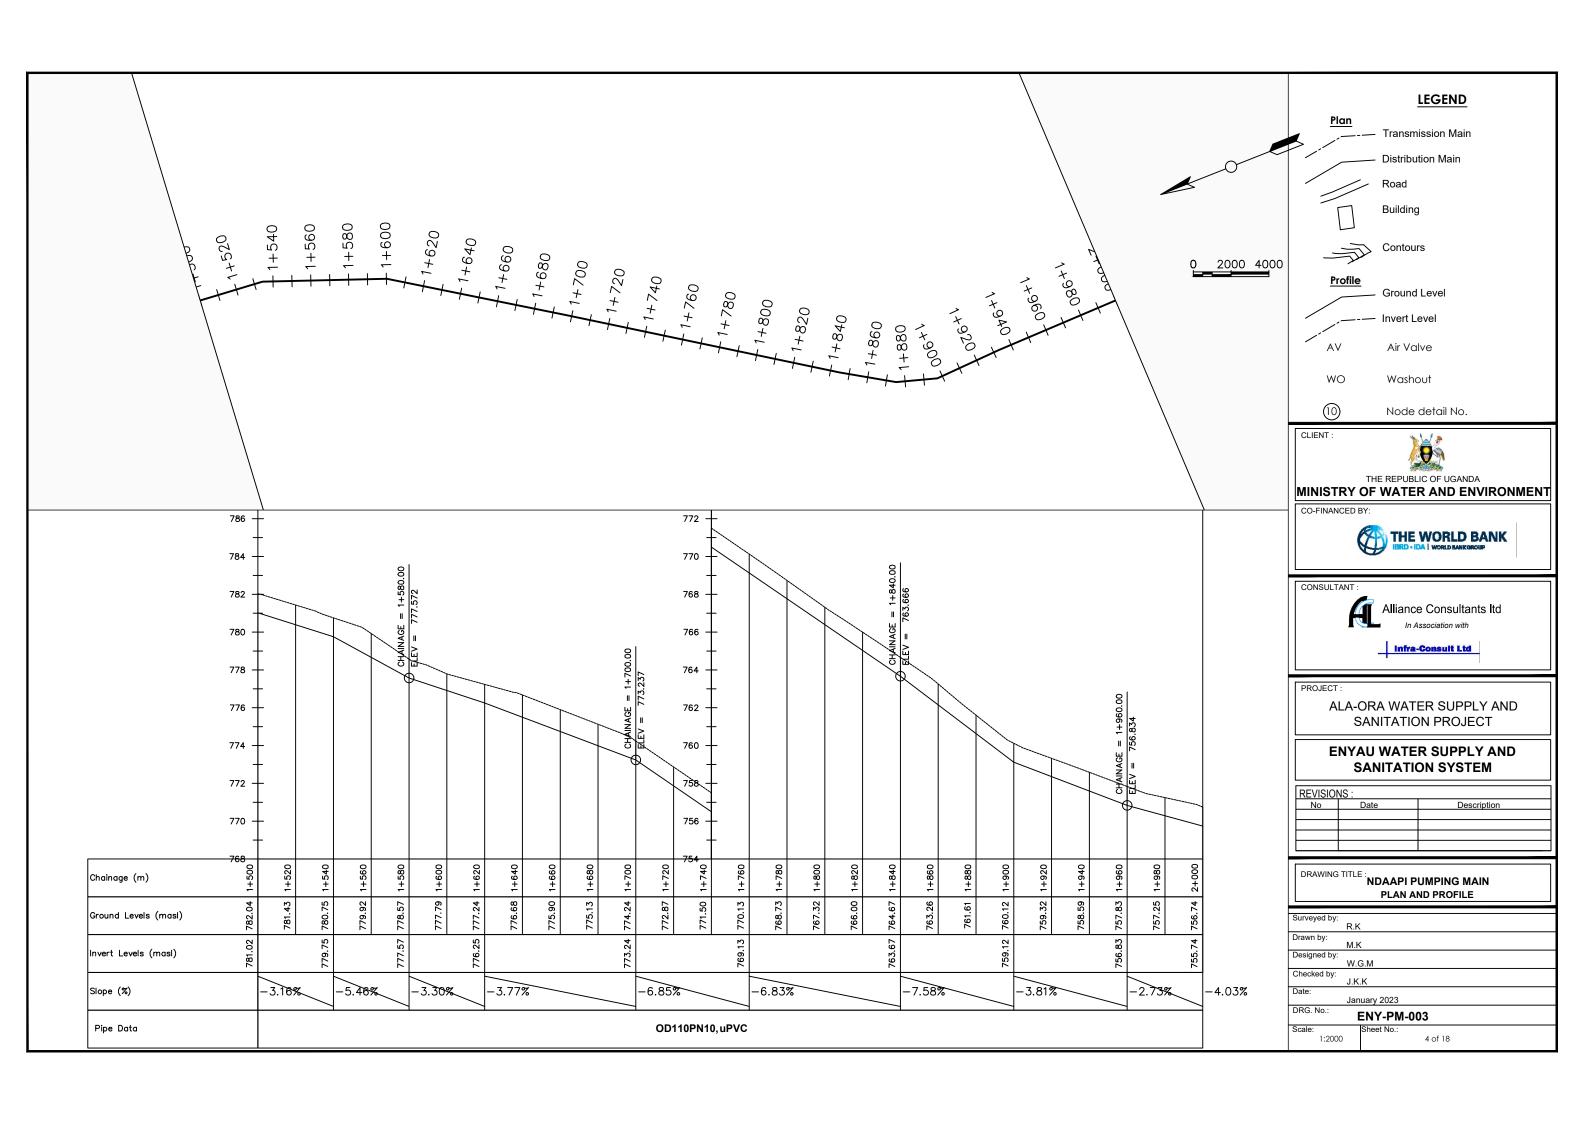


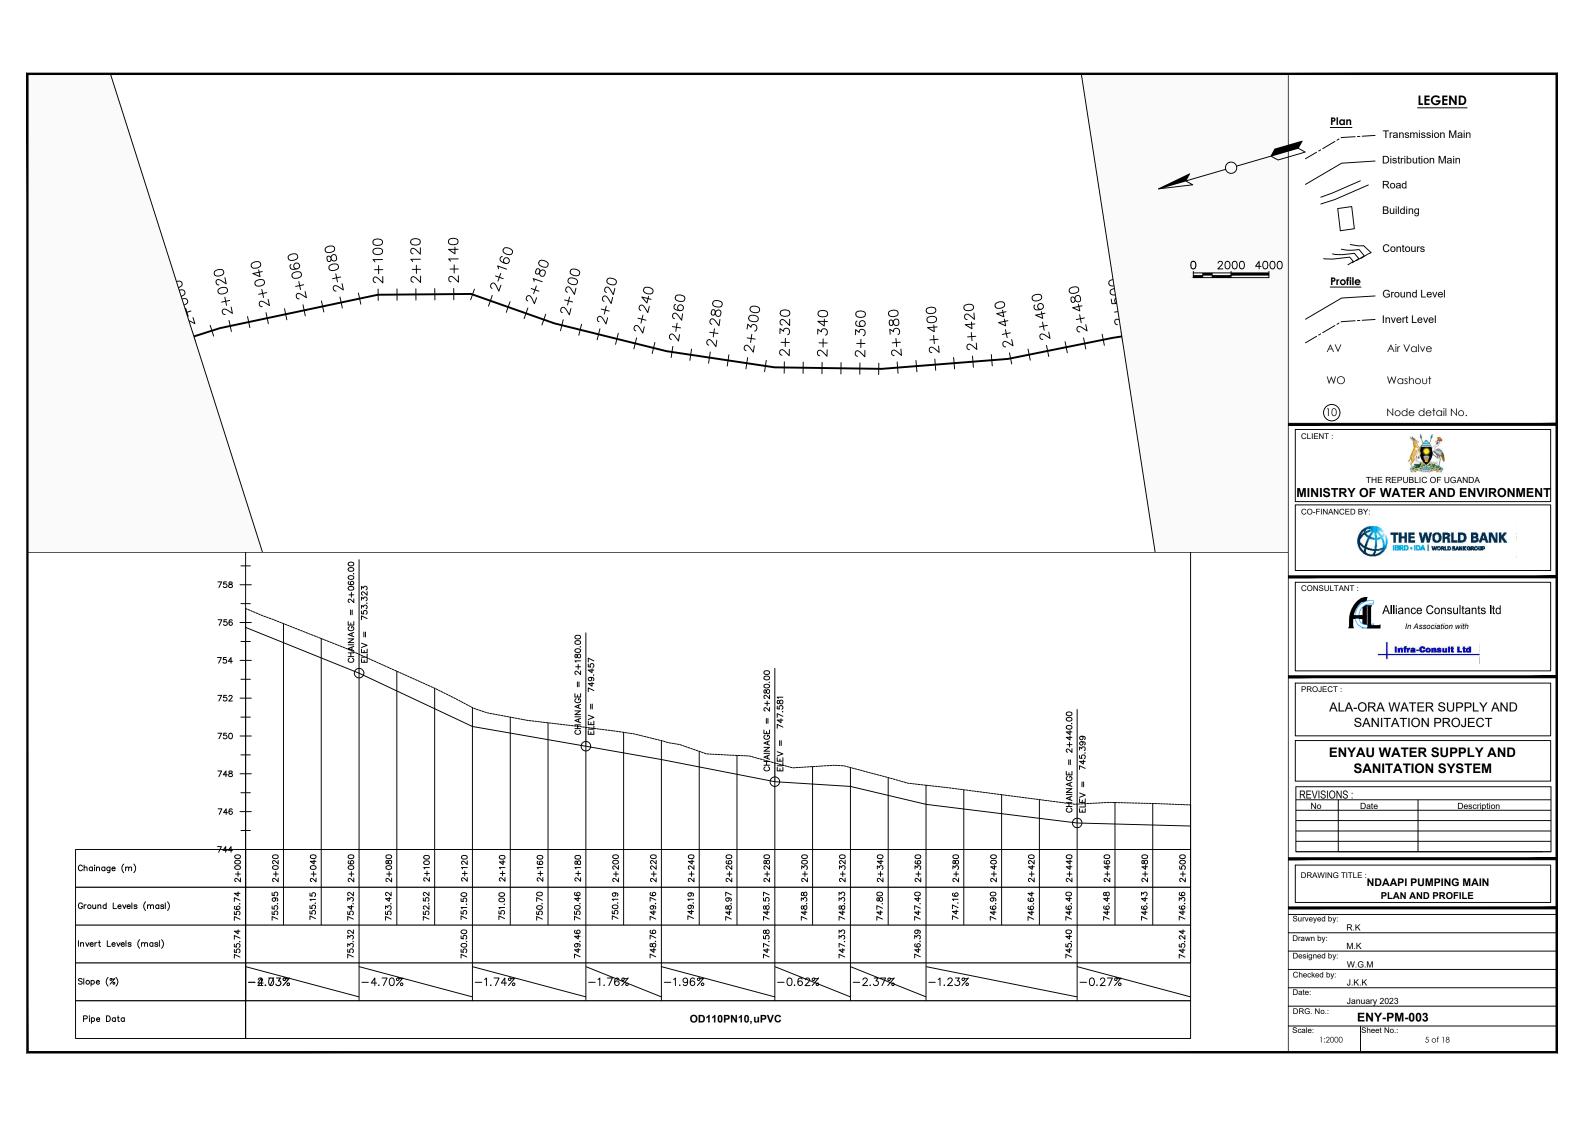


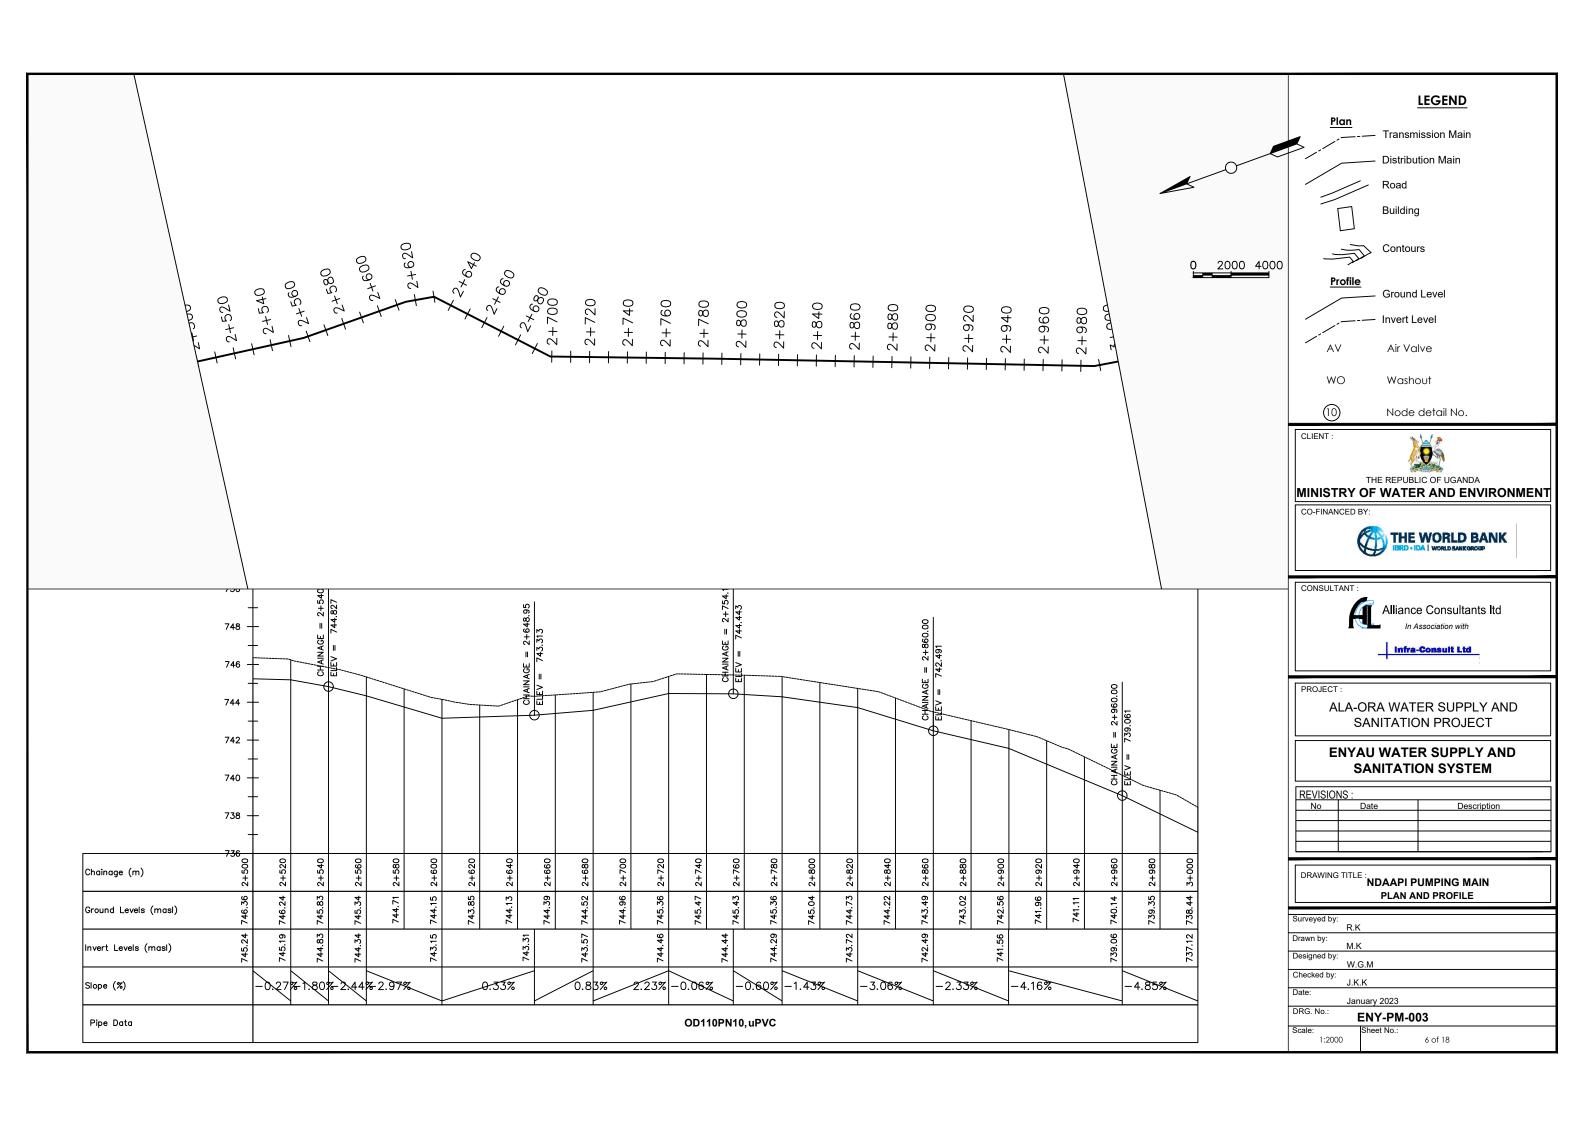


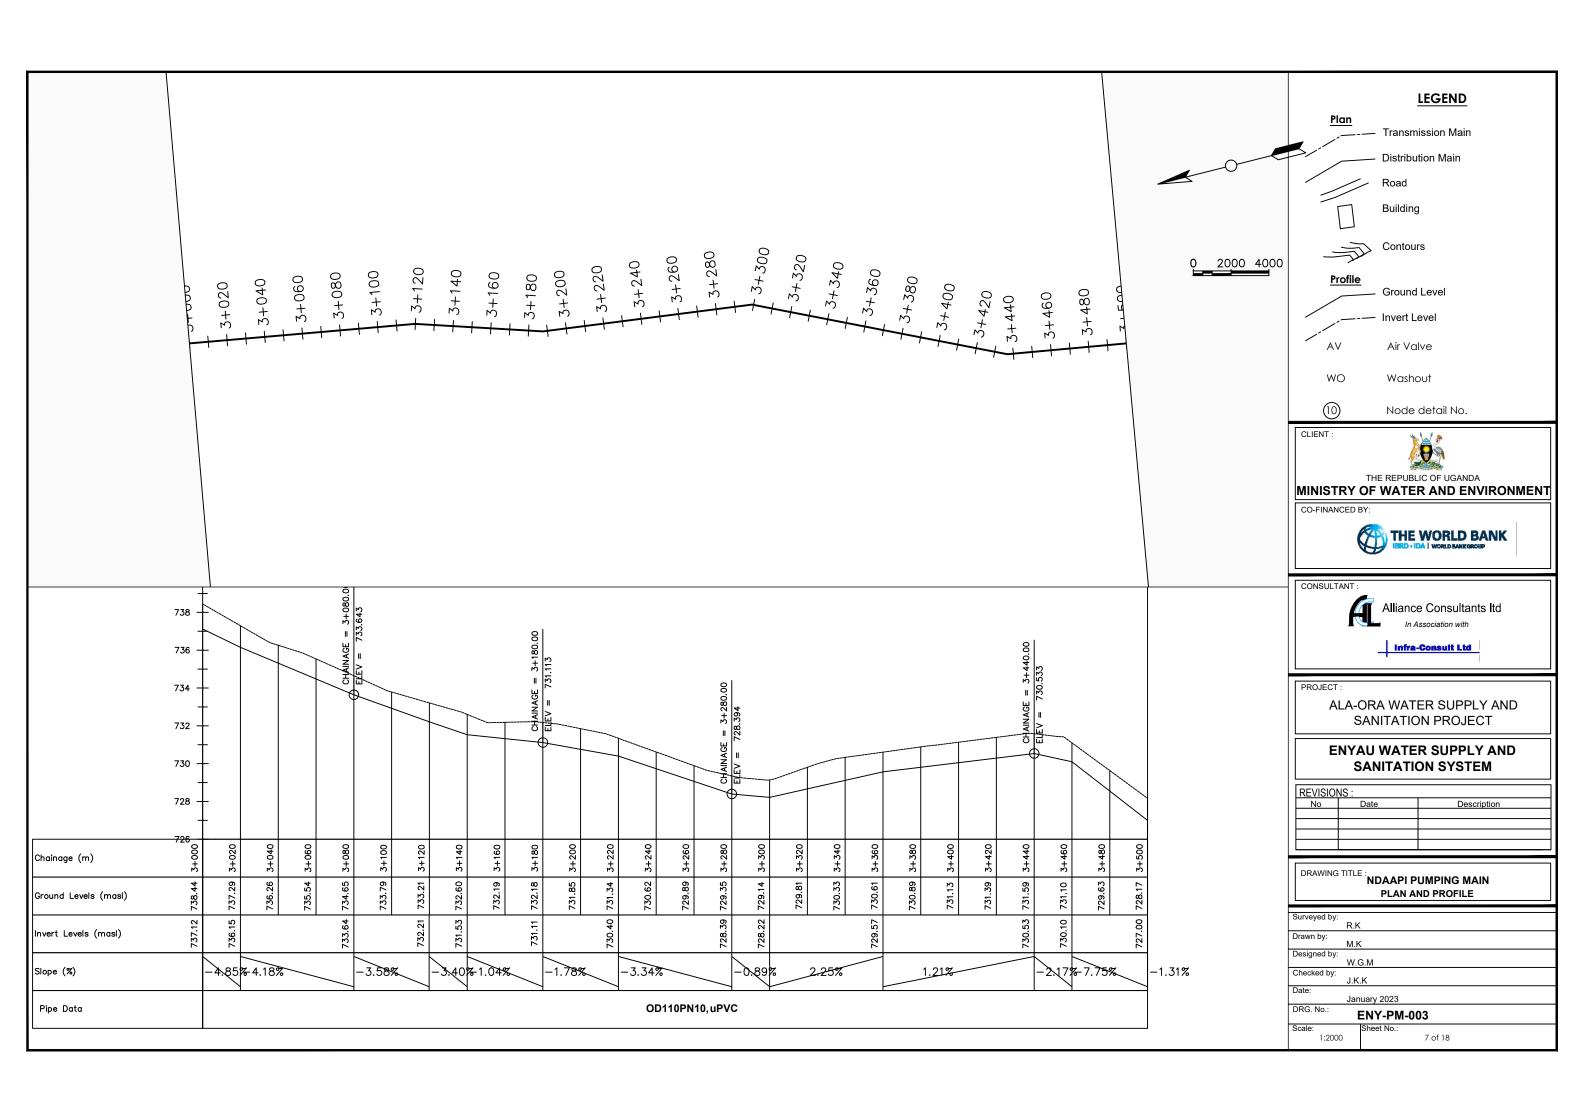


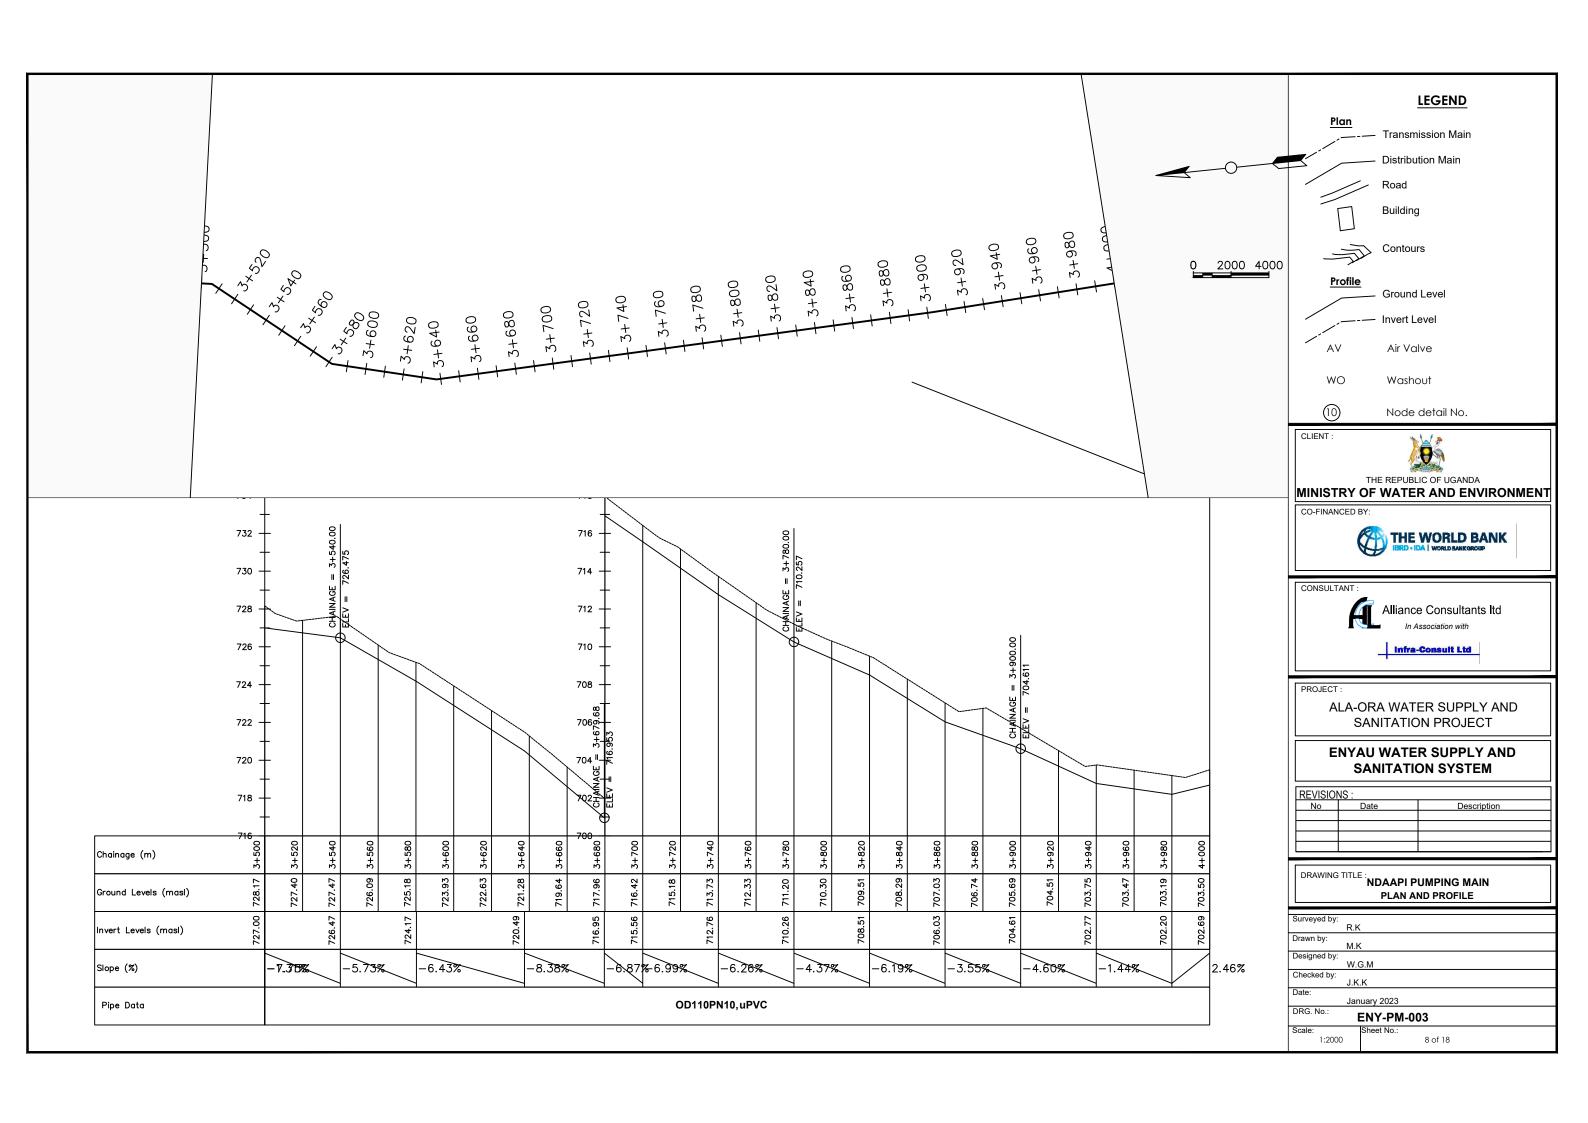


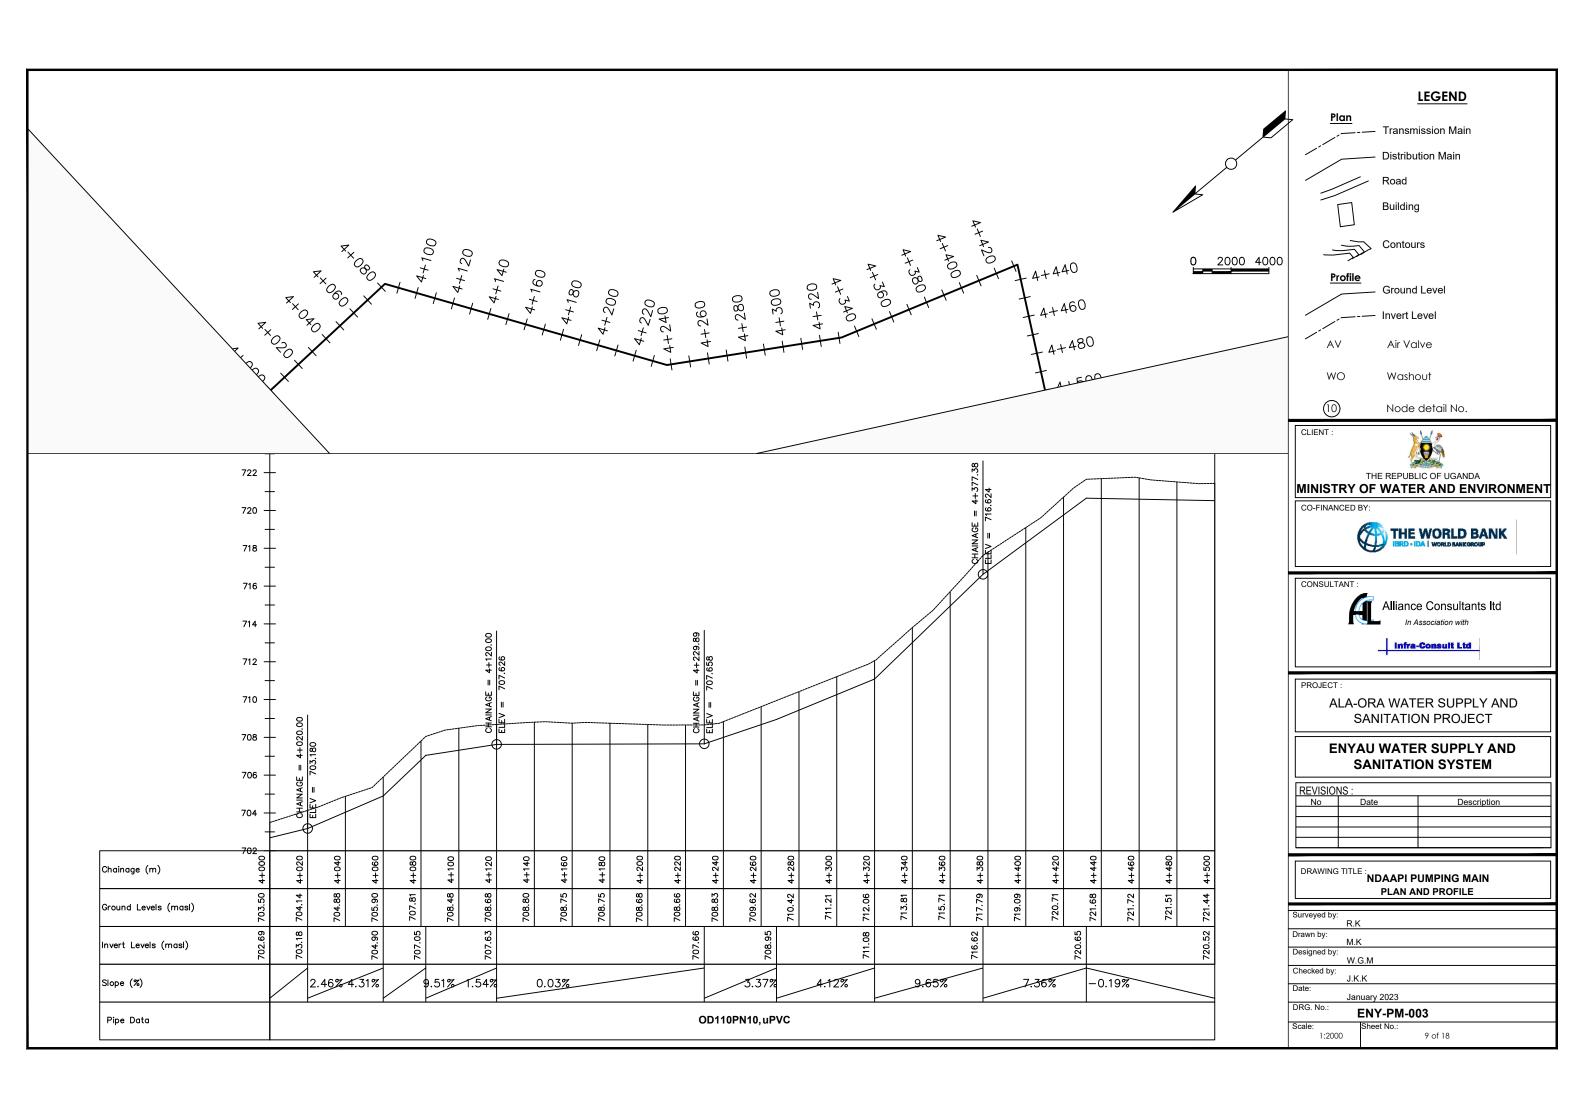


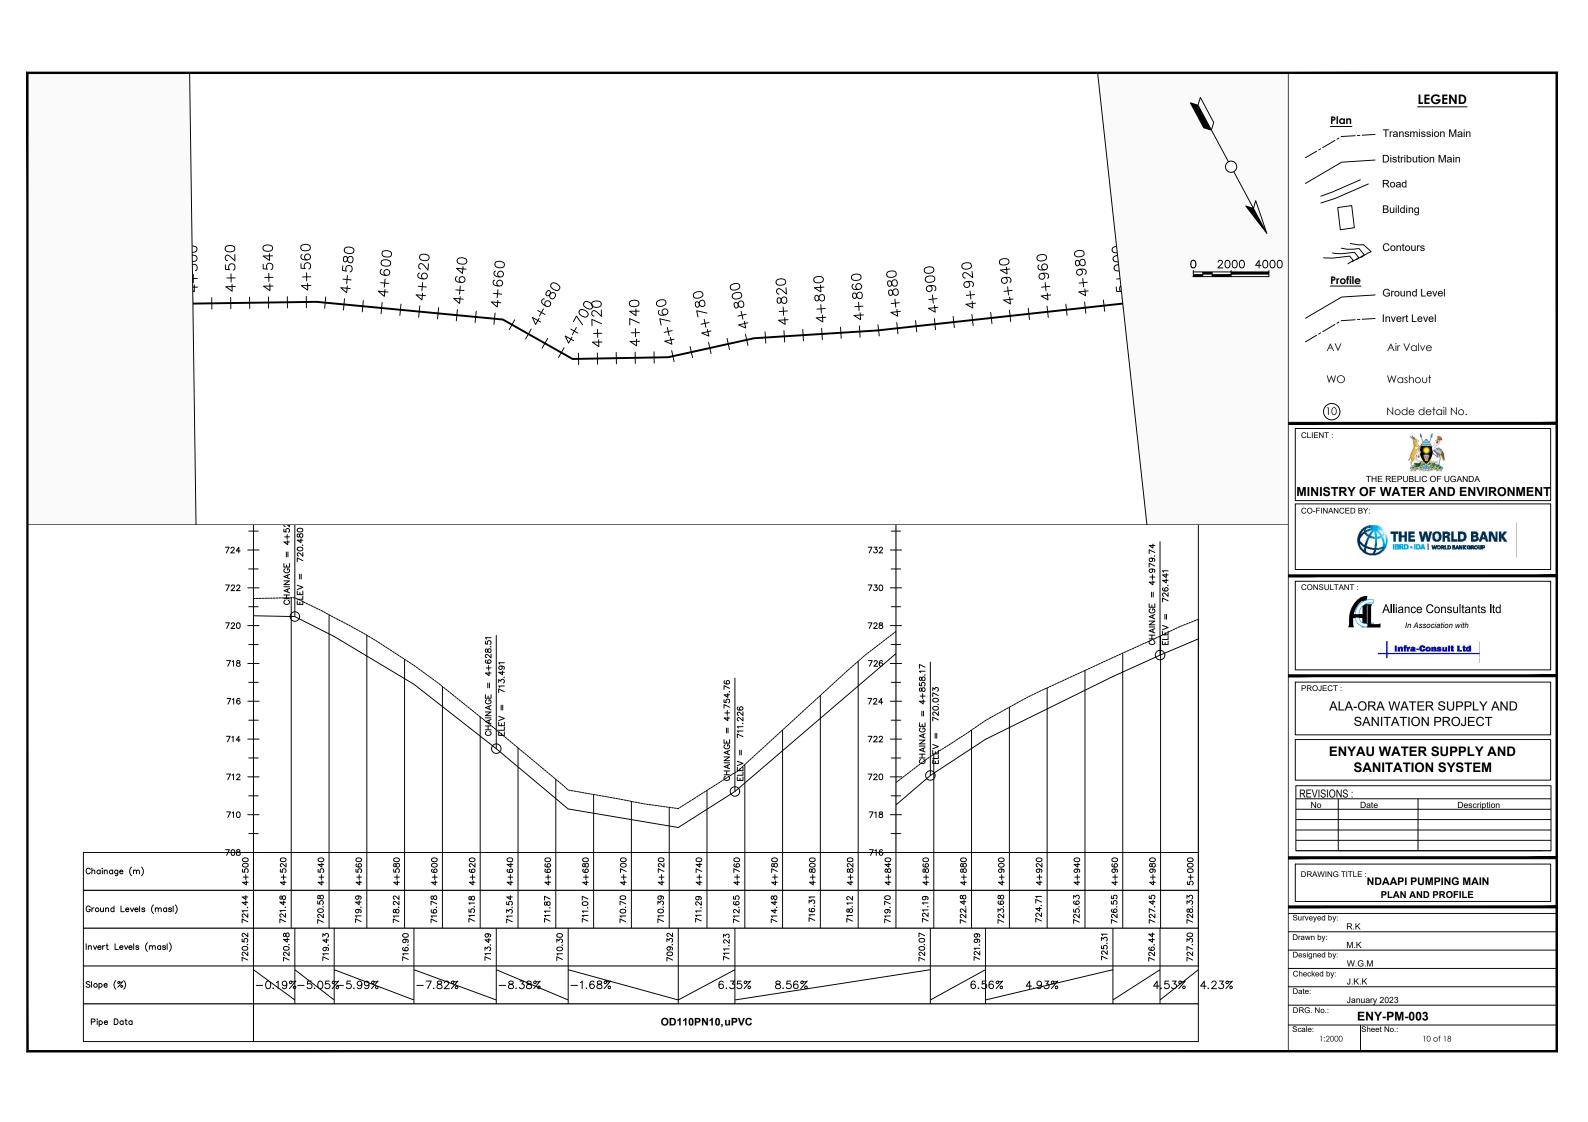


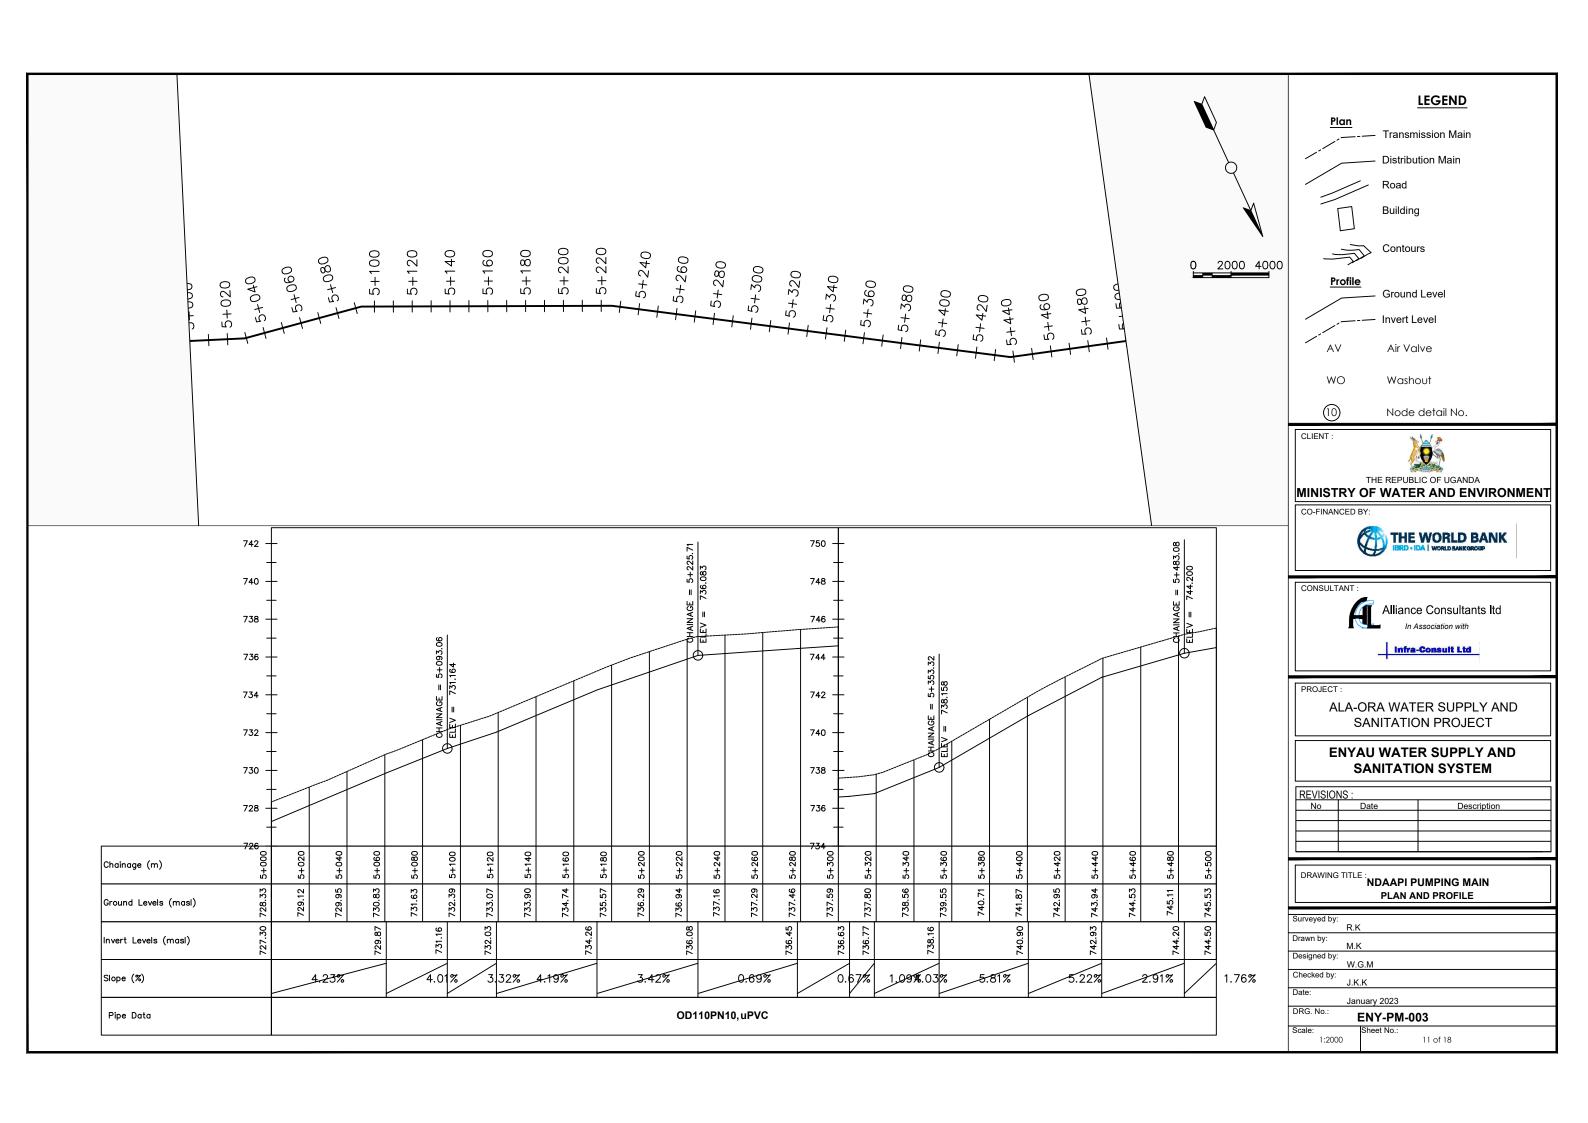


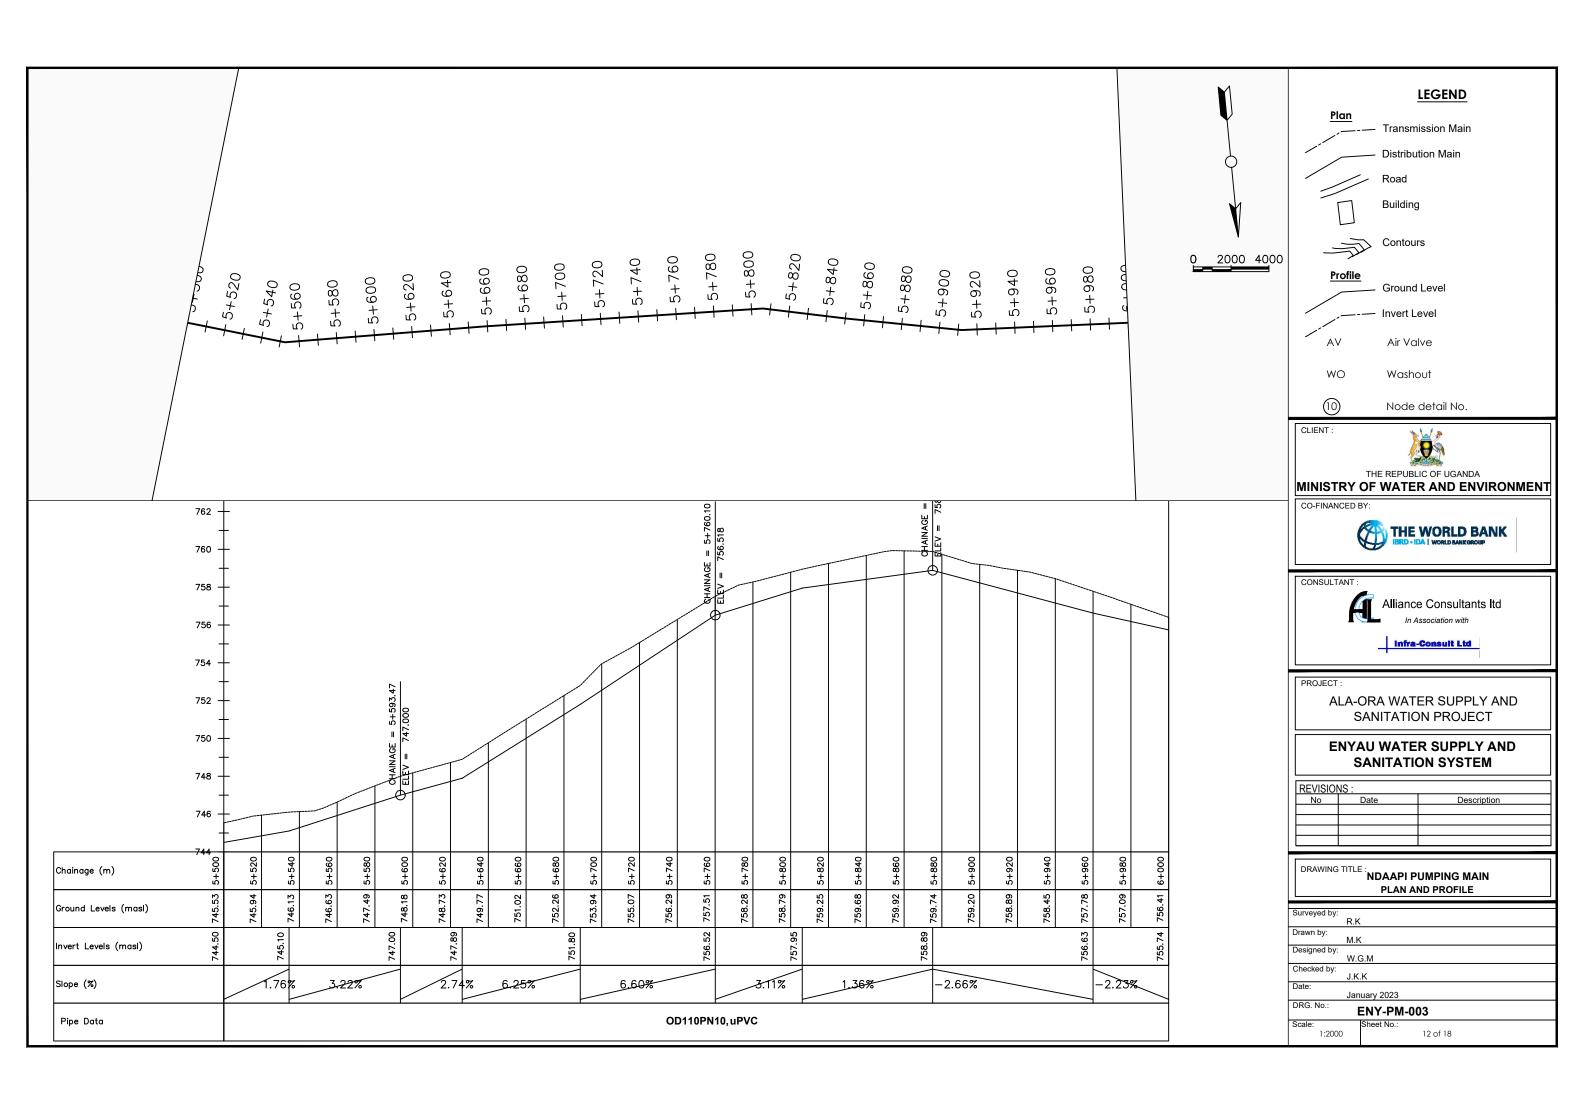


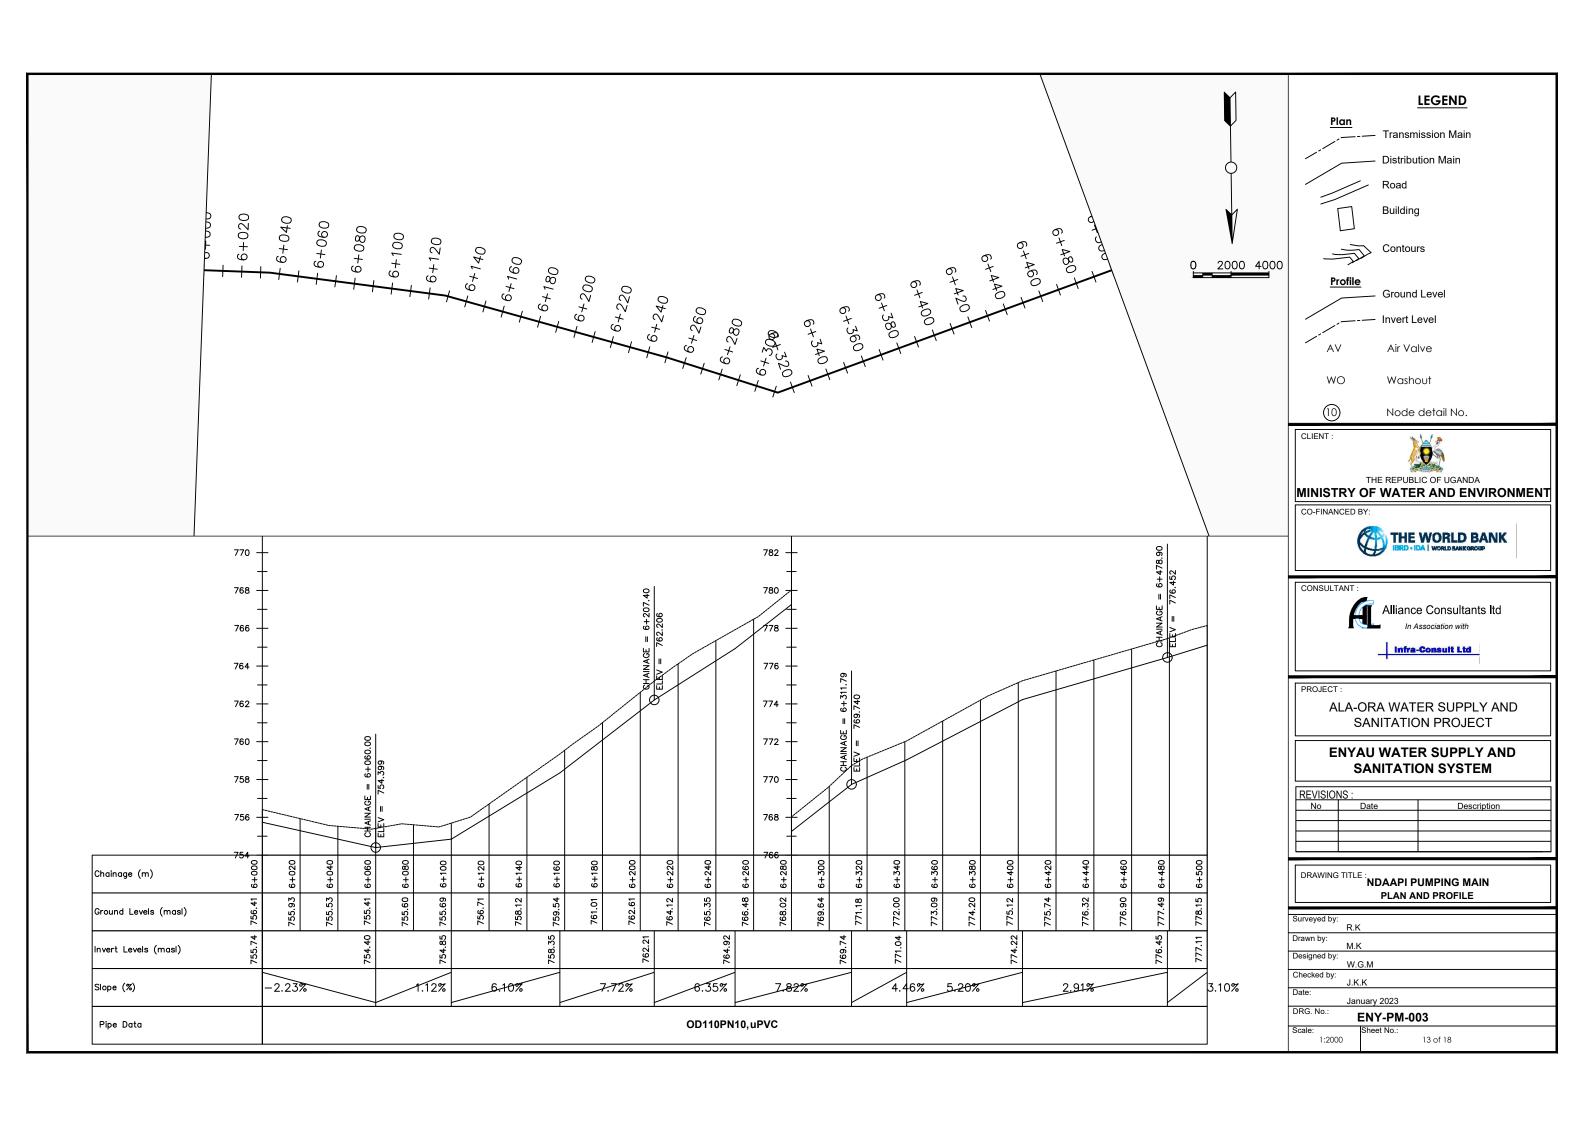


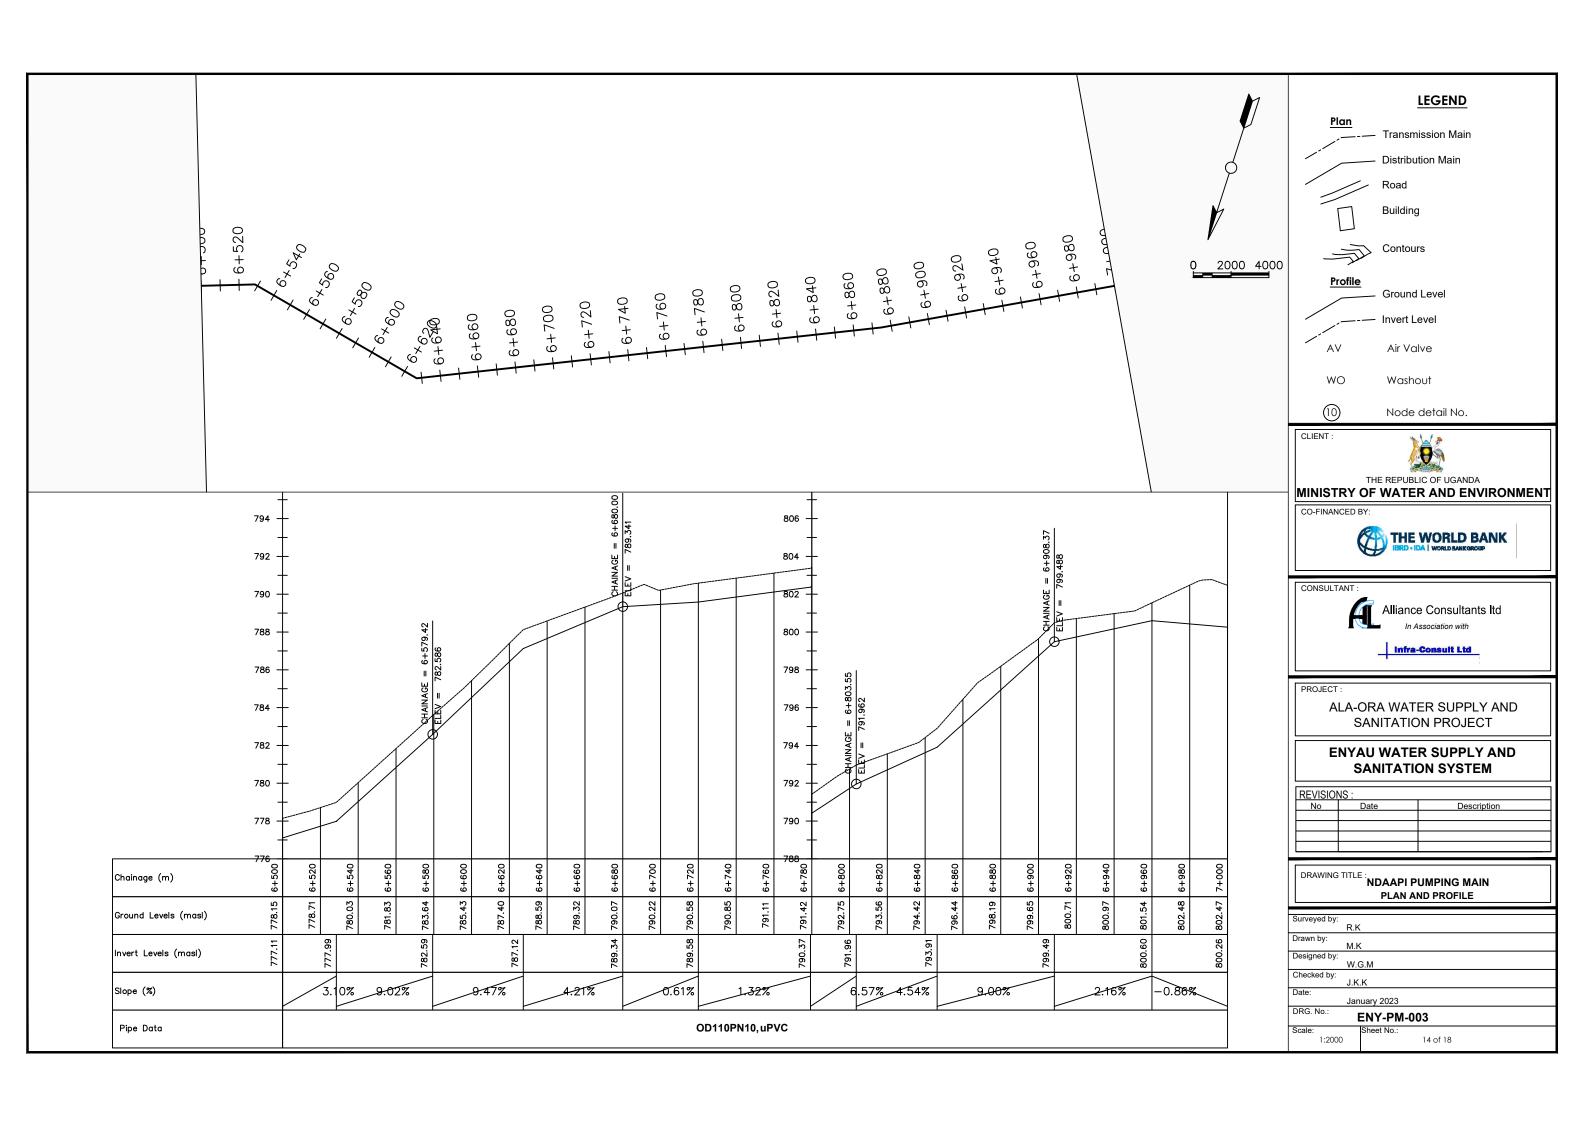


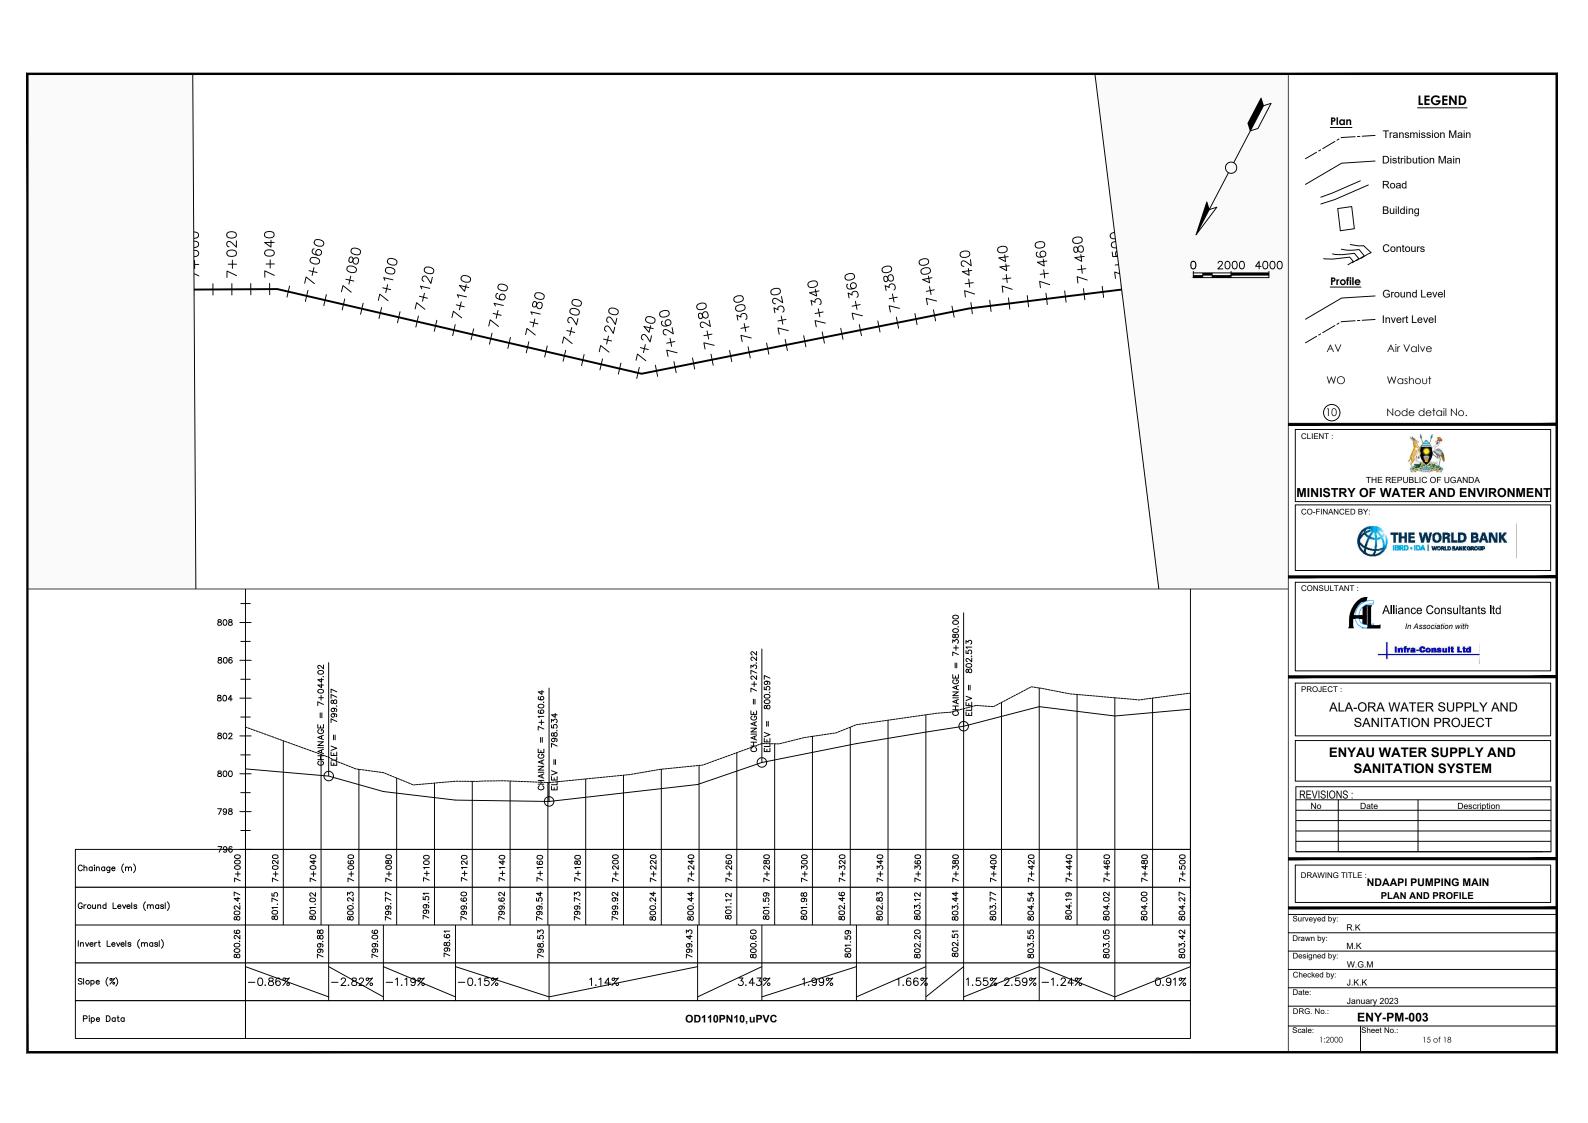


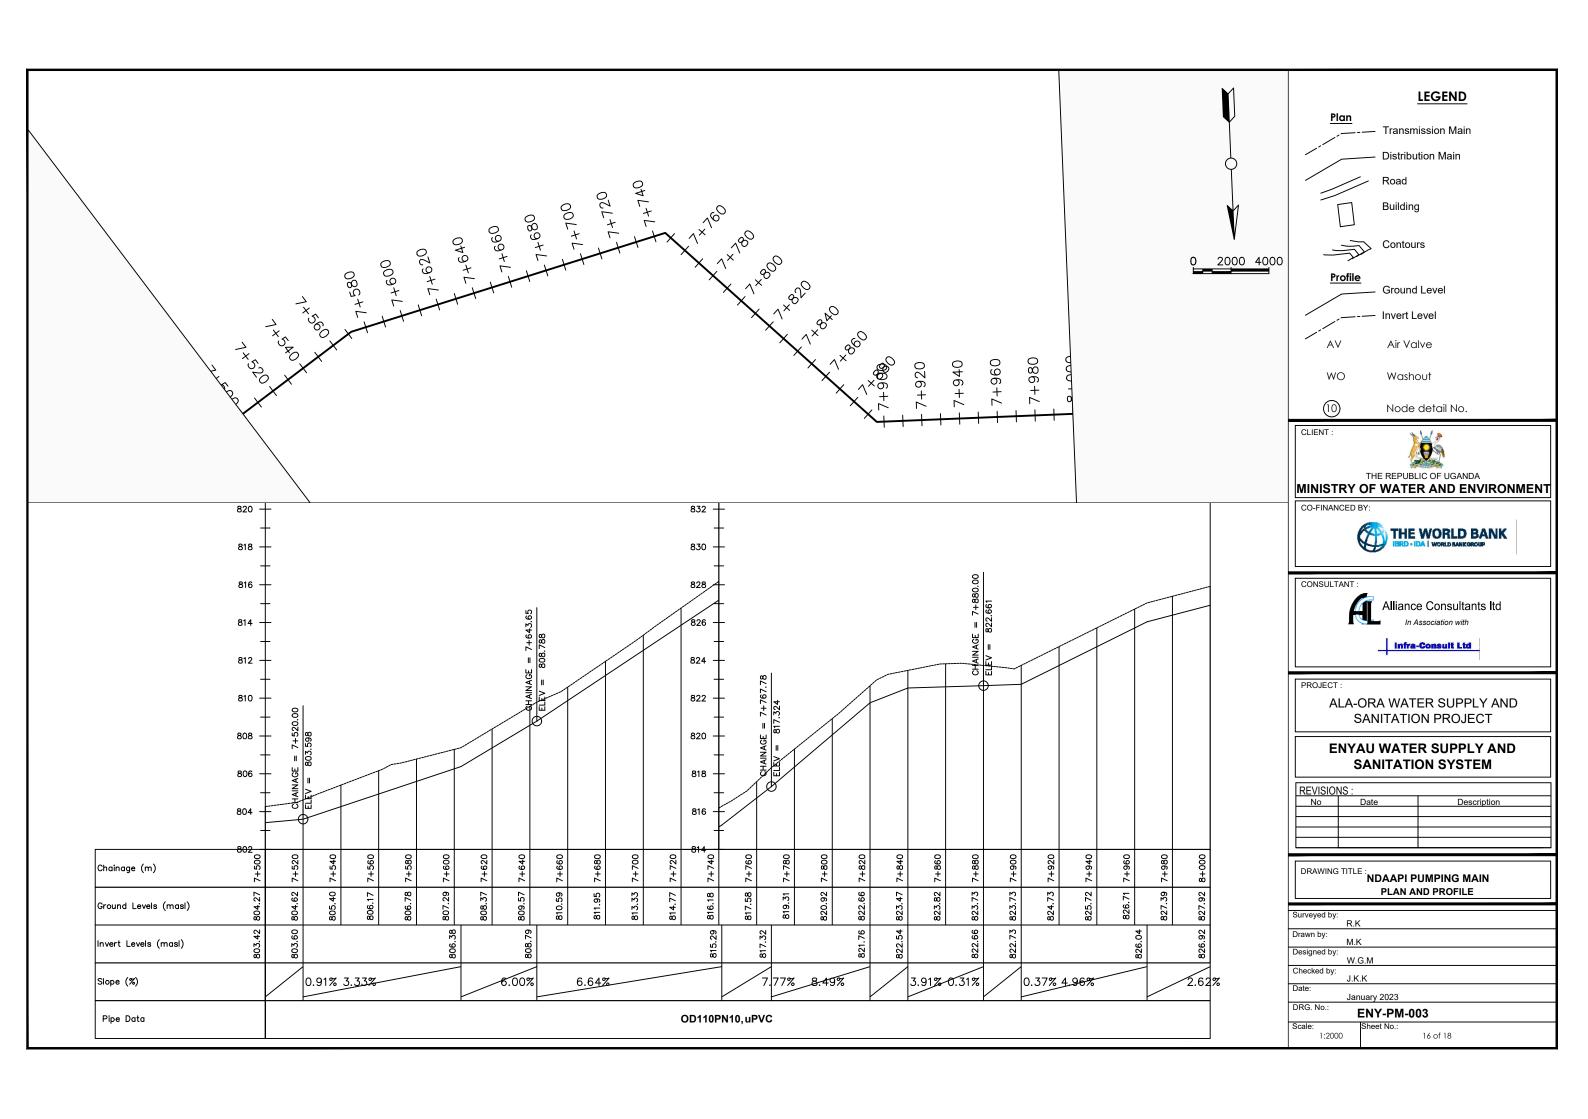


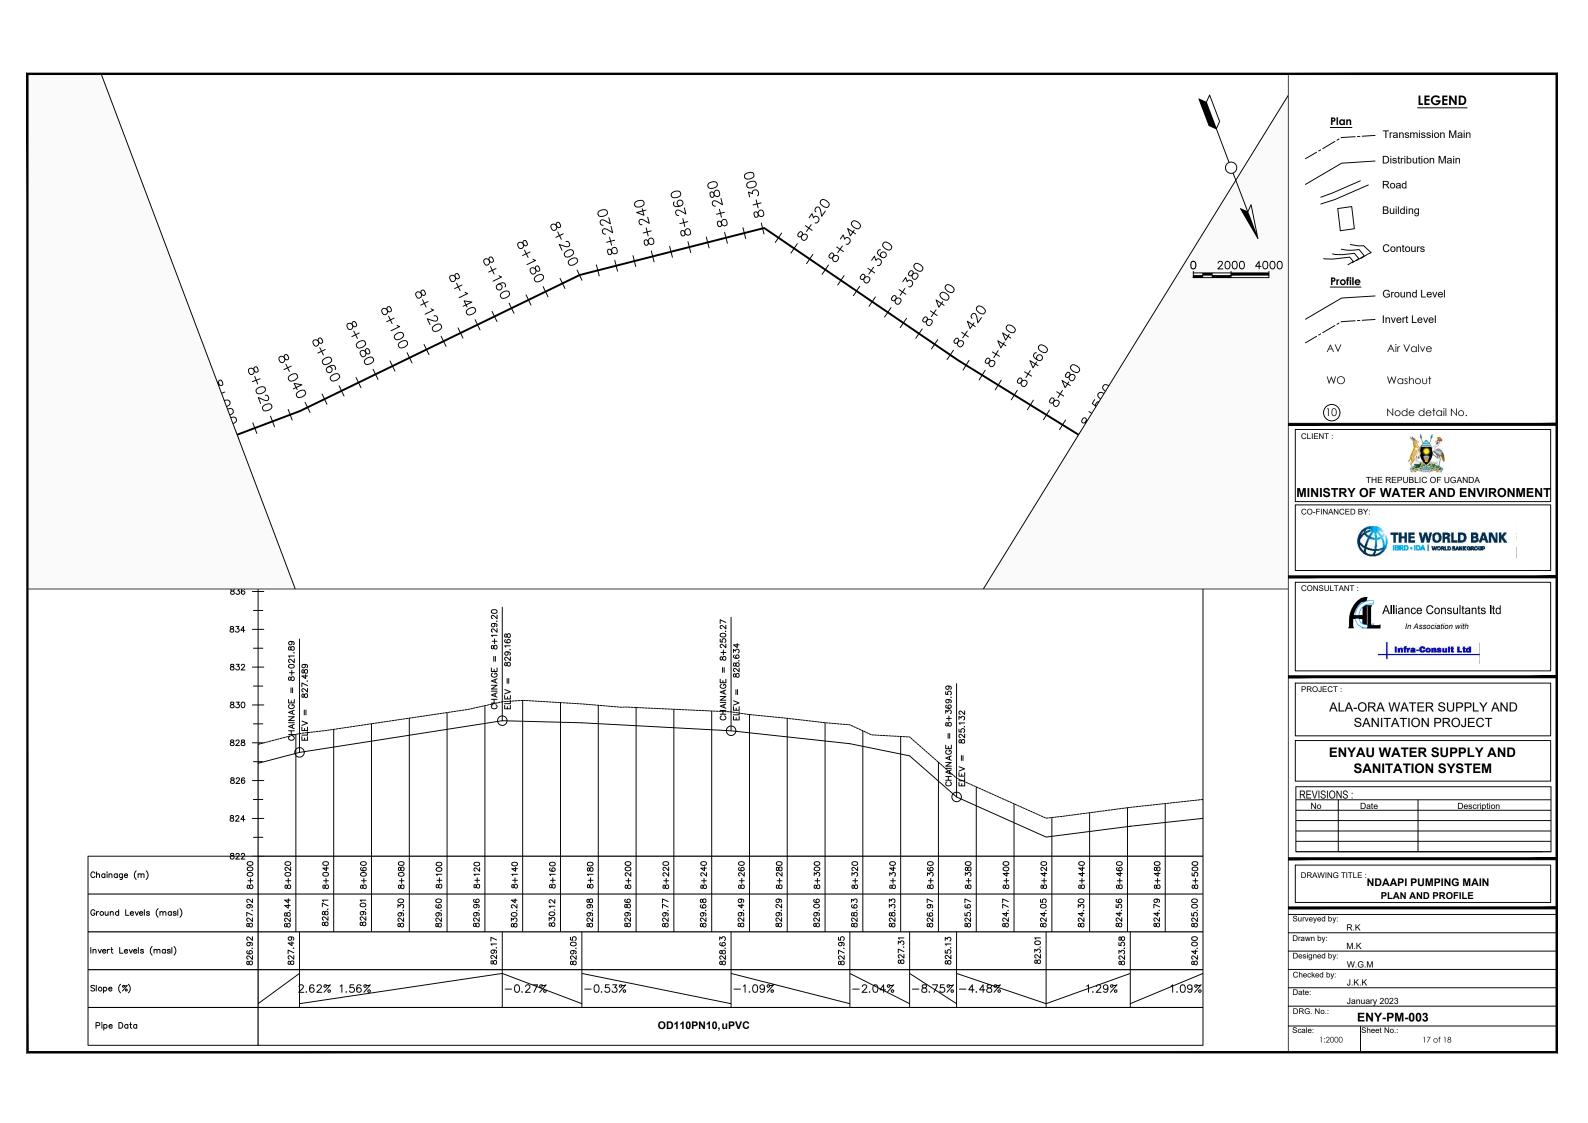

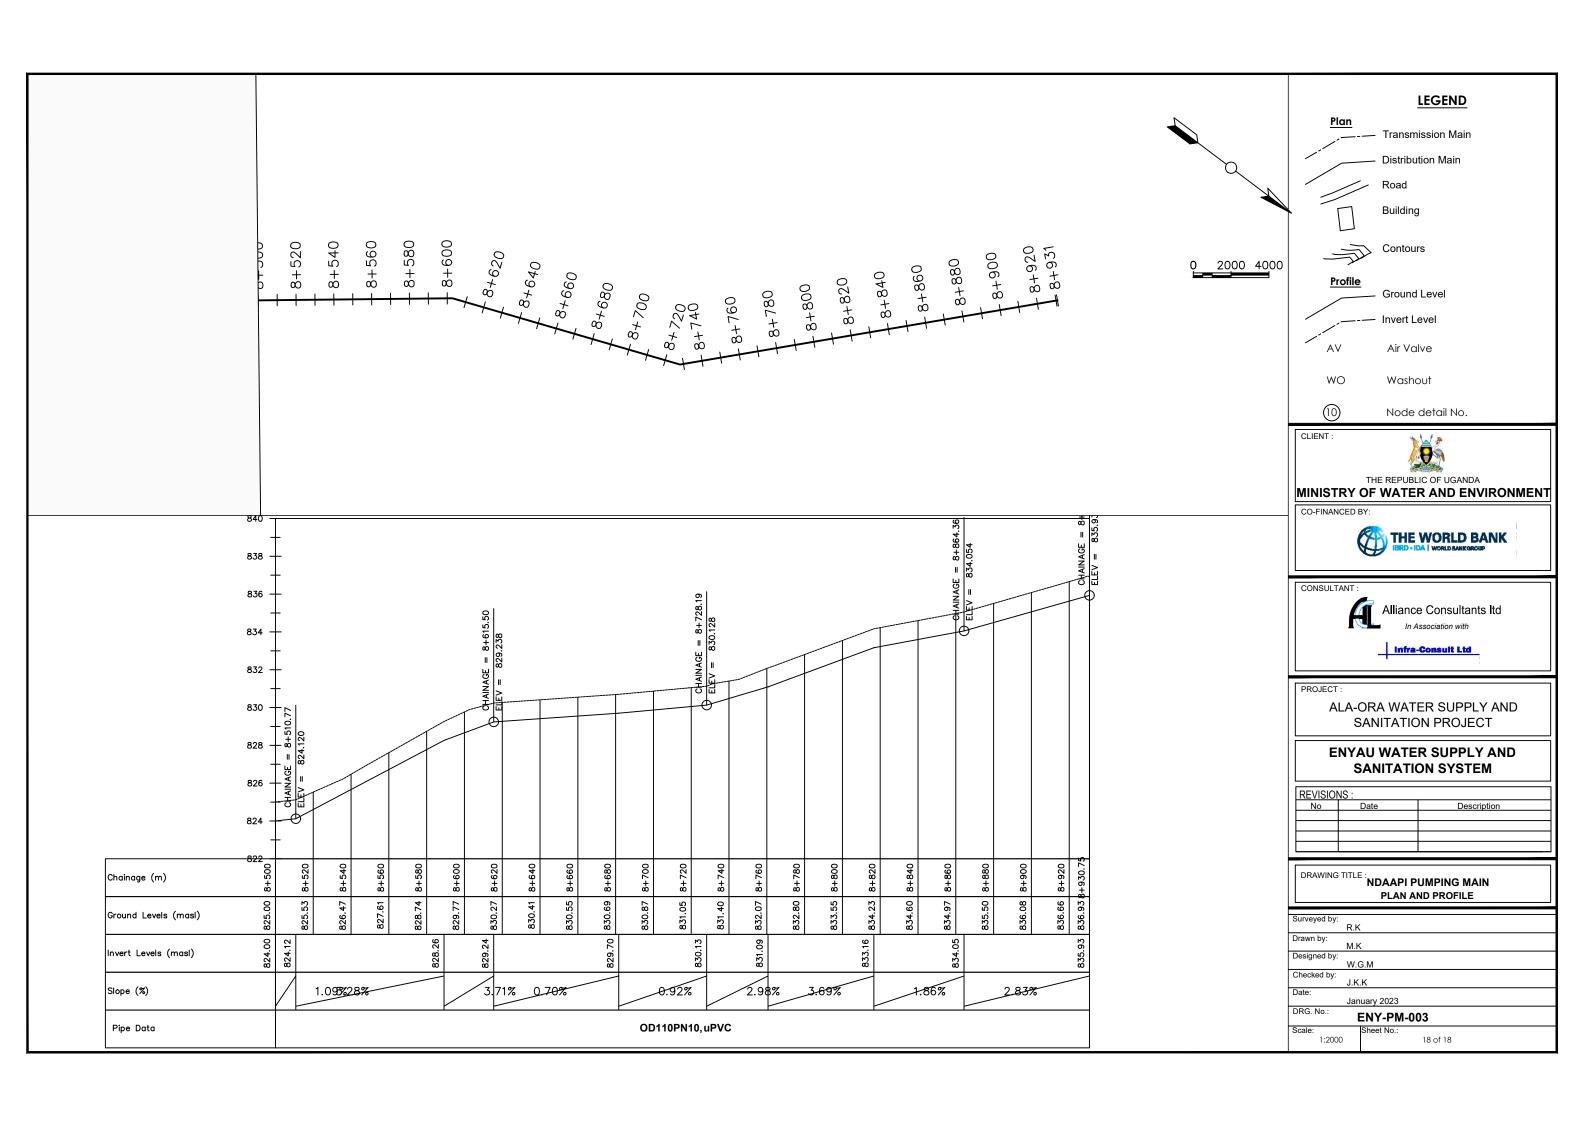

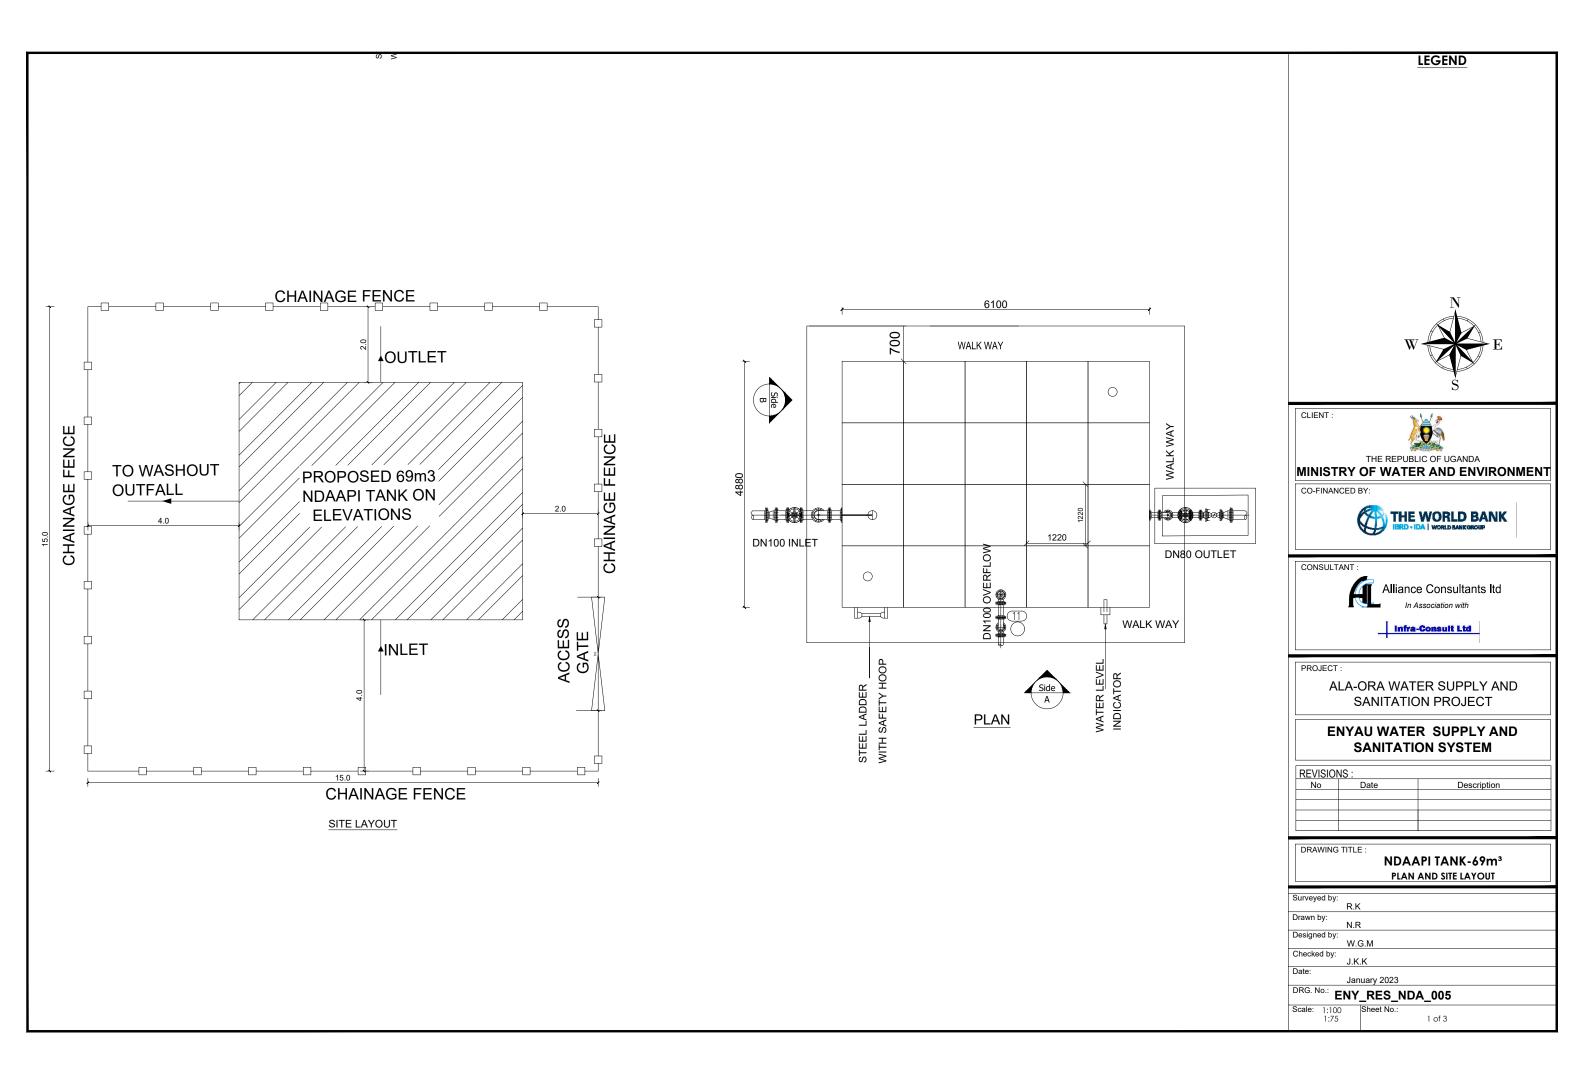

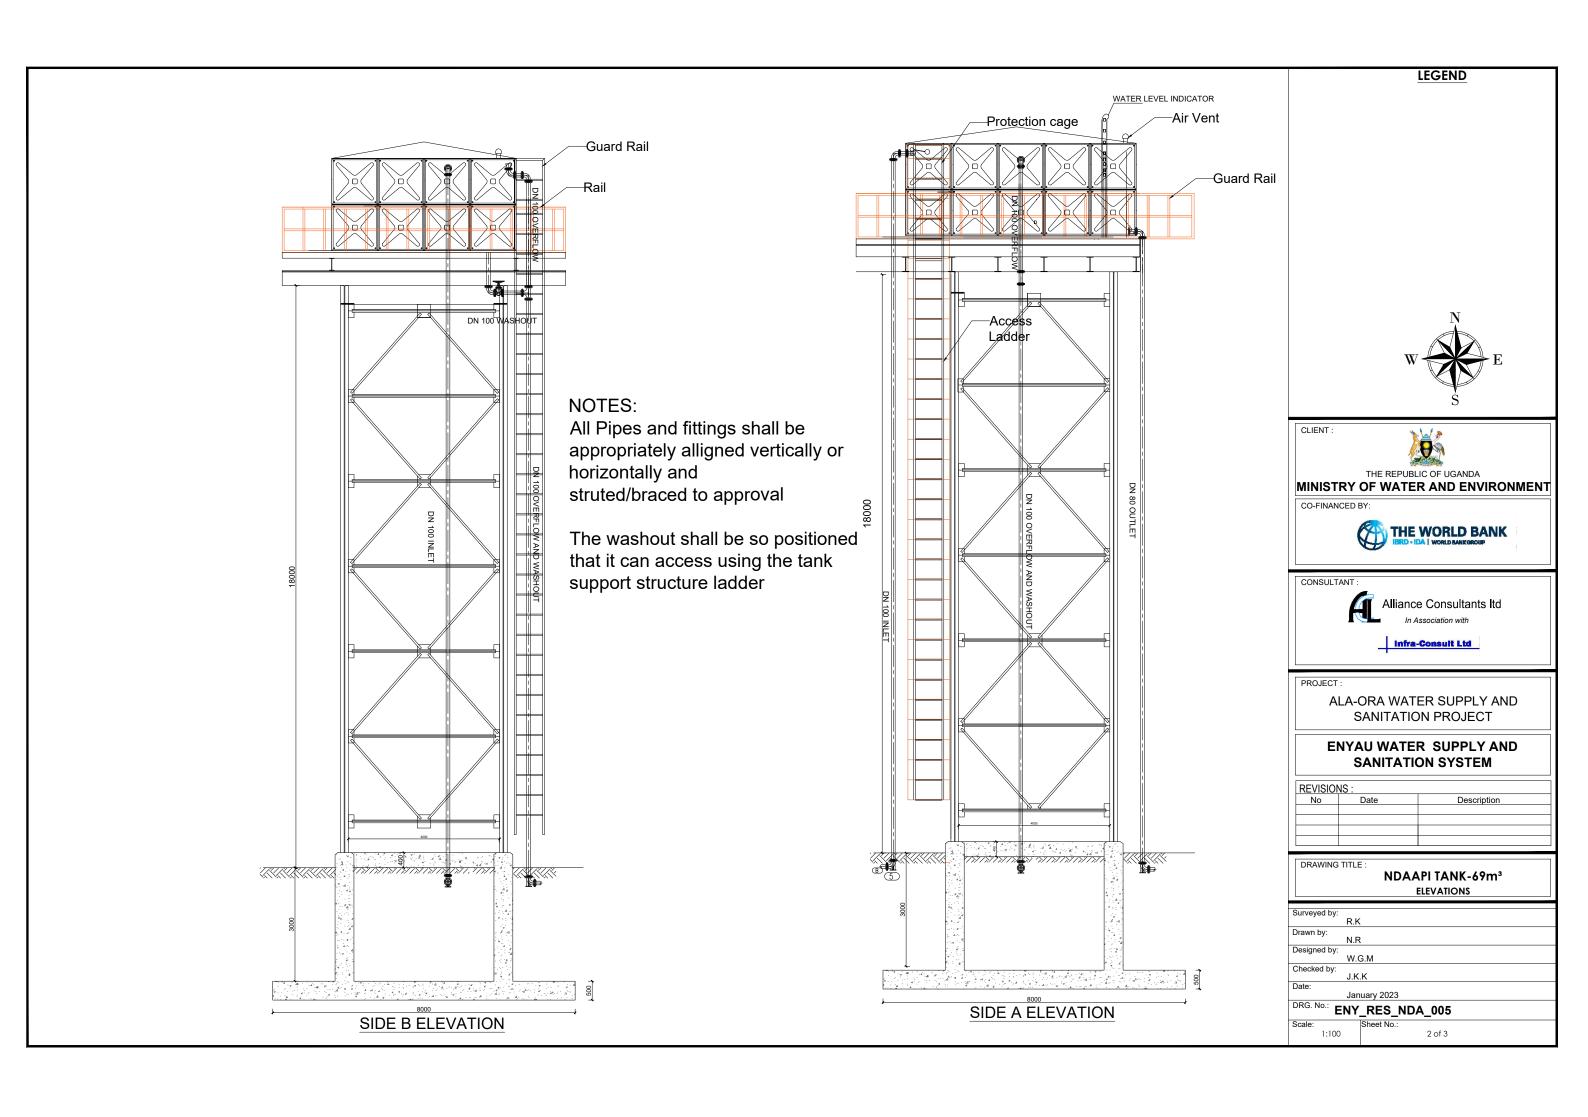

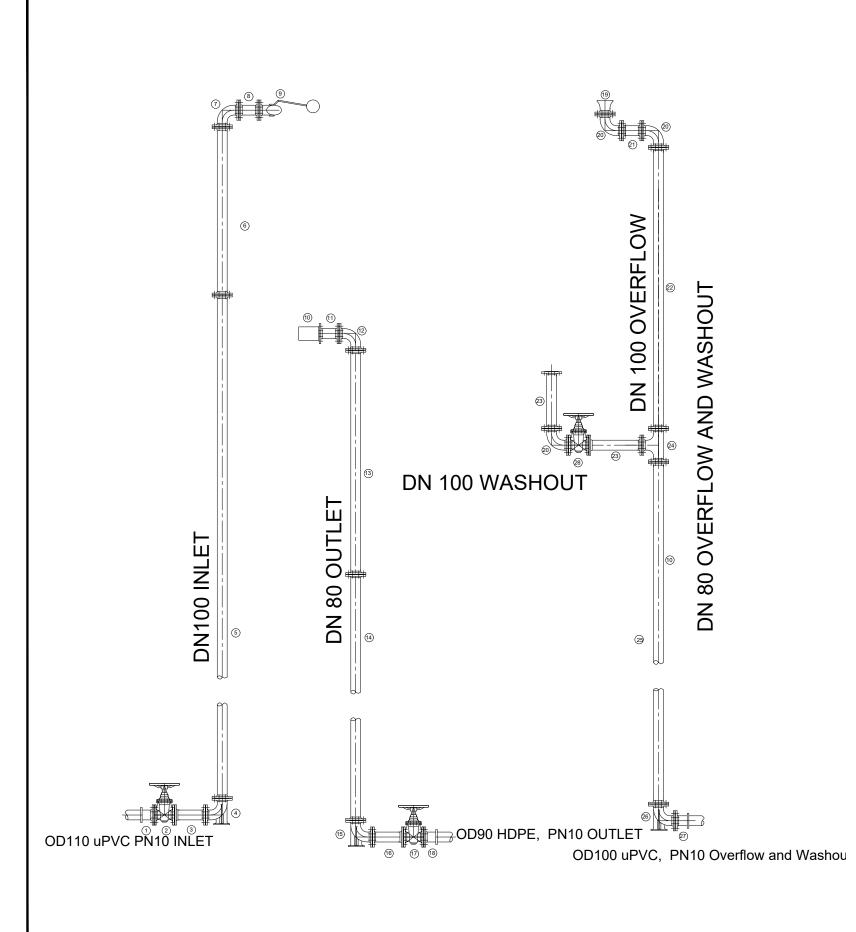

Mark	Description	Material	DN	PN	Qty
	INLET				
1	Flanged Adapter		100		1
2	Flanged Gate Valve	CI	100		1
3	Flanged Pipe Piece, Length - 0.3m	DI	100		1
4	90° Flanged Duckfoot Bend	DI	100		1
5	Flanged Pipe, Length - 6.0m	DI	100	10	2
6	Flanged Pipe, Length n.e - 5.0m	DI	100		1
7	90° Flanged Bend	DI	100		1
8	Flanged Pipe Piece, Length - 0.2m	DI	100		1
9	Flanged Float Valve	CI	100		1
	OUTLET				
10	Flanged Strainer	SS	80		1
11	Flanged Pipe Piece , Length - 0.2m	DI	80		1
12	90° Flanged Bend	DI	80		1
13	Flanged Pipe, Length n.e - 5.0m	DI	80		1
14	Flanged Pipe, Length - 6.0m	DI	80	10	3
15	90° Flanged Duckfoot Bend	DI	80		1
16	Flanged Pipe Piece, Length - 0.3m	DI	80		1
17	Flanged Gate Valve	CI	80		1
18	Flanged Adapter	DI	80		1
	WASHOUT & OVERFLOW				
19	Flanged Bellmouth	DI	100		1
20	90° Flanged Bend	DI	100		2
21	Flanged Pipe, Length n.e - 0.2m	DI	100		1
22	Flanged Pipe Piece, Length n.e - 5.0m	DI	100		1
23	Flanged Pipe Piece, Length n.e - 1.0m	DI	100	10	2
24	Flanged Tee	DI	100	10	1
25	Flanged Pipe Piece, Length - 6.0m	DI	100		2
26	90° Flanged Duckfoot Bend	DI	100		1
27	Flanged Adapter	DI	100		1
28	Flanged Gate Valve	CI	100		







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ALA-ORA WATER SUPPLY AND
SANITATION PROJECT

ENYAU WATER SUPPLY AND SANITATION SYSTEM


REVISIONS:				
No	Date	Description		
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DRAWING TITLE:

NDAAPI TANK-69m³

PIPE FITTINGS

Surveyed by:
R.K
Drawn by:
N.R
Designed by:
W.G.M
Checked by:
J.K.K
Date:
January 2023
DRG. No.: ENY_RES_NDA_005
Scale:
1:75
Sheet No.:
3 of 3




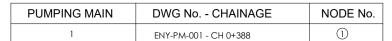

SCHEDULE OF PIPEWORK & FITTINGS

ITEM	DESCRIPTION	SIZE	QTY.	PN
1.	HDPE END CAP	90	1	10

PUMPING MAIN	DWG No CHAINAGE	NODE No.
2	ENY-PM-002 - CH 8+108	2

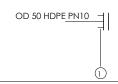

5 (1) (2) (5)

DN 300 STEEL PN10

SCHEDULE OF PIPEWORK & FITTINGS


ITEM	DESCRIPTION	SIZE	QTY.	PN
1.	HDPE END CAP	50	1	10

GRAVITY MAIN	DWG No CHAINAGE	NODE No.
1	ENY-GTM-001- CH 3+015	3



ITEM	DESCRIPTION	SIZE	QTY.	PN
1.	CI ALL FLANGED TEE	300/100	1	10
2.	CI FLANGED GATE VALVE	300	1	10
3	DI FLANGED TAPER	300/100	1	10
4	CI FLANGED GATE VALVE	100	1	10
5	DI FLANGED ADAPTOR (MAXI TYPE OR SIMILAR)	300	2	10
6	DI FLANGED ADAPTOR (MAXI TYPE OR SIMILAR)	100	1	10


GRAVITY MAIN	DWG No CHAINAGE	NODE No.
1	ENY-GTM-001 - CH 14+292	4

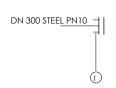

SCHEDULE OF PIPEWORK & FITTINGS

ITEM	DESCRIPTION	SIZE	QTY.	PN
1.	DI END CAP	300	1	10

GRAVITY MAIN	DWG No CHAINAGE	NODE No.
2	ENY-GTM-002 - CH 3+145	5

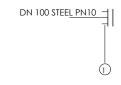

SCHEDULE OF PIPEWORK & FITTINGS

ITEM	DESCRIPTION	SIZE	QTY.	PN
1.	DI END CAP	100	1	10

LEGEND

CLIENT :



THE REPUBLIC OF UGANDA MINISTRY OF WATER AND ENVIRONMENT

CO-FINANCED BY:



CONSULTANT



Alliance Consultants Itd

Infra-Consult Ltd

PROJECT

ALA-ORA WATER SUPPLY AND SANITATION PROJECT

ENYAU WATER SUPPLY AND SANITATION SYSTEM

REVISIONS:					
	No	Date	Description		

DRAWING TITLE: TRANSMISSION NODES DETAILS

Surveyed by:

R.K

Drawn by:

A.K

Designed by:

W.G.M

Checked by:

J.K.K

Date:

January 2023

DRG. No.:

ENY-ND-001


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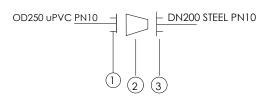
GRAVITY MAIN DWG No. - CHAINAGE NODE No. 3 ENY-GTM-003 - CH 13+450



SCHEDULE OF PIPEWORK & FITTINGS

ITEM	DESCRIPTION	SIZE	QTY.	PN
1.	DI END CAP	160	1	16


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3	ENY-GTM-003 - CH 3+100

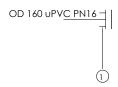

SCHEDULE OF PIPEWORK & FITTINGS

ITEM	DESCRIPTION	SIZE	QTY.	PN
1	DI FLANGED ADAPTOR (MAXI TYPE OR SIMILAR)	250	1	10
2	DI FLANGED TAPER	250/200	1	10
3	DI FLANGED ADAPTOR (MAXI TYPE OR SIMILAR)	200	1	10




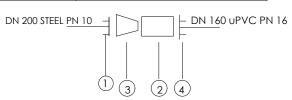

SCHEDULE OF PIPEWORK & FITTINGS

ITEM	DESCRIPTION	SIZE	QTY.	PN
1	DI FLANGED ADAPTOR (MAXI TYPE OR SIMILAR)	200	1	16
2	FLANGED COUPLER	200/160	1	16
3	DI FLANGED TAPER	200/160	1	16
4	DI FLANGED ADAPTOR (MAXI TYPE OR SIMILAR)	160	1	16


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3	ENY-GTM-003 - CH 9+180

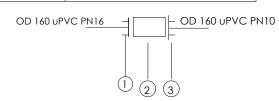

SCHEDULE OF PIPEWORK & FITTINGS

ITE	DESCRIPTION	SIZE	QTY.	PN
1	DI FLANGED ADAPTOR (MAXI TYPE OR SIMILAR)	160	1	16
2	FLANGED COUPLER	160/160	1	16
3	DI FLANGED ADAPTOR (MAXI TYPE OR SIMILAR)	160	1	16

GRAVITY MAIN	DWG No CHAINAGE
3	ENY-GTM-003 - CH 10+260

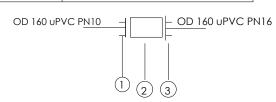

SCHEDULE OF PIPEWORK & FITTINGS

ITEM	DESCRIPTION	SIZE	QTY.	PN
1	DI FLANGED ADAPTOR (MAXI TYPE OR SIMILAR)	160	1	16
2	FLANGED COUPLER	160/160	1	16
3	DI FLANGED ADAPTOR (MAXI TYPE OR SIMILAR)	160	1	16

LEGEND

CLIENT :



THE REPUBLIC OF UGANDA
MINISTRY OF WATER AND ENVIRONMENT

CO-FINANCED BY:



CONSULTANT



Alliance Consultants Itd

Infra-Consult Ltd

PROJEC

ALA-ORA WATER SUPPLY AND SANITATION PROJECT


ENYAU WATER SUPPLY AND SANITATION SYSTEM

REVISIONS:			
No	Date	Description	
		·	

TRANSMISSION NODES DETAILS

Surveyed by:	R.K
Drawn by:	A.K
Designed by:	W.G.M
Checked by:	J.K.K
Date:	January 2023
DRG. No.:	ENY-ND-001
Scale: 1:5	Sheet No.: 2 of 3


DISTRIBUTION MAIN DWG No. - CHAINAGE NODE No. 1 ENY-DM-001 - CH 7+493 7

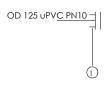

SCHEDULE OF PIPEWORK & FITTINGS

ITEM	DESCRIPTION	SIZE	QTY.	PN
1.	DI END CAP	125	1	10


DISTRIBUTION MAIN	DWG No CHAINAGE
1	ENY-DM-001 - CH 2+450

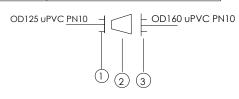

SCHEDULE OF PIPEWORK & FITTINGS

ITEM	DESCRIPTION	SIZE	QTY.	PN
1	DI FLANGED ADAPTOR (MAXI TYPE OR SIMILAR)	125	1	10
2	DI FLANGED TAPER	160/125	1	10
3	DI FLANGED ADAPTOR (MAXI TYPE OR SIMILAR)	160	1	10


DISTRIBUTION MAIN	DWG No CHAINAGE
1	ENY-DM-001 - CH 6+320

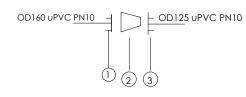

SCHEDULE OF PIPEWORK & FITTINGS

ITEM	DESCRIPTION	SIZE	QTY.	PN
1	DI FLANGED ADAPTOR (MAXI TYPE OR SIMILAR)	160	1	10
2	DI FLANGED TAPER	160/125	1	10
3	DI FLANGED ADAPTOR (MAXI TYPE OR SIMILAR)	125	1	10


GRAVITY MAIN	DWG No CHAINAGE
3	ENY-GTM-003 - CH 9+180

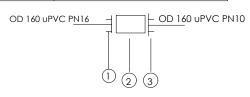

SCHEDULE OF PIPEWORK & FITTINGS

ITEM	DESCRIPTION	SIZE	QTY.	PN
1	DI FLANGED ADAPTOR (MAXI TYPE OR SIMILAR)	160	1	16
2	FLANGED COUPLER	160/160	1	16
3	DI FLANGED ADAPTOR (MAXI TYPE OR SIMILAR)	160	1	16

GRAVITY MAIN	DWG No CHAINAGE
3	ENY-GTM-003 - CH 10+260

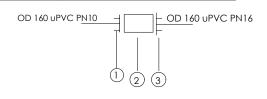

SCHEDULE OF PIPEWORK & FITTINGS

ITEM	DESCRIPTION	SIZE	QTY.	PN
1	DI FLANGED ADAPTOR (MAXI TYPE OR SIMILAR)	160	1	16
2	FLANGED COUPLER	160/160	1	16
3	DI FLANGED ADAPTOR (MAXI TYPE OR SIMILAR)	160	1	16

LEGEND

CLIENT :



THE REPUBLIC OF UGANDA MINISTRY OF WATER AND ENVIRONMENT

CO-FINANCED BY:



CONSULTANT



Alliance Consultants Itd

Infra-Consult Ltd

PROJECT

ALA-ORA WATER SUPPLY AND SANITATION PROJECT


ENYAU WATER SUPPLY AND SANITATION SYSTEM


REVISIONS:					
No	Date	Description			
		·			

TRANSMISSION NODES DETAILS

Surveyed by:	
, ,	R.K
Drawn by:	
	A.K
Designed by:	
,	W.G.M
Checked by:	
	J.K.K
Date:	
	January 2023
DRG. No.:	ENV ND 004
	ENY-ND-001
Scale:	Sheet No.:
1:5.5	3 of 3

STRUCTURAL DRAWINGS

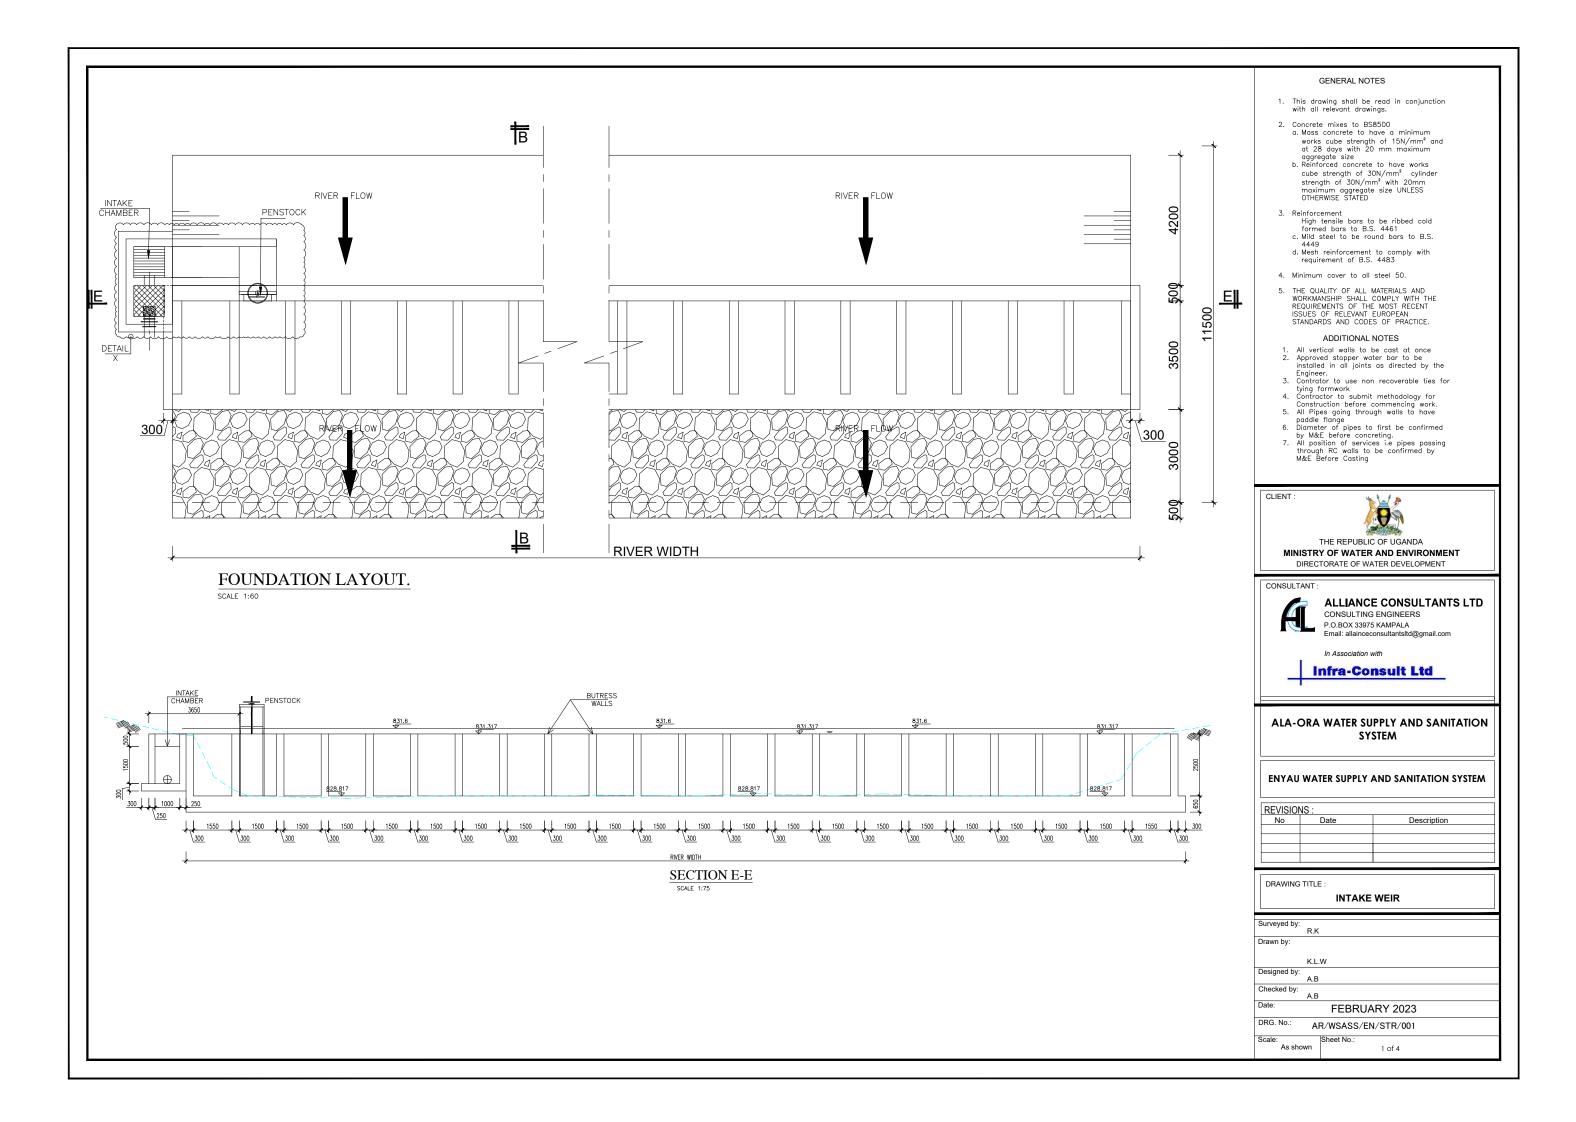

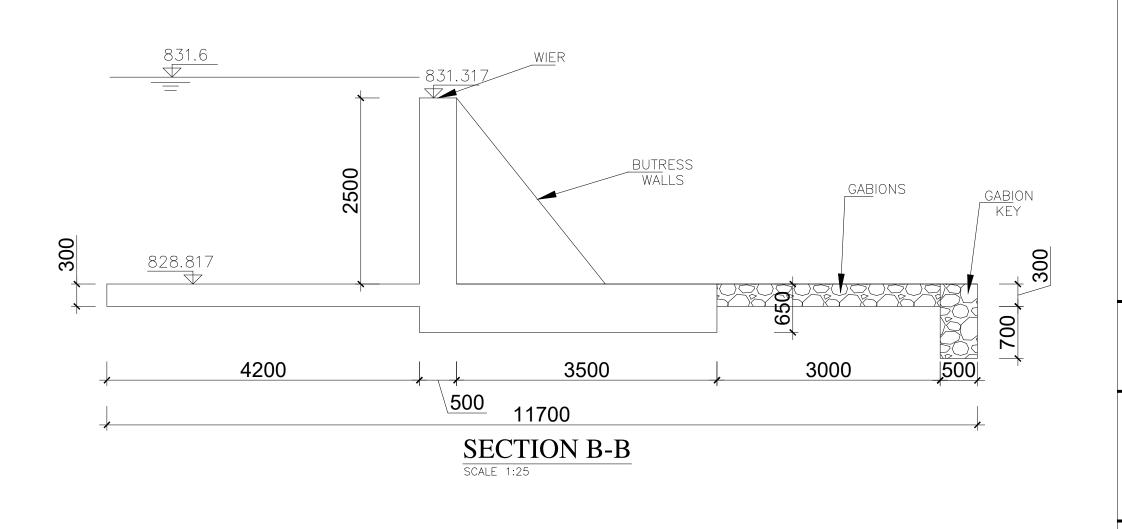

GENERAL NOTES

- This drawing shall be read in conjunction with all relevant drawings.

- Concrete mixes to BS8500
 a. Mass concrete to have a minimum works cube strength of 15N/mm² and at 28 days with 20 mm maximum aggregate size
 b. Reinforced concrete to have works cube strength of 30N/mm² cylinder strength of 30N/mm² with 20mm maximum aggregate size UNLESS OTHERWISE STATED
- 3. Reinforcement
 High tensile bars to be ribbed cold
 formed bars to B.S. 4461
 c. Mild steel to be round bars to B.S.
 4449
 d. Mesh reinforcement to comply with
 requirement of B.S. 4483
- 4. Minimum cover to all steel 50.
- 5. THE QUALITY OF ALL MATERIALS AND WORKMANSHIP SHALL COMPLY WITH THE REQUIREMENTS OF THE MOST RECENT ISSUES OF RELEVANT EUROPEAN STANDARDS AND CODES OF PRACTICE.

ADDITIONAL NOTES

- ADDITIONAL NOTES

 1. All vertical walls to be cast at once
 2. Approved stopper water bar to be installed in all joints as directed by the Engineer.
 3. Contrator to use non recoverable ties for tying formwork
 4. Contractor to submit methodology for Construction before commencing work.
 5. All Pipes going through walls to have paddle flange
 6. Diameter of pipes to first be confirmed by M&E before concreting.
 7. All position of services i.e pipes passing through RC walls to be confirmed by M&E Before Casting

CLIENT :



THE REPUBLIC OF UGANDA MINISTRY OF WATER AND ENVIRONMENT DIRECTORATE OF WATER DEVELOPMENT

CONSULTANT:



ALLIANCE CONSULTANTS LTD CONSULTING ENGINEERS

P.O.BOX 33975 KAMPALA Email: allainceconsultantsltd@gmail.com

In Association with

Infra-Consult Ltd

ALA-ORA WATER SUPPLY AND SANITATION SYSTEM


ENYAU WATER SUPPLY AND SANITATION SYSTEM


REVISIONS:					
No	Date	Description			

DRAWING TITLE :

INTAKE WEIR

Surveyed by:	·			
	R.K			
Drawn by:				
	K.L.	W		
Designed by:				
	A.B			
Checked by:				
	A.B			
Date:		FEBRUARY 2023		
I LDINUART 2023				
DRG. No.:	IG. No.: AR/WSASS/EN/STR/001			
		,		
Scale:		Sheet No.:		
As sho	wn	2 of 4		

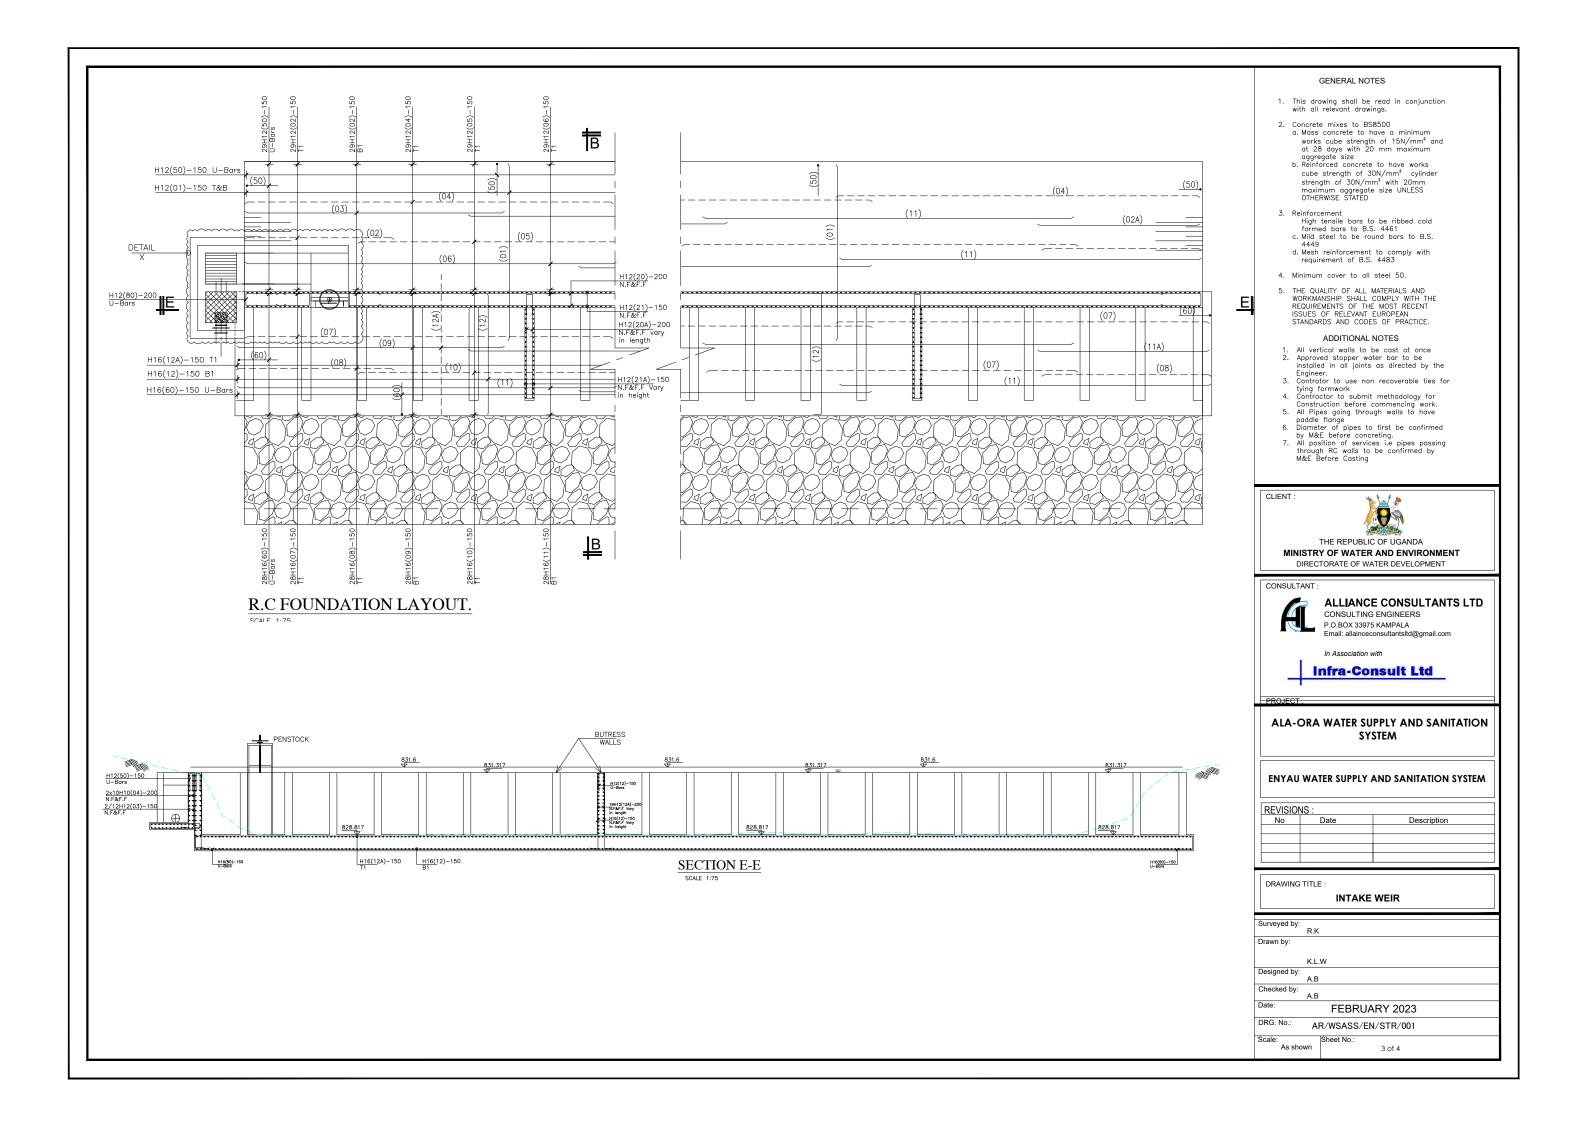

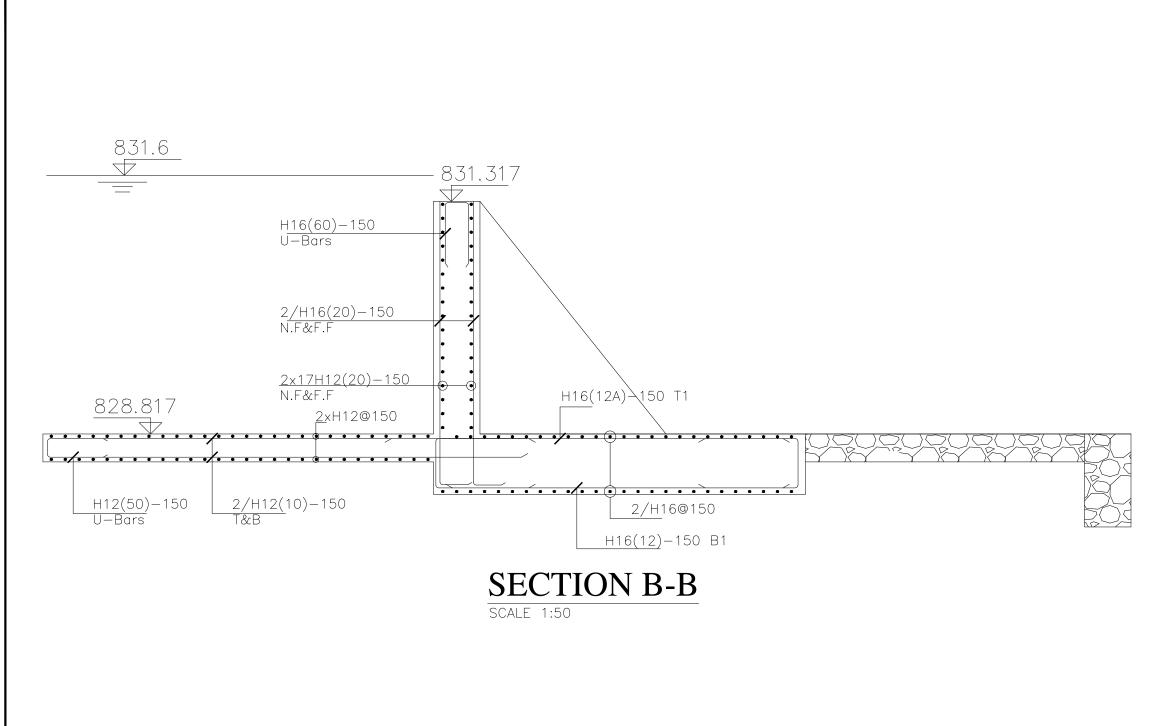

GENERAL NOTES

- This drawing shall be read in conjunction with all relevant drawings.

- Concrete mixes to BS8500
 a. Mass concrete to have a minimum works cube strength of 15N/mm² and at 28 days with 20 mm maximum aggregate size
 b. Reinforced concrete to have works cube strength of 30N/mm² vith 20mm maximum aggregate size UNLESS OTHERWISE STATED

- 3. Reinforcement
 High tensile bars to be ribbed cold
 formed bars to B.S. 4461
 c. Mild steel to be round bars to B.S.
 4449
 d. Mesh reinforcement to comply with
 requirement of B.S. 4483
- 4. Minimum cover to all steel 50.
- 5. THE QUALITY OF ALL MATERIALS AND WORKMANSHIP SHALL COMPLY WITH THE REQUIREMENTS OF THE MOST RECENT ISSUES OF RELEVANT EUROPEAN STANDARDS AND CODES OF PRACTICE.

ADDITIONAL NOTES

- ADDITIONAL NOTES

 1. All vertical walls to be cast at once
 2. Approved stopper water bar to be installed in all joints as directed by the Engineer.
 3. Contrator to use non recoverable ties for tying formwork
 4. Contractor to submit methodology for Construction before commencing work.
 5. All Pipes going through walls to have paddle flange
 6. Diameter of pipes to first be confirmed by M&E before concreting.
 7. All position of services i.e pipes passing through RC walls to be confirmed by M&E Before Casting

CLIENT :



THE REPUBLIC OF UGANDA MINISTRY OF WATER AND ENVIRONMENT DIRECTORATE OF WATER DEVELOPMENT

CONSULTANT



ALLIANCE CONSULTANTS LTD CONSULTING ENGINEERS P.O.BOX 33975 KAMPALA

In Association with

Infra-Consult Ltd

ALA-ORA WATER SUPPLY AND SANITATION SYSTEM

ENYAU WATER SUPPLY AND SANITATION SYSTEM

RE	REVISIONS:				
	No	Date	Description		


DRAWING TITLE :

INTAKE WEIR

Surveyed by: Drawn by: Designed by: Checked by: FEBRUARY 2023 DRG. No.: AR/WSASS/EN/STR/001

Scale:

4 of 4

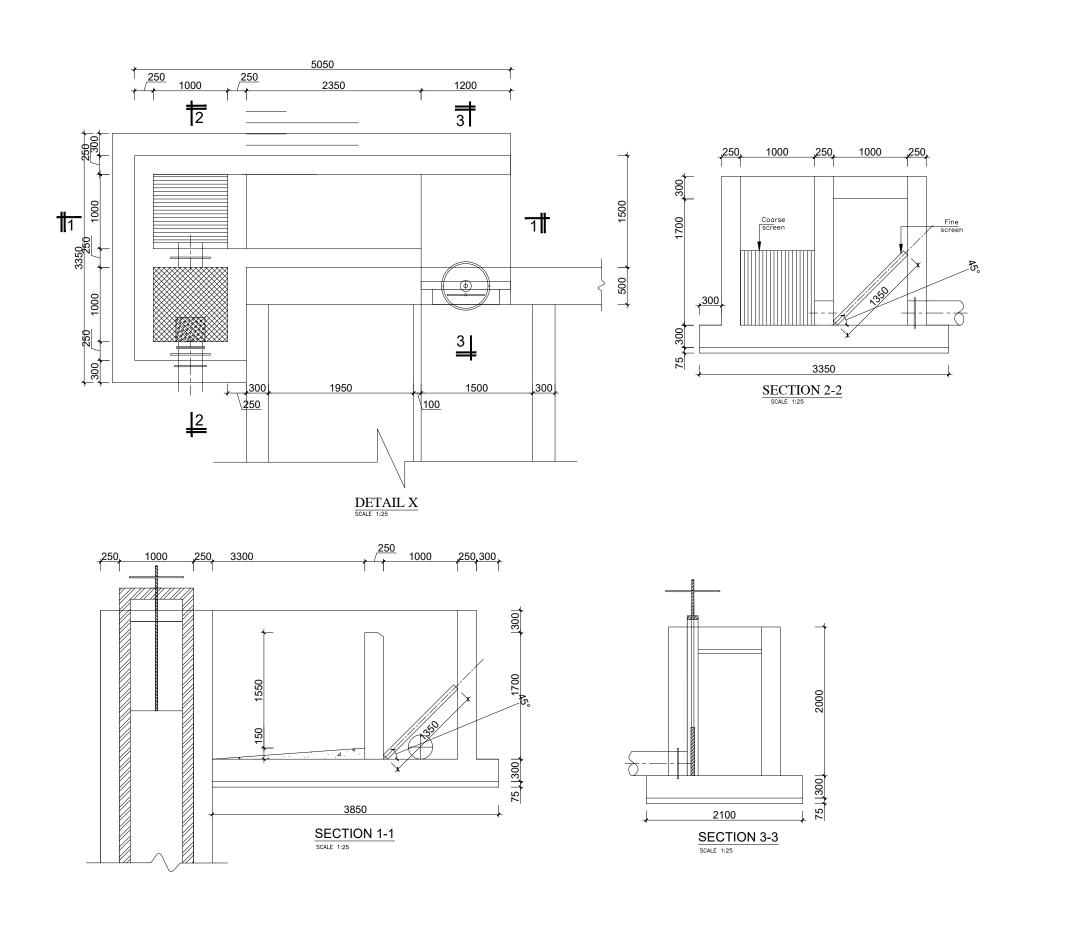

- This drawing shall be read in conjunction with all relevant drawings.
- Concrete mixes to BS8500
 a. Mass concrete to have a minimum works cube strength of 15N/mm² and at 28 days with 20 mm maximum aggregate size
 b. Reinforced concrete to have works cube strength of 30N/mm² cylinder strength of 30N/mm² with 20mm maximum aggregate size UNLESS OTHERWISE STATED
- Reinforcement
 High tensile bars to be ribbed cold formed bars to B.S. 4461
 c. Mild steel to be round bars to B.S. 4448
- d. Mesh reinforcement to comply with requirement of B.S. 4483
- 4. Minimum cover to all steel 50.
- 5. THE QUALITY OF ALL MATERIALS AND WORKMANSHIP SHALL COMPLY WITH THE REQUIREMENTS OF THE MOST RECENT ISSUES OF RELEVANT EUROPEAN STANDARDS AND CODES OF PRACTICE.

ADDITIONAL NOTES

- ADDITIONAL NOTES

 1. All vertical walls to be cast at once
 2. Approved stopper water bar to be installed in all joints as directed by the Engineer.
 3. Contrator to use non recoverable ties for tying formwork
 4. Contractor to submit methodology for Construction before commencing work.
 5. All Pipes going through walls to have paddle flange
 6. Diameter of pipes to first be confirmed by M&E before concreting.
 7. All position of services i.e pipes passing through RC walls to be confirmed by M&E Before Casting

CLIENT :



THE REPUBLIC OF UGANDA MINISTRY OF WATER AND ENVIRONMENT DIRECTORATE OF WATER DEVELOPMENT



ALLIANCE CONSULTANTS LTD

CONSULTING ENGINEERS

Infra-Consult Ltd

P.O.BOX 33975 KAMPALA Email: allainceconsultantsltd@gmail.com

PROJECT :

ALA-ORA WATER SUPPLY AND SANITATION SYSTEM


ENYAU WATER SUPPLY AND SANITATION SYSTEM


REVISIONS:			
	No	Date	Description

DRAWING TITLE :

INTAKE STRUCTURE

	R.K
Drawn by:	K.L.W
Designed by:	A.B
Checked by:	
	A.B
Date:	FEBRUARY 2023
DRG. No.: AR/WSASS/EN/STR/002	
Scale: 1:20	Sheet No.: 1 of 2

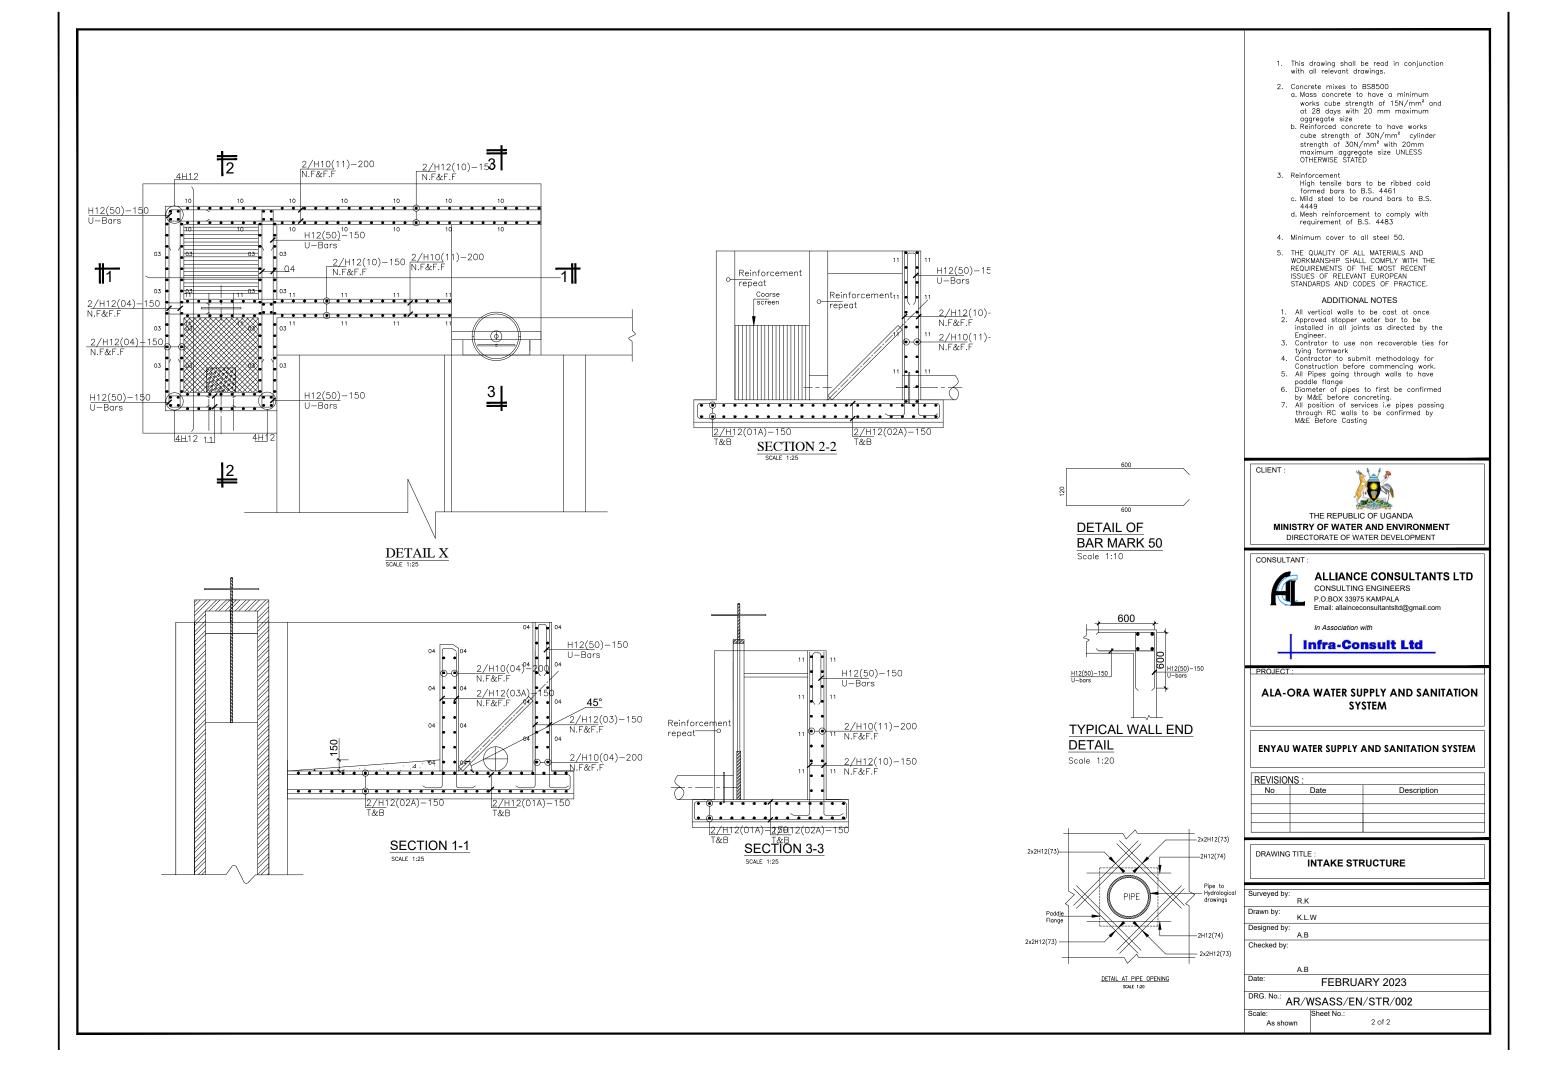

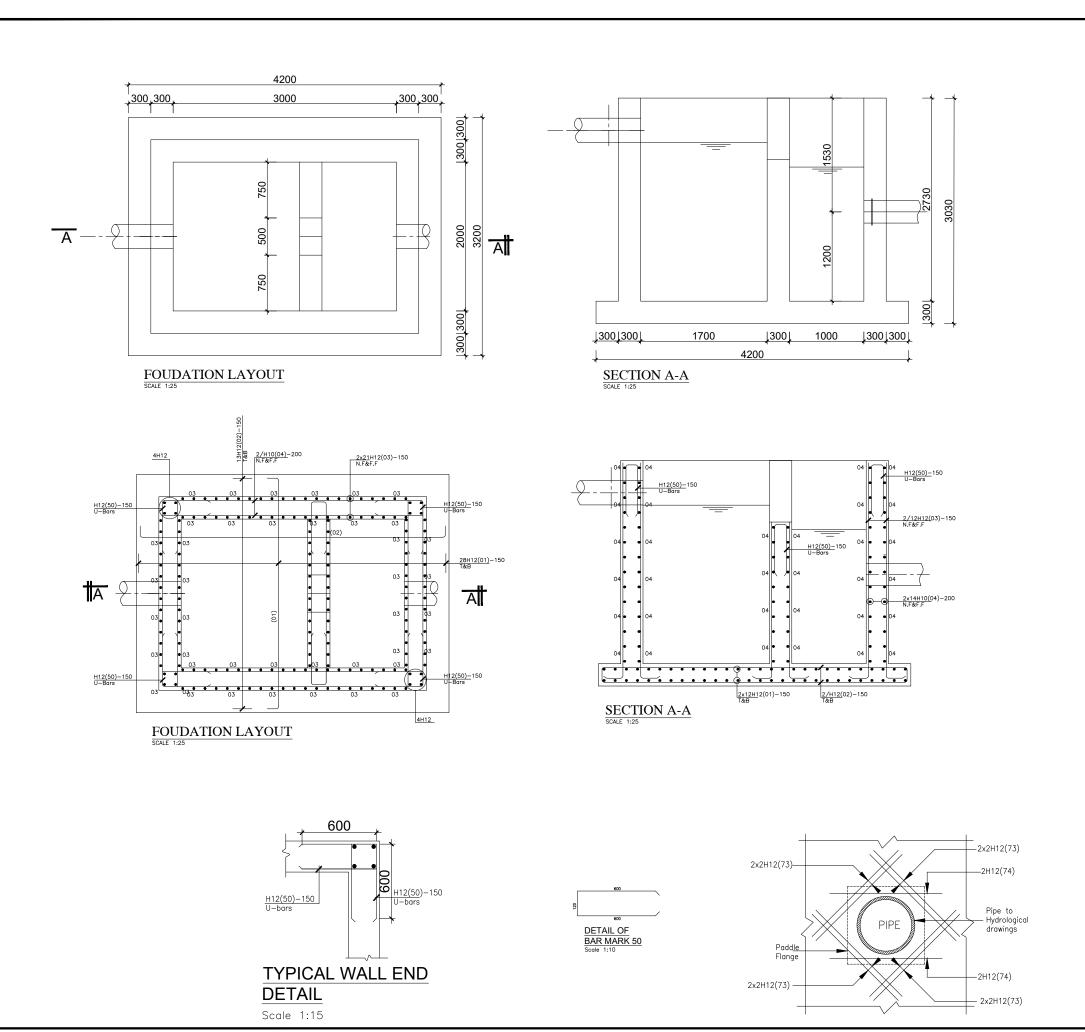

GENERAL NOTES

- This drawing shall be read in conjunction with all relevant drawings.
- Concrete mixes to BS8500
 a. Mass concrete to have a minimum works cube strength of 15N/mm² and at 28 days with 20 mm maximum
- at 20 days with 20 mm maximum aggregate size

 b. Reinforced concrete to have works cube strength of 30N/mm² with 20mm maximum aggregate size UNLESS OTHERWISE STATED
- 3. Reinforcement
 High tensile bars to be ribbed cold
 formed bars to B.S. 4461
 c. Mild steel to be round bars to B.S.
 4449
 d. Mesh reinforcement to comply with
 requirement of B.S. 4483

- 4. Minimum cover to all steel 50.
- 5. THE QUALITY OF ALL MATERIALS AND WORKMANSHIP SHALL COMPLY WITH THE REQUIREMENTS OF THE MOST RECENT ISSUES OF RELEVANT EUROPEAN STANDARDS AND CODES OF PRACTICE.

ADDITIONAL NOTES

- All vertical walls to be cast at once
 Approved stopper water bar to be installed in all joints as directed by the February. Engineer.
 3. Contrator to use non recoverable ties for

- 3. Contrator to use non recoverable ties for tying formwork
 4. Contractor to submit methodology for Construction before commencing work.
 5. All Pipes going through walls to have paddle flange
 6. Diameter of pipes to first be confirmed by M&E before concreting.
 7. All position of services i.e pipes passing through RC walls to be confirmed by M&E Before Casting

CLIENT



THE REPUBLIC OF UGANDA MINISTRY OF WATER AND ENVIRONMENT DIRECTORATE OF WATER DEVELOPMENT

CONSULTANT



ALLIANCE CONSULTANTS LTD

CONSULTING ENGINEERS P.O.BOX 33975 KAMPALA Email: allainceconsultantsltd@gmail.com

In Association with



PROJECT

ALA-ORA WATER SUPPLY AND SANITATION SYSTEM


ENYAU WATER TREATMENT PLANT

REVISIO	NS:	
No	Date	Description
		·


DRAWING TITLE : INLET STRUCTURE

Surveyed by: R.K Drawn by: Luks Designed by: A.B Checked by: A.B Date: FEBRUARY 2023 DRG. No.: AR/WSASS/EN/STR/003 Sheet No.: Scale:

1215 3785 1445 1200×1200×300 Base Base Col.C1 <u>B</u>1 5230 FOUNDATION LAYOUT

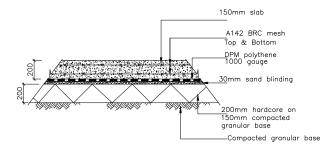

TYPICAL SECTION THROUGH THE GROUND SLAB

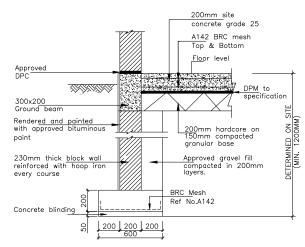



SECTION THROUGH WALL FOOTING

Scale 1:20

2H16-12

230mm BLOCKWALL

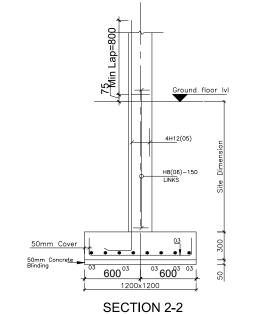

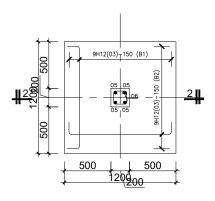

BASE TYPE F1 (4No.) [1200x1200x400]



200

GENERAL NOTES

- This drawing shall be read in conjunction with all relevant drawings.
- 2. Concrete mixes to BS8500
- Concrete mixes to BS8500
 a. Mass concrete to have a minimum
 works cube strength of 15N/mm² and
 at 28 days with 20 mm maximum
 aggregate size
 b. Reinforced concrete to have works
 cube strength of 30N/mm² cylinder
 strength of 30N/mm² with 20mm
 maximum aggregate size UNLESS
 OTHERWISE STATED
- 3. Reinforcement
 High tensile bars to be ribbed cold
 formed bars to B.S. 4461
 c. Mild steel to be round bars to B.S.
 4449
- d. Mesh reinforcement to comply with requirement of B.S. 4483
- 4. Minimum cover to all steel 50.
- 5. THE QUALITY OF ALL MATERIALS AND WORKMANSHIP SHALL COMPLY WITH THE REQUIREMENTS OF THE MOST RECENT ISSUES OF RELEVANT EUROPEAN STANDARDS AND CODES OF PRACTICE.

ADDITIONAL NOTES

- ADDITIONAL NOTES

 1. All vertical walls to be cast at once
 2. Approved stopper water bar to be
 installed in all joints as directed by the
 Engineer.
 3. Contrator to use non recoverable ties for
 tying formwork
 4. Contractor to submit methodology for
 Construction before commencing work.
 5. All Pipes going through walls to have
 paddle flange
 6. Diameter of pipes to first be confirmed
 by M&E before concreting.
 7. All position of services i.e pipes passing
 through RC walls to be confirmed by
 M&E Before Casting

CLIENT



THE REPUBLIC OF UGANDA MINISTRY OF WATER AND ENVIRONMENT DIRECTORATE OF WATER DEVELOPMENT



ALLIANCE CONSULTANTS LTD

CONSULTING ENGINEERS

Infra-Consult Ltd

P.O.BOX 33975 KAMPALA Email: allainceconsultantsltd@gmail.com

PROJECT


ALA-ORA WATER SUPPLY AND SANITATION SYSTEM


ENYAU WATER TREATMENT PLANT

REVISIO	NS:	
No	Date	Description

DRAWING TITLE: ALUM DOSING AND MIXING PLATFORM

Surveyed by:	R.K	
Drawn by:	Luks	
Designed by:	A.B	
Checked by:	A.B	
Date:	FEBRUARY 2023	
DRG. No.:	AR/WSASS/EN/STR/004	
Scale:	Sheet No.: 1 of 2	

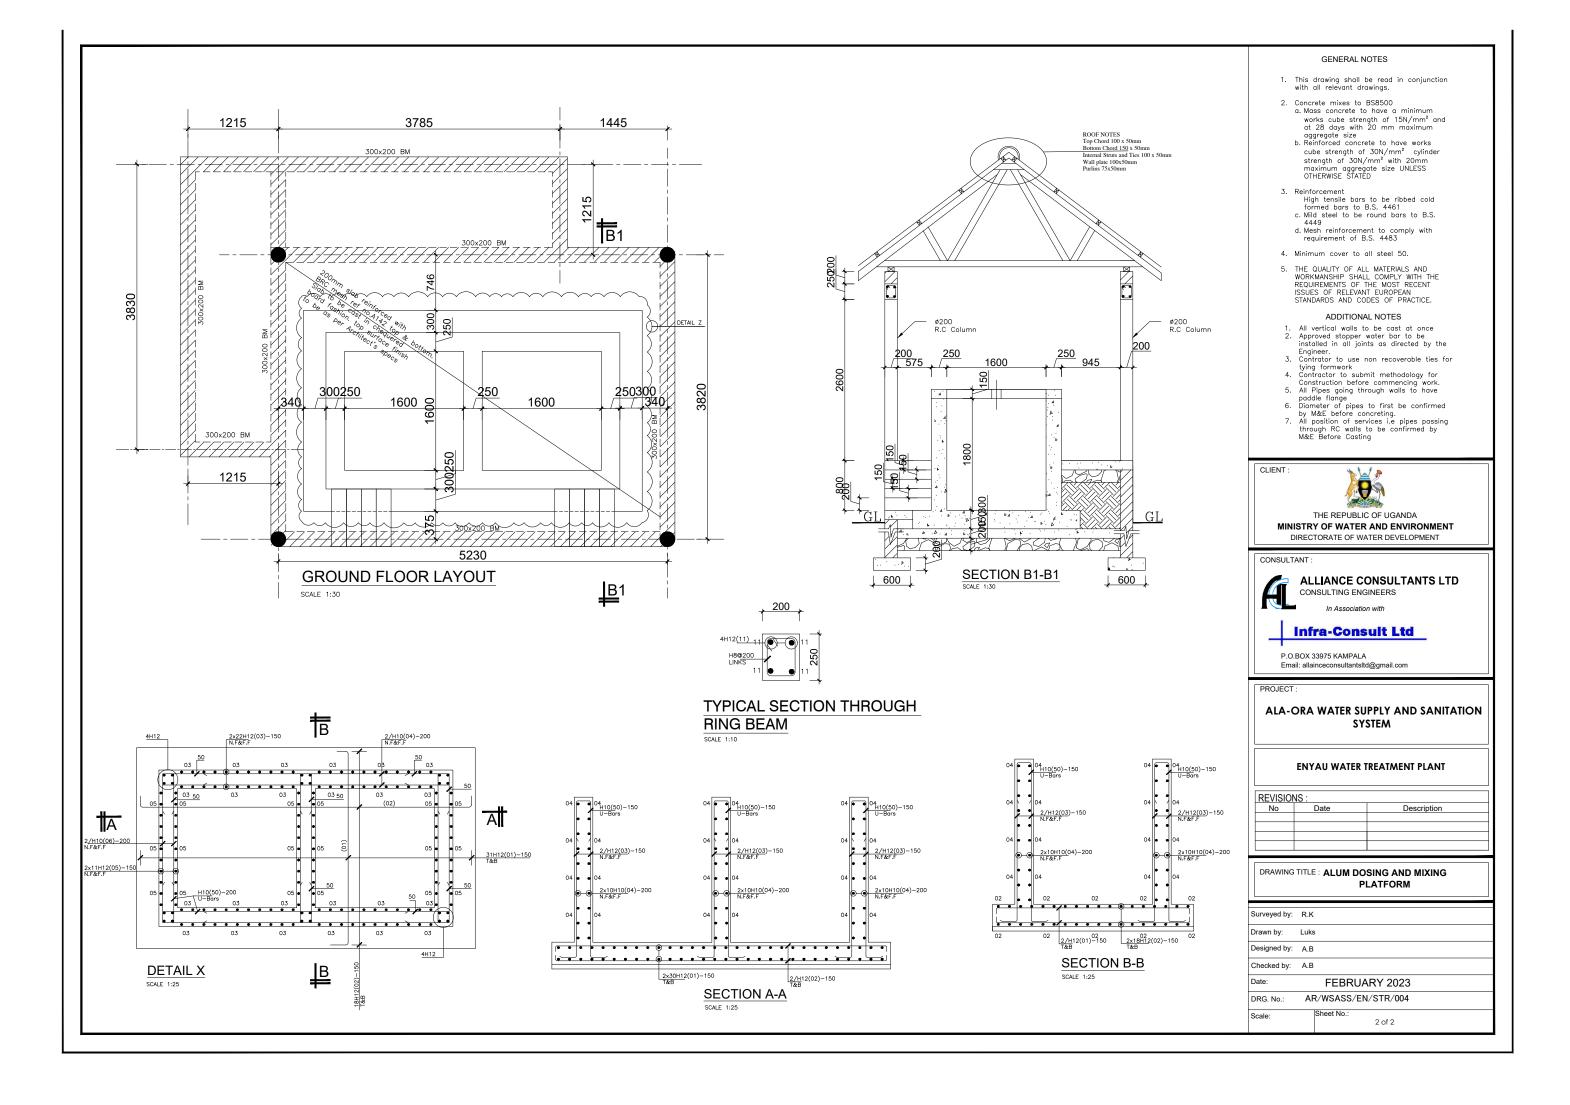

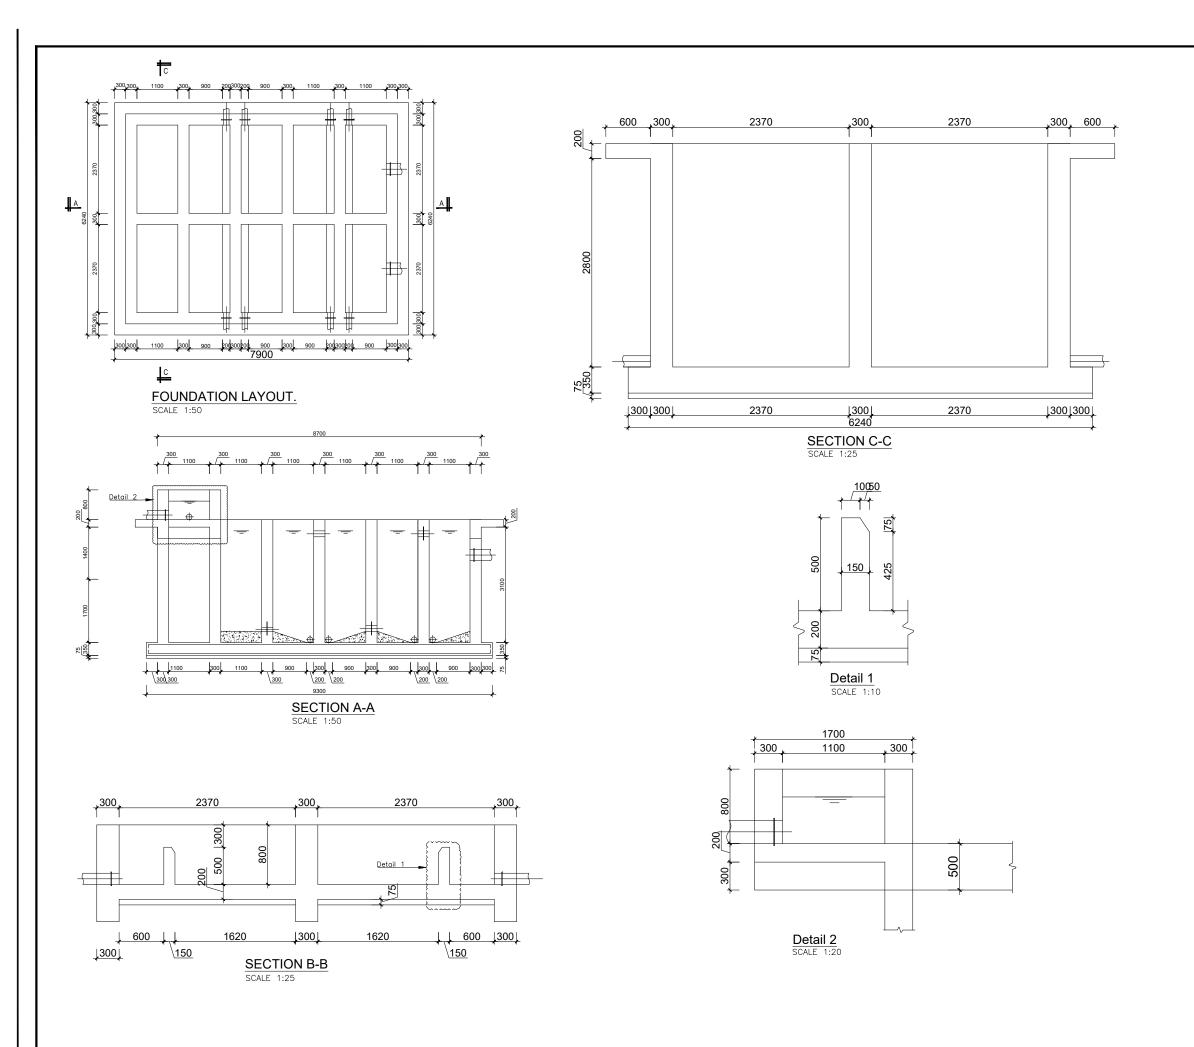

- This drawing shall be read in conjunction with all relevant drawings.
- Concrete mixes to BS8500
 a. Mass concrete to have a minimum works cube strength of 15h/mm² and at 28 days with 20 mm maximum aggregate size
 b. Reinforced concrete to have works cube strength of 30h/mm² cylinder strength of 30h/mm² with 20mm maximum aggregate size UNLESS OTHERWISE STATED
- 3. Reinforcement
 High tensile bars to be ribbed cold
 formed bars to B.S. 4461
 c. Mild steel to be round bars to B.S.

 AA4a
 - d. Mesh reinforcement to comply with requirement of B.S. 4483
- 4. Minimum cover to all steel 50.
- 5. THE QUALITY OF ALL MATERIALS AND WORKMANSHIP SHALL COMPLY WITH THE REQUIREMENTS OF THE MOST RECENT ISSUES OF RELEVANT EUROPEAN STANDARDS AND CODES OF PRACTICE.

ADDITIONAL NOTES

- ADDITIONAL NOTES

 1. All vertical walls to be cast at once
 2. Approved stopper water bar to be installed in all joints as directed by the Engineer.
 3. Contrator to use non recoverable ties for tying formwork
 4. Contractor to submit methodology for Construction before commencing work.
 5. All Pipes going through walls to have paddle flange
 6. Diameter of pipes to first be confirmed by M&E before concreting.
 7. All position of services i.e pipes passing through RC walls to be confirmed by M&E Before Casting

CLIENT



THE REPUBLIC OF UGANDA MINISTRY OF WATER AND ENVIRONMENT DIRECTORATE OF WATER DEVELOPMENT



ALLIANCE CONSULTANTS LTD

CONSULTING ENGINEERS



P.O.BOX 33975 KAMPALA Email: allainceconsultantsltd@gmail.com

PROJECT :

ALA-ORA WATER SUPPLY AND SANITATION SYSTEM


ENYAU WATER SUPPLY AND SANITATION SYSTEM


REVISIONS:		
No	Date	Description


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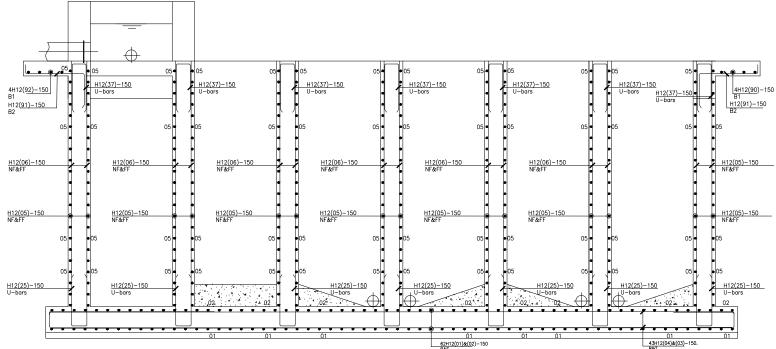
FLOCCULATOR

Surveyed by:		
	R.K	
Drawn by:	K.L.W	
Designed by:	A.B	
Checked by:		
	A.B	
Date:		FEBRUARY 2023
DRG. No.: AF	R/WS	ASS/EN/STR/005
Scale:	Sh	neet No.:
As shown		1 of 4



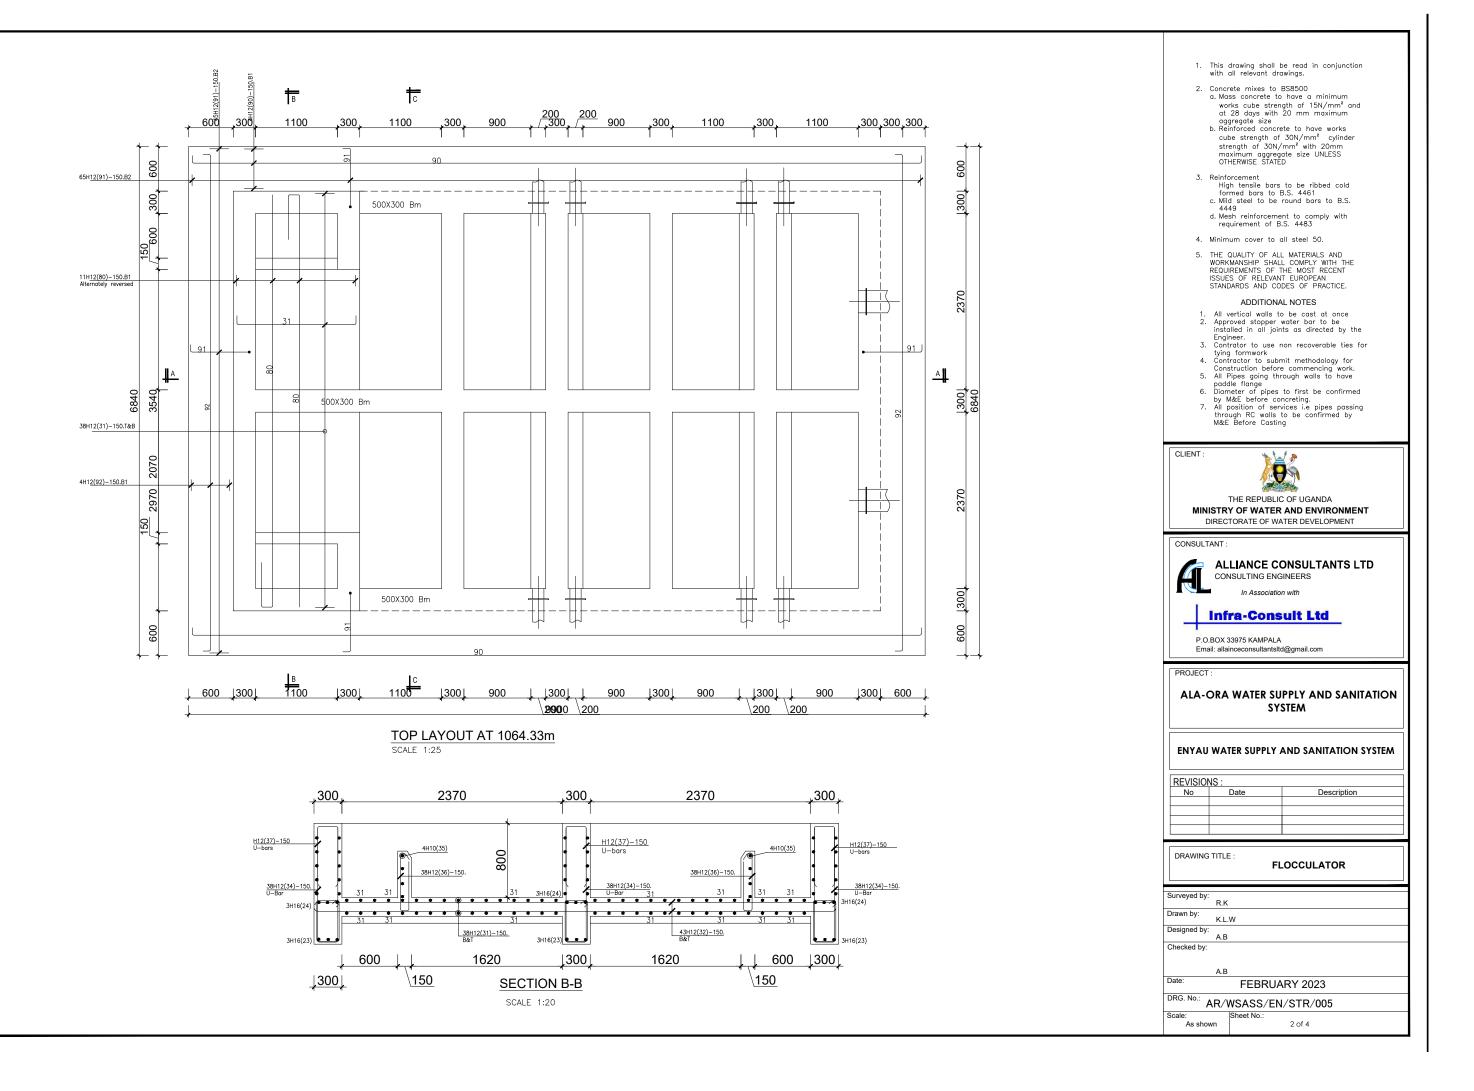

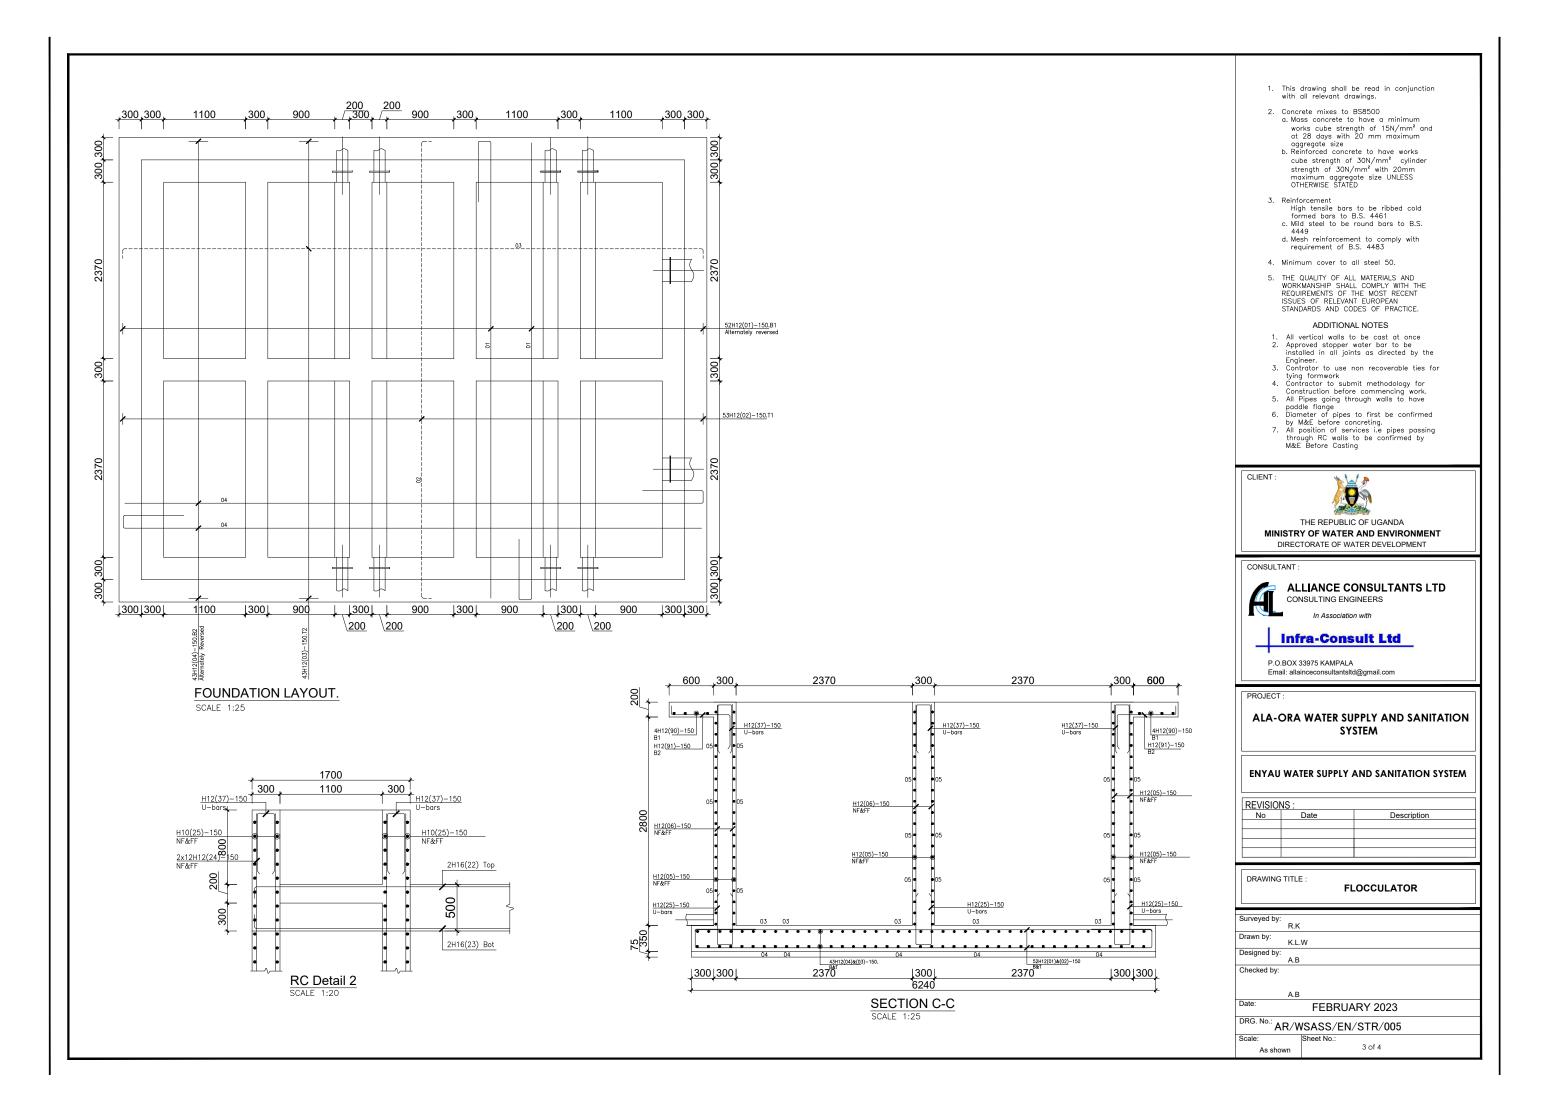

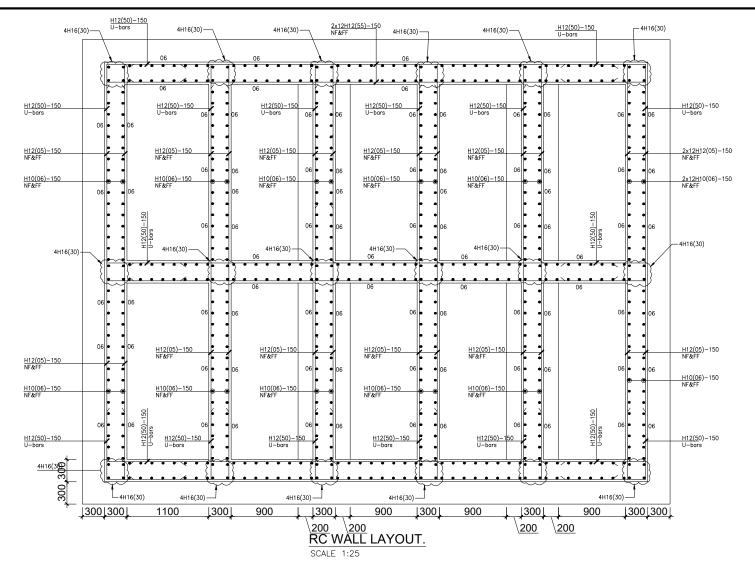

RC SECTION A-A SCALE 1:25

- This drawing shall be read in conjunction with all relevant drawings.
- 2. Concrete mixes to BS8500 Concrete mixes to BSB50U

 o. Mass concrete to have a minimum
 works cube strength of 15N/mm² and
 at 28 days with 20 mm maximum
 aggregate size

 b. Reinforced concrete to have works
 - cube strength of 30N/mm² cylinder strength of 30N/mm² with 20mm maximum aggregate size UNLESS OTHERWISE STATED
- 3. Reinforcement
 High tensile bors to be ribbed cold
 formed bors to B.S. 4461
 c. Mild steel to be round bors to B.S.
- d. Mesh reinforcement to comply with requirement of B.S. 4483
- 4. Minimum cover to all steel 50.
- 5. THE QUALITY OF ALL MATERIALS AND WORKMANSHIP SHALL COMPLY WITH THE REQUIREMENTS OF THE MOST RECENT ISSUES OF RELEVANT EUROPEAN STANDARDS AND CODES OF PRACTICE.

ADDITIONAL NOTES

- ADDITIONAL NOTES

 1. All vertical walls to be cast at once
 2. Approved stopper water bar to be installed in all joints as directed by the Engineer.
 3. Contrator to use non recoverable ties for tying formwork
 4. Contractor to submit methodology for Construction before commencing work.
 5. All Pipes going through walls to have paddle flange
 6. Diameter of pipes to first be confirmed by M&E before concreting.
 7. All position of services i.e pipes passing through RC walls to be confirmed by M&E Before Casting

CLIENT



THE REPUBLIC OF UGANDA MINISTRY OF WATER AND ENVIRONMENT DIRECTORATE OF WATER DEVELOPMENT



ALLIANCE CONSULTANTS LTD

CONSULTING ENGINEERS

Infra-Consult Ltd

P.O.BOX 33975 KAMPALA Email: allainceconsultantsltd@gmail.com

PROJECT

ALA-ORA WATER SUPPLY AND SANITATION SYSTEM

ENYAU WATER SUPPLY AND SANITATION SYSTEM

REVISIONS:		
No	Date	Description
		·

DRAWING TITLE :


FLOCCULATOR


Drawn by: K.L.W Designed by: Checked by:


FEBRUARY 2023


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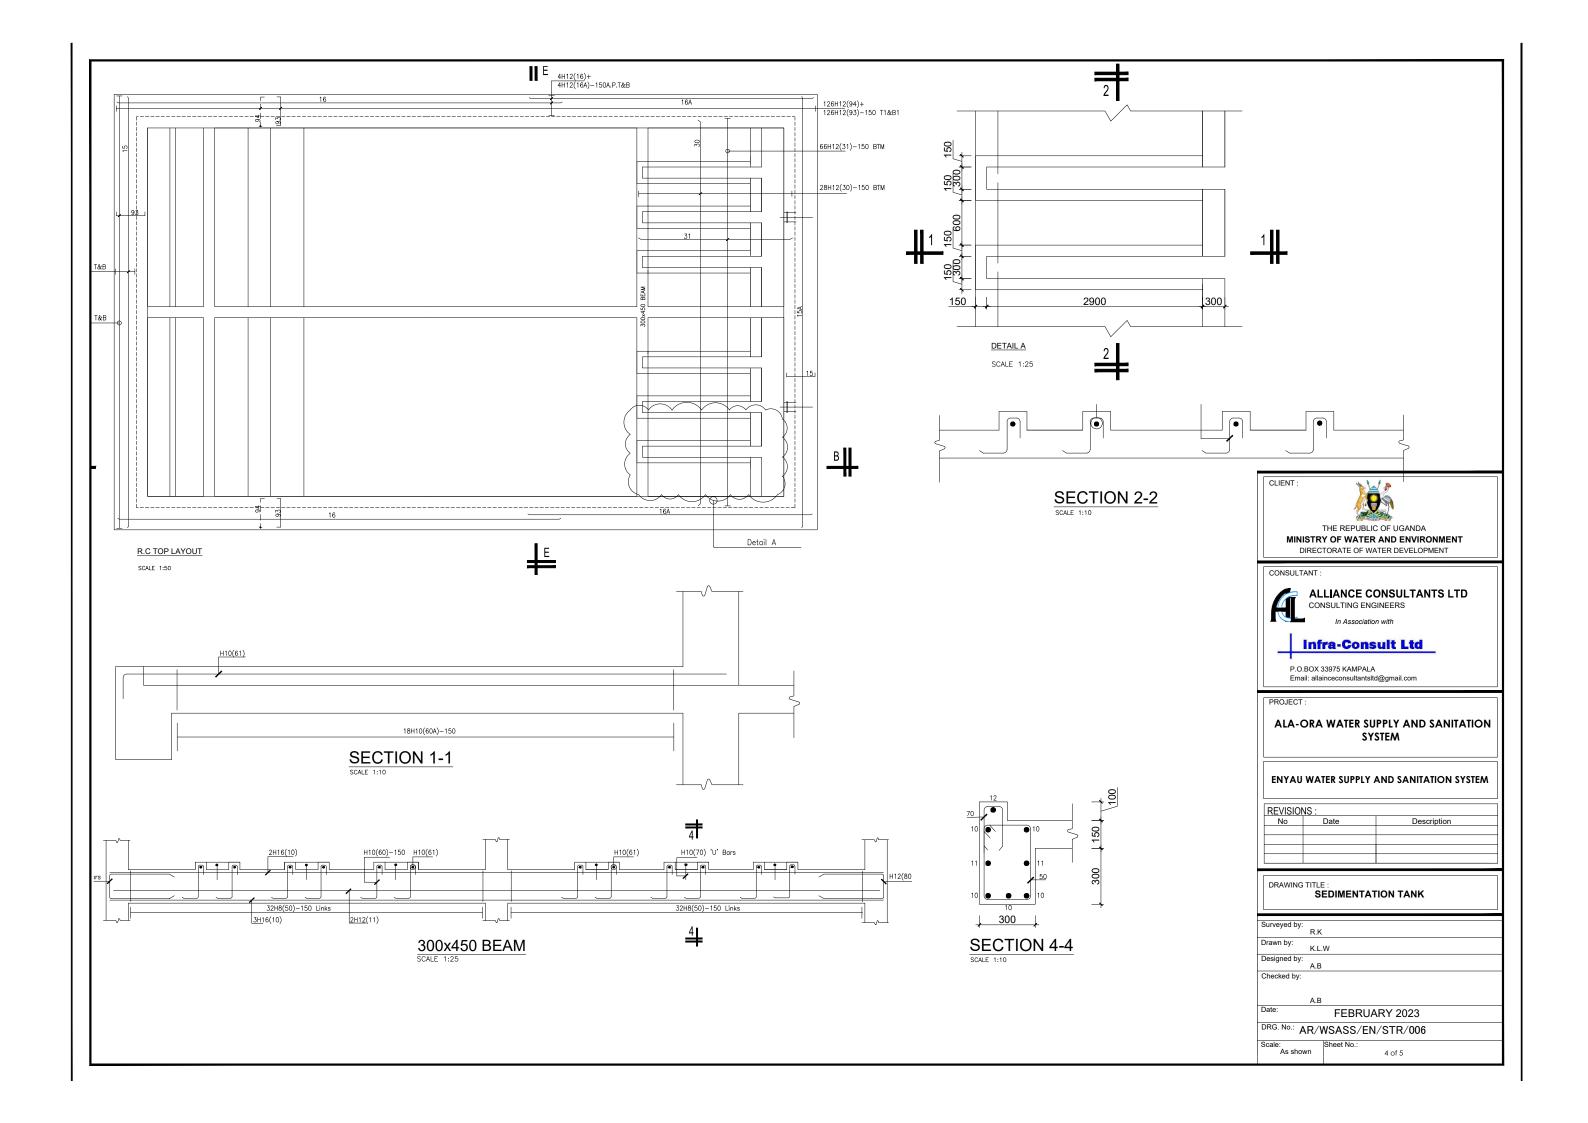
As shown




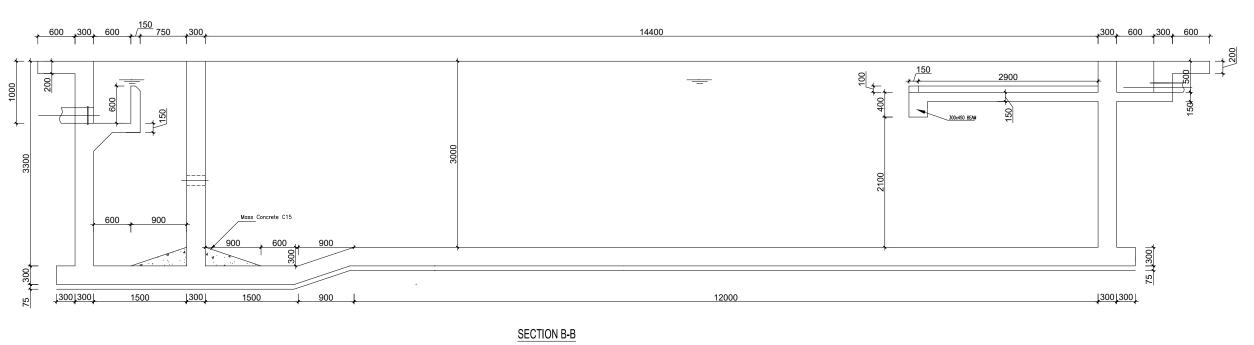


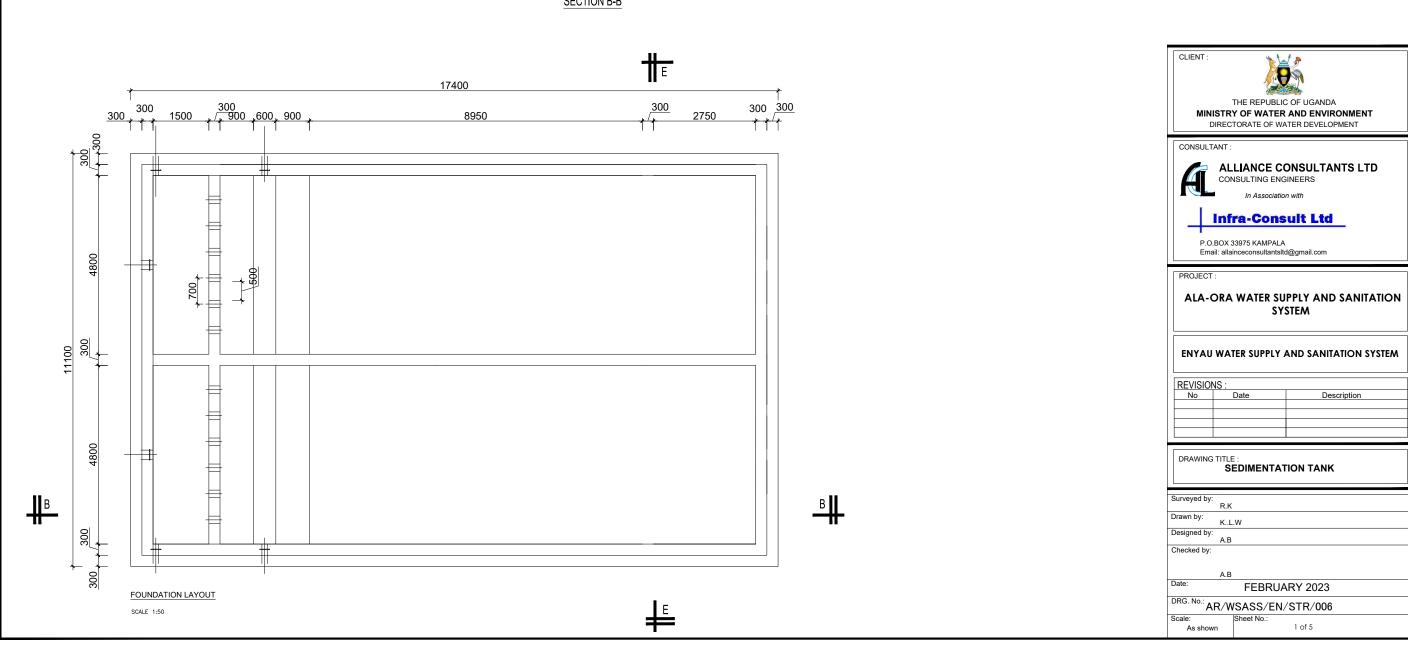

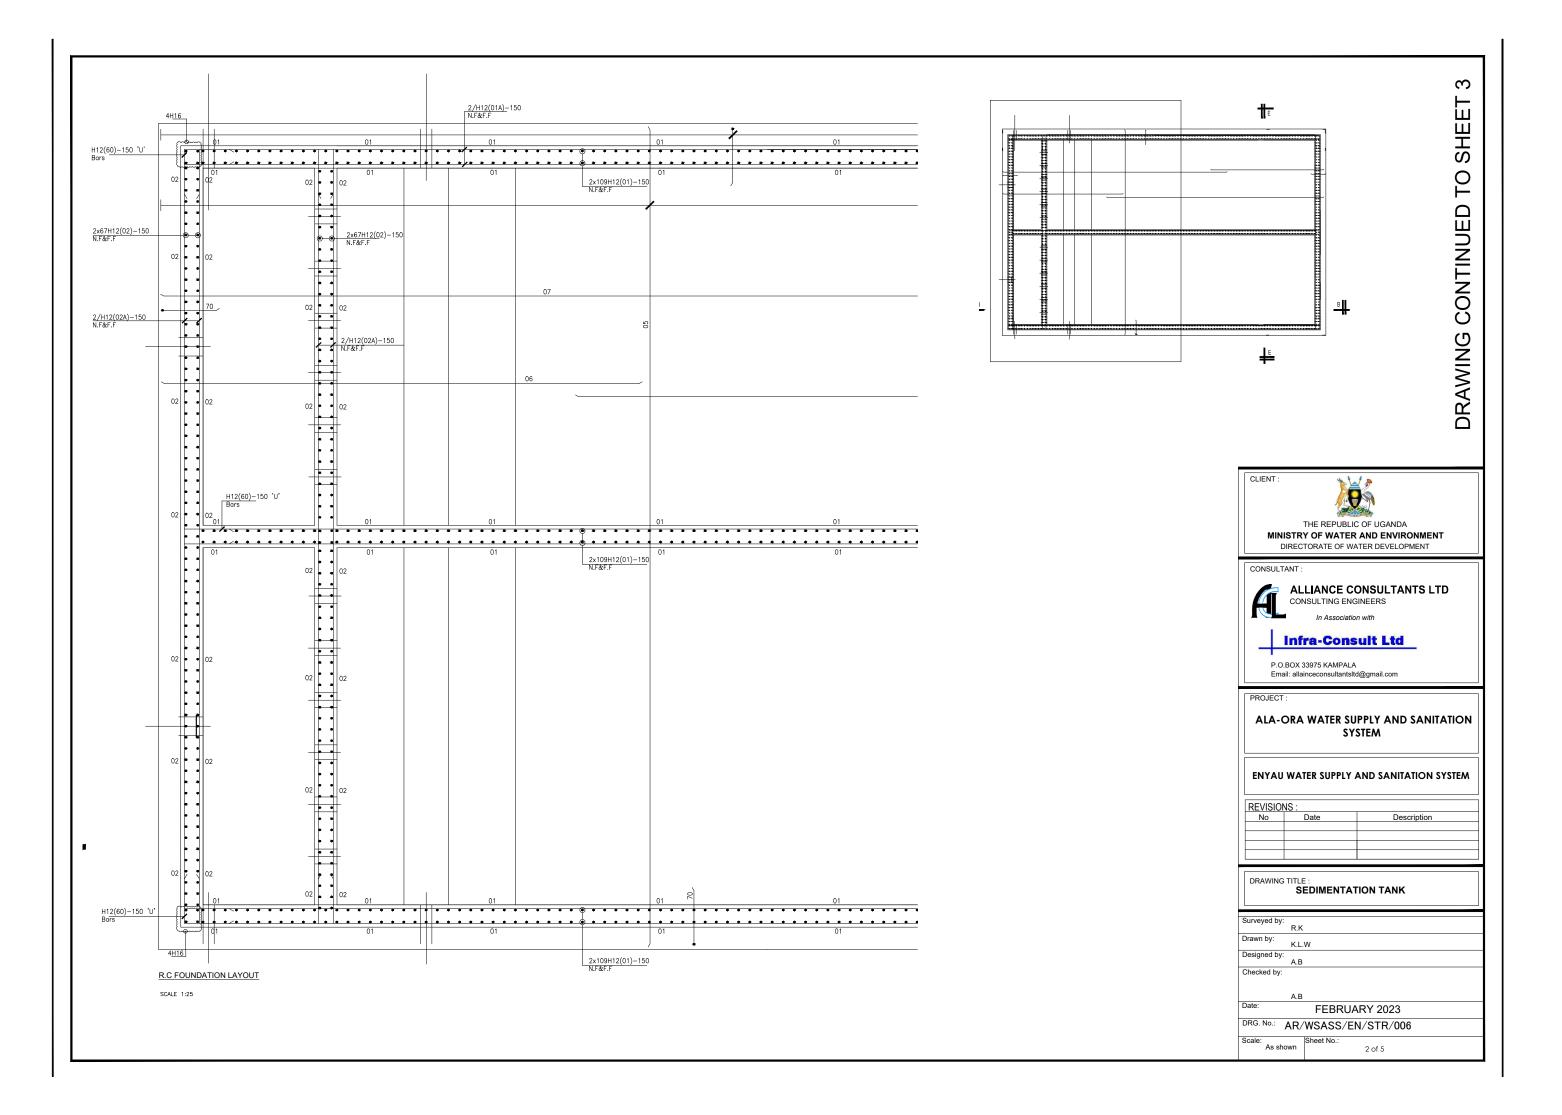

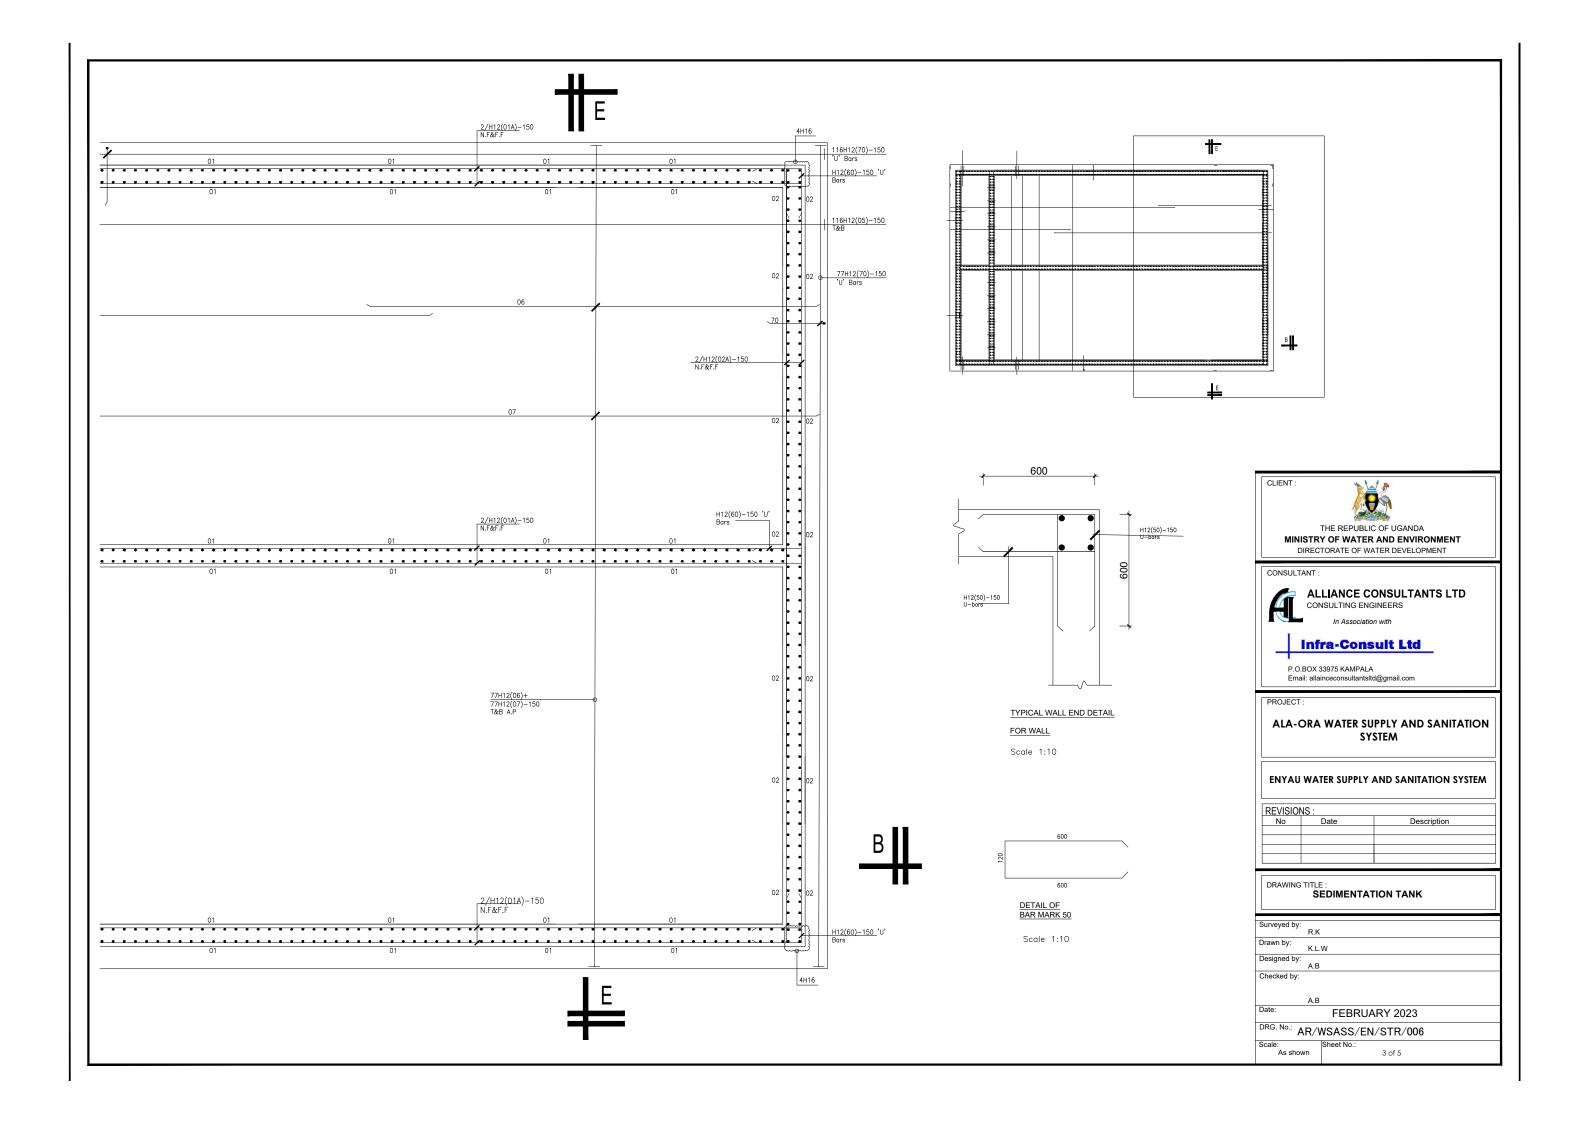

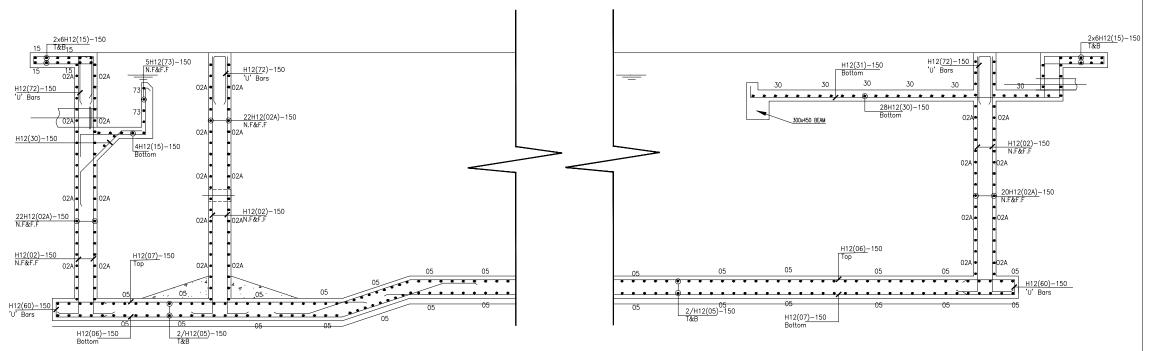

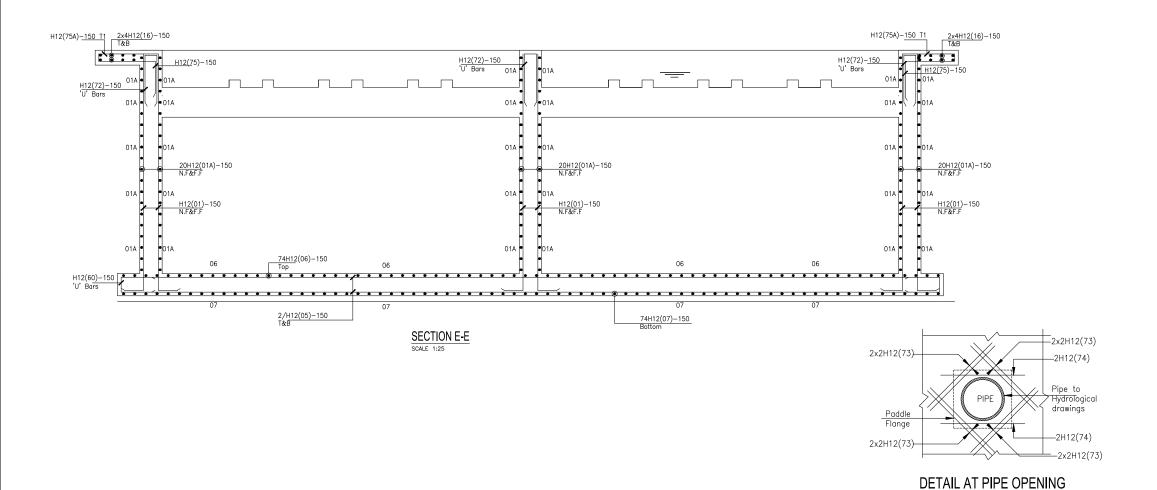

SECTION B-B

- This drawing shall be read in conjunction with all relevant drawings.
- 2. Concrete mixes to BS8500 Concrete mixes to BSB50U

 o. Mass concrete to have a minimum
 works cube strength of 15N/mm² and
 at 28 days with 20 mm maximum
 aggregate size

 b. Reinforced concrete to have works
 - cube strength of 30N/mm² cylinder strength of 30N/mm² with 20mm maximum aggregate size UNLESS OTHERWISE STATED

- 3. Reinforcement
 High tensile bors to be ribbed cold
 formed bors to B.S. 4461
 c. Mild steel to be round bors to B.S.
- d. Mesh reinforcement to comply with requirement of B.S. 4483
- 4. Minimum cover to all steel 50.
- 5. THE QUALITY OF ALL MATERIALS AND WORKMANSHIP SHALL COMPLY WITH THE REQUIREMENTS OF THE MOST RECENT ISSUES OF RELEVANT EUROPEAN STANDARDS AND CODES OF PRACTICE.

ADDITIONAL NOTES

- ADDITIONAL NOTES

 1. All vertical walls to be cast at once
 2. Approved stopper water bar to be installed in all joints as directed by the Engineer.
 3. Contrator to use non recoverable ties for tying formwork
 4. Contractor to submit methodology for Construction before commencing work.
 5. All Pipes going through walls to have paddle flange
 6. Diameter of pipes to first be confirmed by M&E before concreting.
 7. All position of services i.e pipes passing through RC walls to be confirmed by M&E Before Casting

CLIENT



THE REPUBLIC OF UGANDA MINISTRY OF WATER AND ENVIRONMENT DIRECTORATE OF WATER DEVELOPMENT



ALLIANCE CONSULTANTS LTD

CONSULTING ENGINEERS

Infra-Consult Ltd

P.O.BOX 33975 KAMPALA Email: allainceconsultantsltd@gmail.com

PROJECT

ALA-ORA WATER SUPPLY AND SANITATION SYSTEM

ENYAU WATER SUPPLY AND SANITATION SYSTEM

REVISIO	REVISIONS:	
No	Date	Description


DRAWING TITLE


SEDIMENTATION TANK

Drawn by: K.L.W Designed by: Checked by: FEBRUARY 2023

DRG. No.: AR/WSASS/EN/STR/006

SCALE 1:20

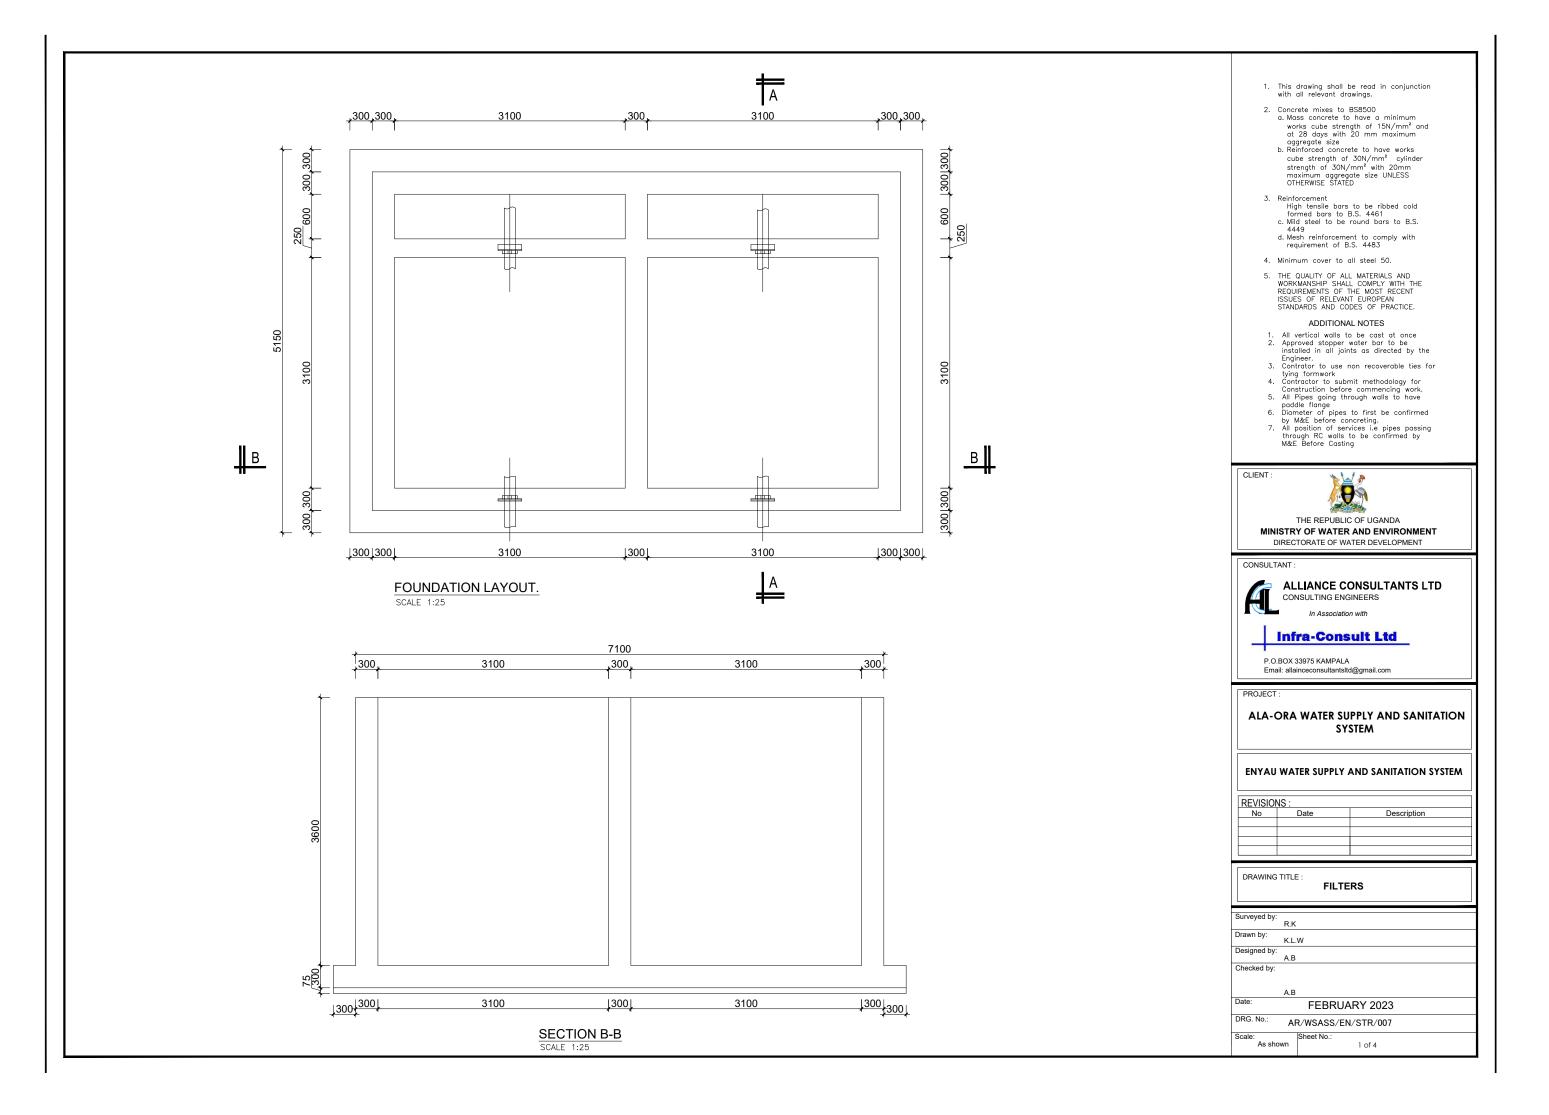

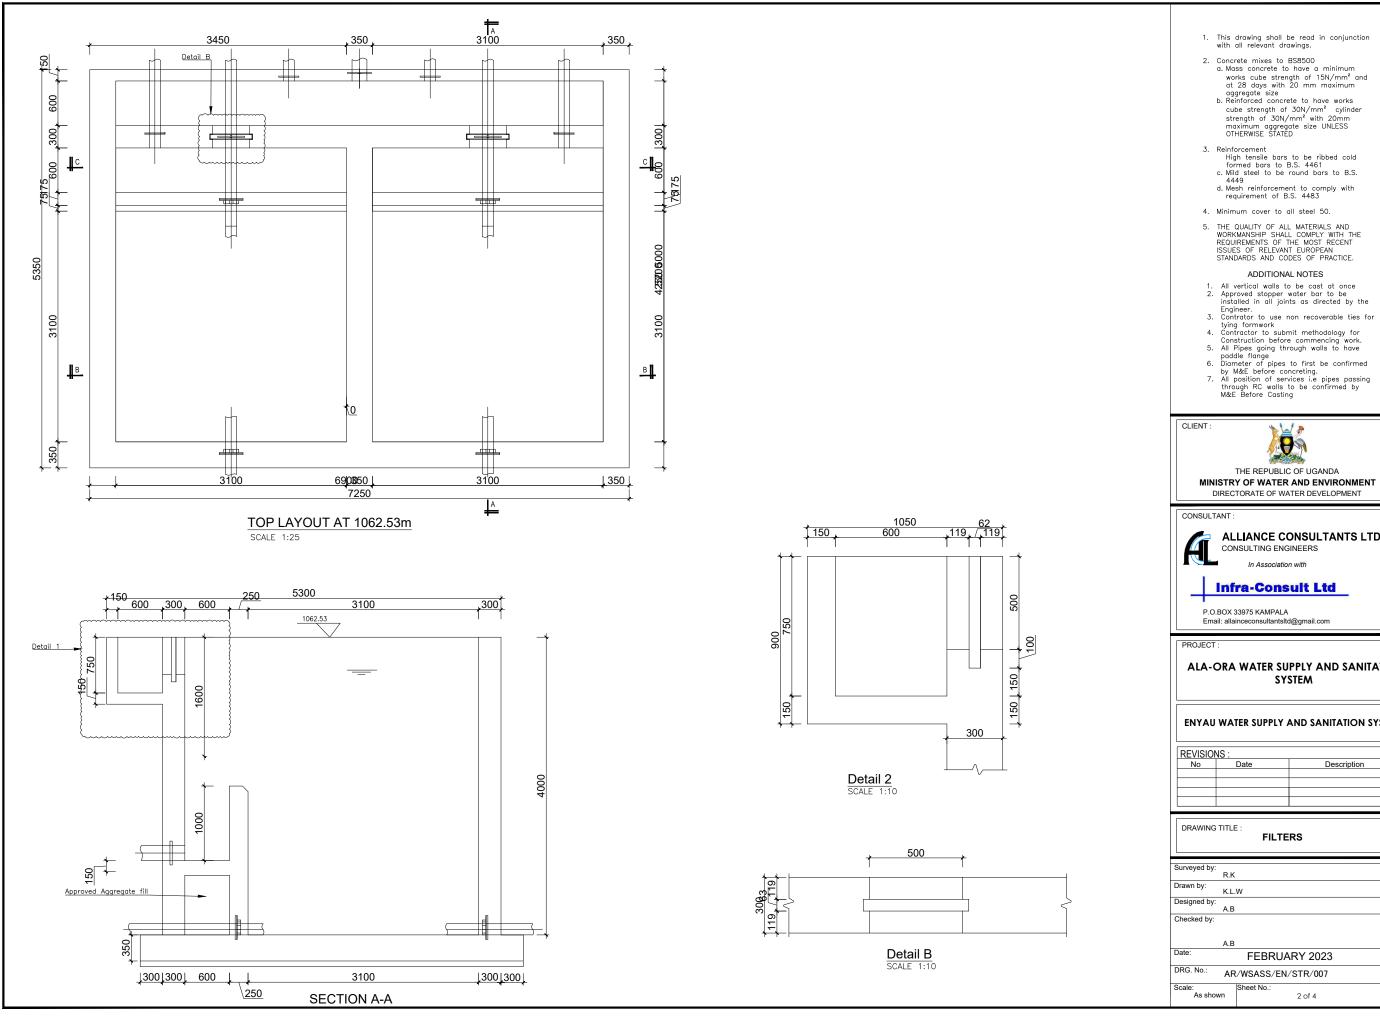

This drawing shall be read in conjunction with all relevant drawings.

Concrete mixes to BSB500
 a. Mass concrete to have a minimum works cube strength of 15N/mm² and at 28 days with 20 mm maximum aggregate size
 b. Reinforced concrete to have works cube strength of 30N/mm² cylinder strength of 30N/mm² with 20mm maximum aggregate size UNLESS OTHERWISE STATED

Reinforcement
 High tensile bars to be ribbed cold formed bars to B.S. 4461
 c. Mild steel to be round bars to B.S. 4448

4449

d. Mesh reinforcement to comply with requirement of B.S. 4483

4. Minimum cover to all steel 50.

5. THE QUALITY OF ALL MATERIALS AND WORKMANSHIP SHALL COMPLY WITH THE REQUIREMENTS OF THE MOST RECENT ISSUES OF RELEVANT EUROPEAN STANDARDS AND CODES OF PRACTICE.

ADDITIONAL NOTES



THE REPUBLIC OF UGANDA MINISTRY OF WATER AND ENVIRONMENT DIRECTORATE OF WATER DEVELOPMENT

ALLIANCE CONSULTANTS LTD

CONSULTING ENGINEERS

Infra-Consult Ltd

P.O.BOX 33975 KAMPALA Email: allainceconsultantsltd@gmail.com

ALA-ORA WATER SUPPLY AND SANITATION SYSTEM


ENYAU WATER SUPPLY AND SANITATION SYSTEM


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No	Date	Description


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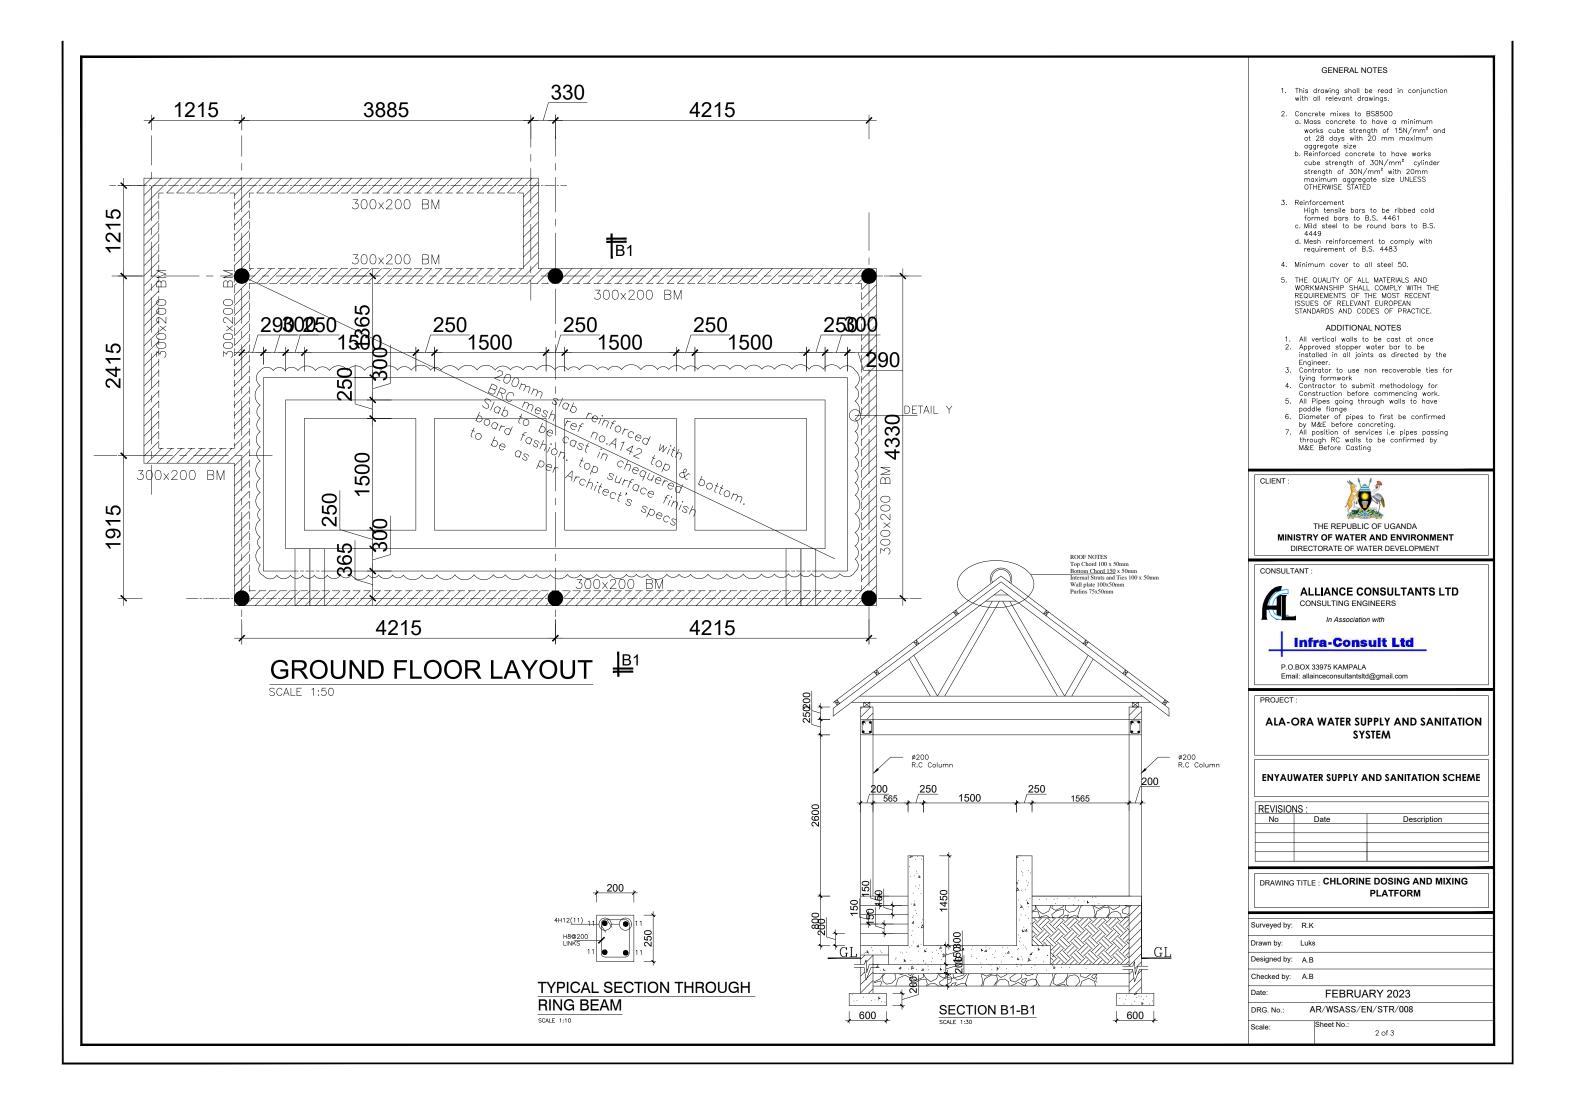
Surveyed by:		
	R.K	
Drawn by:		
	K.L.W	
Designed by:		
,	A.B	
Checked by:		

FEBRUARY 2023 AR/WSASS/EN/STR/007




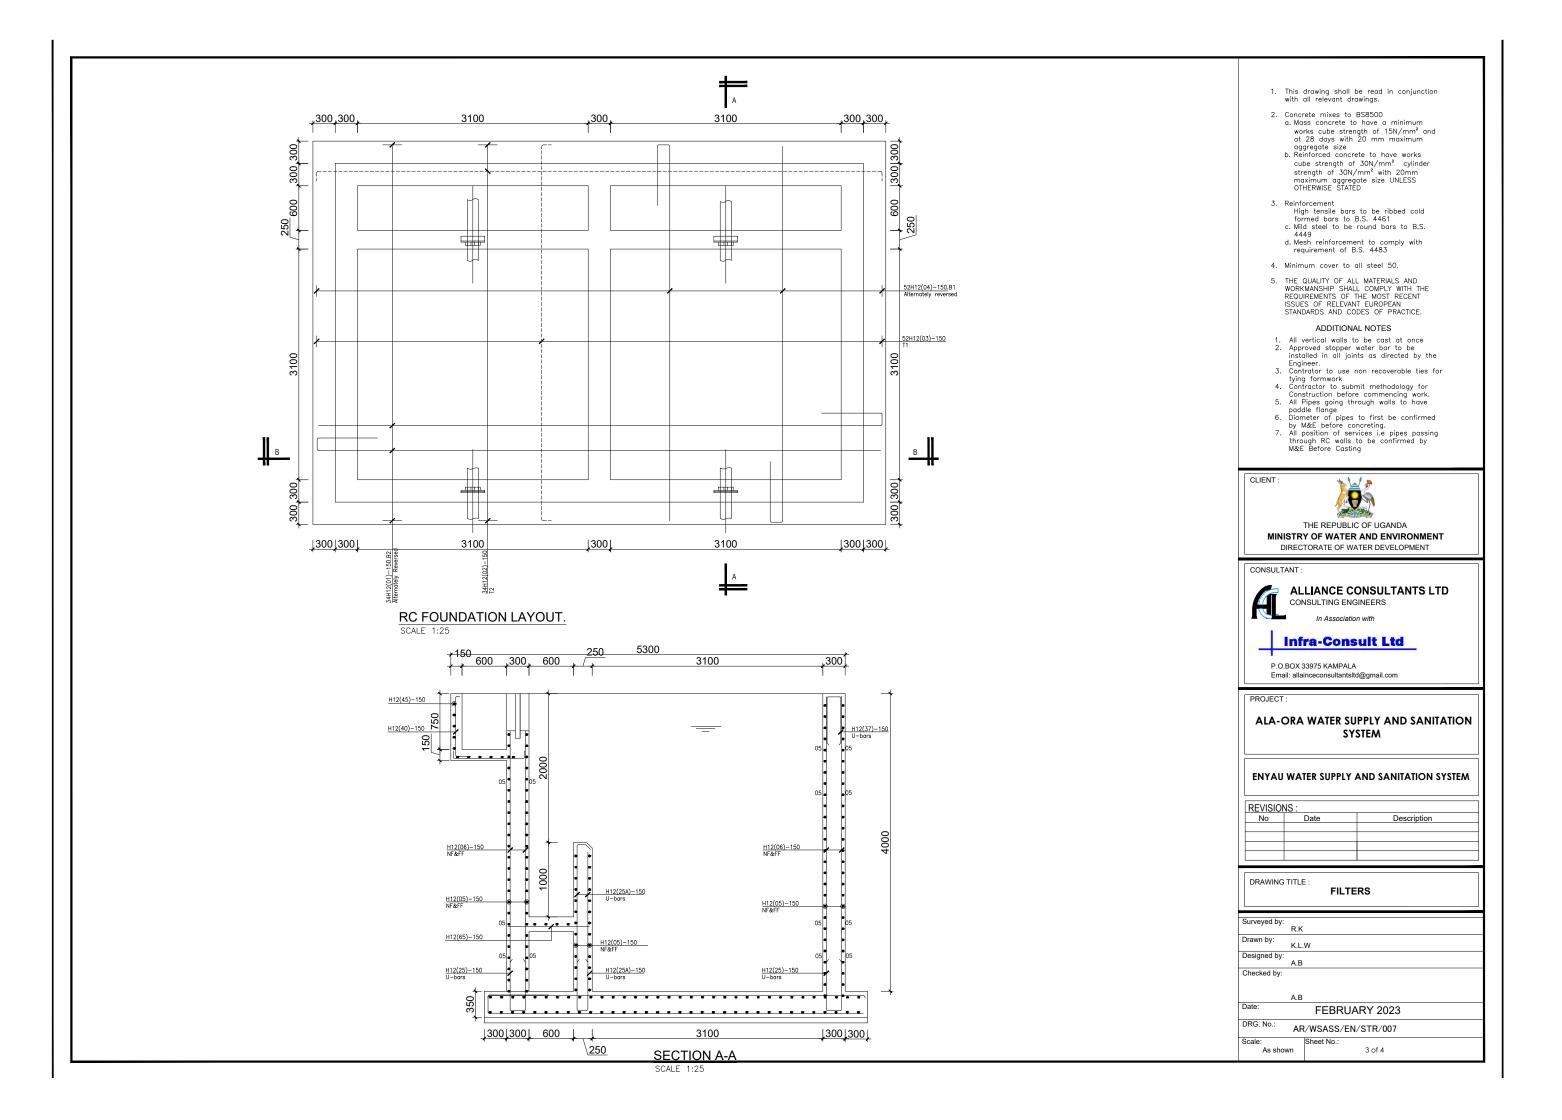


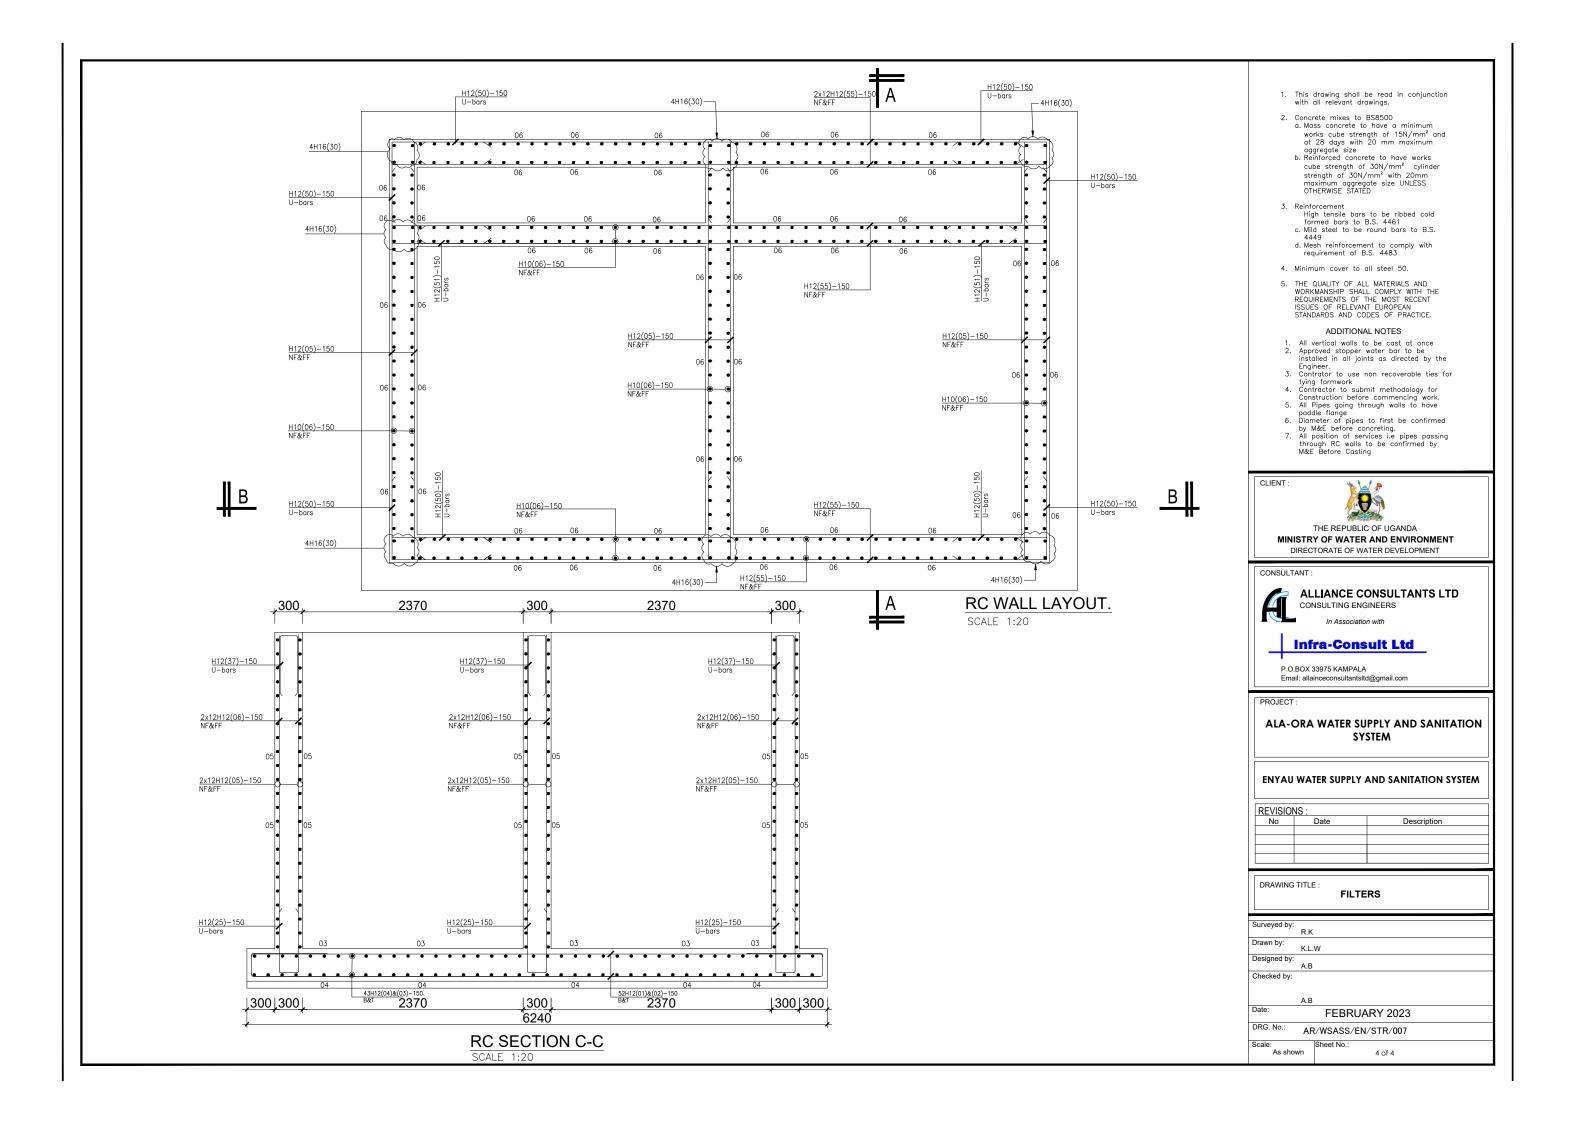

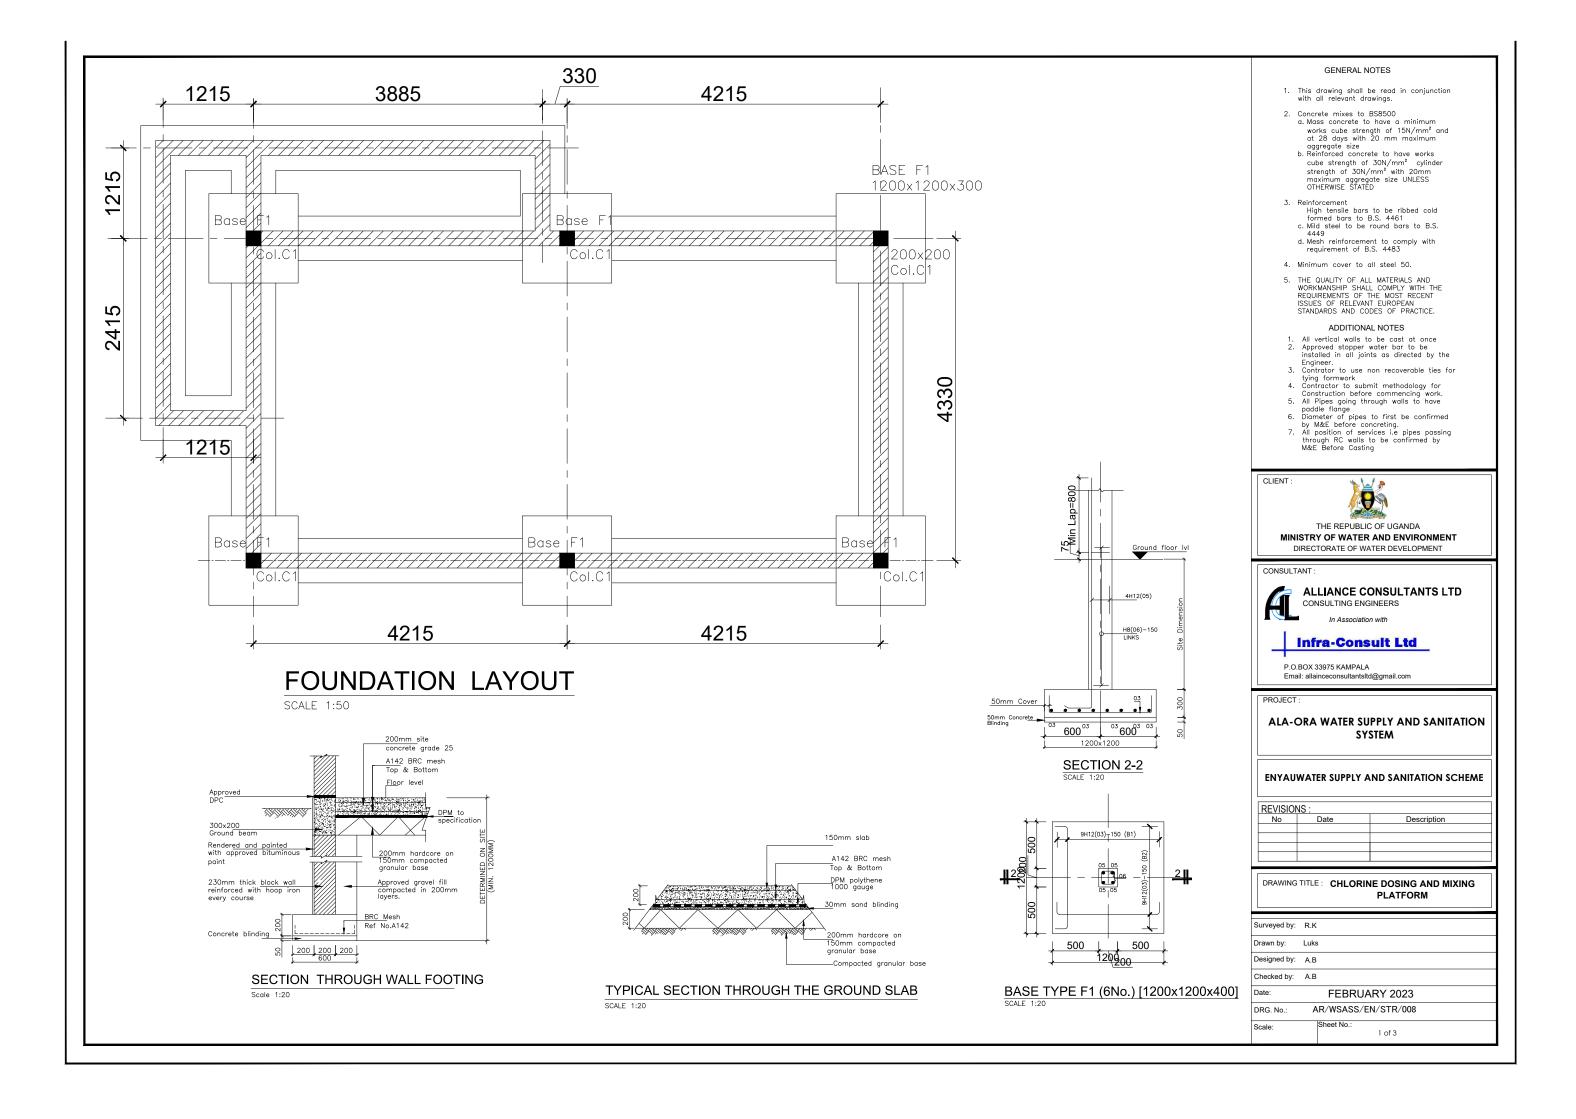

4H12 2/H12(03)-150 N.F&F.F 2/H10(04)-200 N.F&F.F 03 03 03 03 03 03 03 03 50 05 Reinforcement repeat Reinforcement repeat A H12(01)-150 T&B 2/H12(05)-150 N.F&F.F 03 03 03 03 03 03 03 4H12 **DETAIL Y** SCALE 1:20

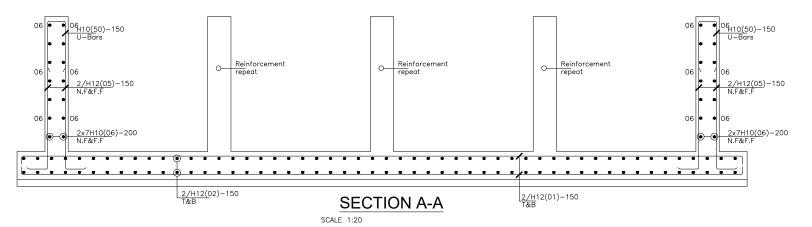

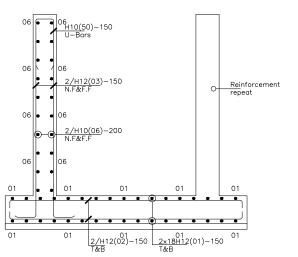

SECTION B-B

GENERAL NOTES

- This drawing shall be read in conjunction with all relevant drawings.
- Concrete mixes to BS8500
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 - at 28 days with 20 mm maximum aggregate size
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 c. Mild steel to be round bars to B.S.
 4449
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 requirement of B.S. 4483
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 7. All position of services i.e pipes passing through RC walls to be confirmed by M&E Before Casting

CLIENT



THE REPUBLIC OF UGANDA MINISTRY OF WATER AND ENVIRONMENT DIRECTORATE OF WATER DEVELOPMENT



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CONSULTING ENGINEERS

Infra-Consult Ltd

P.O.BOX 33975 KAMPALA Email: allainceconsultantsltd@gmail.com

PROJECT


ALA-ORA WATER SUPPLY AND SANITATION SYSTEM


ENYAUWATER SUPPLY AND SANITATION SCHEME


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No	Date	Description

DRAWING TITLE: CHLORINE DOSING AND MIXING PLATFORM


Surveyed by: R.K Drawn by: Luks Designed by: A.B Checked by: A.B FEBRUARY 2023 AR/WSASS/EN/STR/008 DRG. No.: 3 of 3

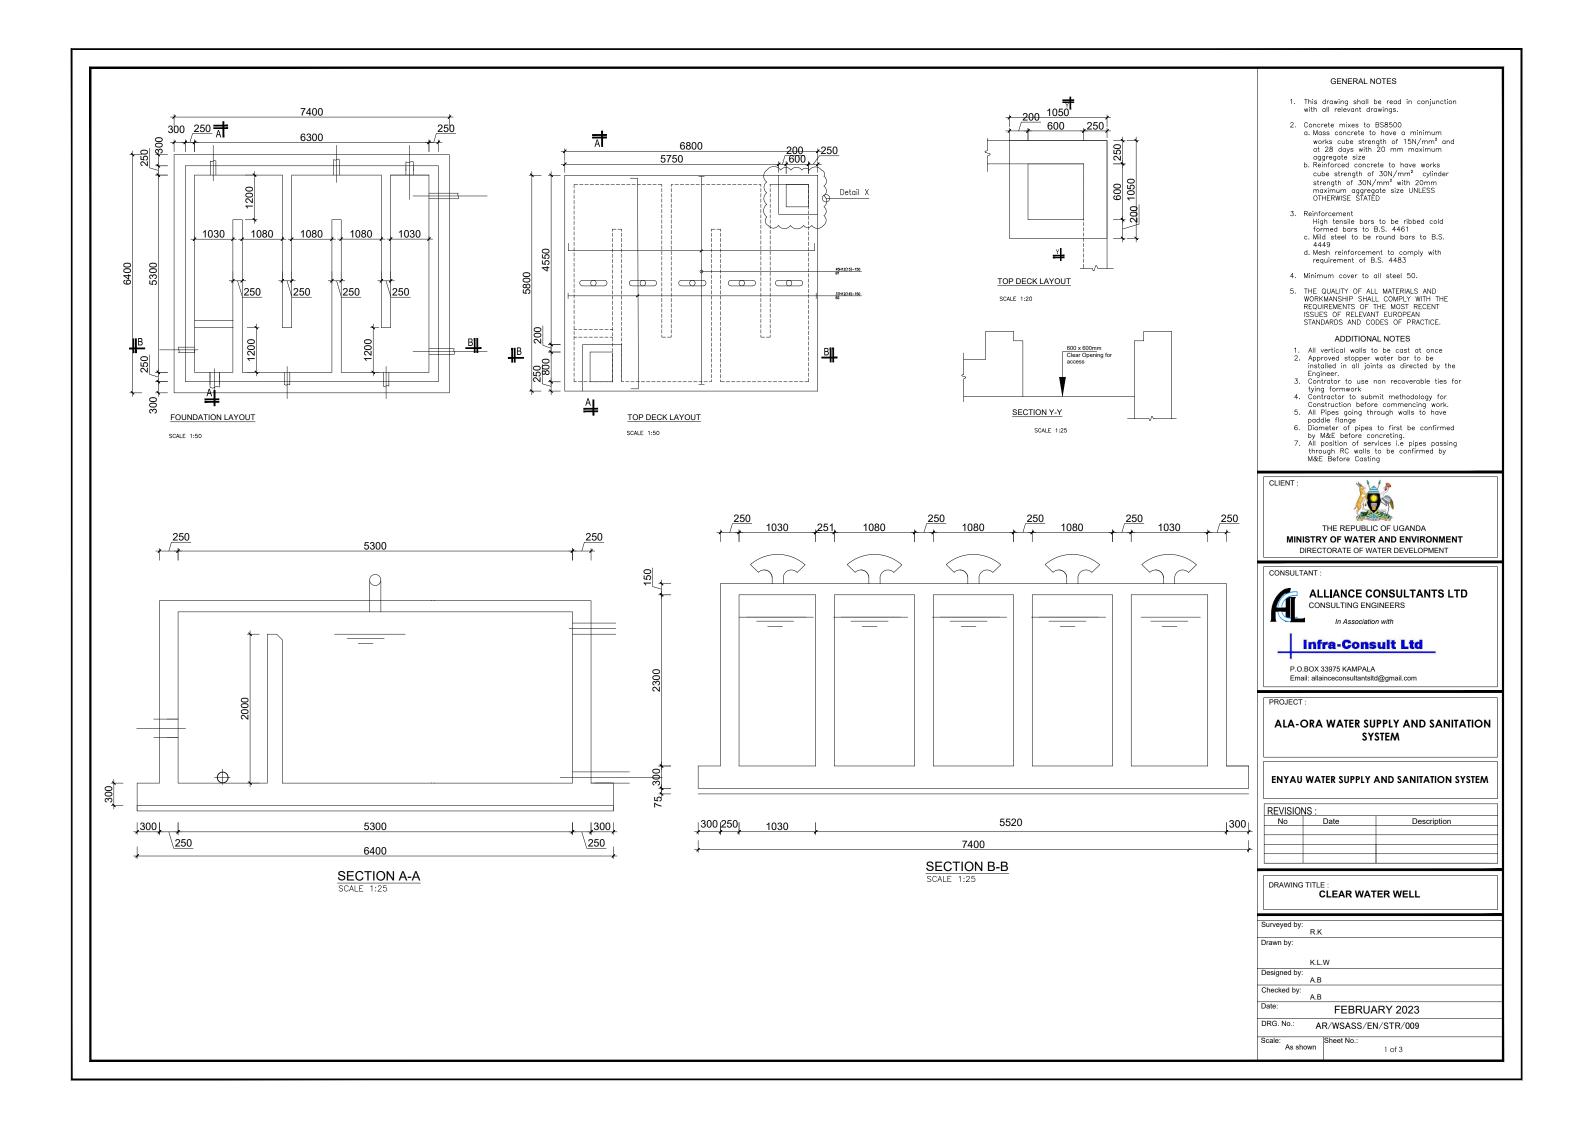

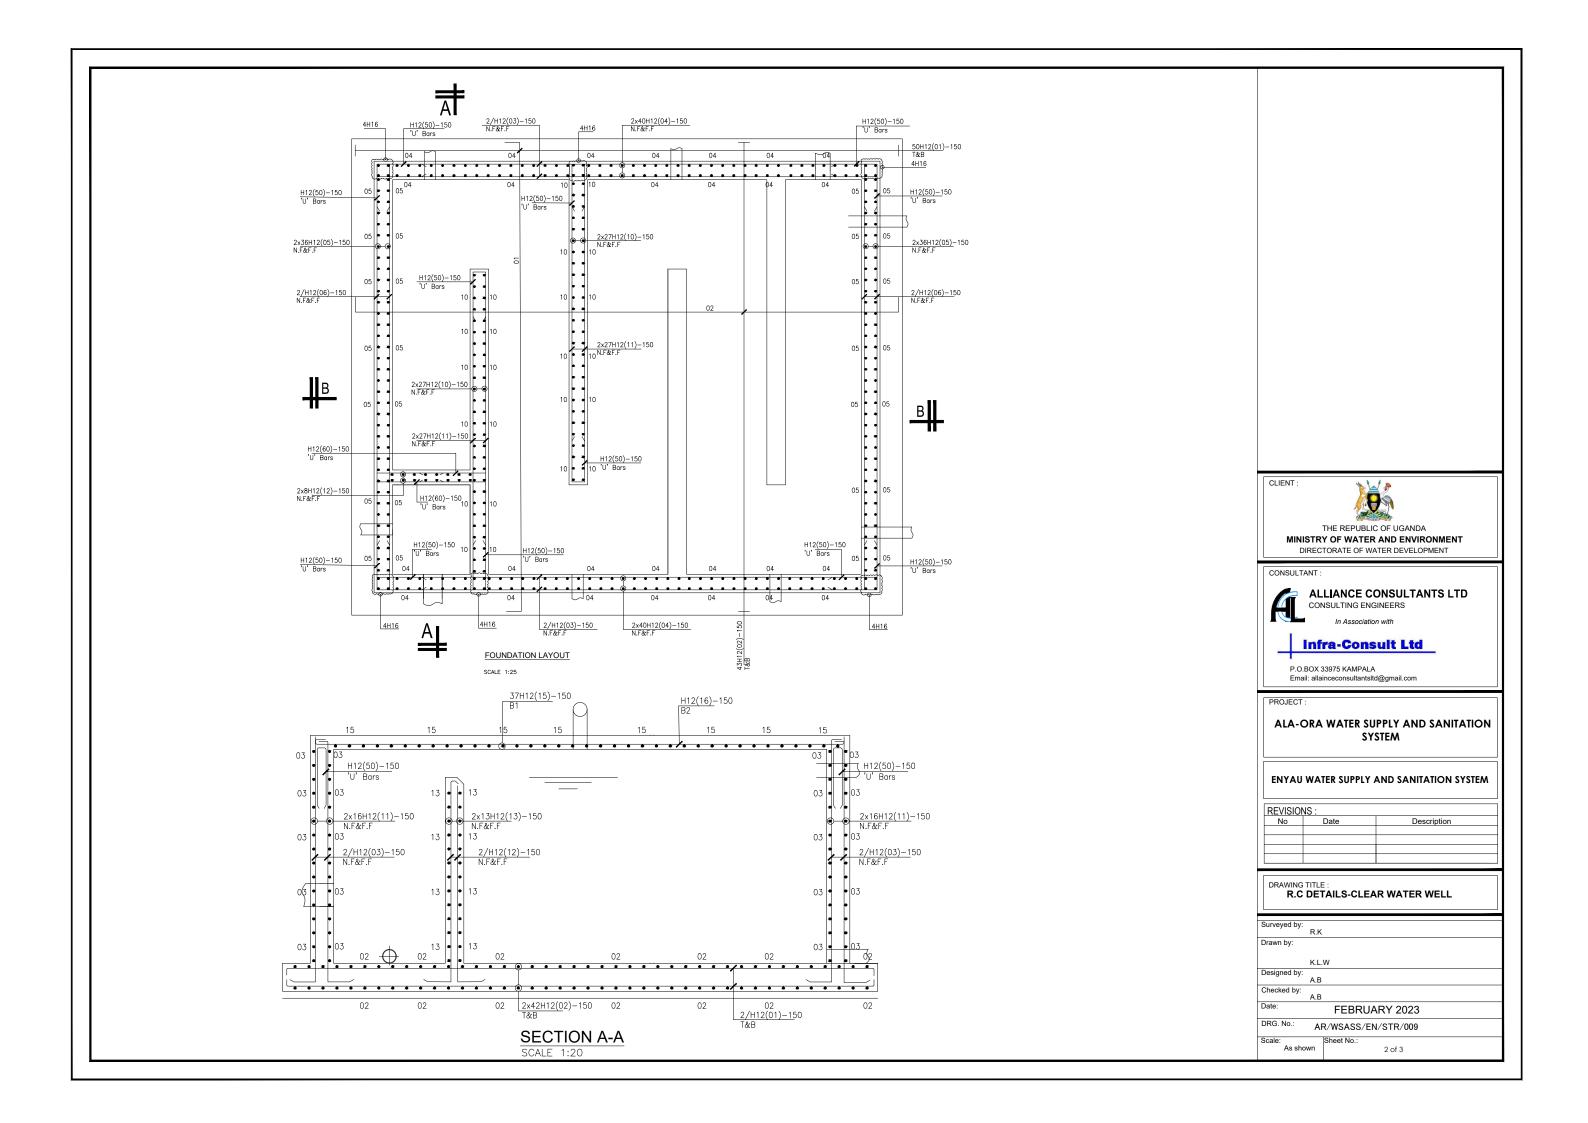

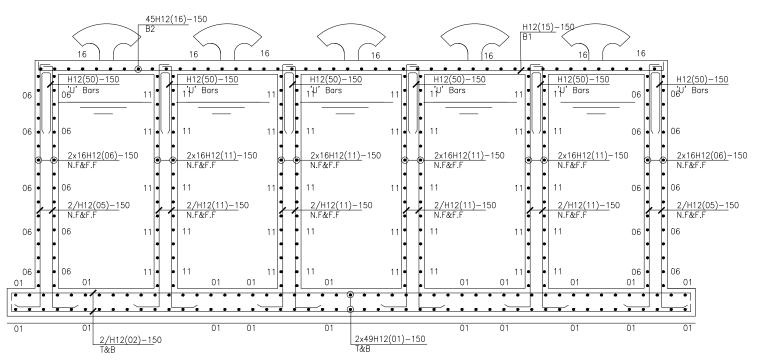

SECTION B-B SCALE 1:20

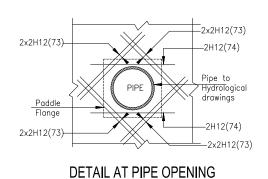

SCALE 1:20

TYPICAL WALL END DETAIL
FOR WALL

H12(50)-<u>150</u> U-bars

Scale 1:20

600

600

†H12(50)-150

DETAIL OF BAR MARK 50

Scale 1:20

CLIENT:



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MINISTRY OF WATER AND ENVIRONMENT

DIRECTORATE OF WATER DEVELOPMENT

CONSULTANT :



ALLIANCE CONSULTANTS LTD

CONSULTING ENGINEERS

In Association wit



P.O.BOX 33975 KAMPALA Email: allainceconsultantsltd@gmail.com


PROJECT :


ALA-ORA WATER SUPPLY AND SANITATION SYSTEM


ENYAU WATER SUPPLY AND SANITATION SYSTEM


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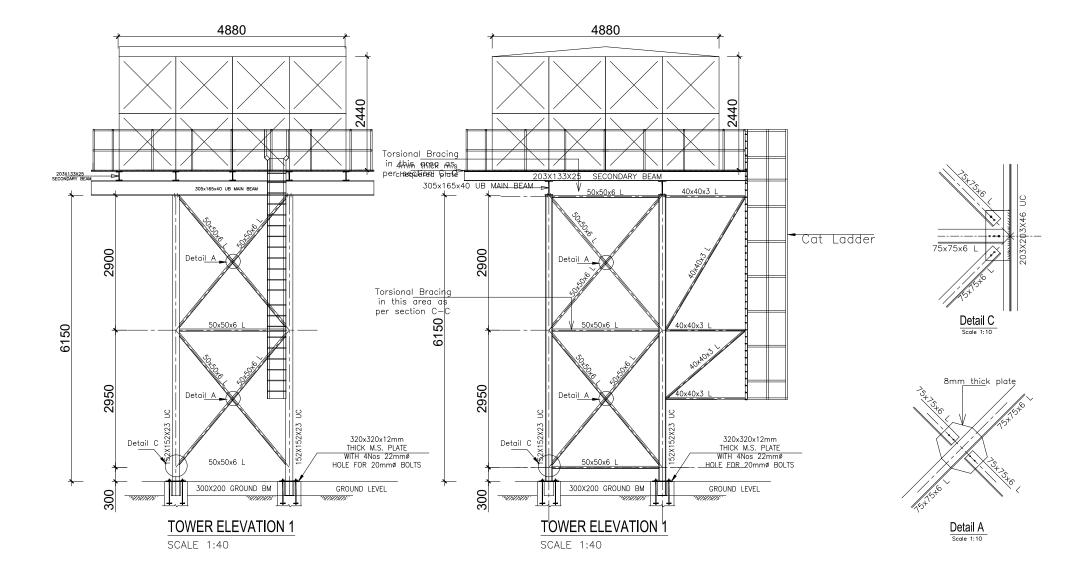
R.C DETAILS-CLEAR WATER WELL



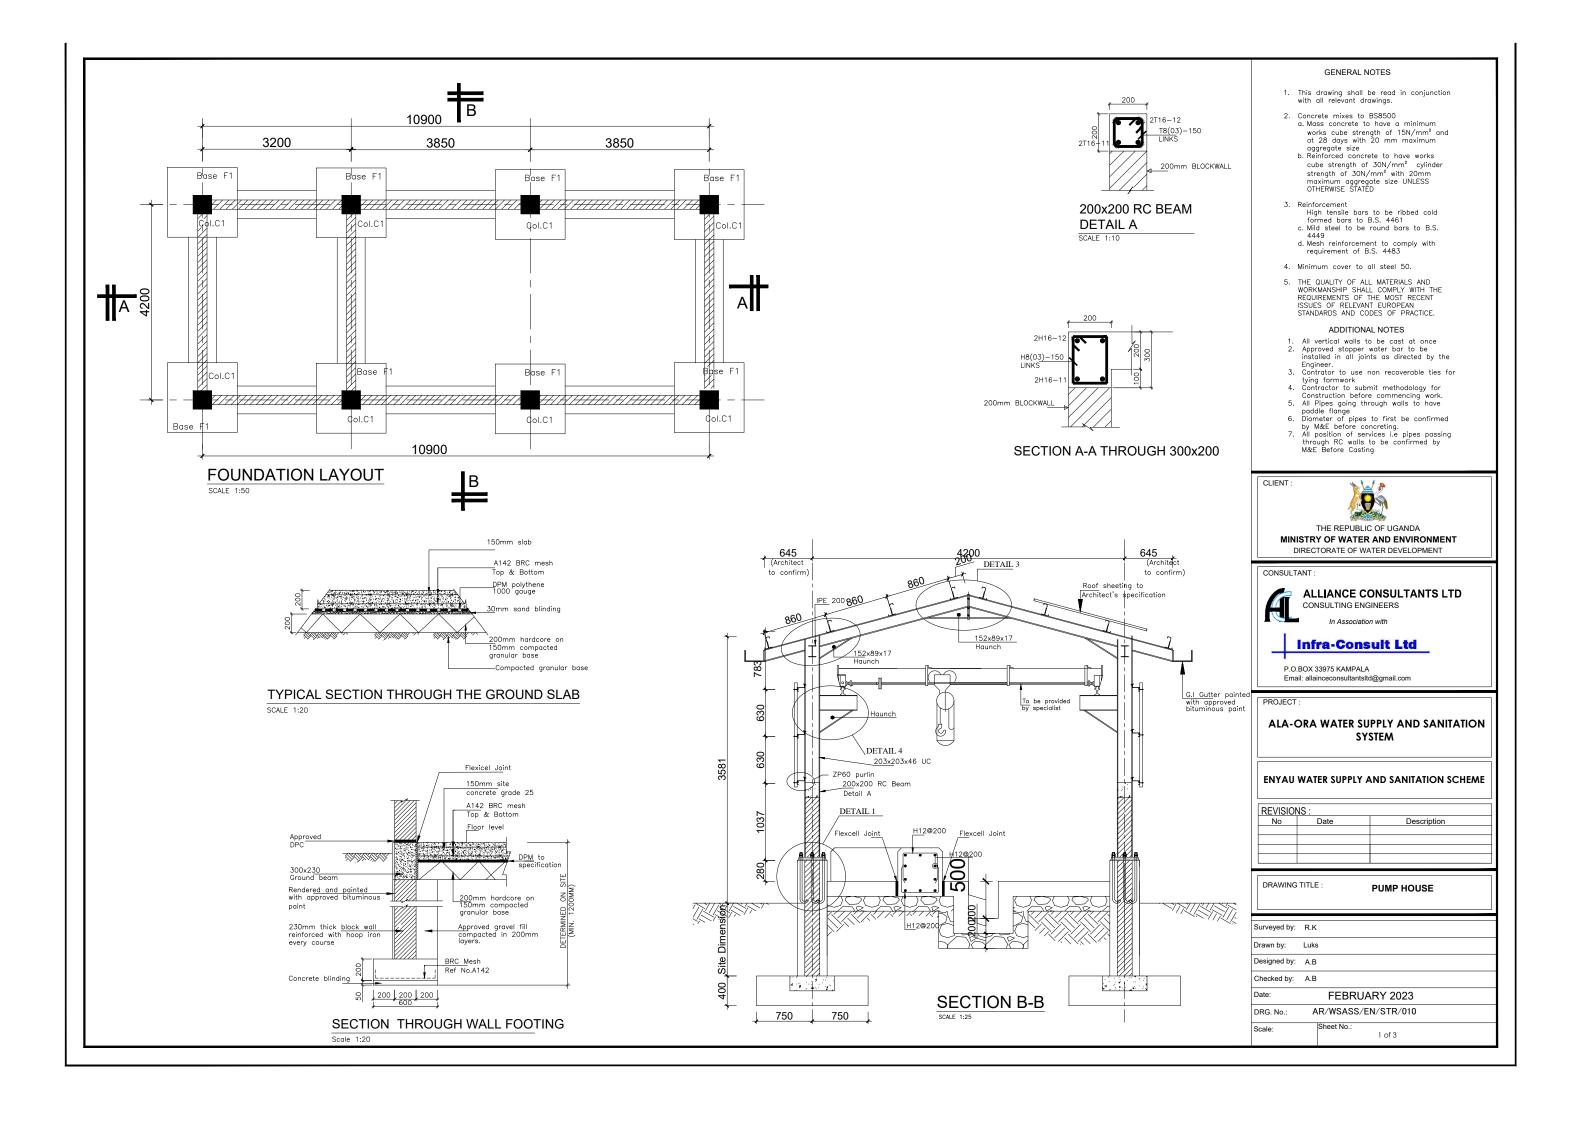

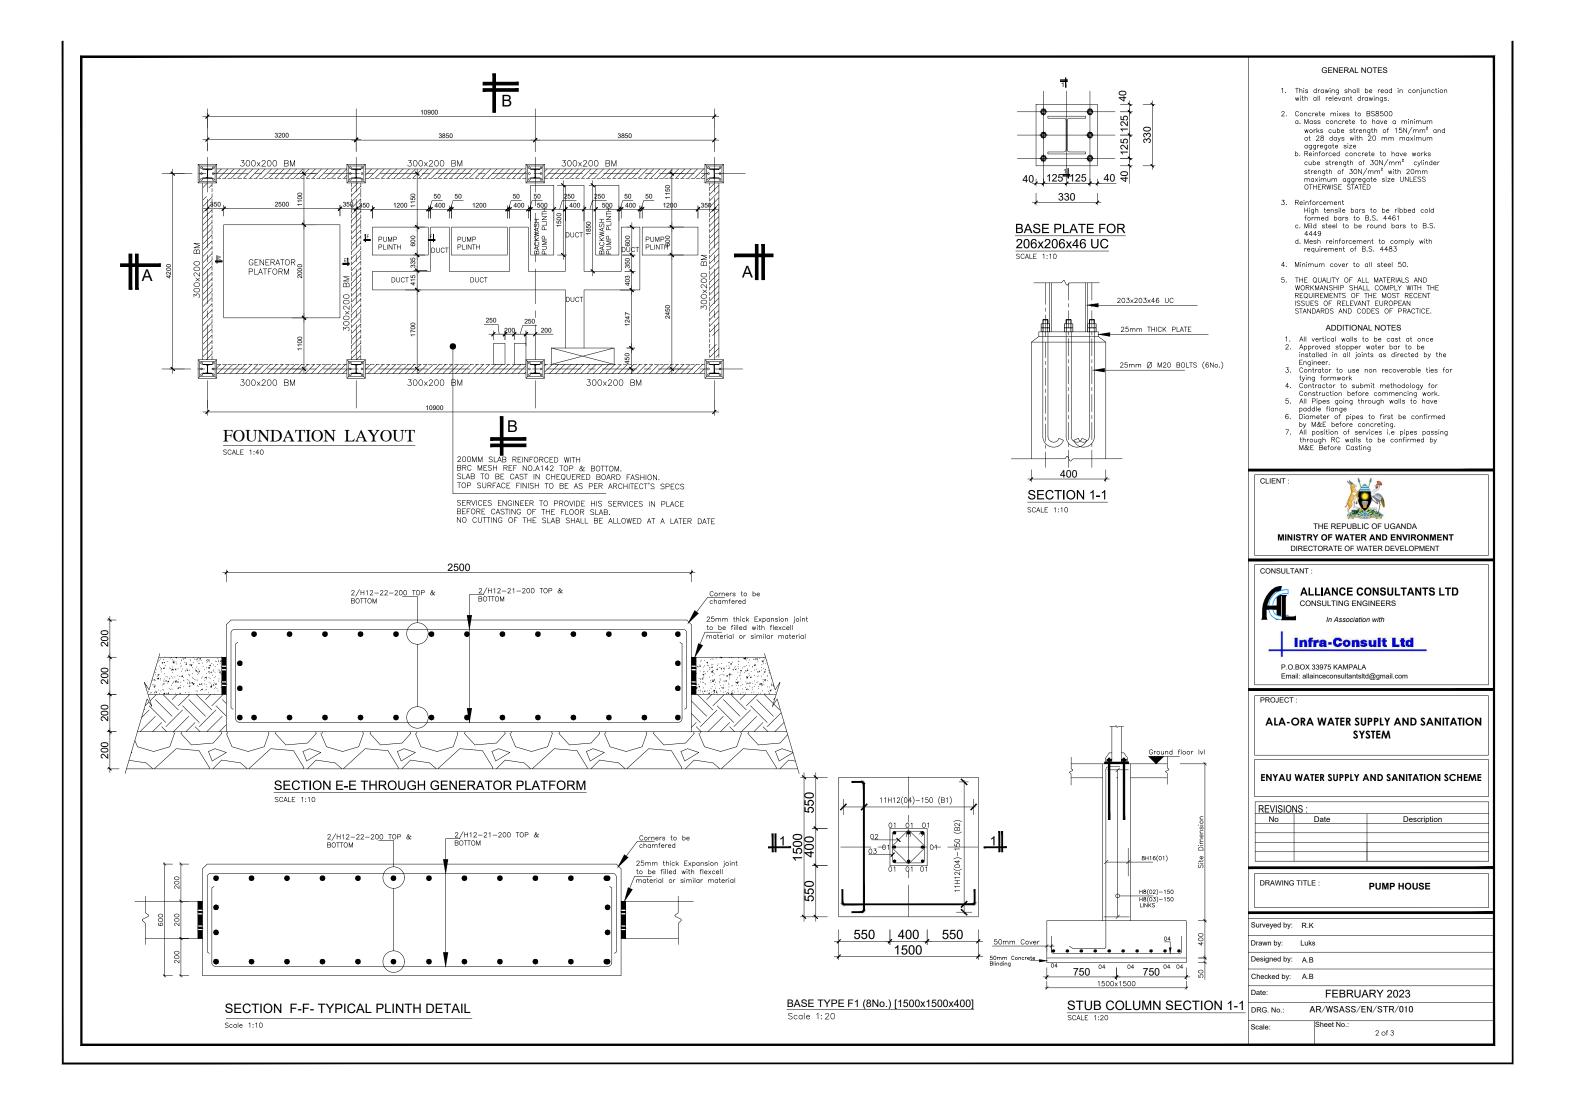

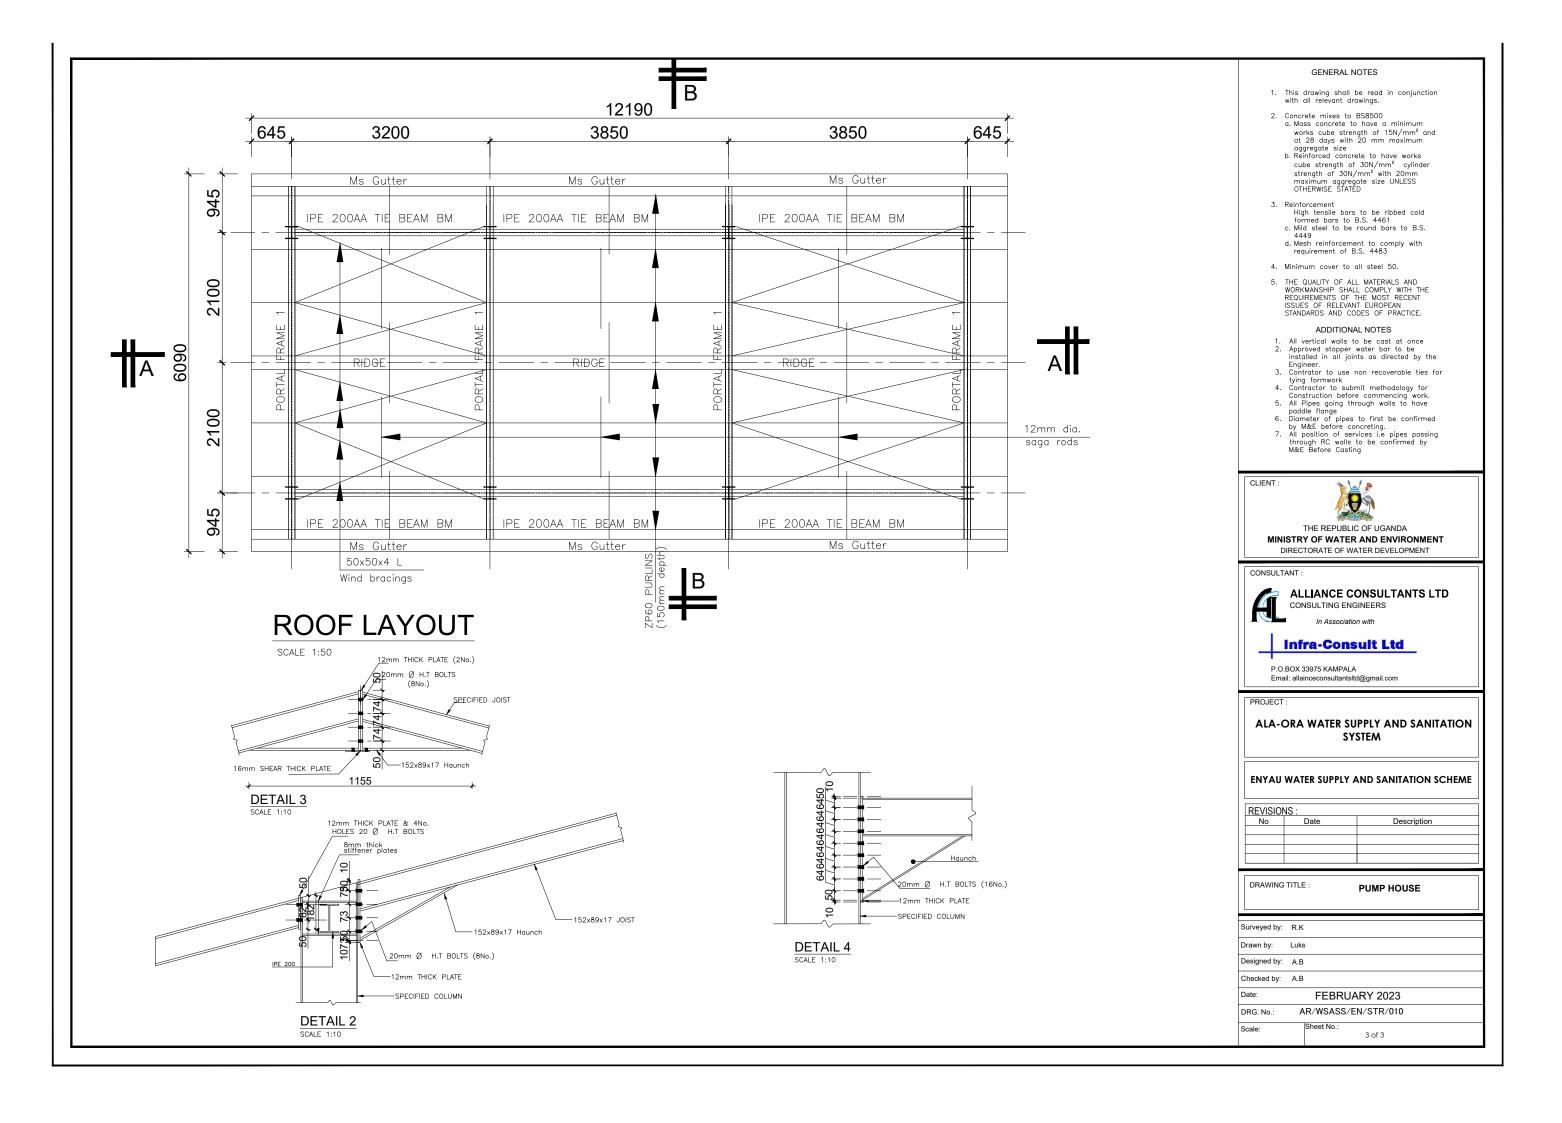

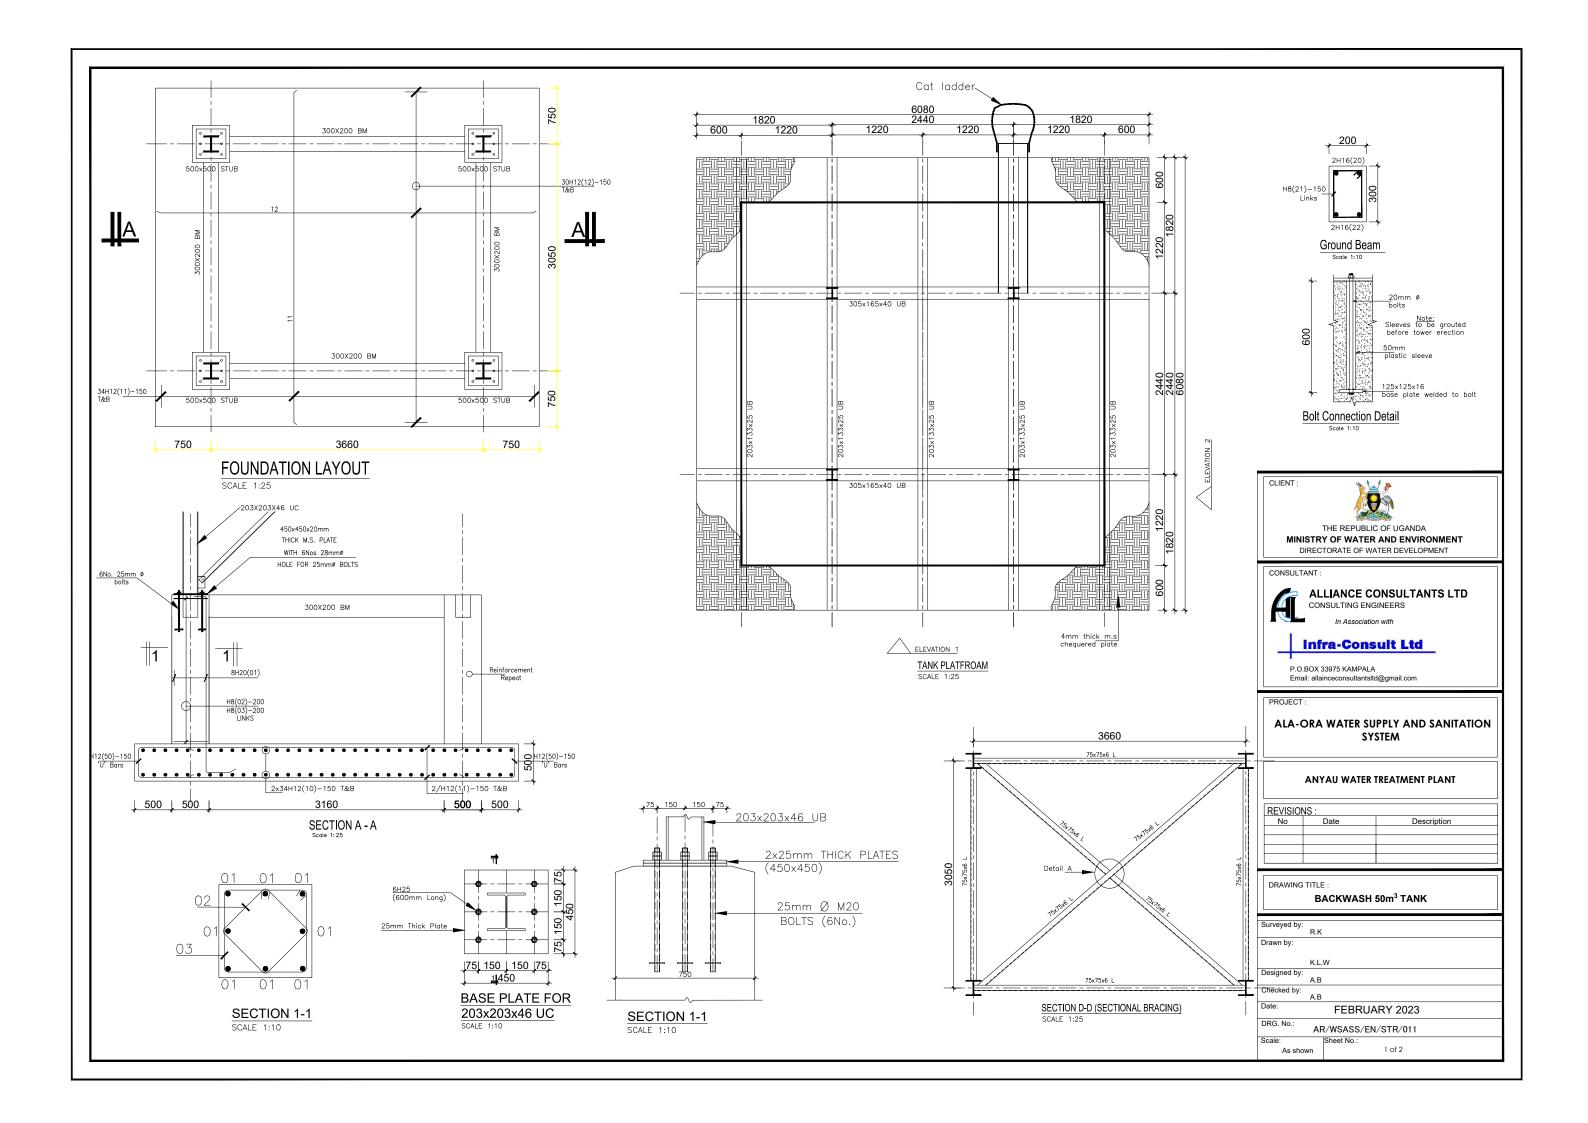

- This drawing shall be read in conjunction with all relevant drawings.
- 2. Concrete mixes to BS8500
 a. Mass concrete to have a minimum works cube strength of 15N/mm² and at 28 days with 20 mm maximum aggregate size
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- 3. Reinforcement
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 4449
 d. Mesh reinforcement to comply with
 requirement of B.S. 4483
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CLIENT :



THE REPUBLIC OF UGANDA MINISTRY OF WATER AND ENVIRONMENT DIRECTORATE OF WATER DEVELOPMENT



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P.O.BOX 33975 KAMPALA Email: allainceconsultantsltd@gmail.com

PROJECT :

ALA-ORA WATER SUPPLY AND SANITATION SYSTEM


ANYAU WATER TREATMENT PLANT


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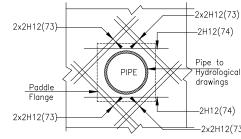
DRAWING TITLE :

BACKWASH 50m3 TANK

Designed by: Checked by: FEBRUARY 2023 DRG. No.: AR/WSASS/EN/STR/011 2 of 2 As shown



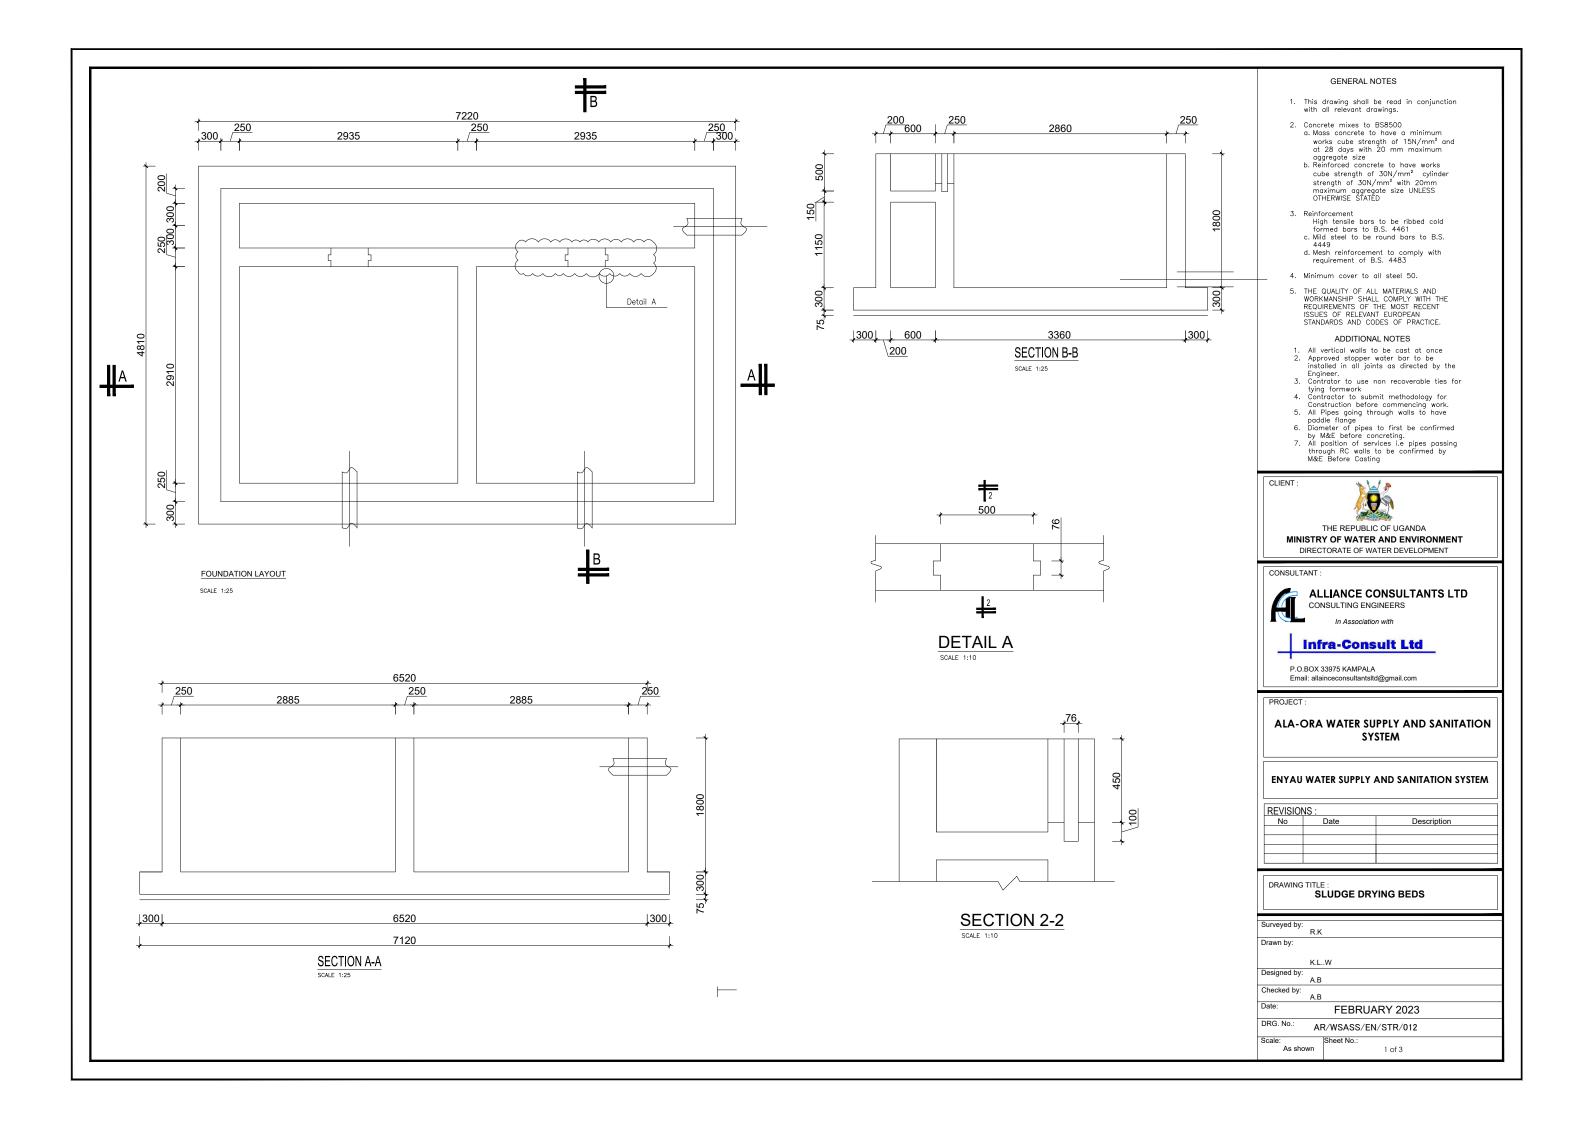

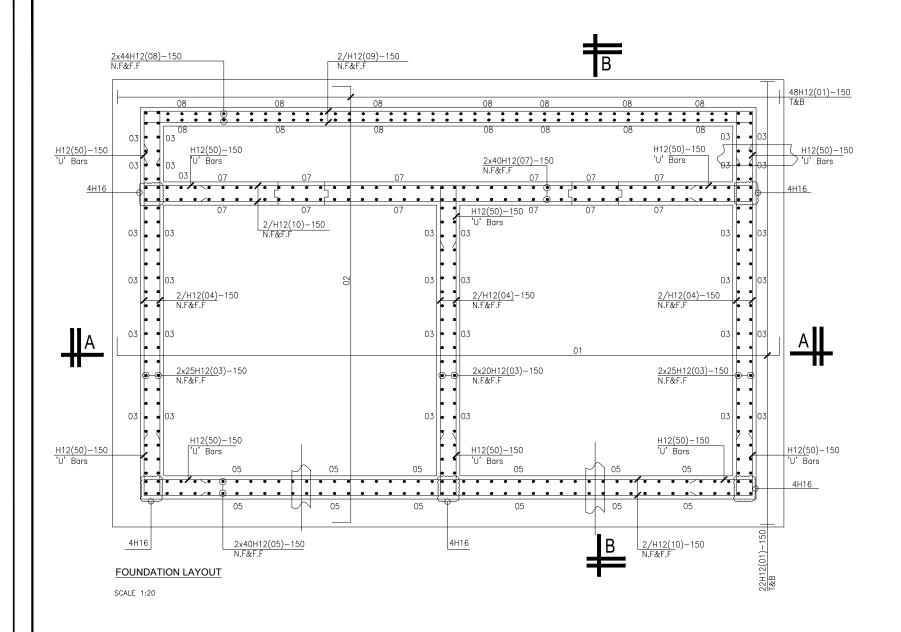

Pipe to 'Hydrological -2H12(74)

SCALE 1:20



MINISTRY OF WATER AND ENVIRONMENT DIRECTORATE OF WATER DEVELOPMENT CONSULTING ENGINEERS

ALLIANCE CONSULTANTS LTD

GENERAL NOTES This drawing shall be read in conjunction with all relevant drawings. Concrete mixes to BS8500
 a. Mass concrete to have a minimum

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Dn

THE REPUBLIC OF UGANDA

4. Minimum cover to all steel 50.

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PROJECT

CLIENT


ALA-ORA WATER SUPPLY AND SANITATION SYSTEM

ENYAU WATER SUPPLY AND SANITATION SYSTEM

REVISIO	NS:	
No	Date	Description

DRAWING TITLE : R.C DETAILS- SLUDGE DRYING BEDS

Surveyed by:	
	R.K
Drawn by:	
,	
	K.L.W
	N.L.VV
Designed by:	
	A.B
Checked by:	
-	A.B
Date:	FEBRUARY 2023
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TYPICAL WALL END DETAIL

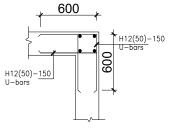
FOR WALL


Scale 1:20



BAR MARK 50

Scale 1:20

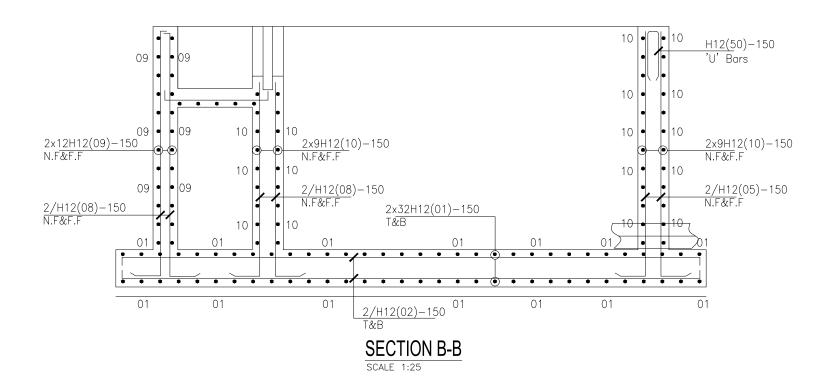

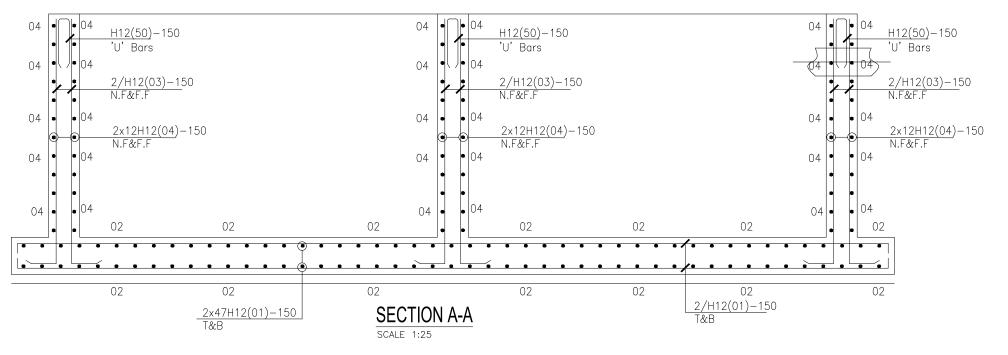

- This drawing shall be read in conjunction with all relevant drawings.
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CLIENT



THE REPUBLIC OF UGANDA MINISTRY OF WATER AND ENVIRONMENT DIRECTORATE OF WATER DEVELOPMENT



ALLIANCE CONSULTANTS LTD

CONSULTING ENGINEERS

Infra-Consult Ltd

P.O.BOX 33975 KAMPALA Email: allainceconsultantsltd@gmail.com

PROJECT


ALA-ORA WATER SUPPLY AND SANITATION SYSTEM


ENYAU WATER SUPPLY AND SANITATION SYSTEM


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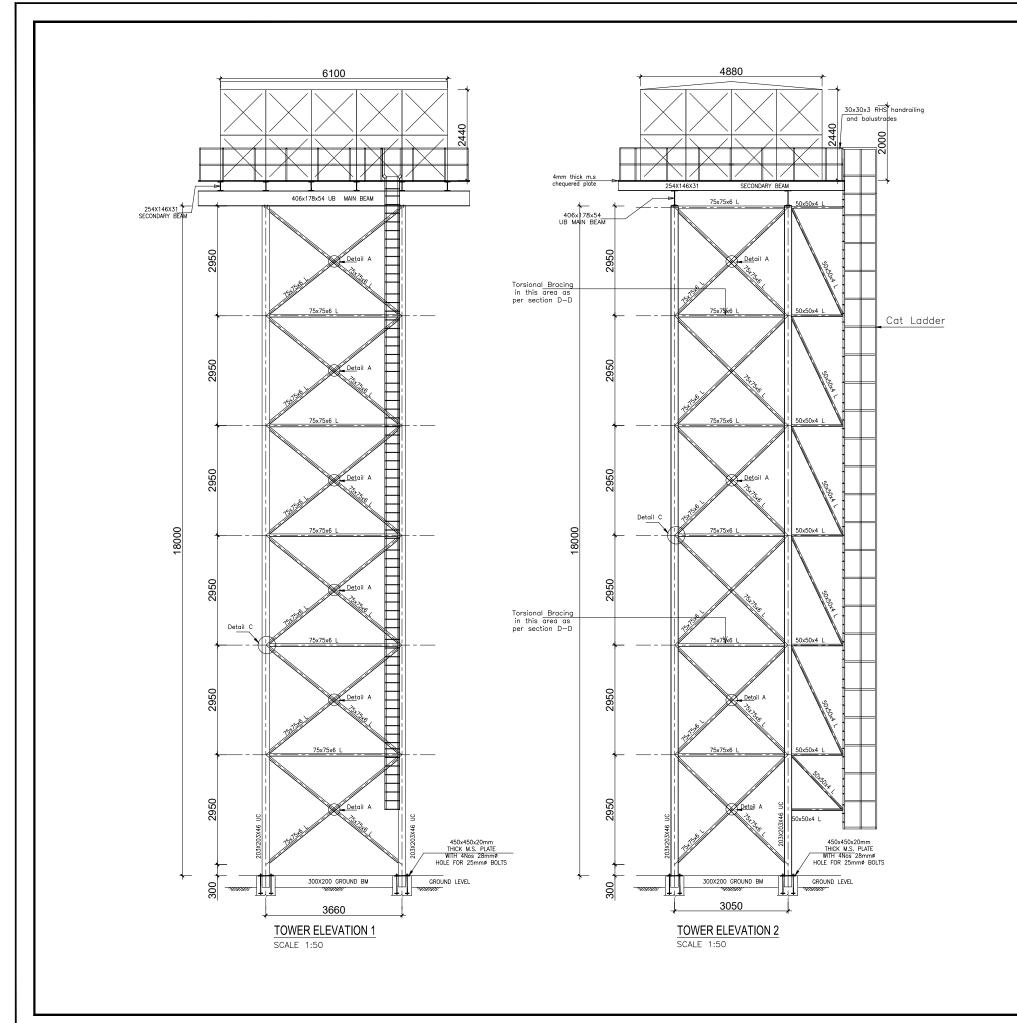
DRAWING TITLE: R.C DETAILS- SLUDGE DRYING BEDS

Surveyed by:	
	R.K
	N.IX
Drawn by:	
,	
	K.L.W
Designed by:	
	A.B
Checked by:	
Checked by.	A.B
	A.D
Date:	FEBRUARY 2023
	FEDRUART 2023
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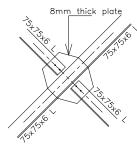




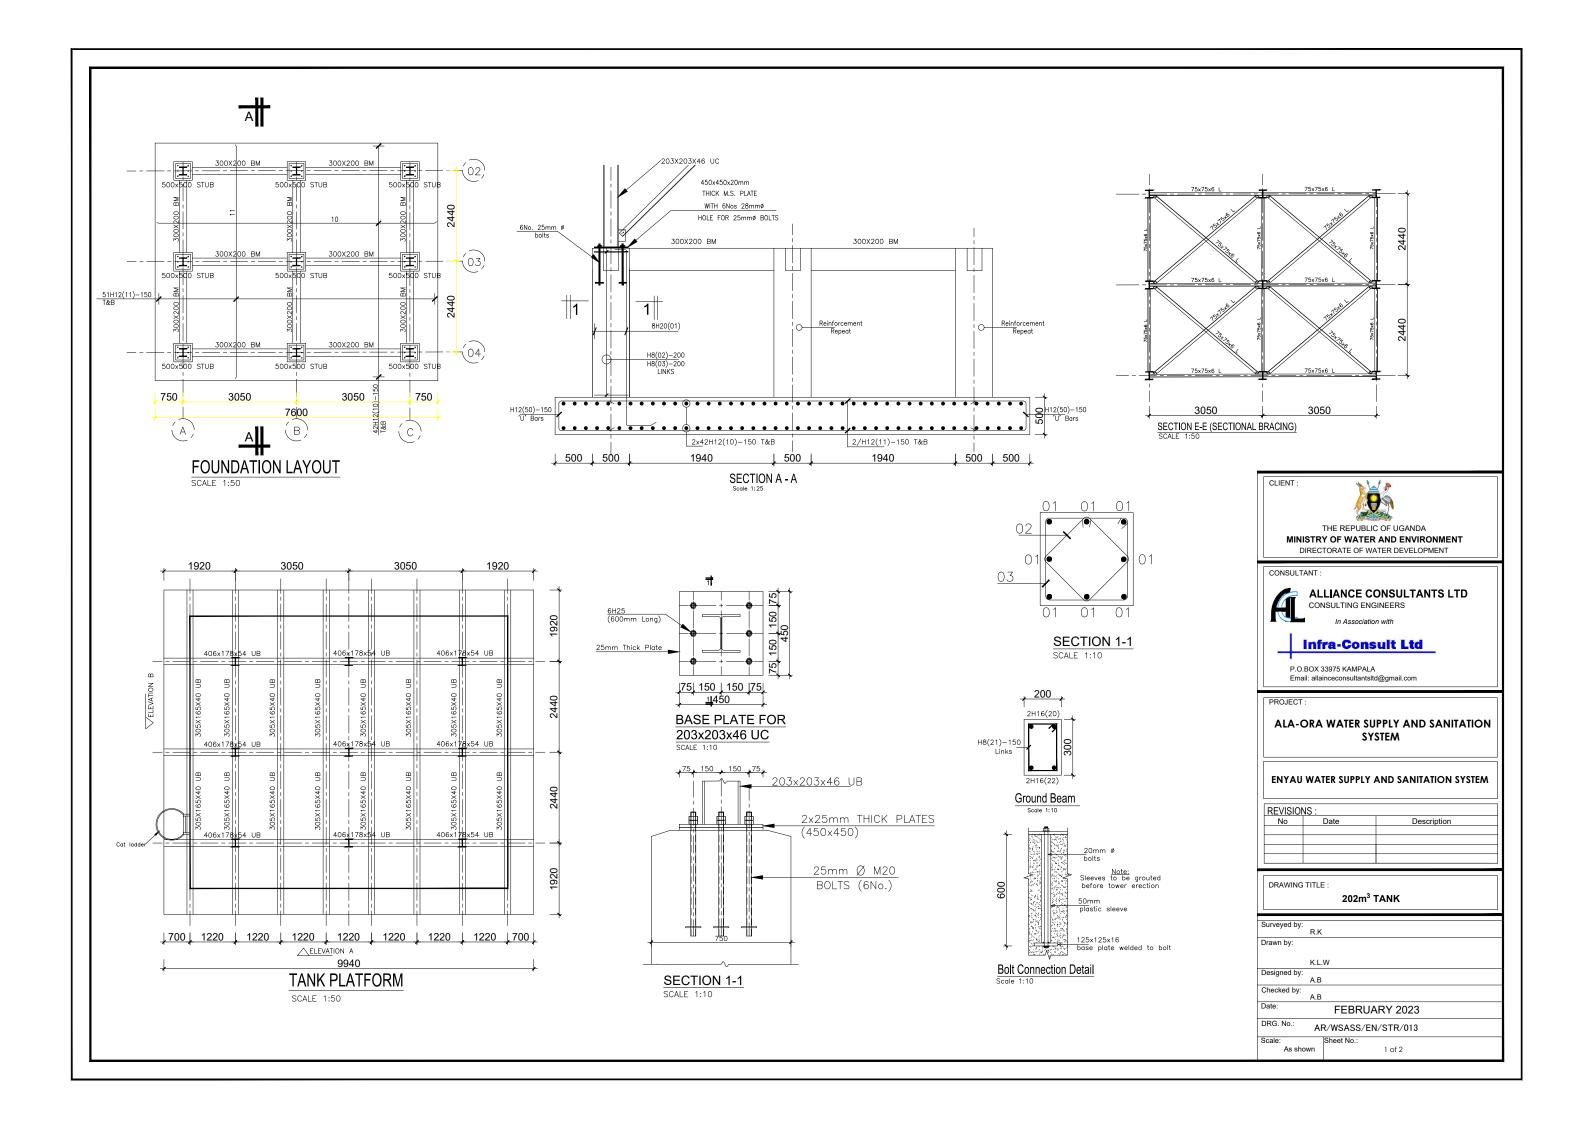

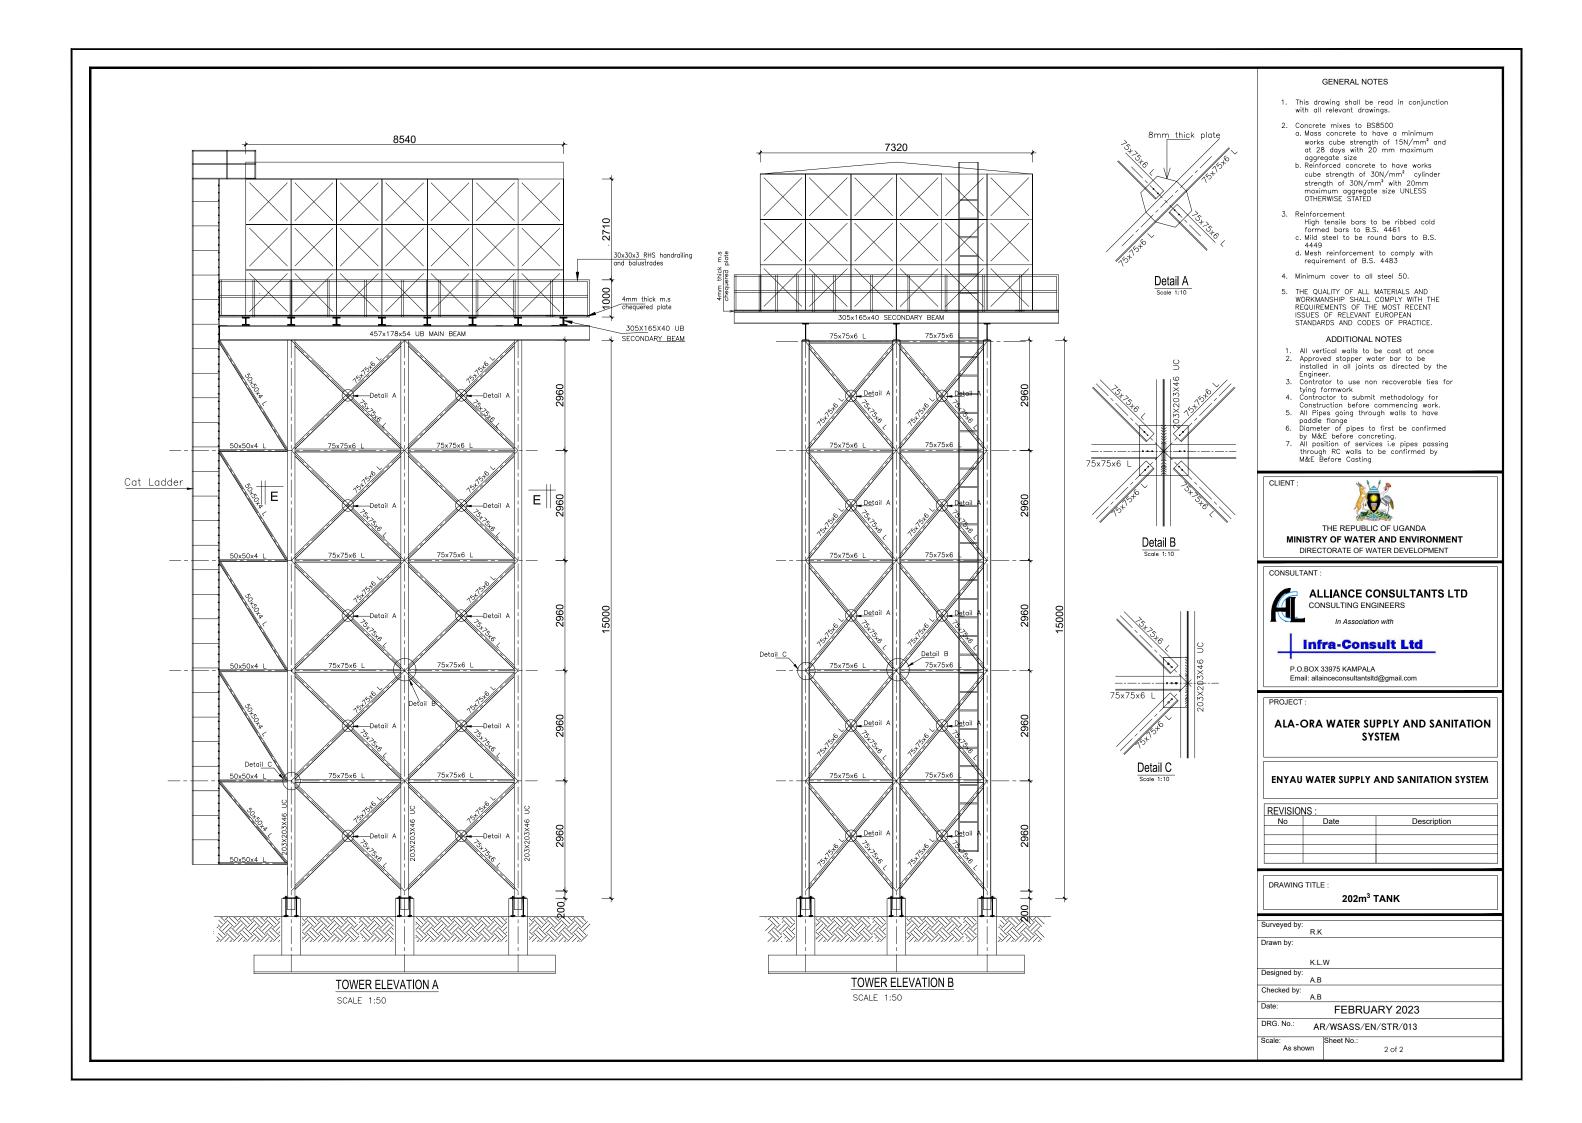

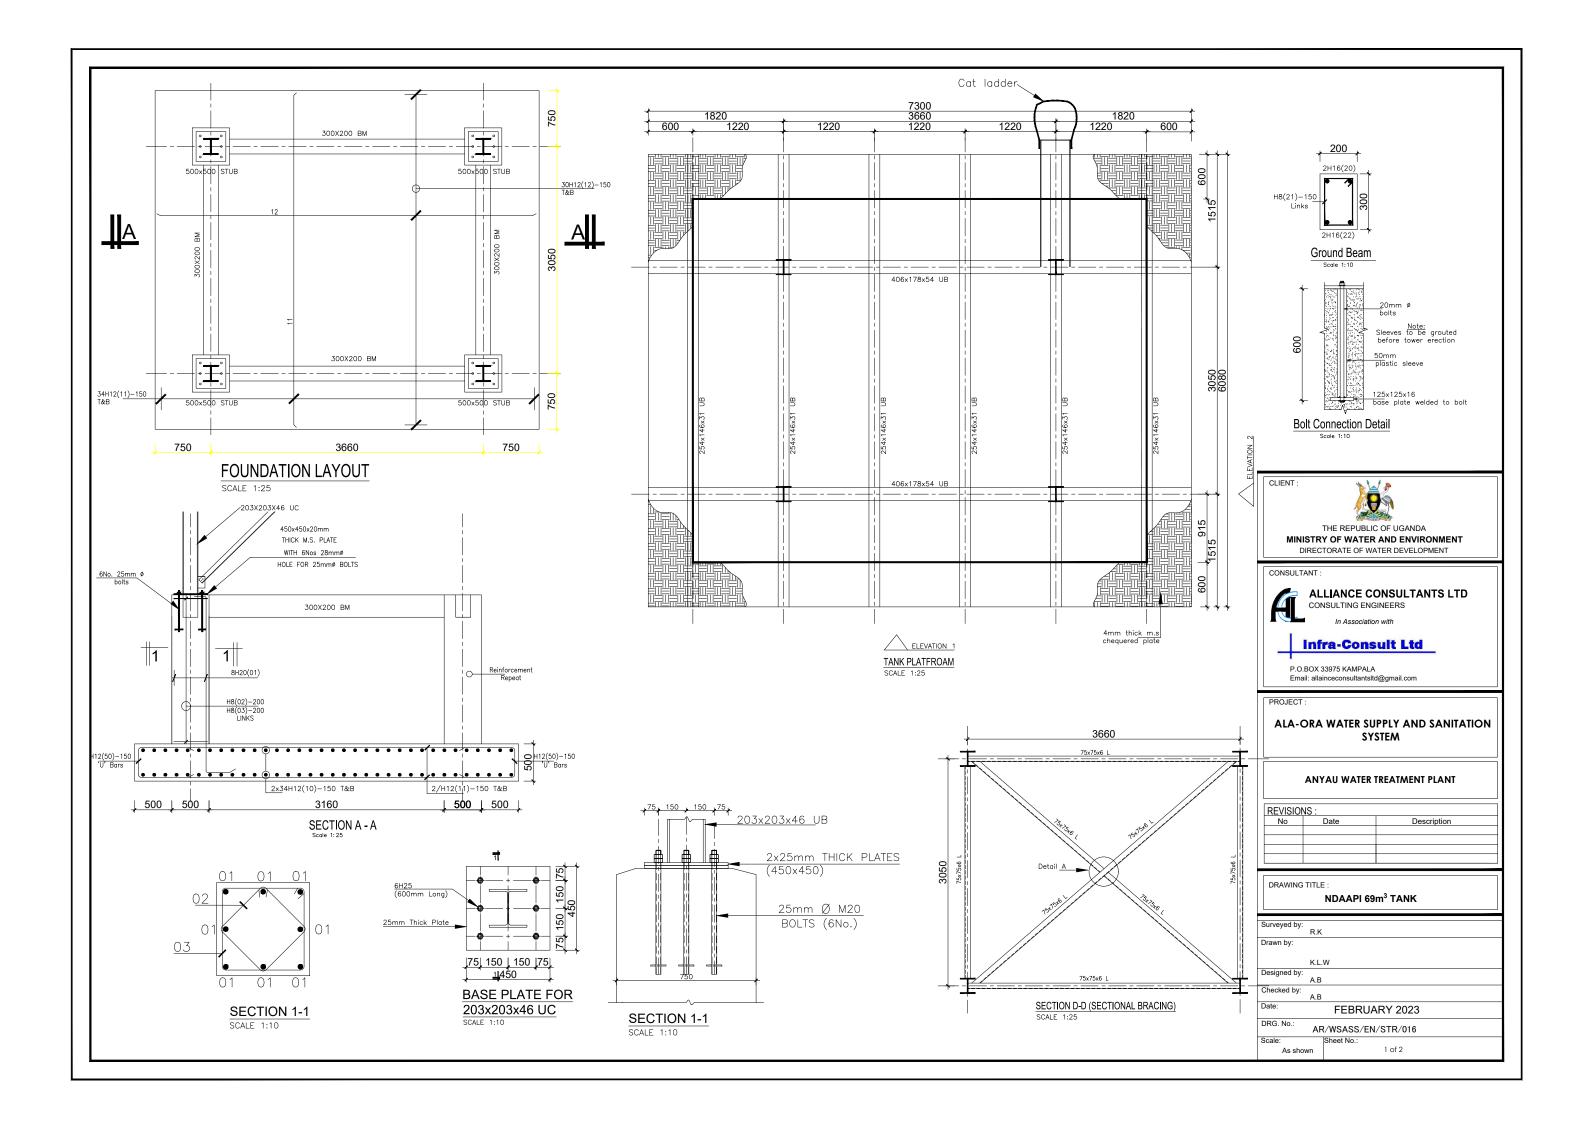



Detail A

- This drawing shall be read in conjunction with all relevant drawings.
- 2. Concrete mixes to BS8500
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CLIENT :



THE REPUBLIC OF UGANDA MINISTRY OF WATER AND ENVIRONMENT

DIRECTORATE OF WATER DEVELOPMENT



ALLIANCE CONSULTANTS LTD

CONSULTING ENGINEERS

Infra-Consult Ltd

P.O.BOX 33975 KAMPALA Email: allainceconsultantsltd@gmail.com

PROJECT

ALA-ORA WATER SUPPLY AND SANITATION SYSTEM


ANYAU WATER TREATMENT PLANT


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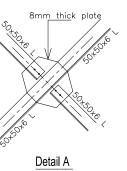
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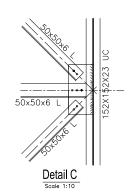
NDAAPI 69m3 TANK

Drawn by: Designed by: Checked by: FEBRUARY 2023 DRG. No.: AR/WSASS/EN/STR/016 2 of 2 As shown





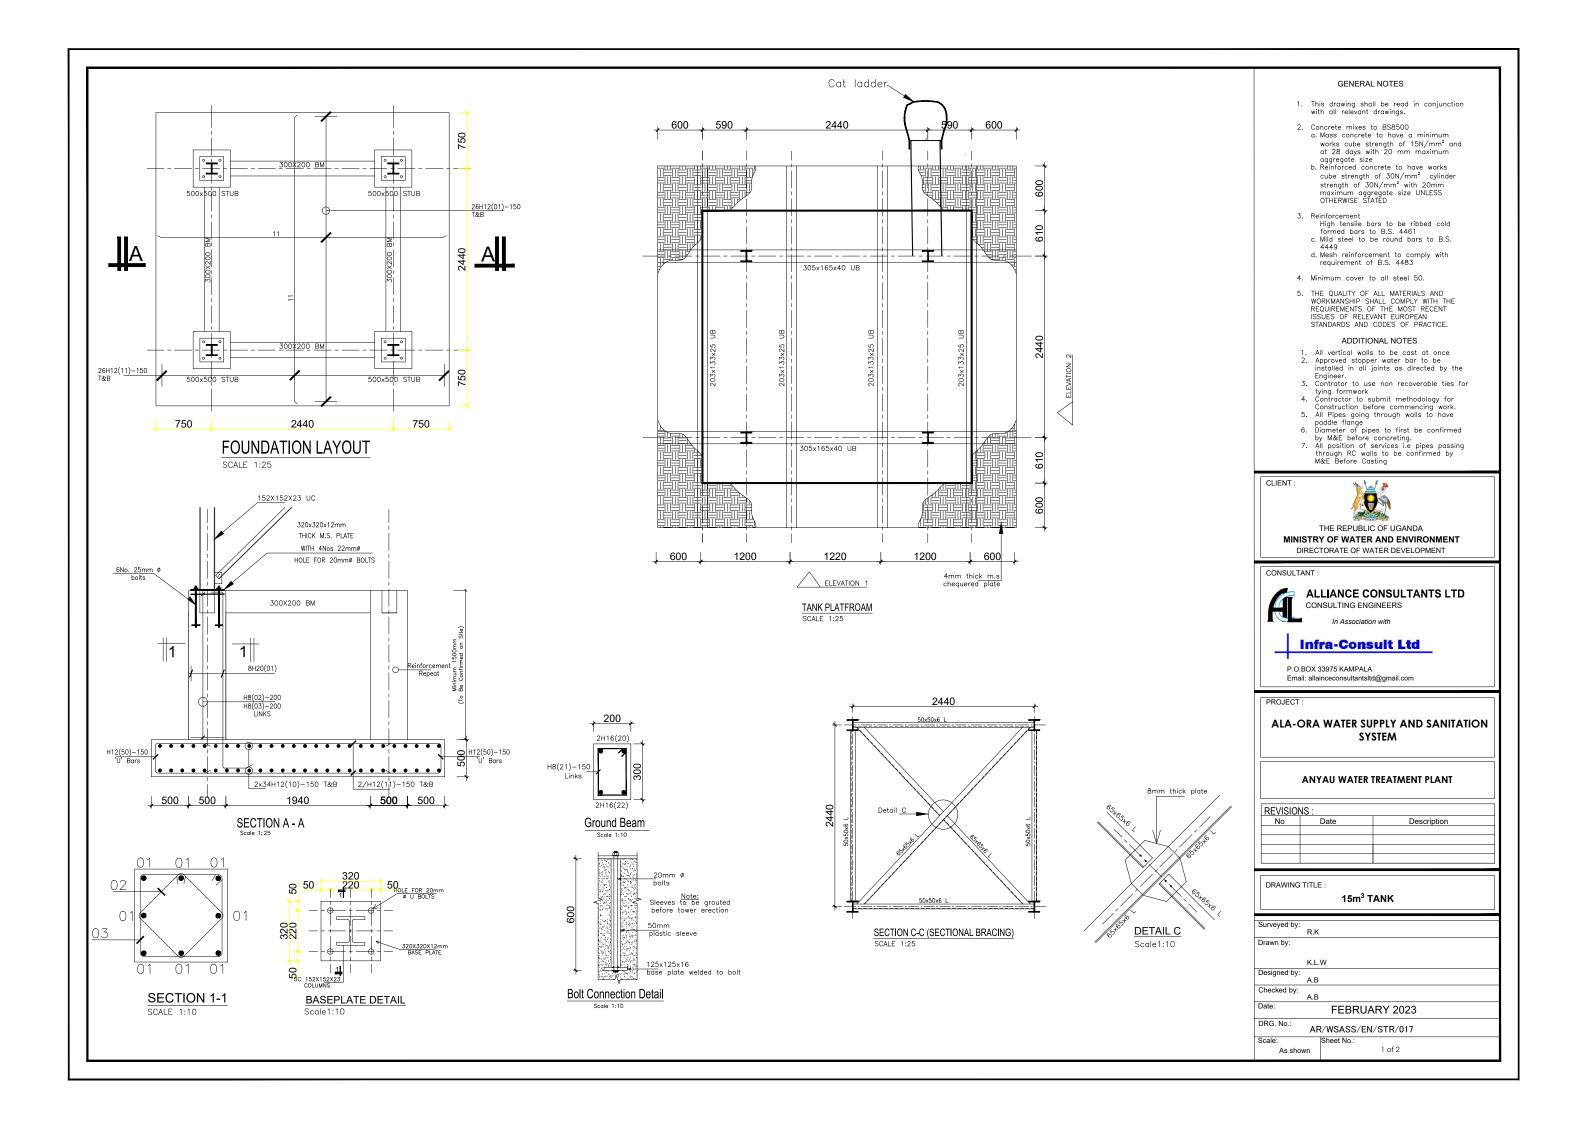

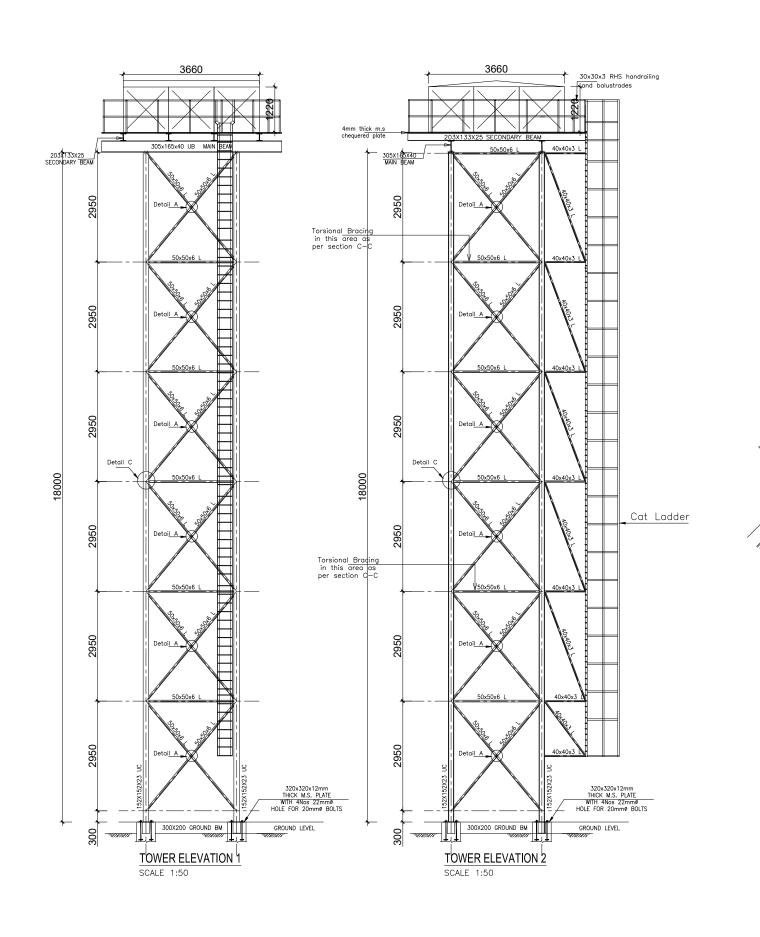

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- 2. Concrete mixes to BS8500
 a. Mass concrete to have a minimum works cube strength of 15N/mm² and at 28 days with 20 mm maximum aggregate size
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ALLIANCE CONSULTANTS LTD

CONSULTING ENGINEERS



P.O.BOX 33975 KAMPALA Email: allainceconsultantsltd@gmail.com

PROJECT :

ALA-ORA WATER SUPPLY AND SANITATION SYSTEM

ANYAU WATER TREATMENT PLANT

REVISIO	NS:	
No	Date	Description
		·

DRAWING TITLE :

15m³ TANK

Surveyed by:		
	R.K	
Drawn by:		
	K.L.	W
Designed by:		
	A.B	
Checked by:		
	A.B	
Date:		FEBRUARY 2023
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DRG. No.:		WO 4 00 /FN /OTD /047
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GENERAL NOTES FOR STANDARD DETAIL DRAWINGS

- 1. Unless flexibility is otherwise provided, where pipes enter or leave concrete structures, or anchor blocks, flexible joints are to be provided as shown.
- 2. Anchor block designs are based on the following ground conditions.

Dry soil density: 1800 kg/m 3

Submerged soil density: 1090 kg/m

Angle of internal friction: 30° Passive resistance factor: 3

- Where considerably better ground conditions, such as rock, are encountered, the dimensions of
 anchor blocks may be reduced. Supporting calculations for any reduced size anchor blocks
 must be submitted to the Project Manager 48 hours before construction of the particular anchor
 block commences and maybe concreted only after his approval.
- 3. Bases and thrust faces of anchor blocks are to be cast against undisturbed ground, or against blinding cast against undisturbed ground.
- 4. Pipe work joints as shown for the water supply details are diagrammatic only.
- 5. The following notes apply to reinforced concrete chambers.
 - a. Concrete in walls and base and cover slab 2

Characteristic strength (N/mm): 30

Maximum aggregate size (mm): 20

Cement type: SR 3

Minimum cement content (kg/m): 330 3

Maximum cement content (kg/m): 400

Maximum free water/cement ratio: 0.47

b. Concrete in blinding 2

Characteristic strength (N/mm): 1030

Maximum aggregate size (mm): 40

Cement type: SR 3

Minimum cement content (kg/m): 230

c. Cover to reinforcement 40mm unless positioned centrally

Minimum reinforcement lap 300 mm

For details of step irons see Standard Detail Ala-ora-SD-009

Corners of rectangular openings to have T8 bars 500 mm long set diagonally

- 6. All dimensions are in millimeters unless shown otherwise.
- 7. Do not scale dimensions from standard Detail drawings.

References

All engineering Drawings shall be read in conjunction with Specifications. Any discrepancies should be reported to the Supervising Engineer.

2. Dimensions

All dimensions are in millimeters (unless stated otherwise)

3. Foundations

Foundations have been designed on bearing pressure of 200 $\rm KN/m^2$ foundation depth to be determined by engineer prior to placing minimum foundation depth to be 1000mm below floor concrete. Level or 600 mm below Splash Apron level whichever is critical maximum allowable fill below ground slab = 500 mm

4. Block work

All Load bearing block walls to be constructed from solid block characteristic compression strength complying of 5.0 N/mm Min. with BS 5620 Part1 1978 Structural use of Unreinforced Masonry Mortar to conform to mortar designation (iii) of Table 1 BS 5620 Part1

5. Concrete

PROPOSED USE	GRADE	PERMITT AGGRE	ED TYPE GATES	MAX. SIZE	WORKABILITY
T NOT OBLD OBL	GIVADL	COARSE	FINE	AGGREGATES	
Reinforced conc. (including ground bearing slab)	C 25	BS 882	BS 882	20mm	Medium (75)
Concrete containing no embedded metal	C 15	BS 882	BS 882	40mm	Medium (75)
Blinding Concrete	C 7.5	BS 882	BS 882	20mm	Medium (75)
Concrete in minor elements e.g lintels	C 25	BS 882	BS 882	10mm	Medium (75)

COVER

LOCATION	COVER
To Mesh in ground slab Columns (cover to links) Slabs (cover to main bars)	30mm 25mm 25mm
Foundations Top and bottom slides	50mm 75mm

6. Joints

Movement joints to be at a maximum 9.0m centres. Joint positions as indicated on drg. Joint in salb to be carried through walls to underside of ring beam

Wall ties

Provide masonry anchors every 2 courses using galvanised. Mild steel debond ties to BS $1243 \cdot 1978$

8. Reinforcement

Reinforcement to be in accordance with consulting engineer's specification.


R - - - - Denotes round mild steel bars

T - - - - Denotes high yield bond strength bars.

NOTES

- . All dimensions in mm unless otherwise stated
- Where it is stated "Site Dimension" the measurement is to be determined on site.

LEGEND

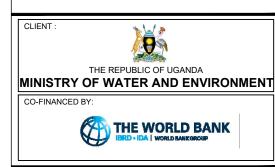

CONSULTANT:
Alliance Consultants Itd
In Association with
Infra-Consult Ltd

ALA-ORA WATER SUPPLY AND SANITATION PROJECT

ENYAU WATER SUPPLY AND SANITATION SYSTEM


REVISIONS:			
Date	Description		

Surveyed by:
R.K
Drawn by:
N.R
Designed by:
W.G.M
Checked by:
J.K.K
Date:
January 2023

DRAWING TITLE: STANDARD DRAWINGS

ALA-ORA-SD-000


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NOTES

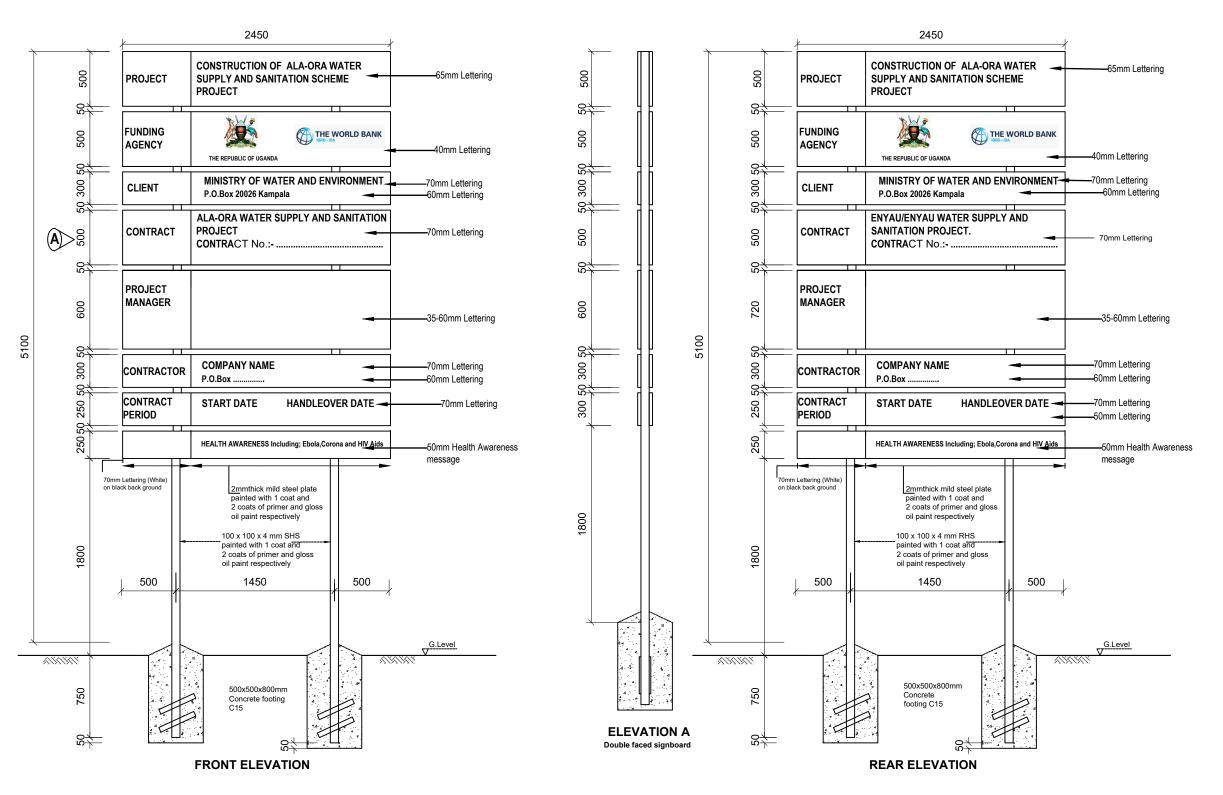- Project Signboards are to be double faced
- The Plates to be printed white and Words to be in black include all Logos.

<u>LEGEND</u>



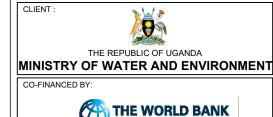


ALA-ORA WATER SUPPLY AND
SANITATION PROJECT


ENYAU WATER SUPPLY AND SANITATION SYSTEM


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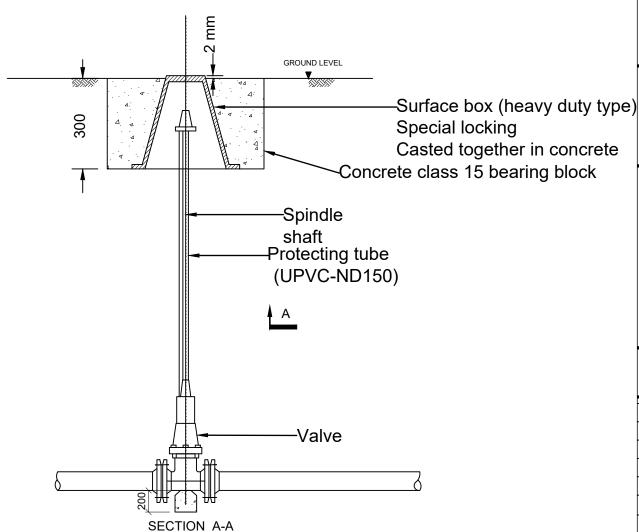
DRAWING TITLE: STANDARD DRAWINGS
Sign Board

Surveyed by:			
	R.K		
Drawn by:			
1 ′	N.R		
Designed by:			
,	W.G.M		
Checked by:			
	J.K.K		
Date:			
	January 2023		
DRG. No.:	AL A CDA CD 201		
ALA-ORA-SD-001			
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1:120	1 of 1		



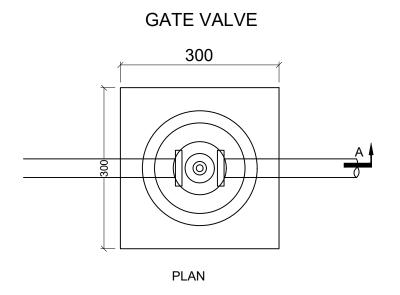

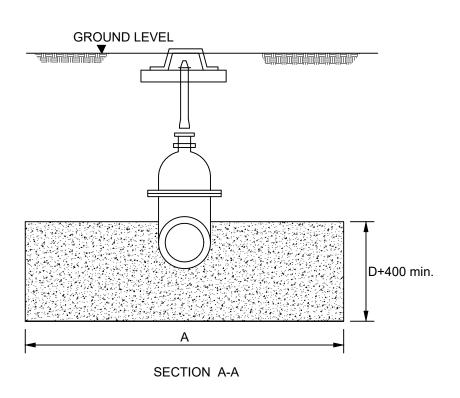

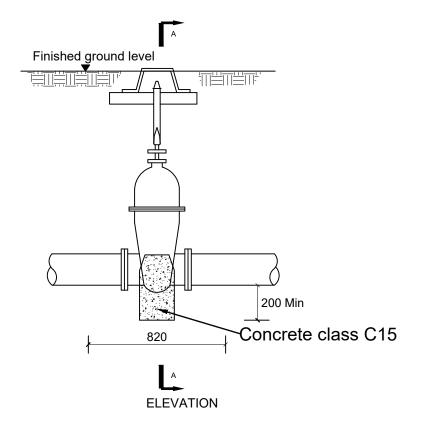

LEGEND



CONSULTANT:

Alliance Consultants Itd

In Association with

Infra-Consult Ltd

ALA-ORA WATER SUPPLY AND
SANITATION PROJECT


ENYAU WATER SUPPLY AND SANITATION SYSTEM

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DRAWING TITLE: STANDARD DRAWINGS
Gate Valve and Surface Box

Surveyed by:		
' '	R.K	
Drawn by:		
1 ′	N.R	
Designed by:		
,	W.G.M	
Checked by:		
•	J.K.K	
Date:		
	January 2023	
DRG. No.:	AL A ODA OD 000	
	ALA-ORA-SD-002	
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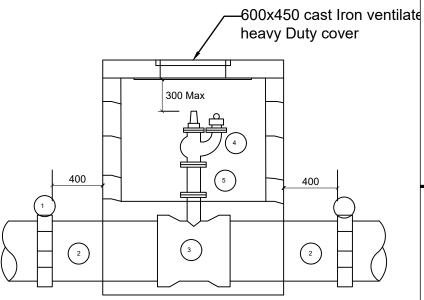
FIRE HYDRANT DETAILS



NOTE Alternati

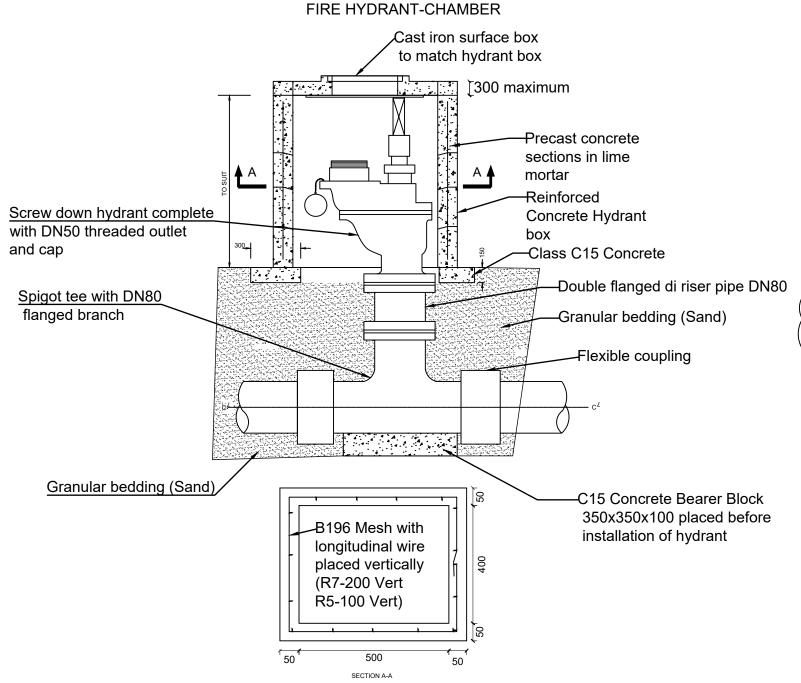Alternative to Precast concrete Chamber Section is 150/200mm thick C25 Layer of A393 Mesh to all members

FIRE HYDRANT-PIPEWORK



SCHEDULE ITEM DESCRIPTION

- 1 Flexible adaptor if required
- 2 Make-up pipe
- 3 Socket tee flanged branch 80 dia.
- 4 Flanged pipe 80 dia. As required
- 5 Screwdown hydrant

NOTES

- 1. Flanged pipework to be ductile iron
- Make up pipes to be ductile iron or UPVC

LEGEND





ALA-ORA WATER SUPPLY AND
SANITATION PROJECT

ENYAU WATER SUPPLY AND SANITATION SYSTEM

REVISIONS:								
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DRAWING TITLE: STANDARD DRAWINGS

Fire Hydrant Chamber and Pipework


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Designed by:	
,	W.G.M
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Date:	
	January 2023
DRG. No.:	AL A ODA OD 000
	ALA-ORA-SD-003
Scale:	Sheet No.:
1:120	1 of 1

AIR VALVE DETAILS

600x450 cast iron ventilated

heavy duty cover

AIR VALVE PIPEWORK

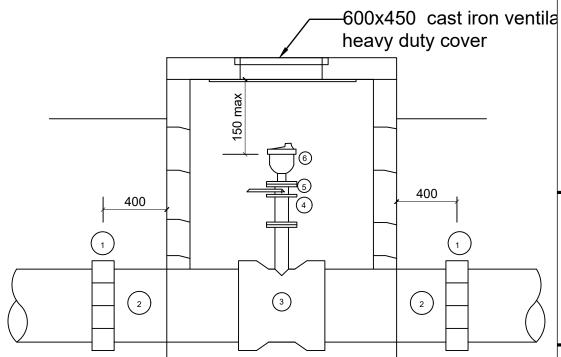

Note:

- 1. All Dimensions are in Millimeters
- 2. Flanged Pipework to be Ductile Iron
- 3. Make up Pipes to be Ductile Iron
- 4. Chamber to be 1200x900 Internal Dimensions
- 5. See General Notes

SCHEDULE

ITEM DESCRIPTION

- 1. Flexible adaptor if required
- 2. Make-up pipe
- 3. Socket tee flanged branch 80/50 dia as required
- 4. Flanged pipe 80/50 dia as required
- 5. Isolating valve main 100-300 Dia valve 50 Dia
- 6. Air valve main 350-600 Dia valve 80Dia








ALA-ORA WATER SUPPLY AND
SANITATION PROJECT

ENYAU WATER SUPPLY AND SANITATION SYSTEM

REVISIO	NS:	
No	Date	Description

DRAWING TITLE: STANDARD DRAWINGS
Air Valve Chamber and Pipework

Surveyed by:	
, ,	R.K
Orawn by:	N.R
Designed by:	100
,	W.G.M
Checked by:	
	J.K.K
Date:	
	January 2023
	ALA-ORA-SD-004
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AIR VALVE CHAMBER

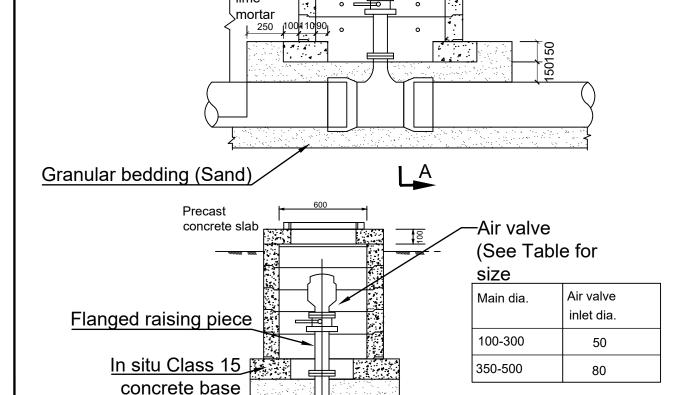Finished

Precast concrete sections in

ground leve

Note:

Granular bedding (Sand)


Alternative to Precast Concrete Chamber Sections is 150/200mm thick C25/Single layer of A393 Mesh to all Members

-Flanged tee

WASHOUT CHAMBER

2 5 4 400 400 SCHEDULE 9 ITEM DESCRIPTION NOTES Flanged spigot pipe 1200 long with thrust flange 10 lth Dimension in millimetres Make-up pipe Max. main size DN 500 All flanged tee, branch DN 80 Pipework within chamber to be 3 Flanged in-line gate valve ductile iron Flange adaptor 4 For details of chamber see Flanged 45o bend DN 80 standard detail drawing SD135 Flanged gate valve DN 80 Flanged adaptor DN 80 Spigot pipe DN 80 10. Flexible adaptor if required

OUTFALL STRUCTURE

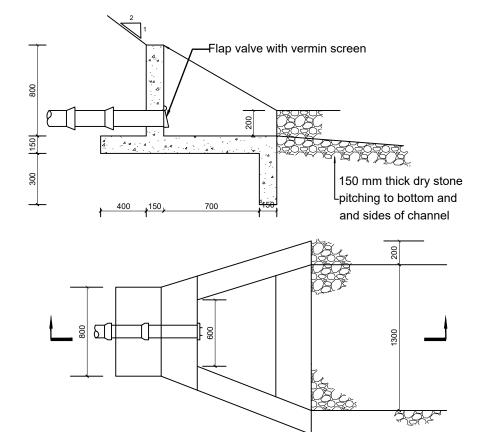

LEGEND





ALA-ORA WATER SUPPLY AND SANITATION PROJECT


ENYAU WATER SUPPLY AND SANITATION SYSTEM

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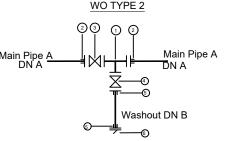
DRAWING TITLE: STANDARD DRAWINGS **Washout Chamber and Outfall Structure**

Surveyed by:	
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Drawn by:	
•	N.R
Designed by:	
	W.G.M
Checked by:	
,	J.K.K
Date:	
	January 2023
DRG. No.:	AL A ODA OD 005
	ALA-ORA-SD-005
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1:120	1 of 1

WASHOUT DETAILS TYPE 1 & 2

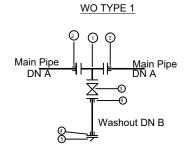

- 1 1No CI Flanged Tee DN A/B
- 2 2No DI Flange Adaptor, Maxi type or similar type DN A
- 3 1No CI Flanged Gate Valve DN A
- (4)1No DI Flange Adaptor, Maxi type or similar DN B
- ⑤ 1 No. D1 Flanged Flap Valve DN B





- 1 1No CI Flanged Tee DN A/B
- 2 1No DI Flange Adaptor, Maxi type or similar type DN A
- 3 1No CI Flanged Gate Valve DN A
- 4 1No DI Flanged Gate Valve DN B
- ⑤ 2No DI Flange Adaptor, Maxi type or similar DN B
- 6 1No D1 Flanged Flap Valve DN B

	WO TYPE 2
Main Pipe A DN A	③③ ① ② Main Pipe A DN A
	Washout DN B


Main Pipe	Washout	А	В
OD 63	OD 63	DN 50	OD 50
OD 90	OD 63	DN 80	OD 50
OD 110	OD 63	DN 100	OD 50
OD 160	OD 63	DN 150	OD 50
OD 208	OD 110	DN 200	OD 100
OD 250	OD 110	DN 250	OD 100
OD 300	OD 110	DN 300	OD 100

installed
All Pipe Fittings within the Chamber are to be Ductile Iro

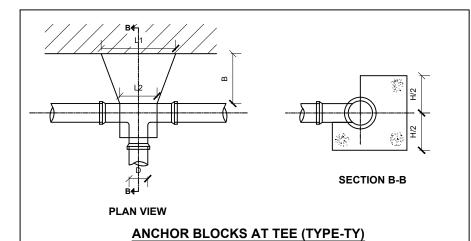

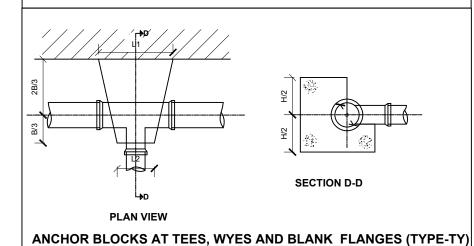

	TEES (TY	TEES (TYPE-TY)									
BRANCH SIZE	TEST PRESSURE				BRANCH SIZE	TEST PRESSURE					
ND (mm)	m	L1 m	L2 m	Вm	H m	ND (mm)	m	L1 m	L2 m	Вm	H m
	250	0.40	0.20	0.40	0.30		250	0.50	0.25	0.50	0.40
	225	0.40	0.20	0.40	0.30		225	0.50	0.25	0.50	0.40
50	180	0.40	0.20	0.40	0.30	80	180	0.50	0.25	0.50	0.40
	135	0.40	0.20	0.40	0.30		135	0.50	0.25	0.50	0.40
	90	0.40	0.20	0.40	0.30		90	0.50	0.25	0.50	0.40
BRANCH SIZE	TEST PRESSURE				BRANCH SIZE	TEST PRESSURE					
ND (mm)	m	L1 m	L2 m	Вm	H m	ND (mm)	m	L1 m	L2 m	Вm	H m
	250	0.60	0.30	0.60	0.50		250	0.70	0.40	0.60	0.50
	225	0.60	0.30	0.60	0.50		225	0.70	0.40	0.60	0.50
100	180	0.60	0.30	0.60	0.50	150	180	0.70	0.40	0.60	0.50
	135	0.60	0.30	0.60	0.50		135	0.70	0.40	0.60	0.50
	90	0.60	0.30	0.60	0.50		90	0.70	0.40	0.60	0.50

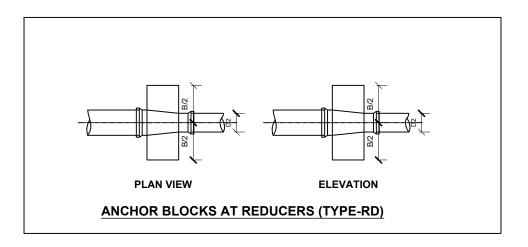

REDUCERS (TYPE-RD)					RE	DUCERS (TY	REDUCERS (TYPE-RD)							
NOMINAL DIAMETER	TEST PRESSURE				NOMINAL DIAMETER	TEST PRESSURE				NOMINAL DIAMETER	TEST PRESSURE			
mm	m	Lm	Вm	H m	mm	m	Lm	Вm	H m	mm	m	Lm	Вm	H m
	250	0.35	0.50	0.55	150/80	250	0.40	0.70	0.45		250	0.40	0.75	0.55
	225	0.35	0.50	0.50		225	0.40	0.70	0.45		225	0.40	0.70	0.55
100/80	180	0.35	0.50	0.45		180	0.40	0.65	0.40	100/150	180	0.40	0.60	0.50
	135	0.35	0.50	0.40		135	0.40	0.60	0.40		135	0.40	0.60	0.45
	90	0.35	0.50	0.40		90	0.40	0.60	0.40		90	0.40	0.60	0.40

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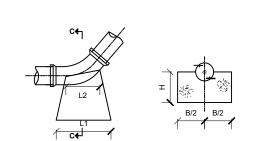
ALA-ORA WATER SUPPLY AND SANITATION PROJECT

ENYAU WATER SUPPLY AND SANITATION SYSTEM

REVISIONS:									
No	Date	Description							
,									

STANDARD DRAWINGS **Anchor Block Details**

Surveyed by:										
R	.K									
Drawn by:										
	.R									
Designed by:										
	W.G.M									
Checked by:	Checked by:									
	.K.K									
Date:										
J	anuary 2023									
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ALA-ORA-SD-006										
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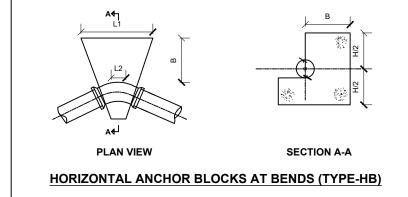
ELEVATION SECTION C-C

VERTICAL ANCHOR BLOCKS AT DEPRESSIONS (TYPE-DV)

NOMINAL DIAMETER	TEST PRESSURE		45° E	BEND			22½°	BEND)	1	11¼°	BEND)
mm	m	L1 m	L2 m	B m	H m	L1 m	L2 m	Вm	H m	L1 m	L2m	B m	H m
	250	0.40	0.20	0.30	0.50	0.40	0.20	0.30	0.50	0.40	0.20	0.20	0.50
	225	0.40	0.20	0.30	0.50	0.40	0.20	0.30	0.50	0.40	0.20	0.20	0.50
100	180	0.40	0.20	0.30	0.50	0.40	0.20	0.30	0.50	0.40	0.20	0.20	0.50
	135	0.40	0.20	0.30	0.50	0.40	0.20	0.30	0.50	0.40	0.20	0.20	0.50
	90	0.40	0.20	0.30	0.50	0.40	0.20	0.30	0.50	0.40	0.20	0.20	0.50

	VEF	RTICA	L BEN	NDS -	DEPR	ESSIC	ONS (1	YPE-	DV)				
NOMINAL DIAMETER	TEST PRESSURE		45° B	END		:	22½°	BEND		,	11¼°	BEND	,
mm	m	L1 m	L2 m	Вm	H m	L1 m	L2 m	B m	H m	L1 m	L2 m	Вm	H m
	250	0.40	0.16	0.30	0.50	0.40	0.16	0.30	0.50	0.40	0.16	0.20	0.50
80	225	0.40	0.16	0.27	0.50	0.40	0.16	0.30	0.50	0.40	0.16	0.20	0.50
	180	0.40	0.16	0.30	0.50	0.40	0.16	0.30	0.50	0.40	0.16	0.20	0.50
	135	0.40	0.16	0.30	0.50	0.40	0.16	0.30	0.50	0.40	0.16	0.20	0.50
	90	0.40	0.16	0.30	0.50	0.40	0.16	0.30	0.50	0.40	0.16	0.20	0.50

NOMINAL DIAMETER	TEST PRESSURE		45° E	BEND			22½°	BEND)		11¼°	BEND)
mm	m	L1 m	L2 m	Вm	Нm	L1 m	L2 m	Вm	Нm	L1m	L2m	Вm	H m
	250	0.80	0.30	0.40	0.55	0.70	0.30	0.30	0.55	0.50	0.30	0.30	0.55
	225	0.70	0.30	0.40	0.55	0.60	0.30	0.30	0.55	0.50	0.30	0.30	0.55
150	180	0.70	0.30	0.40	0.55	0.50	0.30	0.30	0.55	0.50	0.30	0.30	0.55
	135	0.70	0.30	0.40	0.55	0.50	0.30	0.30	0.55	0.40	0.30	0.30	0.55
	90	0.70	0.30	0.40	0.55	0.40	0.30	0.30	0.55	0.40	0.30	0.30	0.55



				Н	ORIZ	ONTA	L BEN	IDS (T	YPE-	HB)							
NOMINAL DIAMETER	TEST PRESSURE		90° E	BEND			45° E	BEND			22½°	BEND)		11¼° BEND		
mm	m	L1 m	L2 m	Вm	H m	L1 m	L2 m	Вm	H m	L1 m	L2 m	Вm	H m	L1m	L2m	Вm	H m
	250	1.00	0.24	0.35	0.50	0.60	0.24	0.30	0.40	0.50	0.24	0.20	0.20	0.40	0.24	0.20	0.20
	225	0.60	0.24	0.35	0.40	0.50	0.24	0.25	0.30	0.40	0.24	0.20	0.20	0.30	0.24	0.20	0.20
80	180	0.60	0.24	0.35	0.30	0.50	0.24	0.23	0.25	0.40	0.24	0.20	0.20	0.30	0.24	0.20	0.20
	135	0.60	0.24	0.35	0.30	0.50	0.24	0.20	0.20	0.40	0.24	0.20	0.20	0.30	0.24	0.20	0.20
	90	0.60	0.24	0.35	0.20	0.50	0.24	0.20	0.20	0.40	0.24	0.20	0.20	0.30	0.24	0.20	0.20

NOMINAL DIAMETER	TEST PRESSURE		90° E	END			45° E	END			22½°	BEND	١		11¼°	BEND)
mm	m	L1 m	L2 m	B m	H m	L1 m	L2 m	B m	H m	L1 m	L2 m	B m	H m	L1m	L2m	B m	H m
	250	1.20	0.45	0.80	0.80	0.80	0.45	0.80	0.80	0.80	0.45	0.70	0.70	0.60	0.45	0.60	0.60
	225	1.20	0.45	0.80	0.80	0.80	0.45	0.80	0.80	0.80	0.45	0.70	0.70	0.60	0.45	0.60	0.60
150	180	1.00	0.45	0.80	0.80	0.80	0.45	0.80	0.80	0.80	0.45	0.70	0.70	0.60	0.45	0.60	0.60
	135	1.00	0.45	0.60	0.60	0.80	0.45	0.80	0.80	0.60	0.45	0.70	0.70	0.60	0.45	0.60	0.60
	90	1.00	0.45	0.60	0.60	0.60	0.45	0.80	0.80	0.60	0.45	0.70	0.70	0.60	0.45	0.60	0.60

NOMINAL DIAMETER	TEST PRESSURE		90° E	BEND			45° E	BEND		;	22½°	BEND	١	,	11¼°	BEND)
mm	m	L1 m	L2 m	Вm	Нm	L1 m	L2 m	Вm	H m	L1 m	L2 m	Вm	H m	L1m	L2 m	Вm	H m
	250	1.00	0.30	0.35	0.50	0.80	0.30	0.80	0.80	0.80	0.30	0.60	0.60	0.60	0.30	0.60	0.60
	225	0.90	0.30	0.30	0.40	0.60	0.30	0.80	0.80	0.80	0.30	0.60	0.60	0.60	0.30	0.60	0.60
100	180	0.60	0.30	0.25	0.30	0.60	0.30	0.80	0.80	0.80	0.30	0.60	0.60	0.60	0.30	0.60	0.60
	135	0.60	0.30	0.25	0.30	0.60	0.30	0.80	0.80	0.60	0.30	0.60	0.60	0.60	0.30	0.60	0.60
	90	0.60	0.30	0.20	0.20	0.60	0.30	0.80	0.80	0.60	0.30	0.60	0.60	0.60	0.30	0.60	0.60

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PROJECT


ALA-ORA WATER SUPPLY AND SANITATION PROJECT

ENYAU WATER SUPPLY AND SANITATION SYSTEM

REVISIO	NS:	
No	Date	Description

DRAWING TITLE: STANDARD DRAWINGS
Anchor Block Details

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Surveyed by:		
R.K		
Drawn by:		
N.F	{	
Designed by:		
	G.M	
Checked by:		
J.K	.K	
Date:		
Jar	uary 2023	
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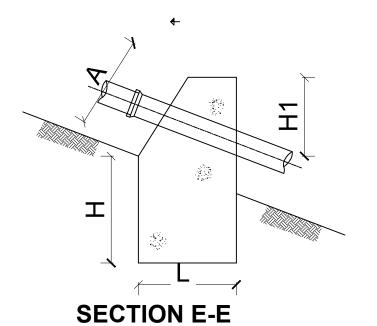
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mm	m	Lm	B m	H m	Lm	B m	H m	Lm	B m	H m
	250	1.70	1.10	0.80	1.30	0.90	0.80	1.00	0.70	0.60
	225	1.50	1.10	0.80	1.20	0.80	0.80	1.00	0.70	0.60
150	180	1.50	1.10	0.70	1.10	0.80	0.80	1.00	0.70	0.60
	135	1.40	0.90	0.70	1.00	0.70	0.80	1.00	0.70	0.60
	90	1.20	0.80	0.60	0.90	0.70	0.80	1.00	0.70	0.60

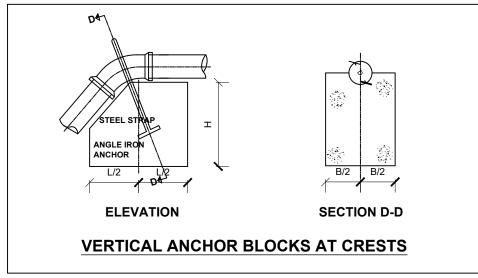
NOMINAL DIAMETER	TEST PRESSURE	45	s° BEN	ND	221	∕₂° BE	ND	111	∕₄° BE	:ND
mm	m	Lm	B m	H m	Lm	B m	H m	L m	B m	H m
	250	1.40	0.70	0.80	1.20	0.70	0.80	1.20	0.70	0.80
	225	1.20	0.70	0.80	1.20	0.70	0.80	1.20	0.70	0.80
100	180	1.20	0.70	0.80	1.20	0.70	0.80	1.20	0.70	0.80
	135	1.20	0.70	0.80	1.20	0.70	0.80	1.20	0.70	0.80
	90	1.20	0.70	0.80	1.20	0.70	0.80	1.20	0.70	0.80


	VE	RTIC	AL BE	NDS	(TYPE	-CV)				
NOMINAL DIAMETER	TEST PRESSURE	45	s° BEN	1D	221	∕₂° BE	ND	111	∕₄° BE	ND
mm	m	L m	B m	H m	L m	B m	H m	L m	Вm	H m
	250	1.40	0.70	0.80	1.20	0.70	0.80	1.20	0.70	0.80
	225	1.20	0.70	0.80	1.20	0.70	0.80	1.20	0.70	0.80
80	180	1.20	0.70	0.80	1.20	0.70	0.80	1.20	0.70	0.80
	135	1.20	0.70	0.80	1.20	0.70	0.80	1.20	0.70	0.80
	90	1.20	0.70	0.80	1.20	0.70	0.80	1.20	0.70	0.80

NOTES

- 1. Anchor blocks to be constructed from unreinforced concrete class 20.
- Concrete to be casted and undisturbed soil, where disturbed soil around the anchor blocks either to be removed and filled with concrete before pressure testing, or soil to be compacted to not less than 95% max. dry density before the mass is pressure tested.
- 3. $11\frac{1}{4}$ ° bends to be used for bends >=6° and =<16°
- 4. Anchor blocks to be cast to leave all pipe joints free.
- 5. Shuttered surfaces to be suitable to receive backfill or further concrete framework suitable to precast loss of ground fibrated.
- 6. The p.v.c bends shall be covered with three layers of polythene sheeting before concreteing.



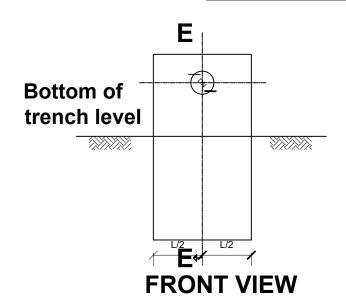

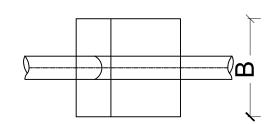

PLAN VIEW

ANCHOR BLOCKS ON GRADIENTS (TYPE-GD)

LEGEND

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PROJECT

ALA-ORA WATER SUPPLY AND SANITATION PROJECT

ENYAU WATER SUPPLY AND SANITATION SYSTEM


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No	Date	Description
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DRAWING TITLE: STANDARD DRAWINGS
Anchor Block Details

Surveyed by:		
	R.K	
Drawn by:		
	N.R	
Designed by:		
	W.G.M	
Checked by:		
	J.K.K	
Date:		
	January 2023	
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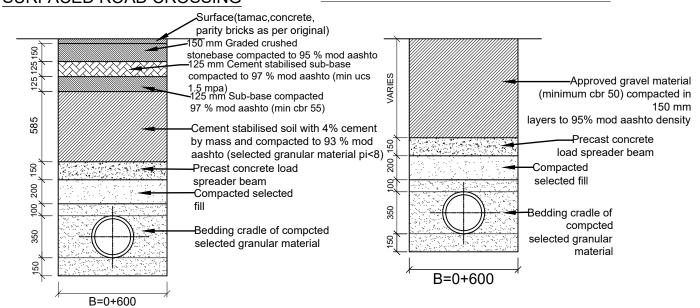
TRENCHING AND BACKFILLING DETAILS

TYPICAL TRENCH EXCAVATION AND BACKFILLING FOR PE/uPVC/GRP PIPES



PIPE PROTECTION AT SURFACED ROAD CROSSING

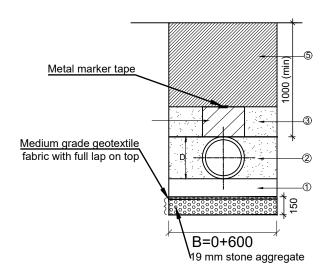PIPE PROTECTION AT UNSURFACED ROAD CROSSING



NOTES:

- 1. Minimum and normal trench width are defined as normal pipe diameter plus 600 mm.
- 2. The backfill around the pipe from the trench bottom to the crown of the pipe shall be carried out in layers whose depth shall not exceed 75 mm nor half the nominal pipe diameter whichever is the lesser.
- 3. The bedding required is selected by the engineer according to :
 - (i) Depth of cover
 - (ii) Diameter of pipe
 - (iii)Type of vehicle loading
 - (iv) Type of soil
- 4. The embedment specifies the degree of compaction required in order to fulfill design requirements.
- 5. In general, the method of attaining the required compaction will be ascertained as follows:
- (i) The engineer's representative will identify, classify and agree the soil type of embedment material available from the trench.
 - (ii) The site soil type will be compared with those on the material description chart [see table 1]
- (iii) The compaction method required is then selected from the compaction chart for the appropriate soil type and class of embedment [see table 2]
- 6. not all soils are given in table 1. it should be noted that:
 - (i) Fined grained soils with high plasticity may not be used as backfill

- (ii)Fined grained soils with low plasticity may be condemned for use as backfill if the contractor has difficulty in attaining the required compaction.
- 7. Where site material is condemned, imported material shall be used. this shall be a well graded soil from fines upto 20 mm gravel or as approved by the engineer's representative.
- 8. Where some doubt exists as to the compactibility of the soil as defined above, recourse shall be made to the modified proctor density test. the site and laboratory tests shall be carried out to tests 14 b and 12 respectively to ssrn 601 the contractor shall include in his rates for backfilling with available soil.
- 9. If stones or rock are present, imported bedding material of min. 150 mm thick shall be required as approved by the engineer's representative. at designated road crossings the bedding shall have a minimum thickness of 150 mm.
- 10. The backfill shall be placed in layers as defined above, each layer shall be rammed with a small vibratory rammer. the required number of passes of the rammer is given in table 2. in any event 90% mpd shall be achieved. only when there is 300 mm cover over the pipe may heavier compacting equipment
- 11. Be used. the remainder of the backfill shall be suitably compacted in keeping with the reinstatement of the ground to be carried out. this shall be agreed upon with the engineer's representative.
- 12. Ferrous pipes shall be wrapped in polyethylene sleeving as corrosion protection when and as directed by the engineer's representative. soil tests shall be carried out in advance of pipe laying to ascertain requirements.
- 13. All dimensions are in millimetres unless stated otherwise.

<u>LEGEND</u>



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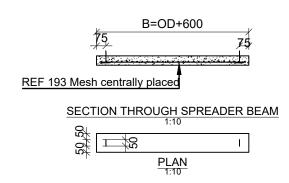
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DRAWING TITLE: STANDARD DRAWINGS
Trenching,Road Crossing and Backfilling Details

	Surveyed by:		
		R.K	
ĺ	Drawn by:		
	,	N.R	
ĺ	Designed by:		
	,	W.G.M	
	Checked by:		
	J.K.K		
i	Date:		
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Backfill as specified Backfill compacted to 90 % MDD

PRECAST CONCRETE LOAD SPREADER BEAM



NOTE


- Where required by local authorities, a concrete pipe or culvert must be used instead of a concrete spreader beam.
- Horizontal directional drilling must be undertaken where specified to the engineer's approval.

TABLE 1: MATERIAL DESCRIPTION CHART

SOIL TYPE	DESCRIPTION	GROUP SYMBOL
Α	Angular, crushed rock negligible fines	-
В	Well graded gravel-sand mixtures few fines	GW
С	Fine Gravel,No fines	GP
D	Gravel-Sand Mix,upto 15% Fines	GF

TABLE 2 : COMPACTION CHART

% MPD SOIL TYPE	COMPACTION METHOD		
	Thickness of Layer (mm)	No. of Passes	
	A AND B	150	1
90	С	150	2
	D	75	2

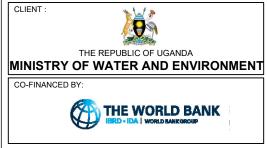

LEGEND



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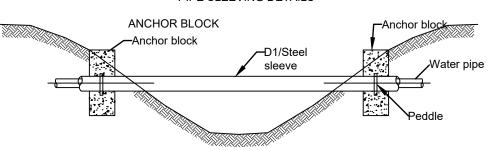
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Trenching,Road Crossing and Backfilling Details


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Designed by:		
	W.G.M	
Checked by:		
•	J.K.K	
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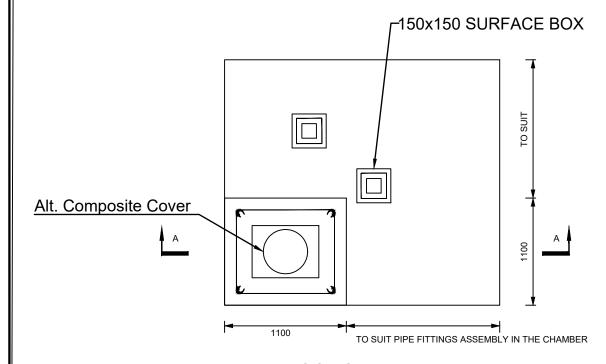
D pipe outside diameter approved

- Granular bedding material (10 20 mm size) compacted in 50 mm layers to a thickness of 100 mm or as directed by the engineer's representative.
- 2. Approved granular bedding material compacted in layers as per note 2. careful tamping on either the pipe should be maintained to ensure equal pressure on both sides of the bedding.
- Approved granular bedding material compacted in shallow layers to a maximum of 150 mm thick a,b,c and 75 mm thick type d.
- 4. As in above, but excessive tamping to be avoided.
- 5. Normal backfill material properly rammed in layers. not exceeding 150 mm thick.
- 6. Approved granular backfill material compacted to 90 % mpd in layers as per note 2.




PLAN NOTE 3 LA 393 Mesh reinforcement **SECTION A-A**

SECTIONAL PLAN A-A

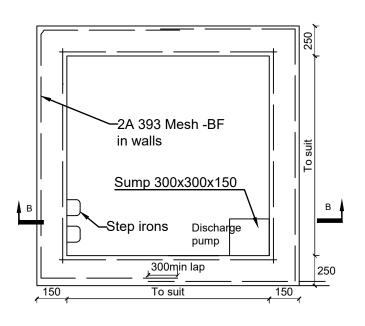

ROOF SLAB

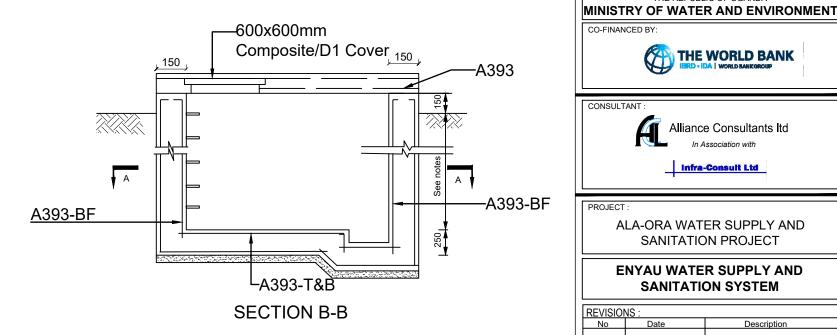

NOTES

- 1. Floor of chamber to be 250 below pipe IL.
- 2. Fore details of cover slab see General notes.



LEGEND

THE WORLD BANK




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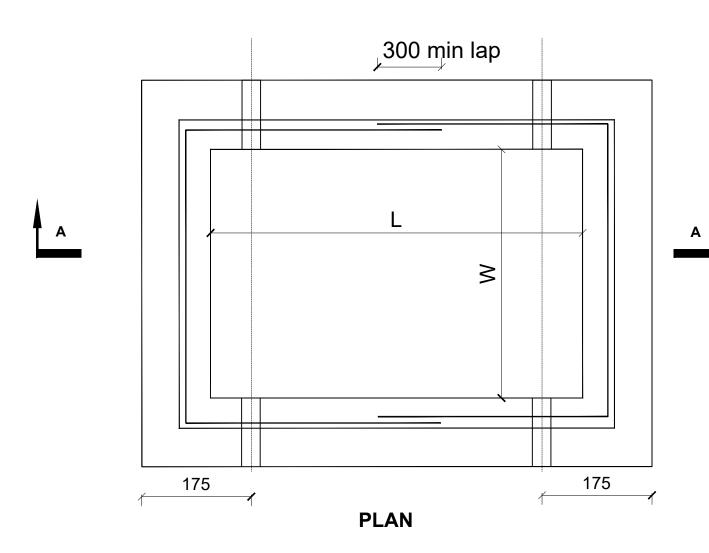
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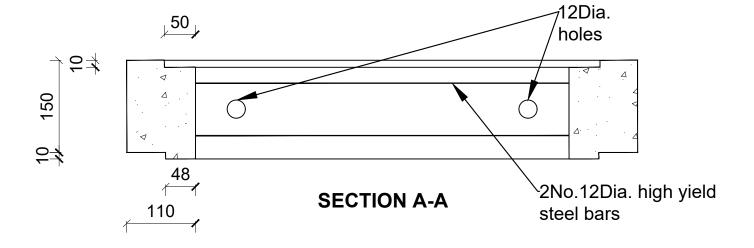
DRAWING TITLE: STANDARD DRAWINGS Reinforcement Details for Washout/Gate Valve **Chamber and Roof Slab Details**

Surveyed by:		
	R.K	
Drawn by:		
,	N.R	
Designed by:		
	W.G.M	
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J.K.K		
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TYPE	L	W
А	430	200
В	600	450
С	750	600
D	900	600
E	1200	600
F	1200	900



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PROJECT:

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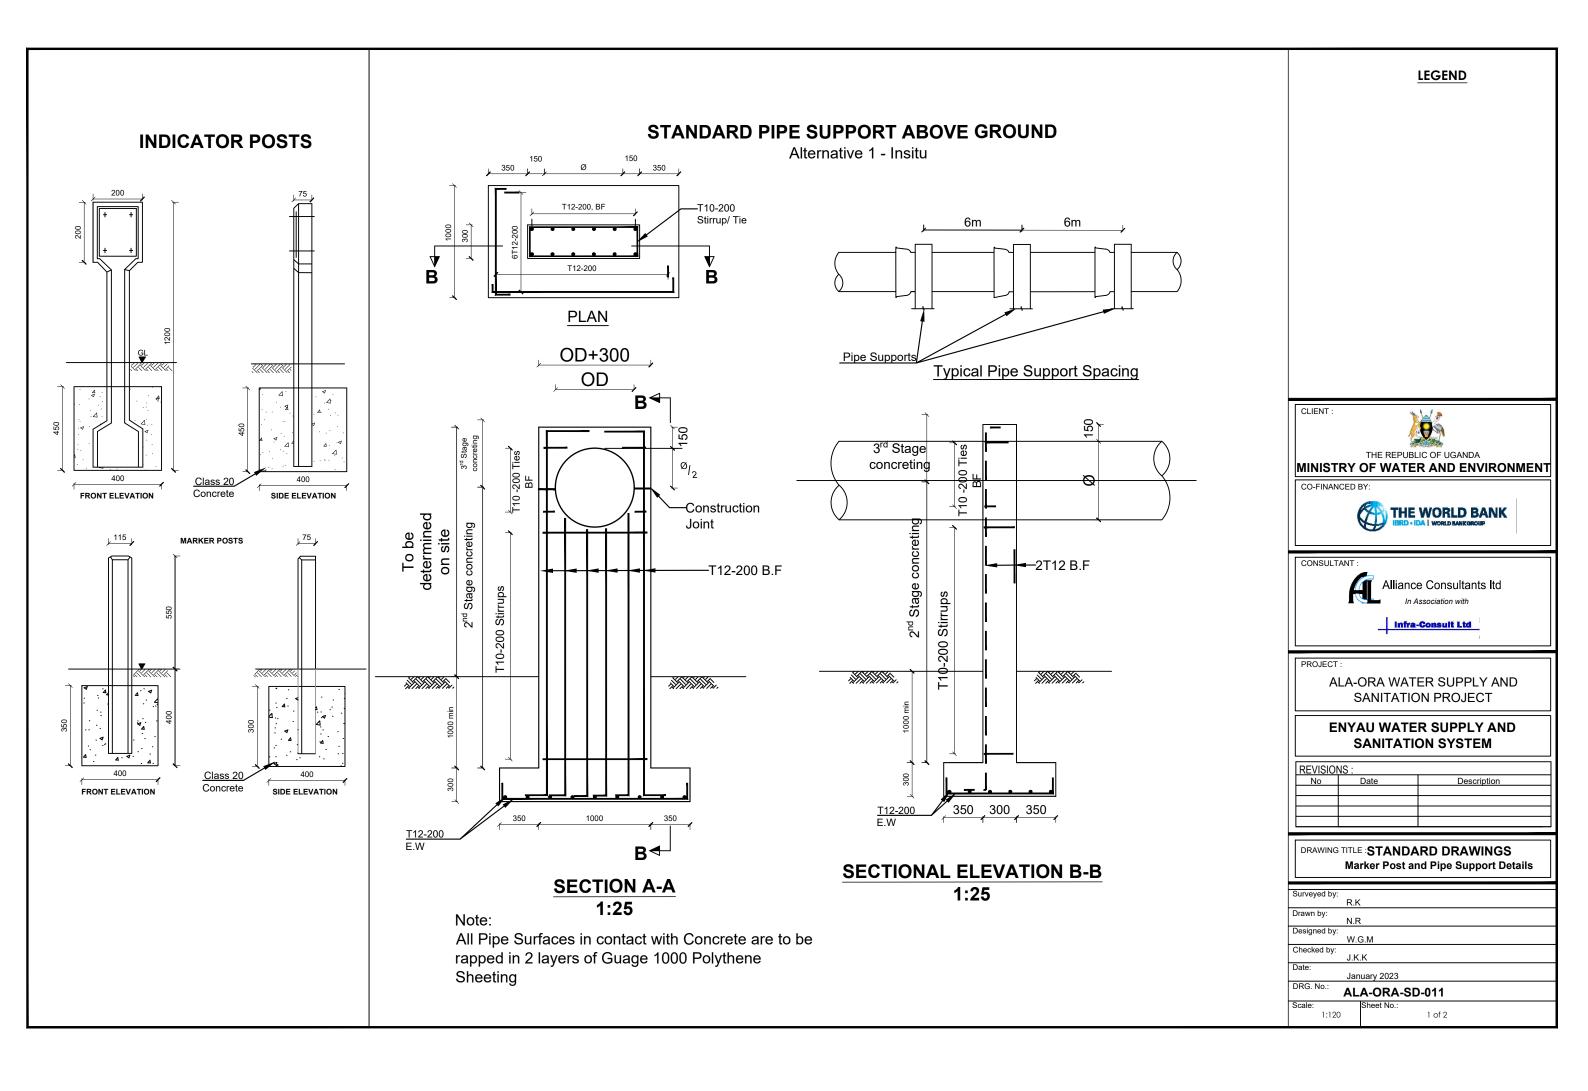
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DRAWING TITLE: STANDARD DRAWINGS

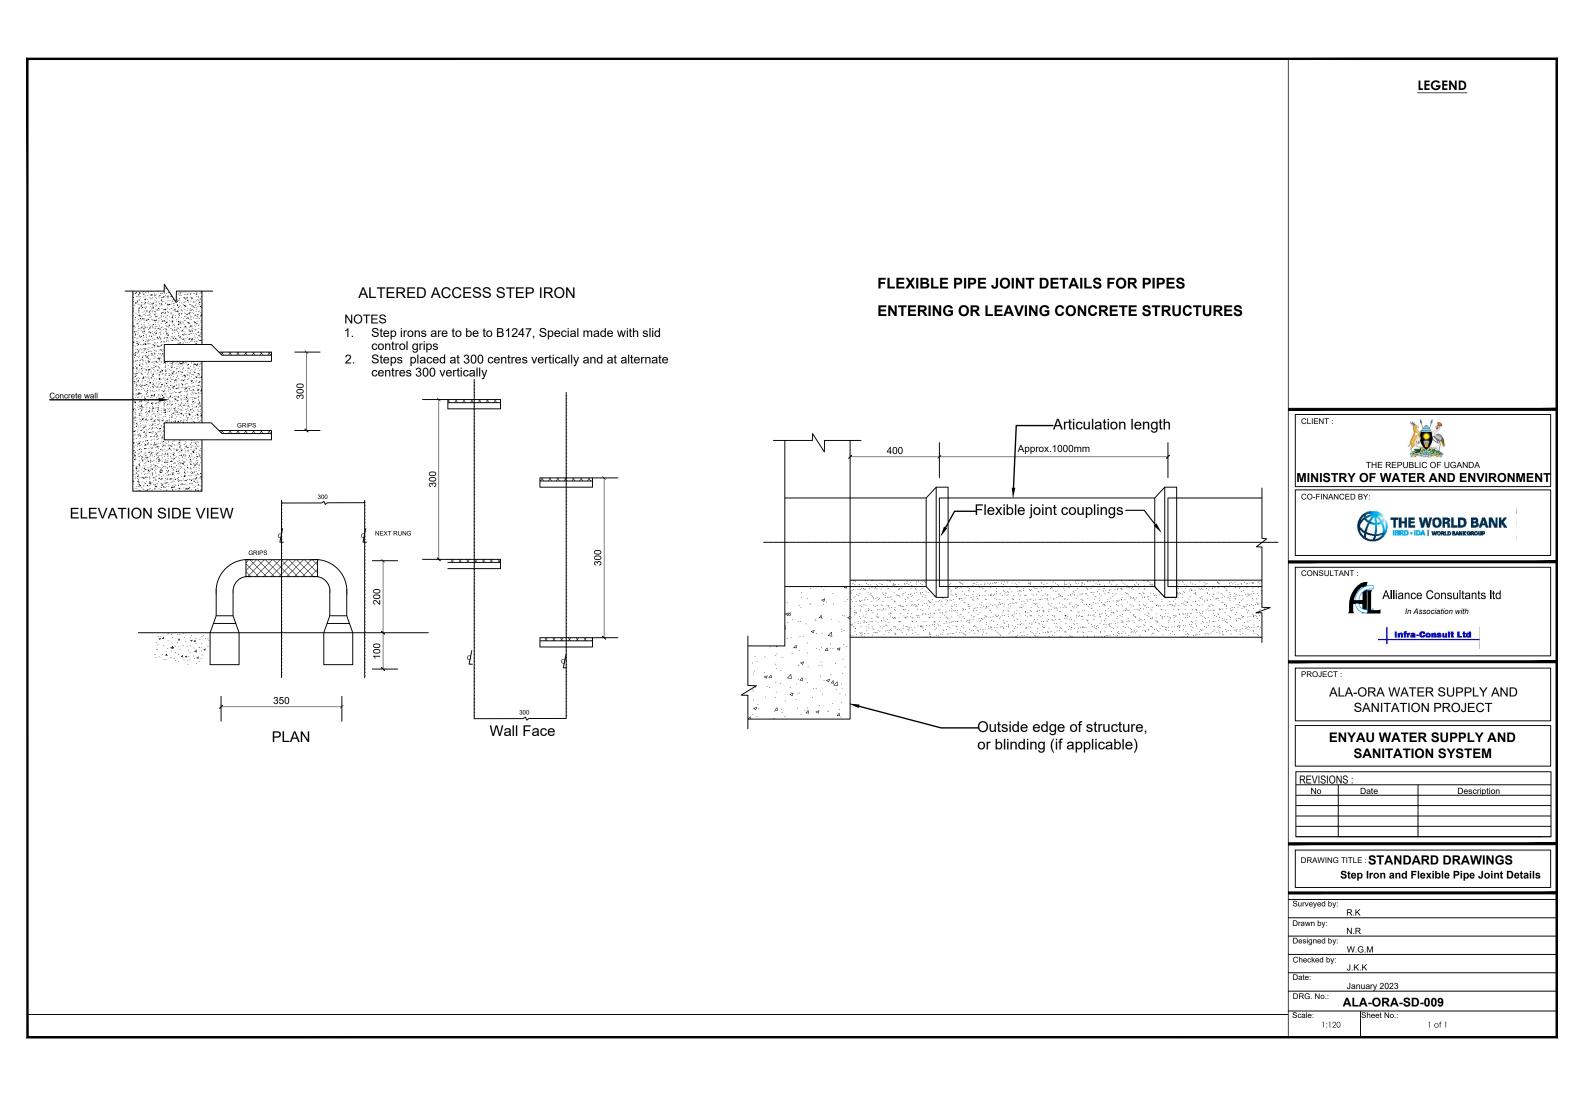
Precast Chamber Cover slab and Section


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STANDARD PIPE SUPPORT ABOVE GROUND

Alternative 2 - Insitu with a precast concrete strap



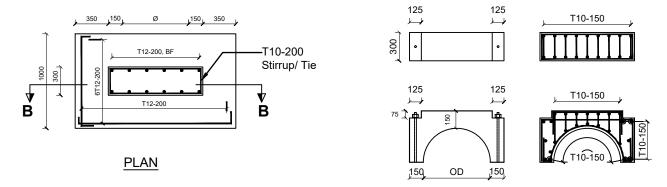

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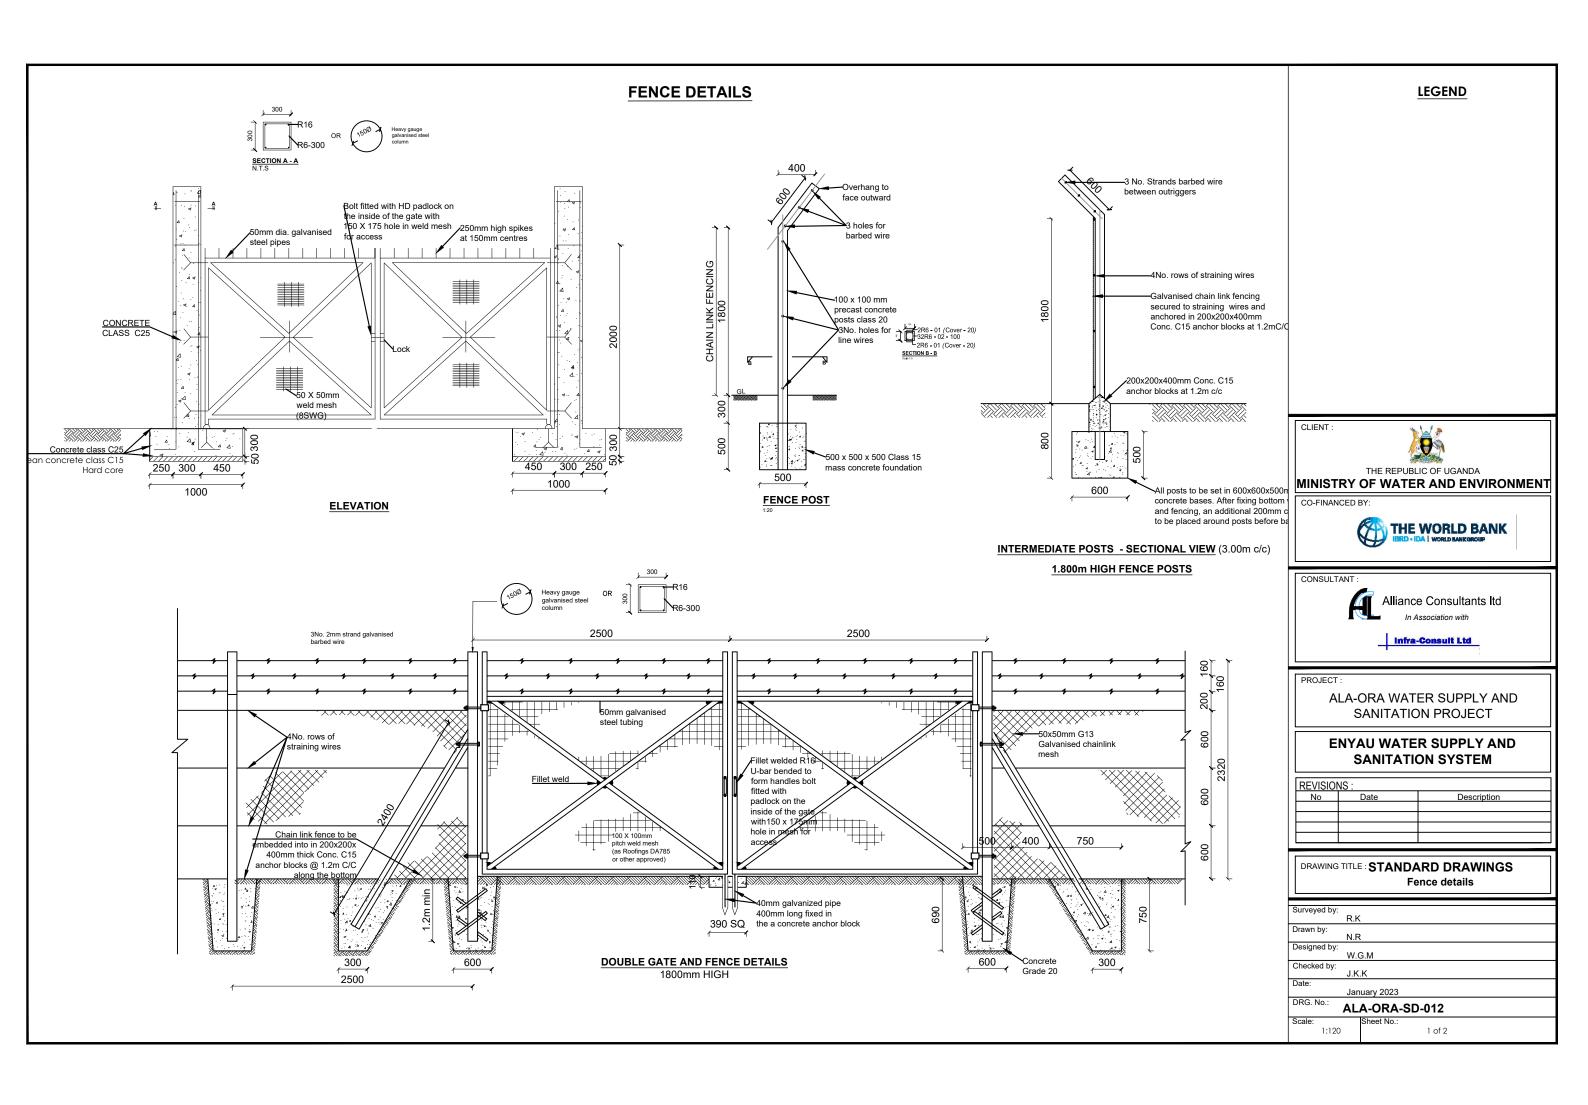
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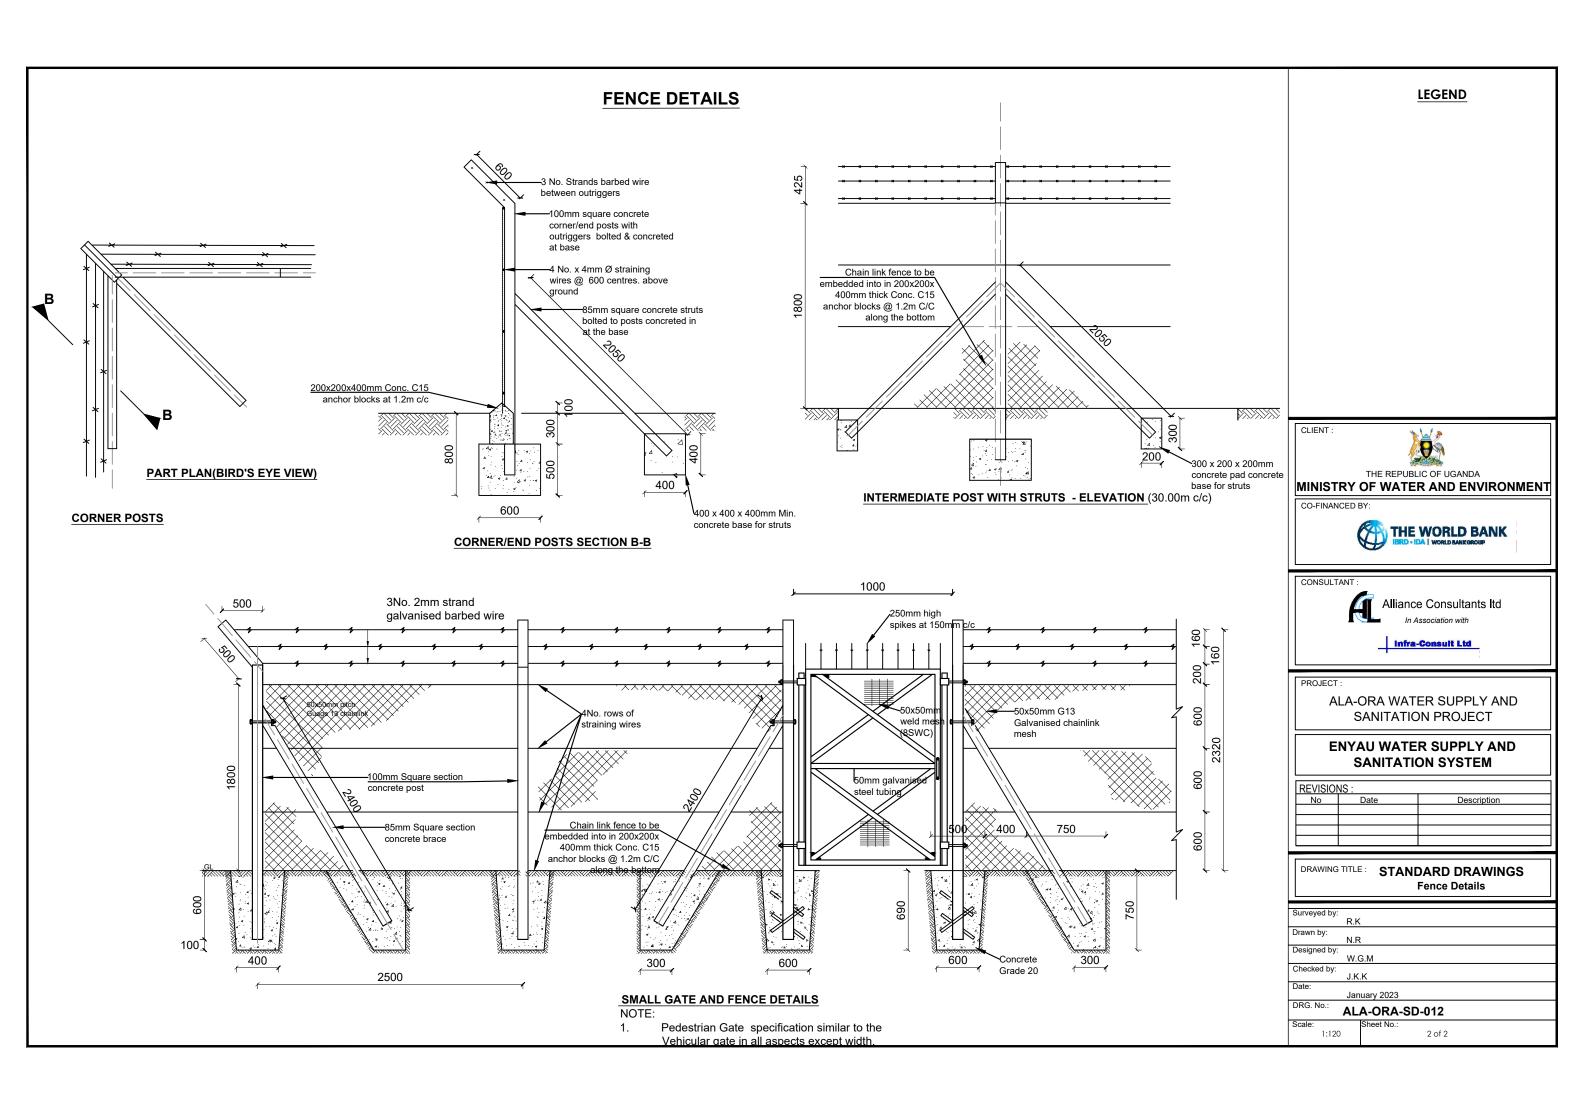
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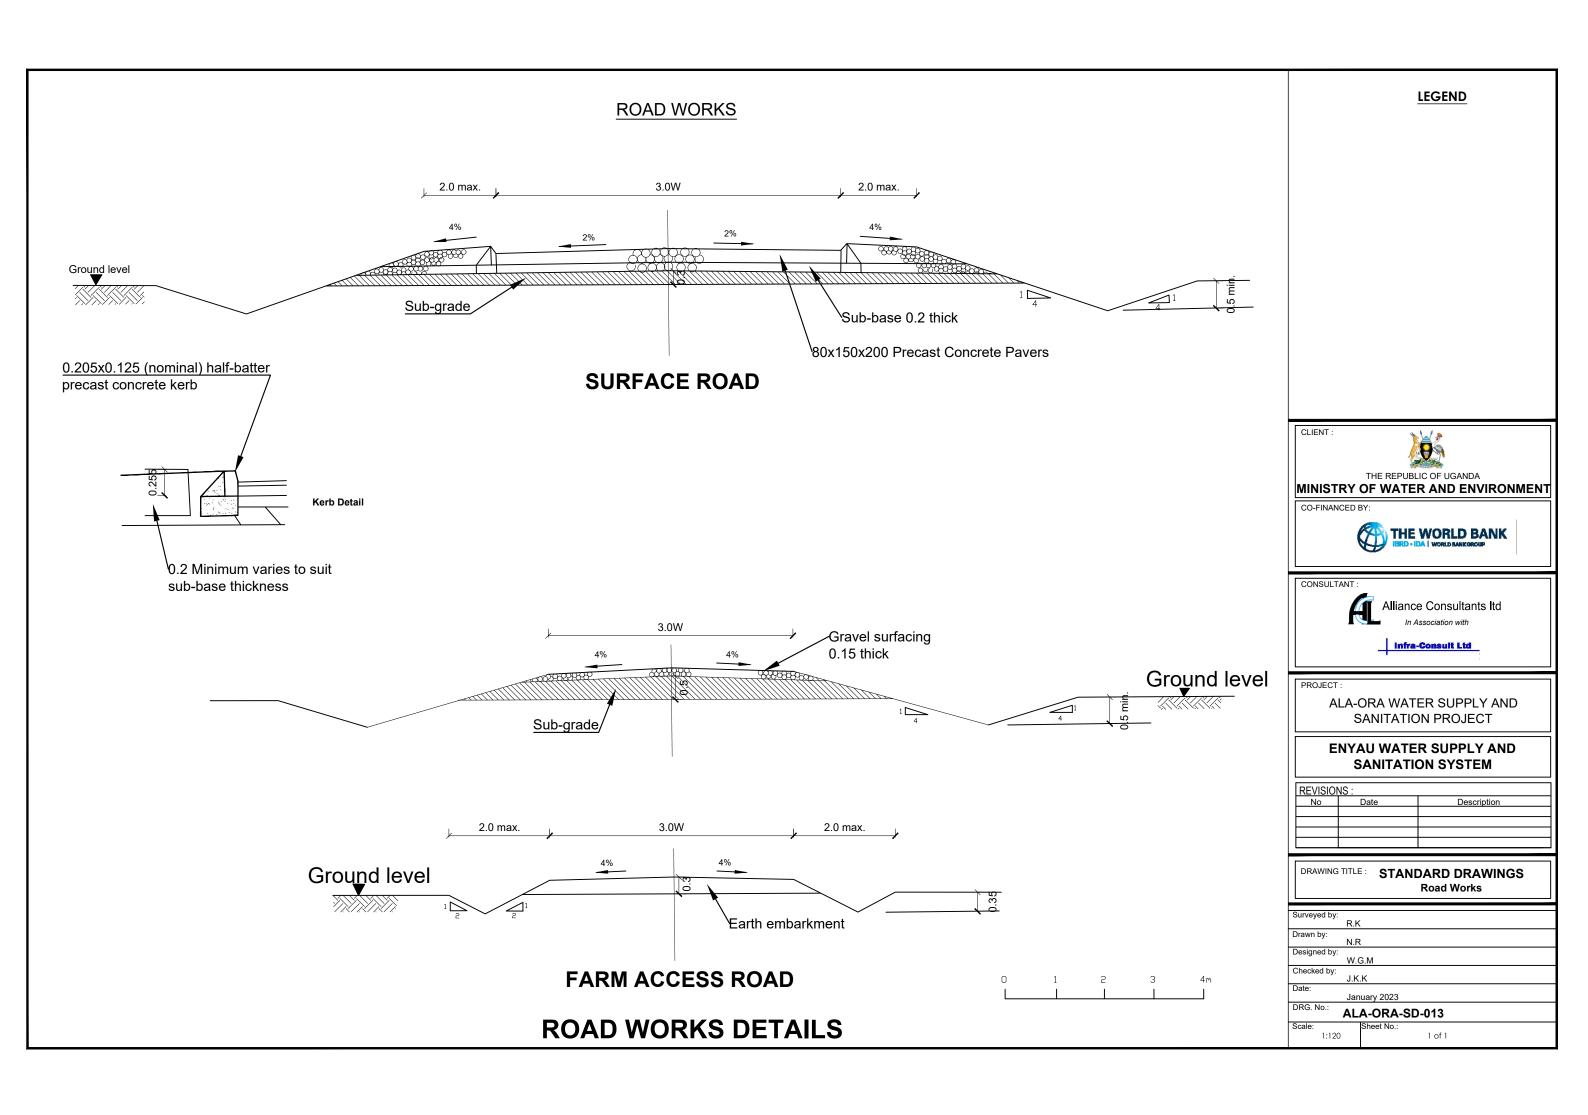
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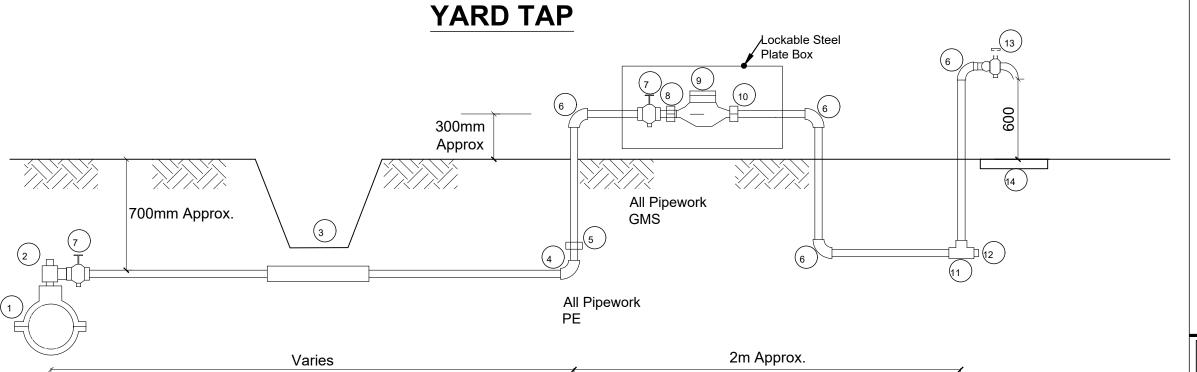
Marker Post and Pipe Support Details

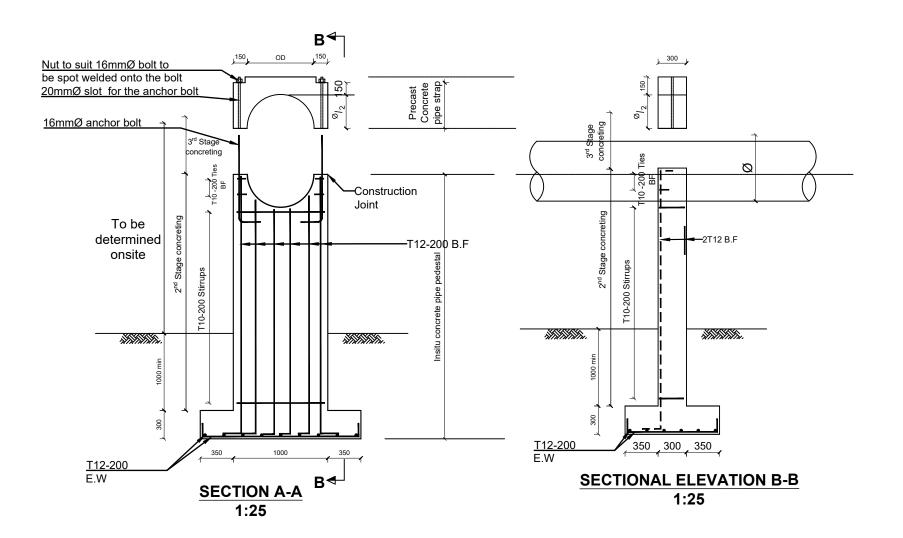Surveyed by:	
F	R.K
Drawn by:	
1	I.R
Designed by:	
' '	V.G.M
Checked by:	
ĺ	.K.K
Date:	
	anuary 2023
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SCHEDULE OF FITTINGS

ITEM NO.	DESCRIPTION	NO. REQUIRED PER CONNECTION
1.	PVC Saddle Clamp	1
2.	PE Outlet type swivel ferule	1
3.	1m Length GMS sleeve	1 (optional)
4.	PE Elbow	1
5.	PE/GMS Adaptor	4
6.	GMS Elbow	3
7.	Stop cock	1
8.	Male threaded connector	1
9.	Water meter	1
10.	Adjusting coupling	1
11.	GMS equal tee	1
12.	Plug	1
13.	Тар	3
14.	600x600x50mm RC precast reinfo	orced 1
15.	with a G10 (3.0mm Ø x 60 x 60mm Purpose made Lockable Meter pro	• ,
	made of 3mm Ms plate Complete i Painting and a 50mm Padlock	including

NOTES:

- GMS pipe ends to be screwed with tapered threads to ISO
 R7 and to be supplied with sealing PTFE tape
- GMS pipe fittings to be malleable cast iron to BS 143 and BS 1256 with female threaded ends
- The adjusting coupling shall be made of bronze or brass with a threaded female connection at the outlet end. It shall incorporate sufficient adjustment to permit removal at the meter
- 4. All PE connections shall be of the push fit type
- 5. Diameter of pipe varies
- 6. The Meter Protection shall be robust and be able to enclose the Meter and Stop clocks.

LEGEND

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PROJECT :

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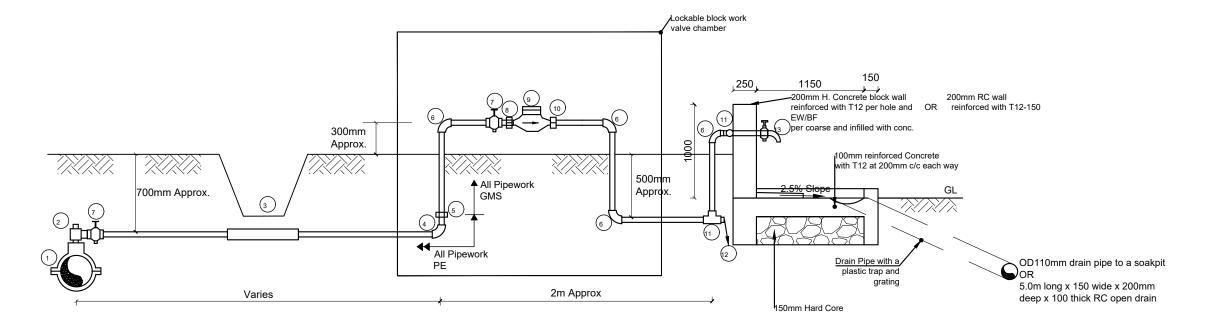
ENYAU WATER SUPPLY AND SANITATION SYSTEM

REVISIO	REVISIONS:						
No	Date Description						

DRAWING TITLE: STANDARD DRAWINGS
Tape Yard

Surveyed by:	
, ,	R.K
	TAIX
Drawn by:	
	N.R
Designed by:	
Designed by.	WON
	W.G.M
Checked by:	
	J.K.K
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STAND POST 20mm GI pipe 250 Concrete C25 It 1400 Sooksway Somm Blinding 150 Sooksway SECTION B-B C25 conc



SCHEDULE OF FITTINGS

ITEM NO.	DESCRIPTION	NO. REQUIRED PER CONNECTION	
1.	PVC Saddle Clamp	1	
2.	PE Outlet type swivel ferule	1	
3.	1m Length GMS sleeve	1 (optional)	NOTES:
4.	PE Elbow	1	GMS pipe ends to be screwed with tapered threads to ISO
5.	PE/GMS Adaptor	1	R7 and to be supplied with sealing PTFE tape
6.	GMS Elbow	6	2. GMS pipe fittings to be malleable cast iron to BS 143 and
		•	BS 1256 with female threaded ends
7.	Stop cock	3	3. The adjusting coupling shall be made of bronze or brass
8.	Male threaded connector	1	with a threaded female connection at the outlet end. It shall
9.	Water meter	1	incorporate sufficient adjustment to permit removal at the
10.	Adjusting coupling	1	meter
11.	GMS equal tee	3	4. All PE connections shall be of the push fit type
12.	Plug	1	5. Diameter of pipe varies
13.	Тар	3	6. The Meter Protection shall be robust and be able to enclose
	· ~P	Š	the Meter and Stop clocks.

NOTE:

Soak pit to be 2.0m Ø by 2.0m deep with hardcore fill of 300mm min size covered with 2 layers of gauge 1000 polythene sheet

<u>LEGEND</u>

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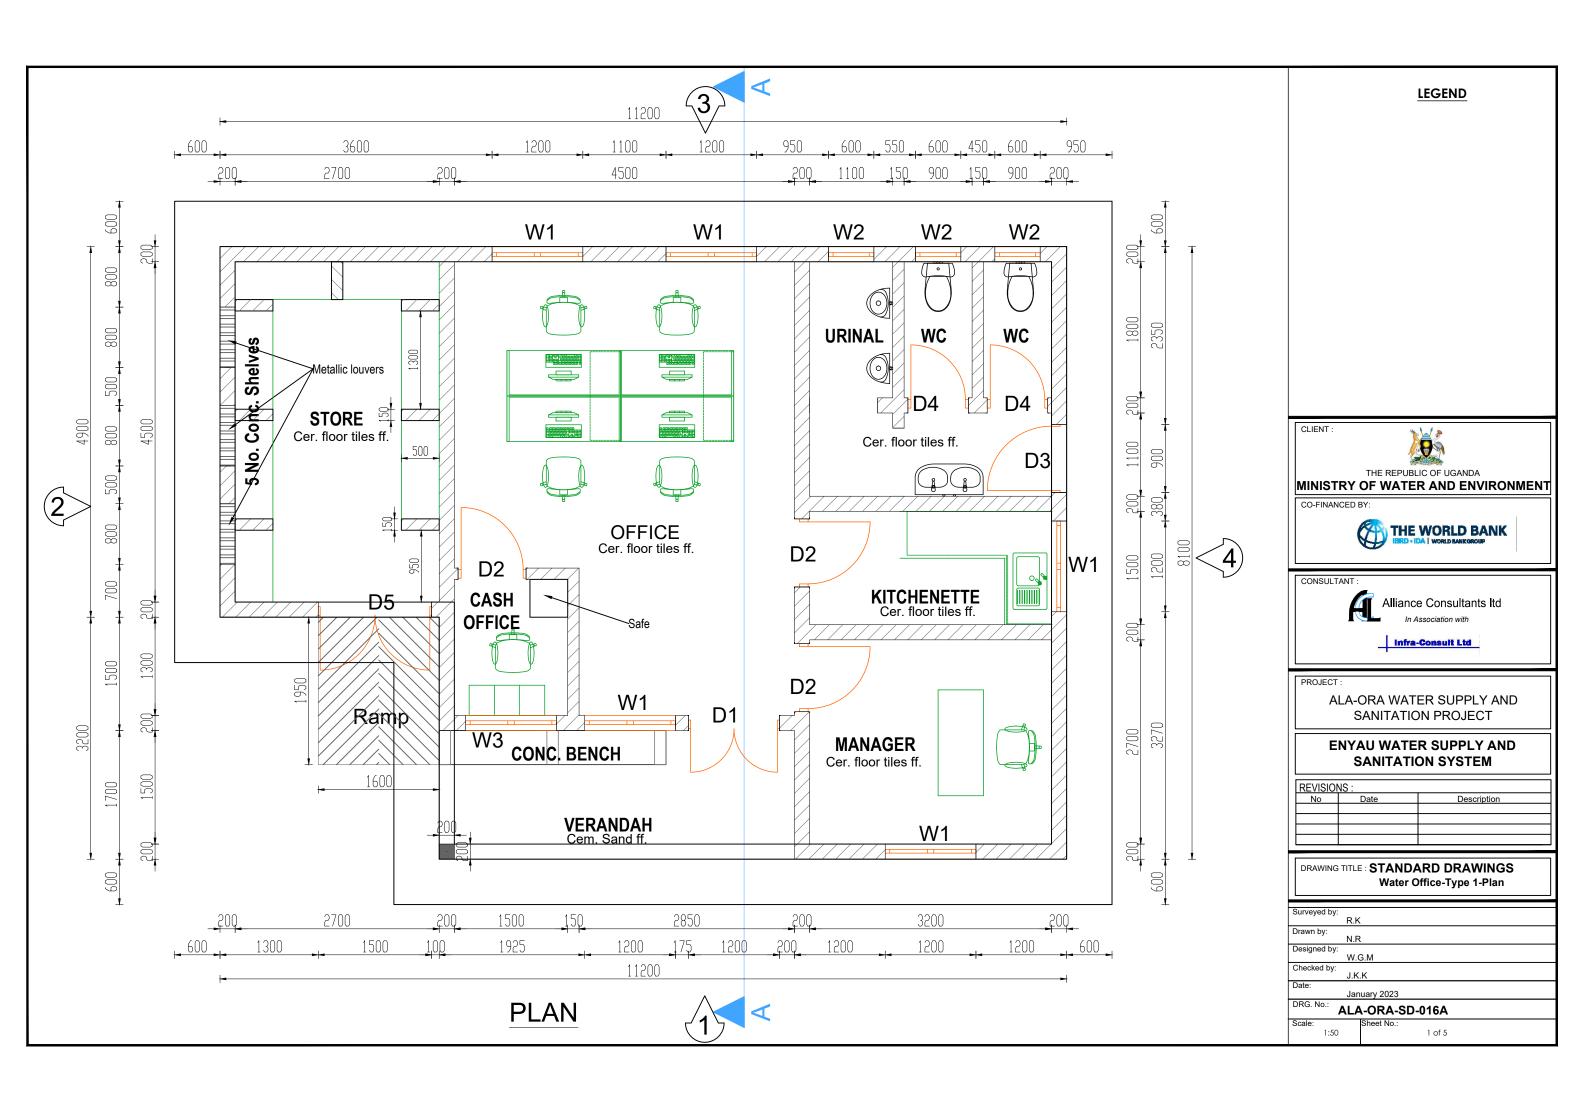
ALA-ORA WATER SUPPLY AND SANITATION PROJECT

ENYAU WATER SUPPLY AND SANITATION SYSTEM

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DRAWING TITLE: STANDARD DRAWINGS
Stand Post

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Surveyed by:	
	R.K
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	N.R
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	W.G.M
	VV.G.IVI
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	J.K.K
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ROOF NOTES: pitch 25° Fire clay ridge cap/Mangalore roofing tiles on 50 X 25 timber battens with gauge 32 GI plane sheet Pressure treated roofing soft wood timber Double 100 x 50 mm timber rafters with 100x 50mm struts & ties in truss with 75 x 50 mm purlins on 150 x 50mm tie beam on 150 x 75 mm wall plate 250 mm plastic fascia boards CEILING CONSTRUCTION NOTES: 20mm thick Cement and sand plaster on Expanded Metal Lathing on 100 x 50mm Ceiling branderings at 600mm centres 100 x 50mm Ceiling joists at 1200mm centres 200 x 200mm C20 RCC Ring Beam Note All worktops should have 200mm high vent 200mm high vent granite finish **OFFICE** 200mm thick blockwall superstructure plastered on both sides SPLASH APRON FINISH Cem. screed with steel float finish on 30mm cem: sand (1:3) thick rendered on outer side LOOR CONSTRUCTION NOTES 300mm below GL. 6mm thick ceramic wall tile skirting on 8mm thick ceramic floor tiles on 25mm cement and sand (1:3) screed on 600 200 200 200 100mm C15 Reinforced cement concrete slab/ A142 BRC on 600 x 200 mm plain cement concrete C15 strip fdn 200mm Hardcore stone bed blinded with 50mm sand 150mm selected well compacted natural murram filling

SECTION A-A

LEGEND

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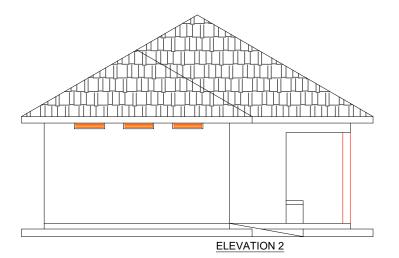
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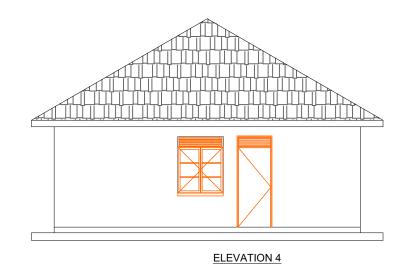
DRAWING TITLE: STANDARD DRAWINGS
Water Office-Type 1- Section

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sandwiched with coffeetray mesh.

All metallic window & Door sections to be 3.0mm minimum thickness

Door Schedule						Window Schedule			
Door Name	D1	D2	D3	D4	D5	Window Name	W1	W2	W3
Quantity	2	3	1	2	1	Quantity	5	3	1
W x H Size	1200x2400	900x2400	900x2400	800x2400	1500x2400	W x H Size	1200x1500	600x900	1200 X 1500
Elevation View	B Double Leaf Metalic Casement Door	Single Leaf Wooden Paneled Door	Single Leaf Half Glazed/ Half Steel plate Door	Single Leaf Wooden Paneled Door	Double Leaf Metalic Casement Door		Double Sash Glazed Metalic Casement e ≤ 0.2m to be of a 25x3mm flat are to be fitted with mo	Casement bar grille with 175x3	

LEGEND

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ENYAU WATER SUPPLY AND SANITATION SYSTEM


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DRAWING TITLE: STANDARD DRAWINGS
Water Office-Type 1- Elevations

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, M	/.G.M
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fall fall

ROOF LAYOUT



FOUNDATION LAYOUT

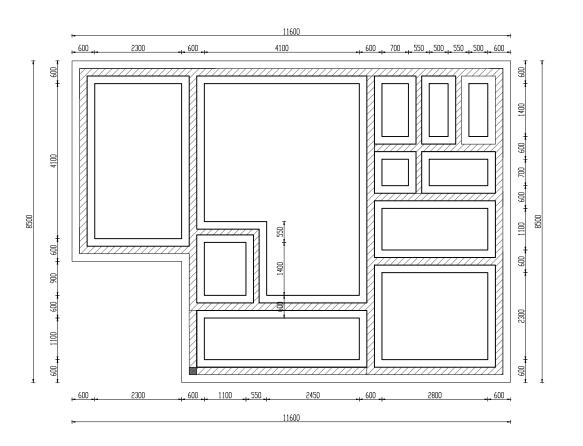LEGEND

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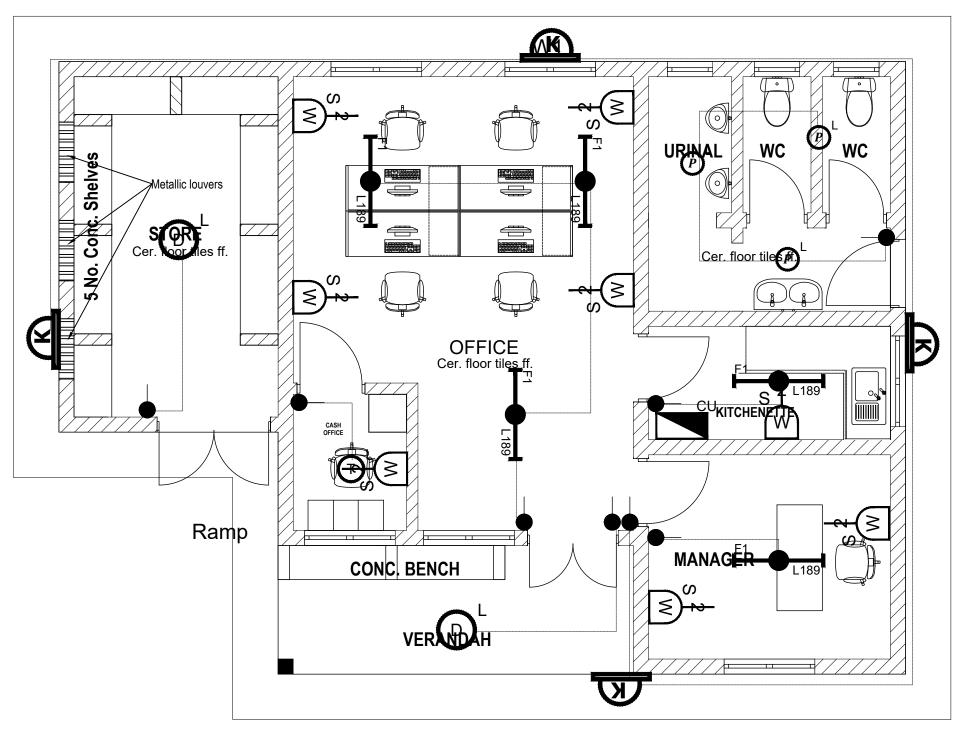
ALA-ORA WATER SUPPLY AND SANITATION PROJECT

ENYAU WATER SUPPLY AND SANITATION SYSTEM

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No	Date	Description
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DRAWING TITLE: STANDARD DRAWINGS
Water Office-Type 1-Foundation & Roof Layout

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, N.R		
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W.0	G.M	
Checked by:		
J.K.	.K	
Date:		
Jan	uary 2023	
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- 1). ALL WALL BRACKETS SHALL BE MOUNTED 1800mm ABOVE FINISHED FLOOR LEVEL
- 2). TELEPHONE, SOCKETS, T.V AND COMPUTER OUTLETS SHALL BE MOUNTED 300mm ABOVE FINISHED FLOOR LEVEL EXCEPT WHERE THEIR IS A WORKTOP.
- $3). \ WHERE\ THEIR\ IS\ A\ WORKTOP, TELEPHONE,\ SOCKETS, T.V\ AND\ COMPUTER\ OUTLETS\ SHALL\ BE\ MOUNTED\ 150mm\ ABOVE\ WORKTOPS.$
- 4). CONSUMER UNITS SHALL BE 1800mm ABOVE FINISHED FLOOR LEVEL
- 5). ALL SWITCHES SHALL BE 1400mm ABOVE FINISHED FLOOR LEVEL
- 6). ALL OUTSIDE SOCKETS SHOULD BE WEATHER PROOF
- 7). ALL SHAVER SOCKETS SHOULD BE ON THE RIGHT HAND SIDE OF THE WASH HAND BASIN
- 8). ALL CABLES MUST BE STRANDED

SYMBOL	DESCRIPTION
F1	1200mm 18W LED batten with a removable LED engine. IP20 As Thom PopPack LED. or equal approved. (Light Type F1)
0	Pedant lighting fitting comprising ceiling Rose 300mm 3x1.5mm flexible copper cable lamp holder and 6W LED Lamp
Ø,	Pedant lighting fitting comprising ceiling Rose 300mm 3x1.5mm ² flexible copper cable lamp holder and 6WLED Lamp
®∟	Pedant lighting fitting comprising ceiling Rose 300mm 3x1.5mm flexible copper cable lamp holder and 6W LED Lamp
<u>©</u>	Decorative Bed side lamp complete with flexible spot light arm as LEDS-C4 BALI (05-3217-19-82 + PAN-157-BY) to client's approval.
A	wall mounted light
ф	Socket outlet on Wall
Cu	Consumer's Unit
¥	One Gang 2way Switch
W	Two Gang 2way Switch
MAX	Three Gang 2way Switch
•	One Gang Iway Switch
₩	Two Gang Iway Switch
44	Three Gang Iway Switch
重	Intermediate Switch
PC	Photo - Cell

CLIENT :



MINISTRY OF WATER AND ENVIRONMENT

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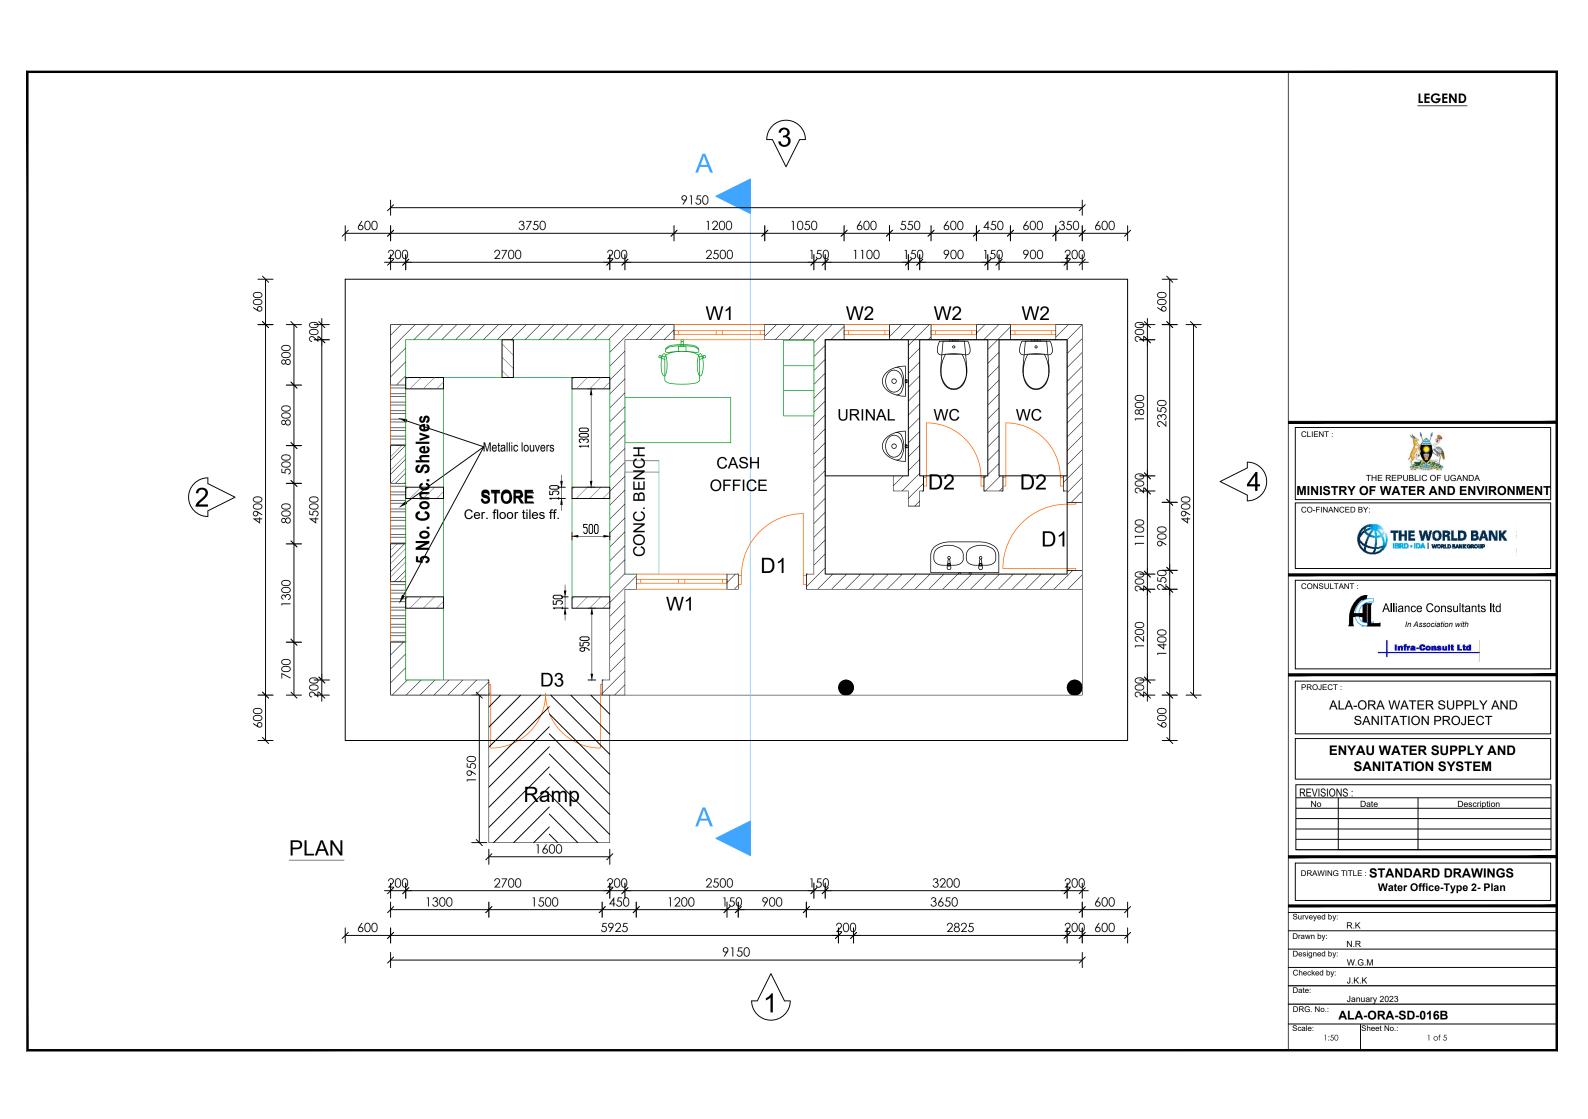
ENYAU WATER SUPPLY AND SANITATION SYSTEM


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No	Date	Description
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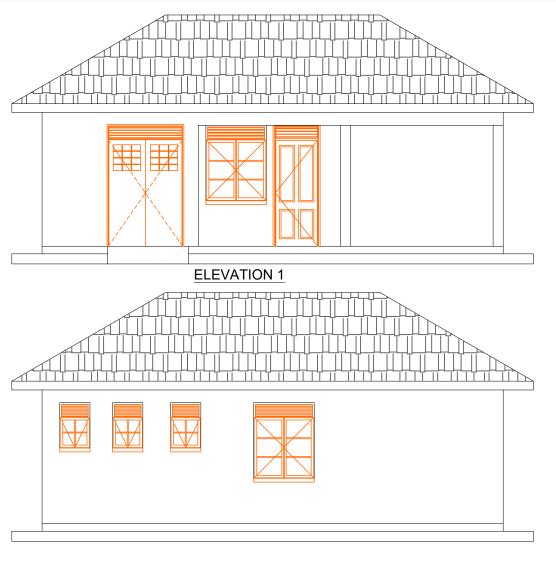
DRAWING TITLE: STANDARD DRAWINGS

Water Office-Type 1- Electrical layouts

Surveyed by:	
curreyed by.	R.K
Drawn by:	
	N.R
Designed by:	
,	W.G.M
Checked by:	
,	J.K.K
Date:	
	January 2023
DRG. No.:	N. A. O.D.A. O.D. O.4.O.A.
,	ALA-ORA-SD-016A
Scale:	Sheet No.:
1:50	5 of 5






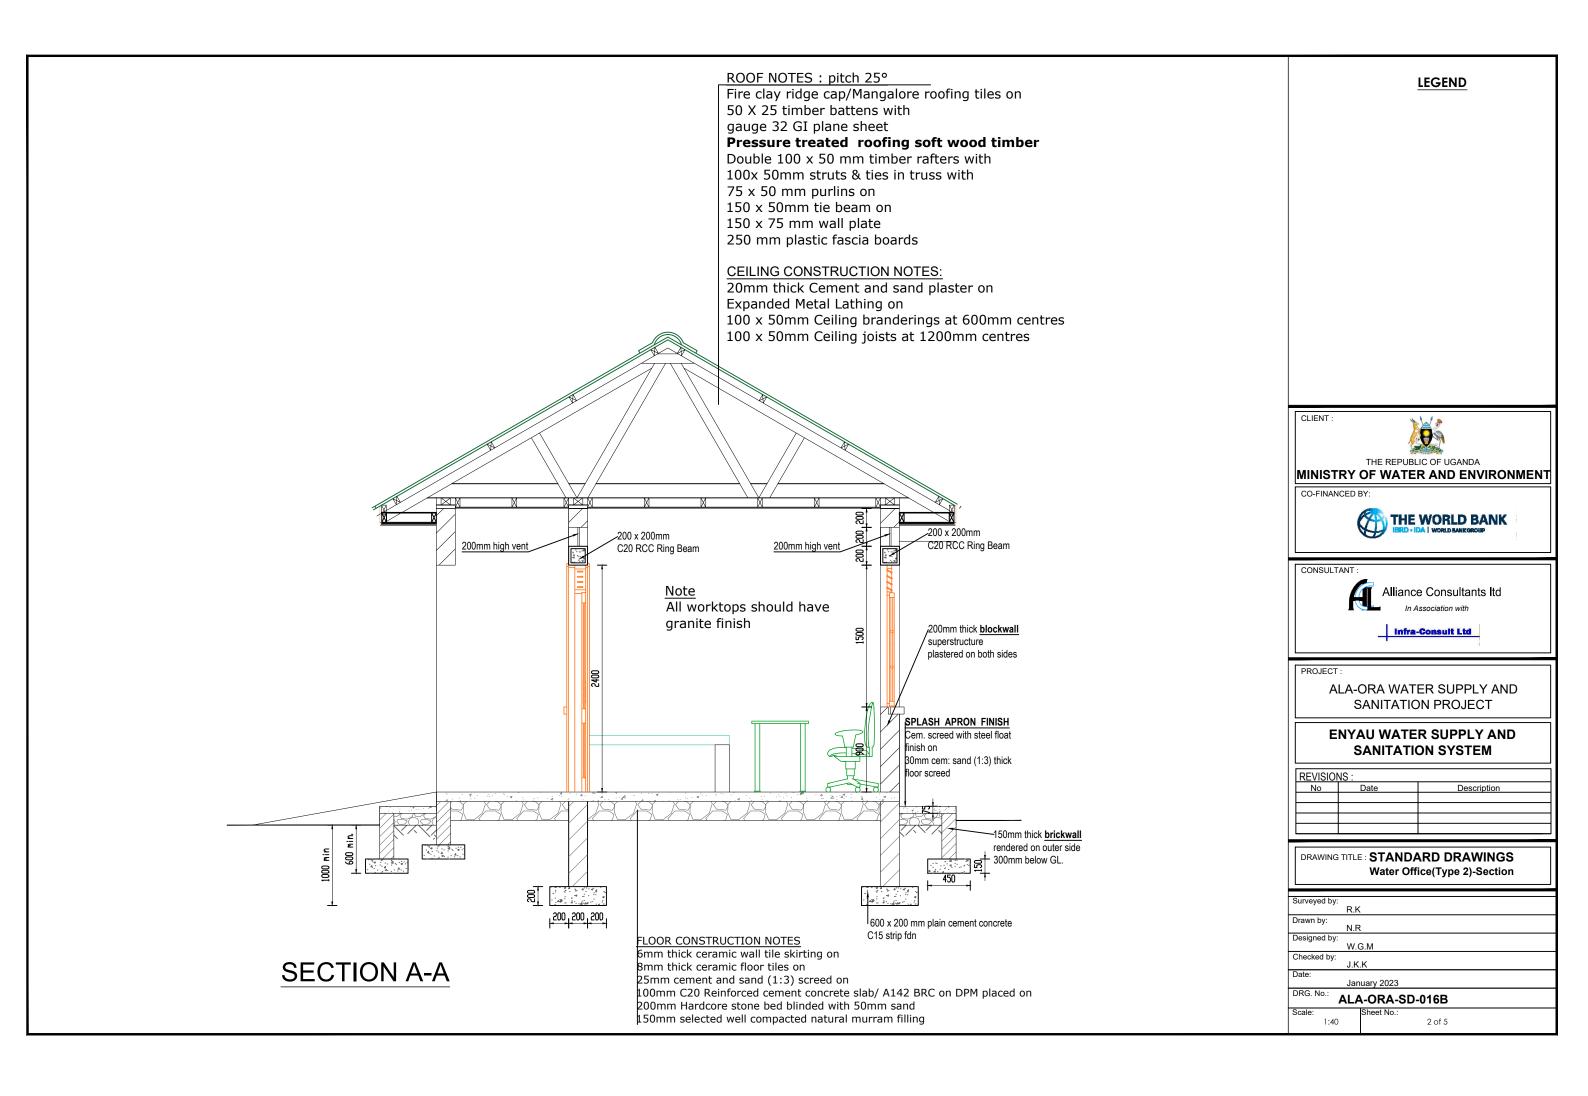

Single Leaf Wooden

Paneled Door

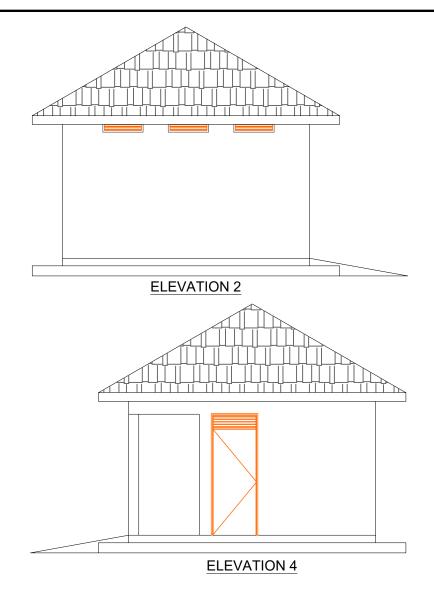

Permanent Vents are to be fitted with mosquito proofing nets i.e plastic net

All metallic window & Door sections to be 3.0mm minimum thickness

sandwiched with coffeetray mesh.

ELEVATION 3

Casement Door

Door Schedule Window Schedule W3 **Door Name** D1 D2 D3 D4 D5 Window Name W1 W2 Quantity 2 3 2 Quantity 5 3 1 1 W x H Size 1500x2400 W x H Size 600x900 1200 X 1500 1200x2400 900x2400 900x2400 800x2400 1200x1500 **Elevation View Elevation View** Double Sash Glazed Top Hung Metalic Metallic Double Metalic Casement Glass panes to be ≤ 0.2m² Casement sash sliding Single Leaf Half Double Leaf Metalic Burglar proofing to be of a 25x3mm flat bar grille with 175x300mm pitch.

Double Leaf Metalio

Casement Door

Single Leaf Wooden

Paneled Door

Glazed/ Half Steel

plate Door

LEGEND

CLIENT :



THE REPUBLIC OF UGANDA MINISTRY OF WATER AND ENVIRONMENT

CO-FINANCED BY:



CONSULTANT



Alliance Consultants Itd

ALA-ORA WATER SUPPLY AND SANITATION PROJECT


ENYAU WATER SUPPLY AND SANITATION SYSTEM

REVISION	NS :	
No	Date	Description
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DRAWING TITLE: STANDARD DRAWINGS Water Office(Type 2)-Elevations

	
•	
Surveyed by:	
, ,	R.K
	TAIN
Drawn by:	
•	N.R
Designed by:	
Designed by.	M/ C M
	W.G.M
Checked by:	
bu bj.	J.K.K
D-4	VALAN
Date:	
	January 2023
DRG. No.:	
<i>[</i>	ALA-ORA-SD-016B
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1:75	3 of 5
	<u> </u>

fall fall fall fall fall fall fall fall ROOF LAYOUT

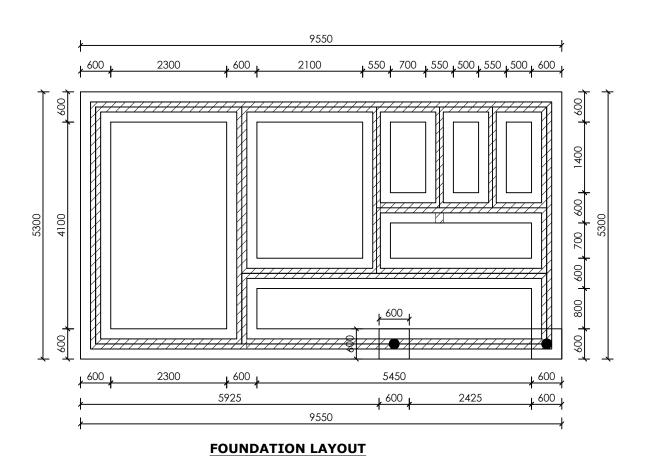

LEGEND

CLIENT :



MINISTRY OF WATER AND ENVIRONMENT

CO-FINANCED BY:



CONSULTANT :



Alliance Consultants Itd

Infra-Consult Ltd

PROJECT


ALA-ORA WATER SUPPLY AND SANITATION PROJECT

ENYAU WATER SUPPLY AND SANITATION SYSTEM

REVISIO	NS :	
No	Date	Description

DRAWING TITLE: STANDARD DRAWINGS
Water Office(Type 2)-Roof and Foundation Layout

Surveyed by:	
	.K
Drawn by:	
	.R
Designed by:	
V	/.G.M
Checked by:	
J	K.K
Date:	
J	anuary 2023
DRG. No.:	4 OD4 OD 040D
AL	.A-ORA-SD-016B
Scale:	Sheet No.:
1:75	4 of 5

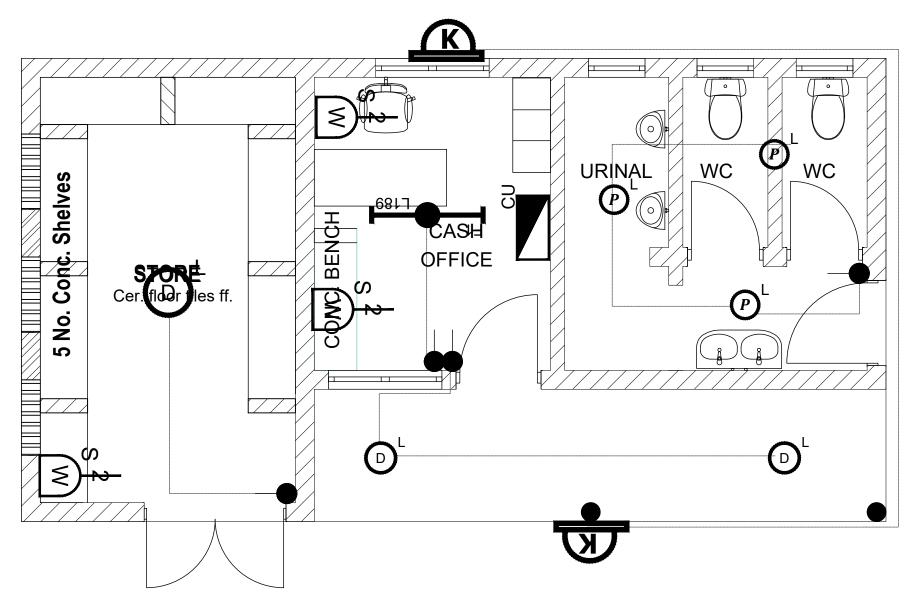

PLAN

- 1). ALL WALL BRACKETS SHALL BE MOUNTED 1800mm ABOVE FINISHED FLOOR LEVEL
- 2). TELEPHONE, SOCKETS, T.V AND COMPUTER OUTLETS SHALL BE MOUNTED 300mm ABOVE FINISHED FLOOR LEVEL EXCEPT WHERE THEIR IS A WORKTOP.
- 3). WHERE THEIR IS A WORKTOP, TELEPHONE, SOCKETS, T.V AND COMPUTER OUTLETS SHALL BE MOUNTED 150mm ABOVE WORKTOPS.
- 4). CONSUMER UNITS SHALL BE 1800mm ABOVE FINISHED FLOOR LEVEL
- 5). ALL SWITCHES SHALL BE 1400mm ABOVE FINISHED FLOOR LEVEL
- 6). ALL OUTSIDE SOCKETS SHOULD BE WEATHER PROOF
- 7). ALL SHAVER SOCKETS SHOULD BE ON THE RIGHT HAND SIDE OF THE WASH HAND BASIN
- 8). ALL CABLES MUST BE STRANDED

SYMBOL	DESCRIPTION
F1 C L189	1200mm 18W LED batten with a removable LED engine. IP20 As Thorn PopPack LED. or equal approved. (Light Type F1)
O'	Pedant lighting fitting comprising ceiling Rose 300mm 3x1.5mm flexible copper cable lamp holder and 6W LED Lamp
Ø.	Pedant lighting fitting comprising ceiling Rose 300mm 3x1.5mm ² flexible copper cable lamp holder and 6WLED Lamp
®⊔	Pedant lighting fitting comprising ceiling Rose 300mm 3x1.5mm flexible copper cable lamp holder and 6W LED Lamp
<u>©</u>	Decorative Bed side lamp complete with flexible spot light arm as LEDS-C4 BALI (05-3217-19-82 + PAN-157-BY) to client's approval.
A	wall mounted light
ф	Socket outlet on Wall
Cu	Consumer's Unit
¥	One Gang 2way Switch
**	Two Gang 2way Switch
W	Three Gang 2way Switch
•	One Gang Iway Switch
₩	Two Gang Iway Switch
44	Three Gang Iway Switch
重	Intermediate Switch
PC	Photo - Cell

CLIENT :



THE REPUBLIC OF UGANDA MINISTRY OF WATER AND ENVIRONMENT

CO-FINANCED BY



CONSULTANT :



Alliance Consultants Itd

Infra-Consult Ltd

PROJEC

ALA-ORA WATER SUPPLY AND SANITATION PROJECT


ENYAU WATER SUPPLY AND SANITATION SYSTEM


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No	Date	Description			
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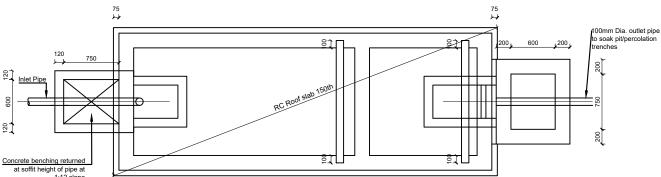
DRAWING TITLE: STANDARD DRAWINGS
Water Office(Type 2)-Electrical Layout

Surveyed by:		
R.K		
Drawn by:		
N.R		
Designed by:		
W.(9.M	
Checked by:		
, J.K	K	
Date:		
Jan	uary 2023	
DRG. No.:		
ALA	-ORA-SD-016B	
Scale:	Sheet No.:	
1:40	5 of 5	


SEPTIC TANK



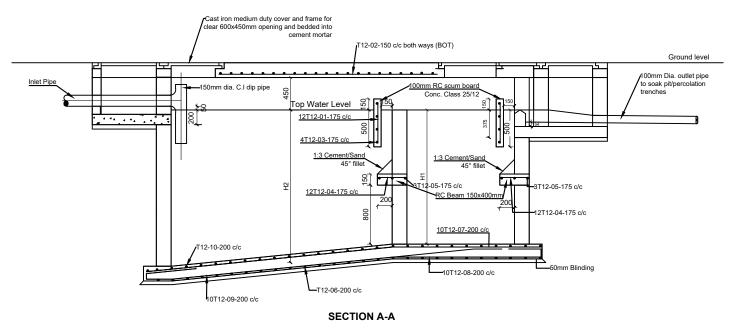


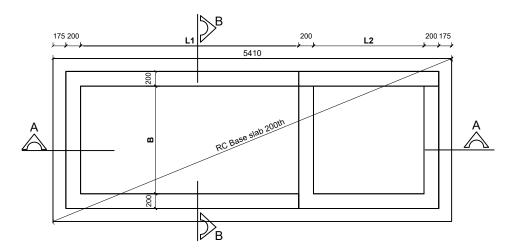

ROOF SLAB PLAN

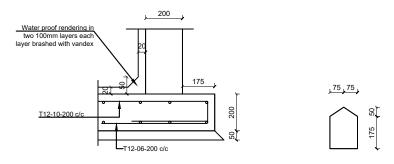

INTERNAL WATER PROOF CONC. WEIR BLOCK DETAIL TO WALLS AND SLABS

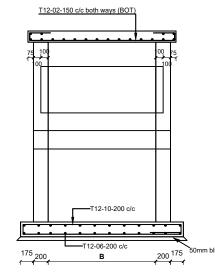

SECTION B-B

SEPTIC TANK DIMENSIONS

	INTERNAL DIMENSIONS (mm)			CAPACITY	NO. OF USERS	
L1	L2	H1	H2	В	Cu. M	
1540	760	1600	1750	760	3.2	10
1900	900	1800	2000	900	4.5	20
2000	1000	1800	2000	1100	5.9	30
2400	1100	1800	2000	1150	7.24	40
2500	1200	1800	2000	1300	8.6	50
2000	1300	1800	2000	1400	10	60
2000	1400	1800	2000	1450	11.3	70
3000	1500	1800	2000	1560	12.7	80
3200	1600	1800	2000	1600	14	90
3300	1700	1800	2000	1700	15.4	100
4000	2000	1800	2000	2090	24	150
4500	2000	1800	2000	2650	34.3	200

LEGEND





MINISTRY OF WATER AND ENVIRONMENT

CO-FINANCED BY:





Alliance Consultants Itd


ALA-ORA WATER SUPPLY AND SANITATION PROJECT

ENYAU WATER SUPPLY AND SANITATION SYSTEM

REVISIONS:				
Date Description				
	·			

DRAWING TITLE: STANDARD DRAWINGS Septic Tank

Surveyed by:			
	R.K		
Drawn by:			
Diawii by.	N.R		
Designed by:			
,	W.G.M		
Checked by:			
,	J.K.K		
Date:			
	January 2023		
DRG. No.:			
ALA-ORA-SD-017			
Scale:	Sheet No.:		
1:120		1 of 1	
	1		

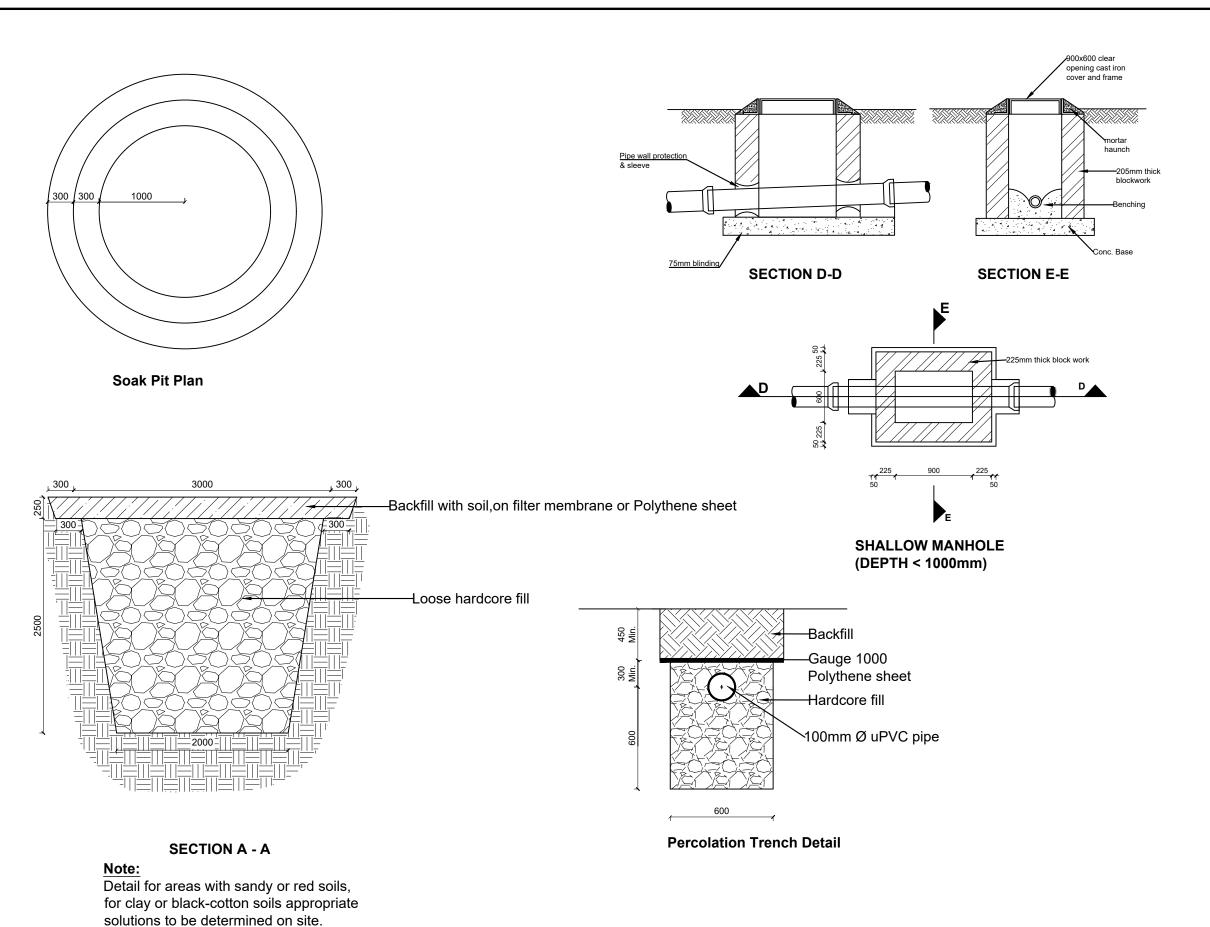

CLIENT :



THE REPUBLIC OF UGANDA
MINISTRY OF WATER AND ENVIRONMENT

CO-FINANCED BY:



CONSULTANT:



Alliance Consultants Itd

Infra-Consult I td

PROJEC

ALA-ORA WATER SUPPLY AND SANITATION PROJECT

ENYAU WATER SUPPLY AND SANITATION SYSTEM

Description

REVISIONS :
No Date

DRAWING TITLE :STANDARD DRAWINGS

Surveyed by:
R.K

Drawn by:
N.R

Designed by:
W.G.M

Checked by:
J.K.K

Date:
January 2023

DRG. No.:


ALA-ORA-SD-018

Sheet No.:

1 of

1 of 1

Manhole and Soak Pit Details

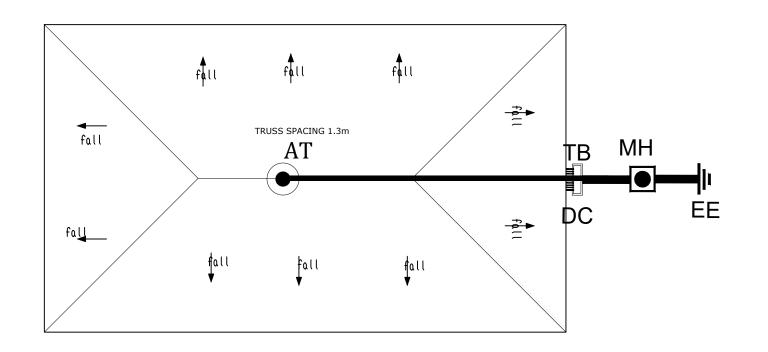



AIR TERMINAL


TB TEST CLAMP

MH INSPECTION MANHOLE

≡EE EARTH ELECTRODE

HC HORIZONTAL CONDUCTOR

DC DOWN CONDUCTOR

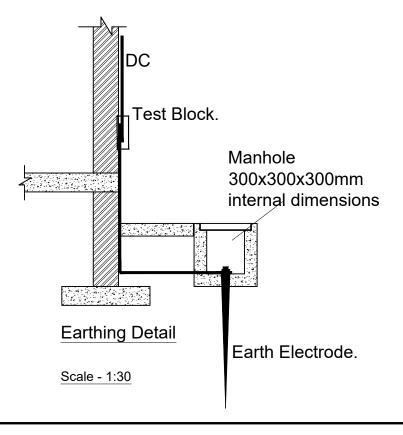

NOTE

Air Terminal to be placed at the highest and center point of the roof

CLIENT :



MINISTRY OF WATER AND ENVIRONMENT

CO-FINANCED BY:



CONSULTANT :



Alliance Consultants Itd

Infra-Consult Ltd

PROJECT

ALA-ORA WATER SUPPLY AND SANITATION PROJECT

ENYAU WATER SUPPLY AND SANITATION SYSTEM

REVISIONS:				
No	Date	Description		
		-		

DRAWING TITLE STANDARD DRAWINGS

Lightning Conductor

Surveyed by:

R.K

Drawn by:

N.R

Designed by:

W.G.M

Checked by:

J.K.K

Date:

January 2023


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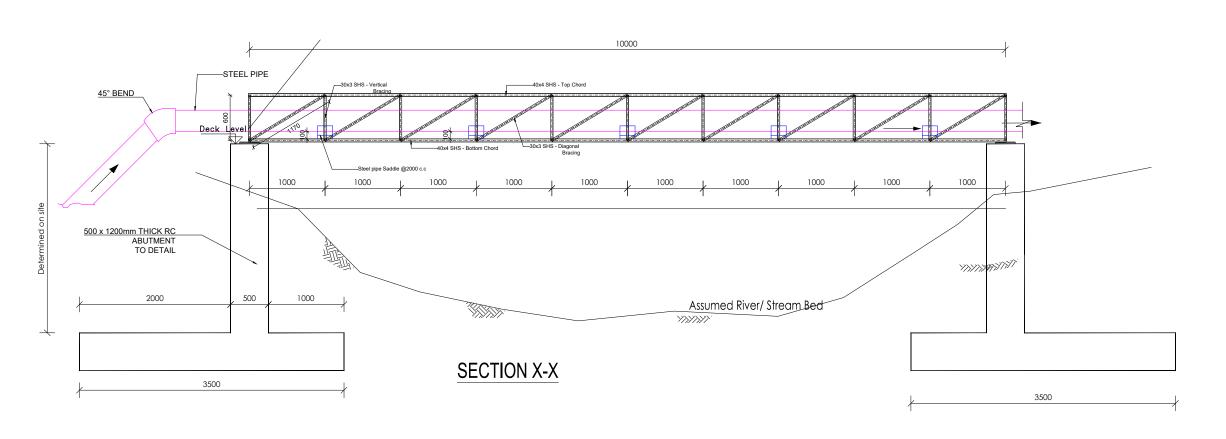
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Scale:

Sheet No.:

1:75



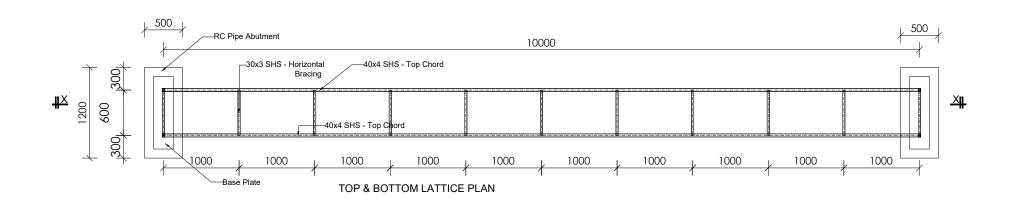

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CONSULTANT



Alliance Consultants Itd

Infra-Consult Ltd

PROJECT

ALA-ORA WATER SUPPLY AND SANITATION PROJECT

STANDARD DRAWINGS

REVISIONS:			
No	Date	Description	
		·	

PIPE BRIDGES-10m
Plan and Elevation

Surveyed by:

R.K

Drawn by:

A.K

Designed by:

B.A

Checked by:

J.K.K

Date:

March 2023

DRG. No.:


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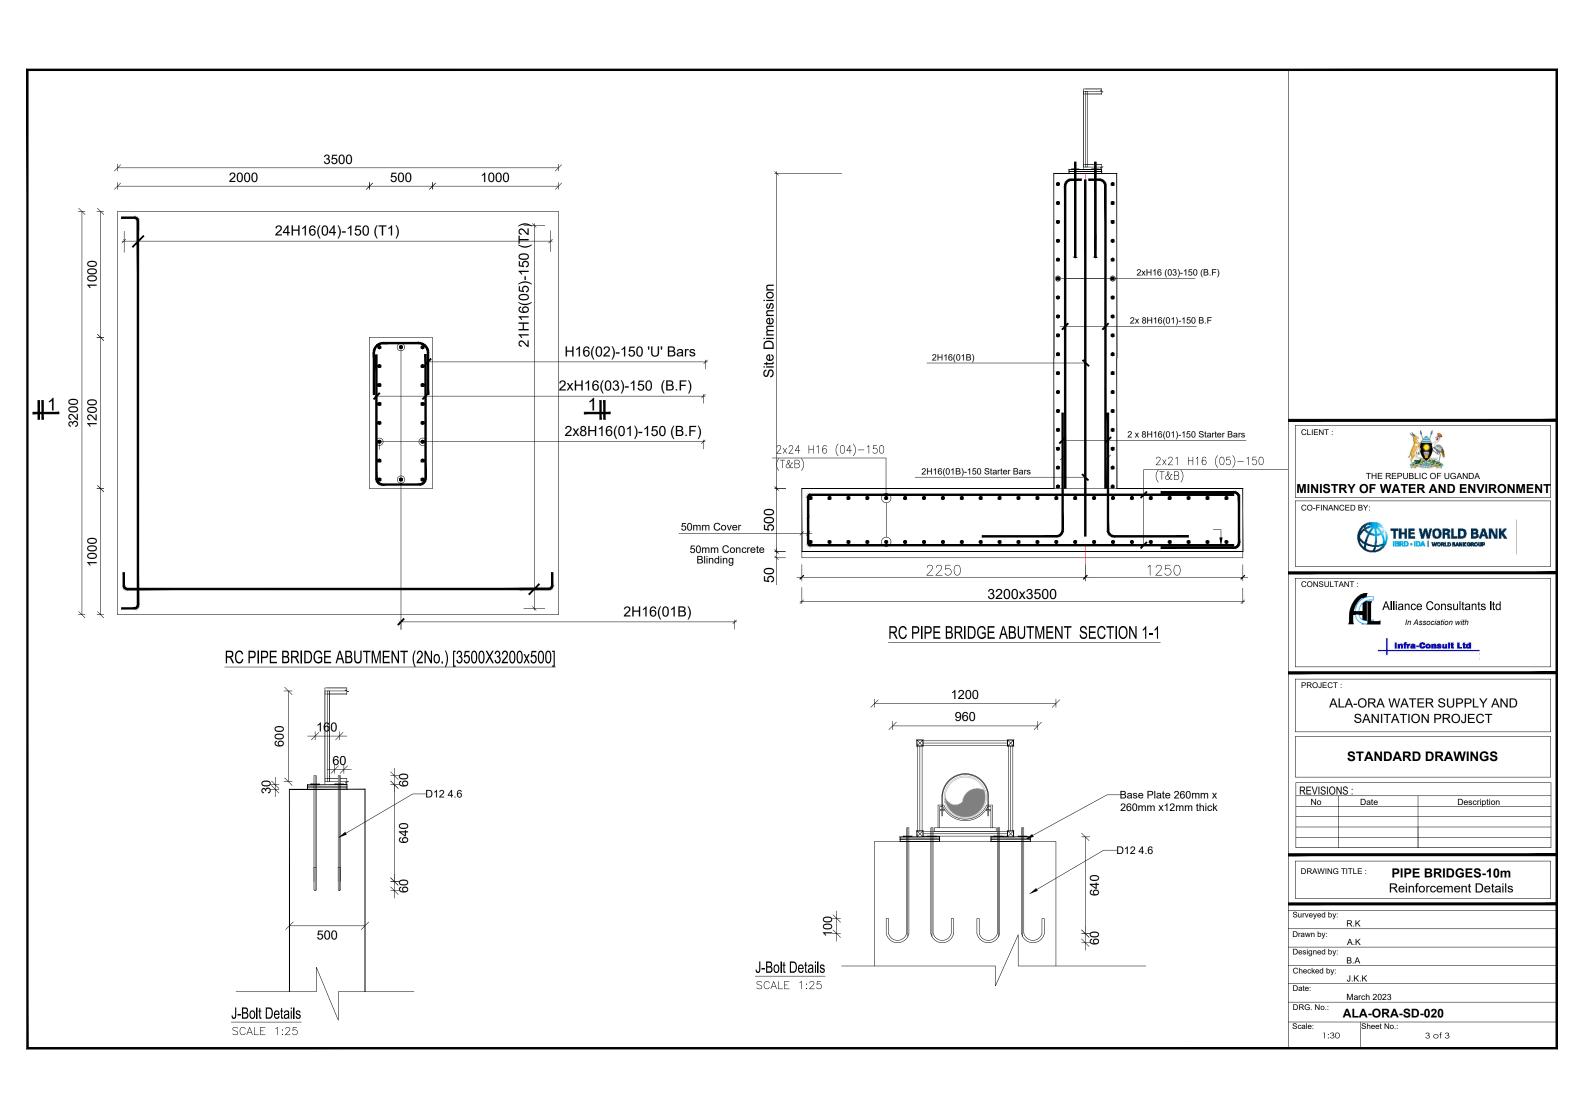
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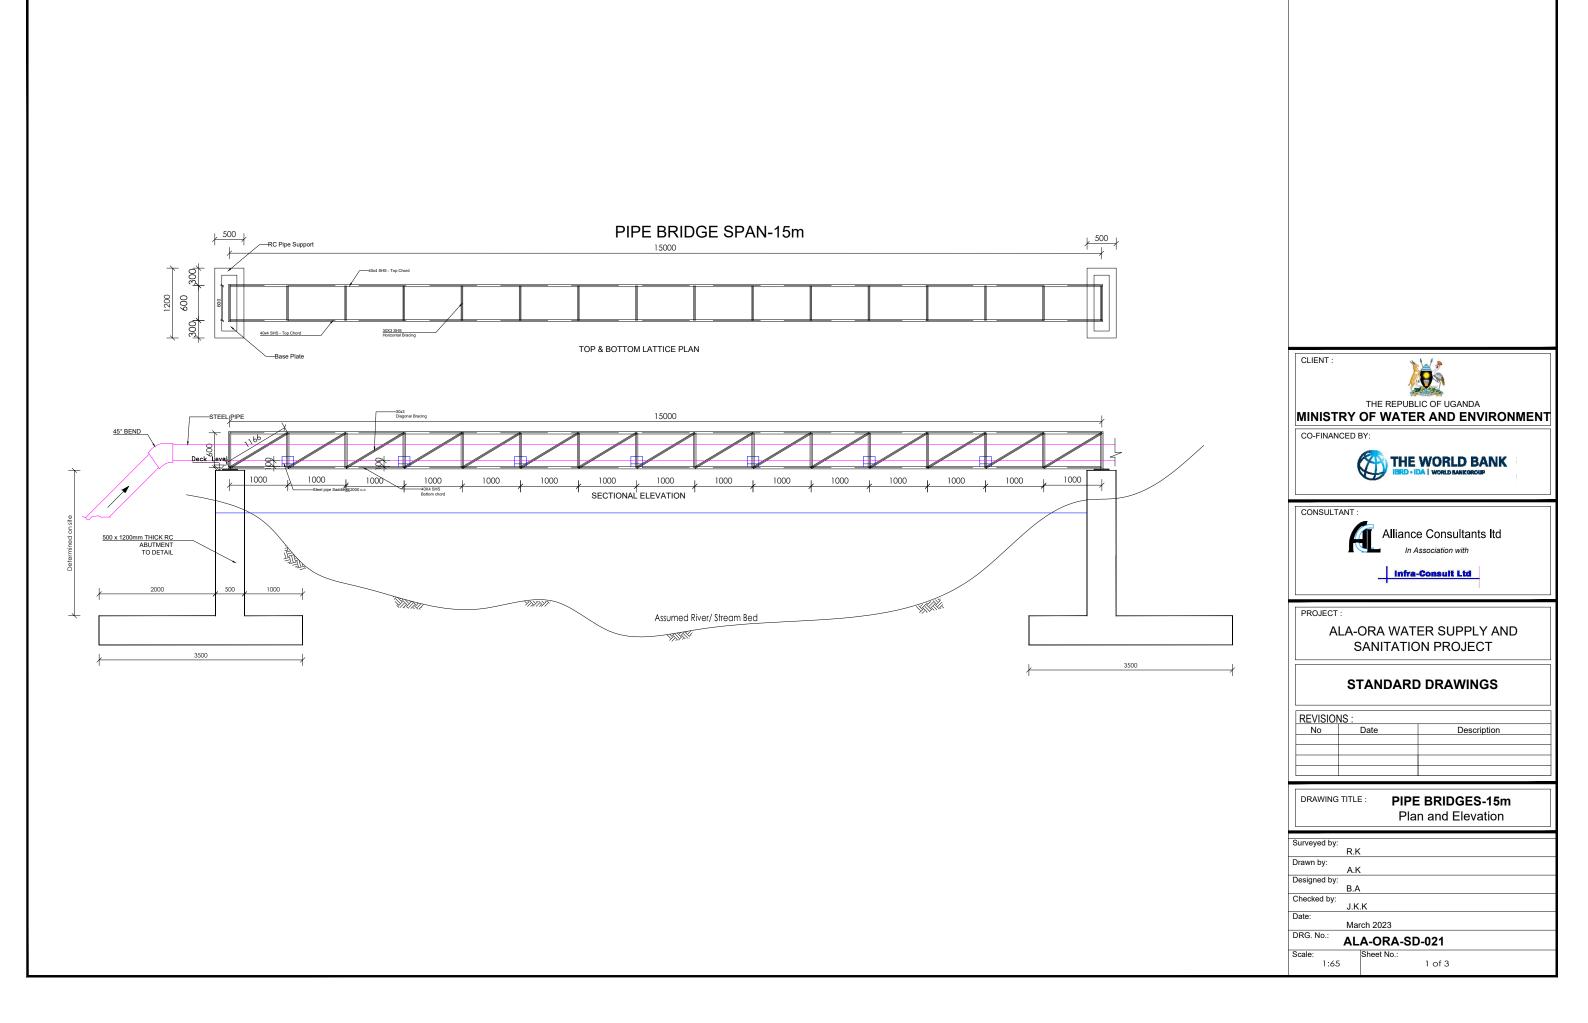
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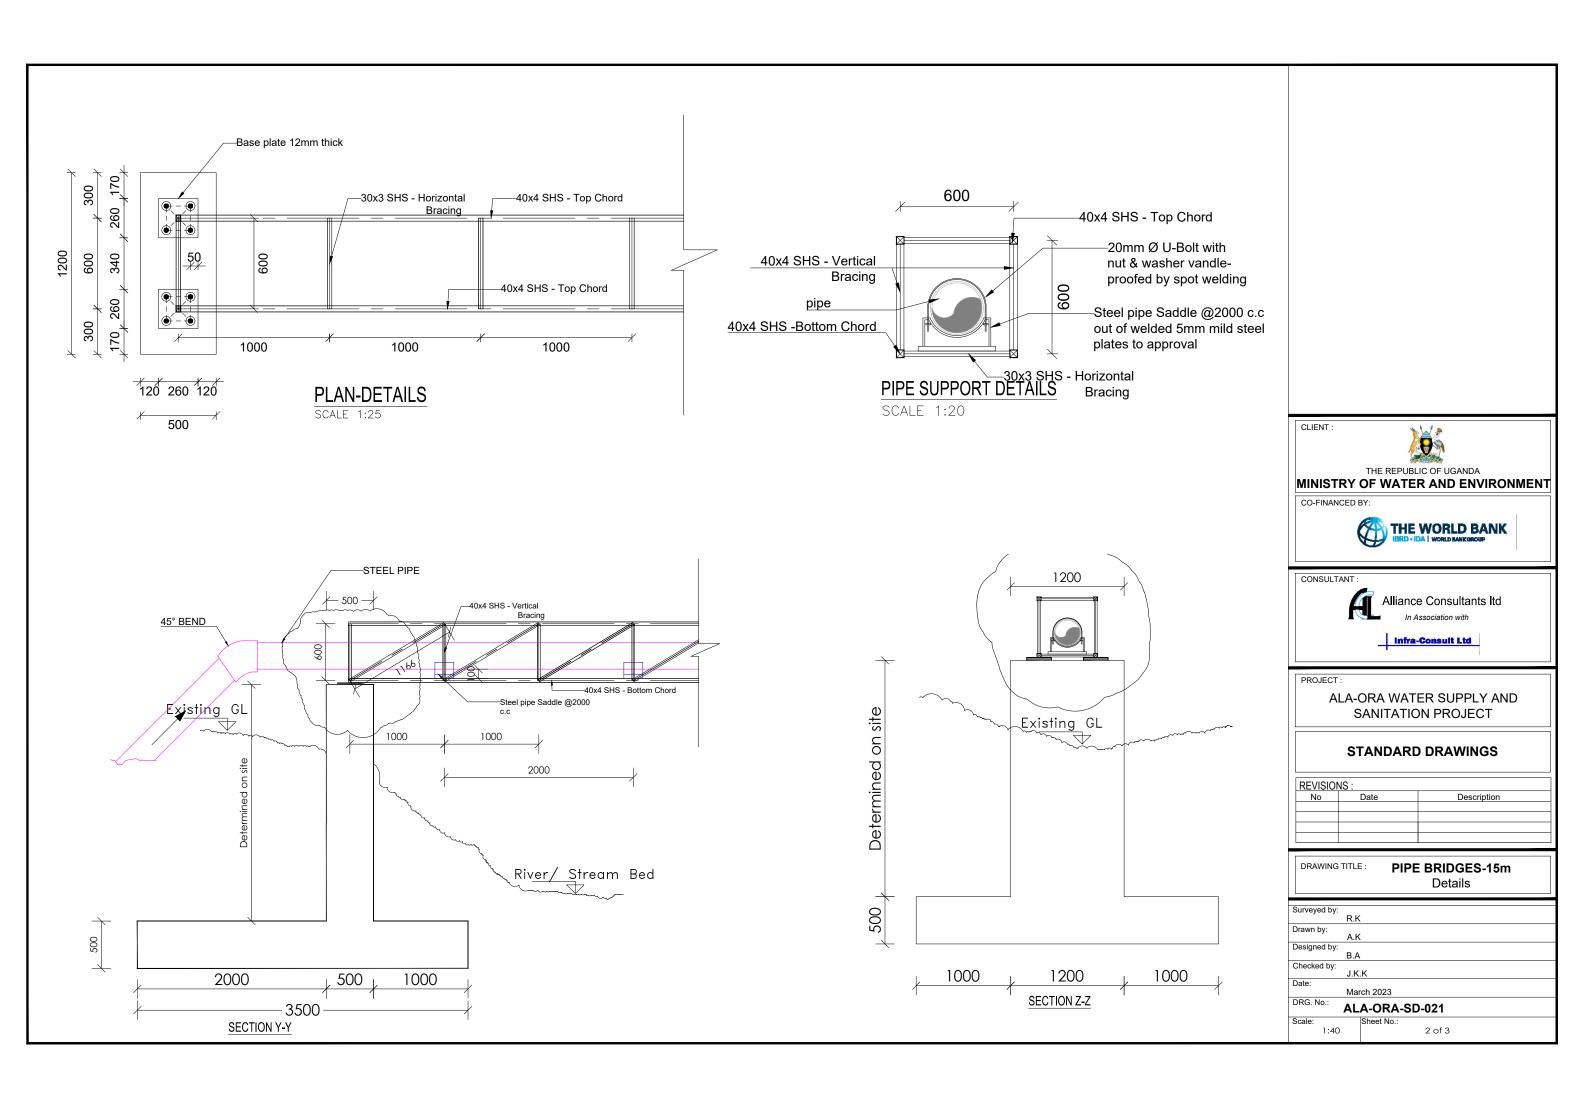
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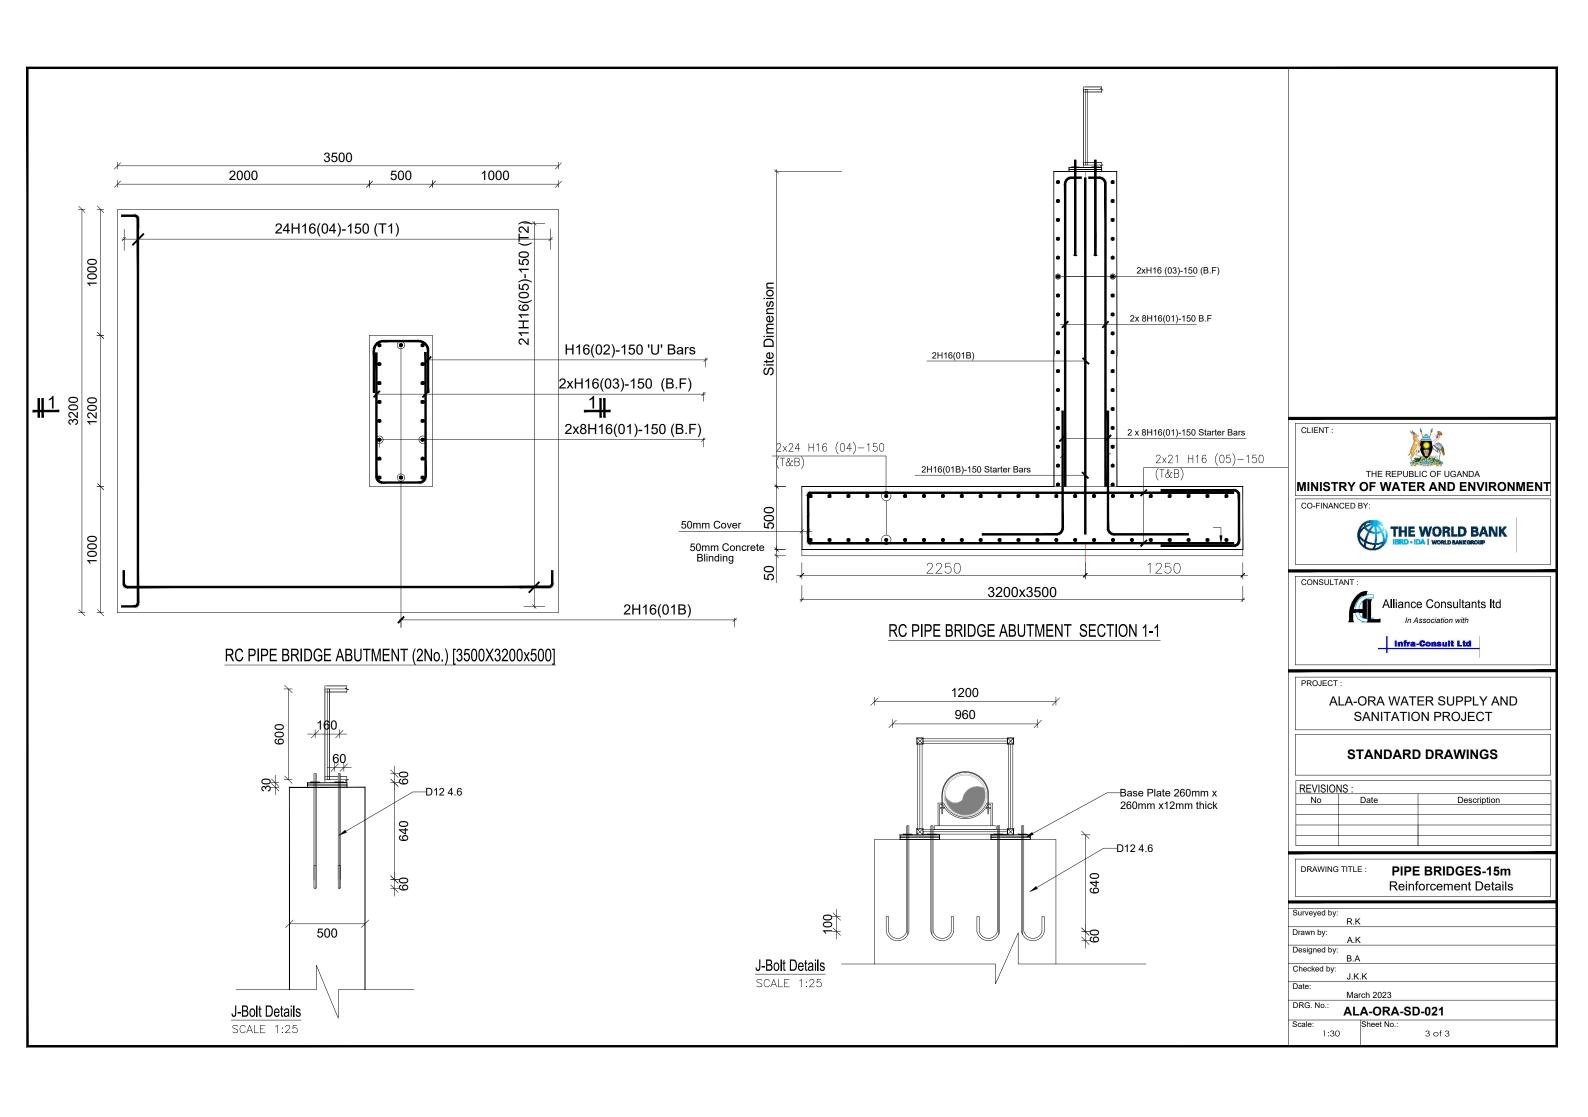
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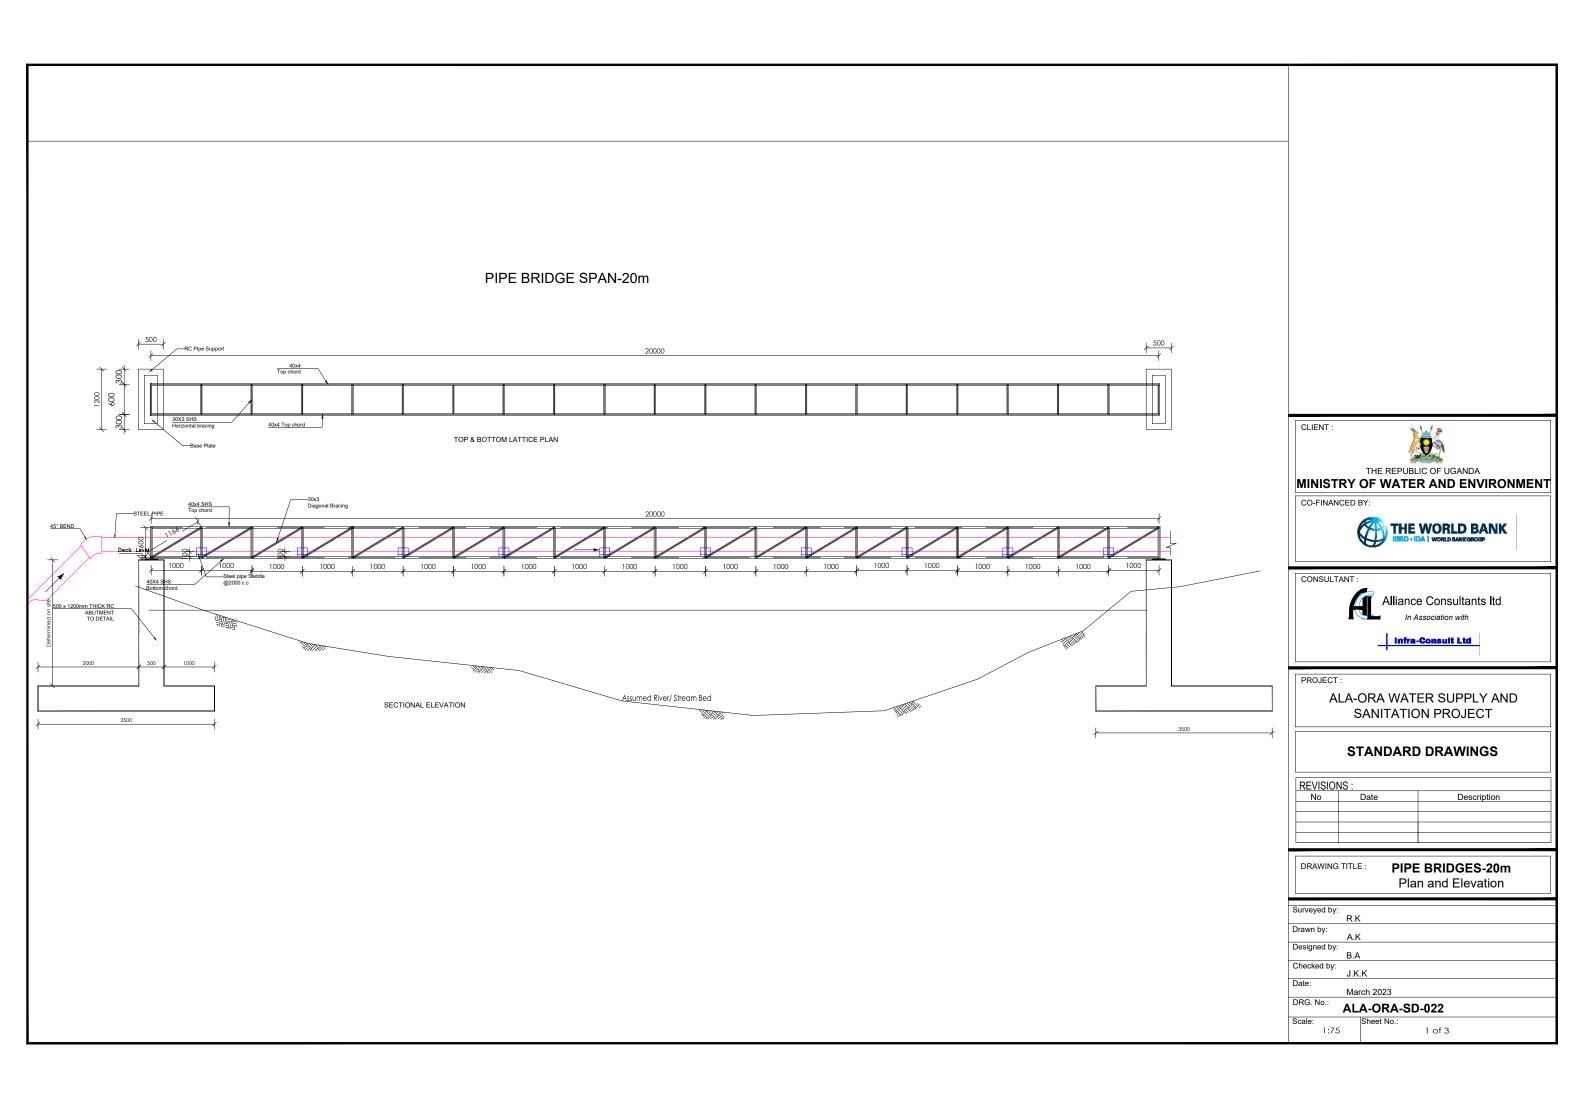













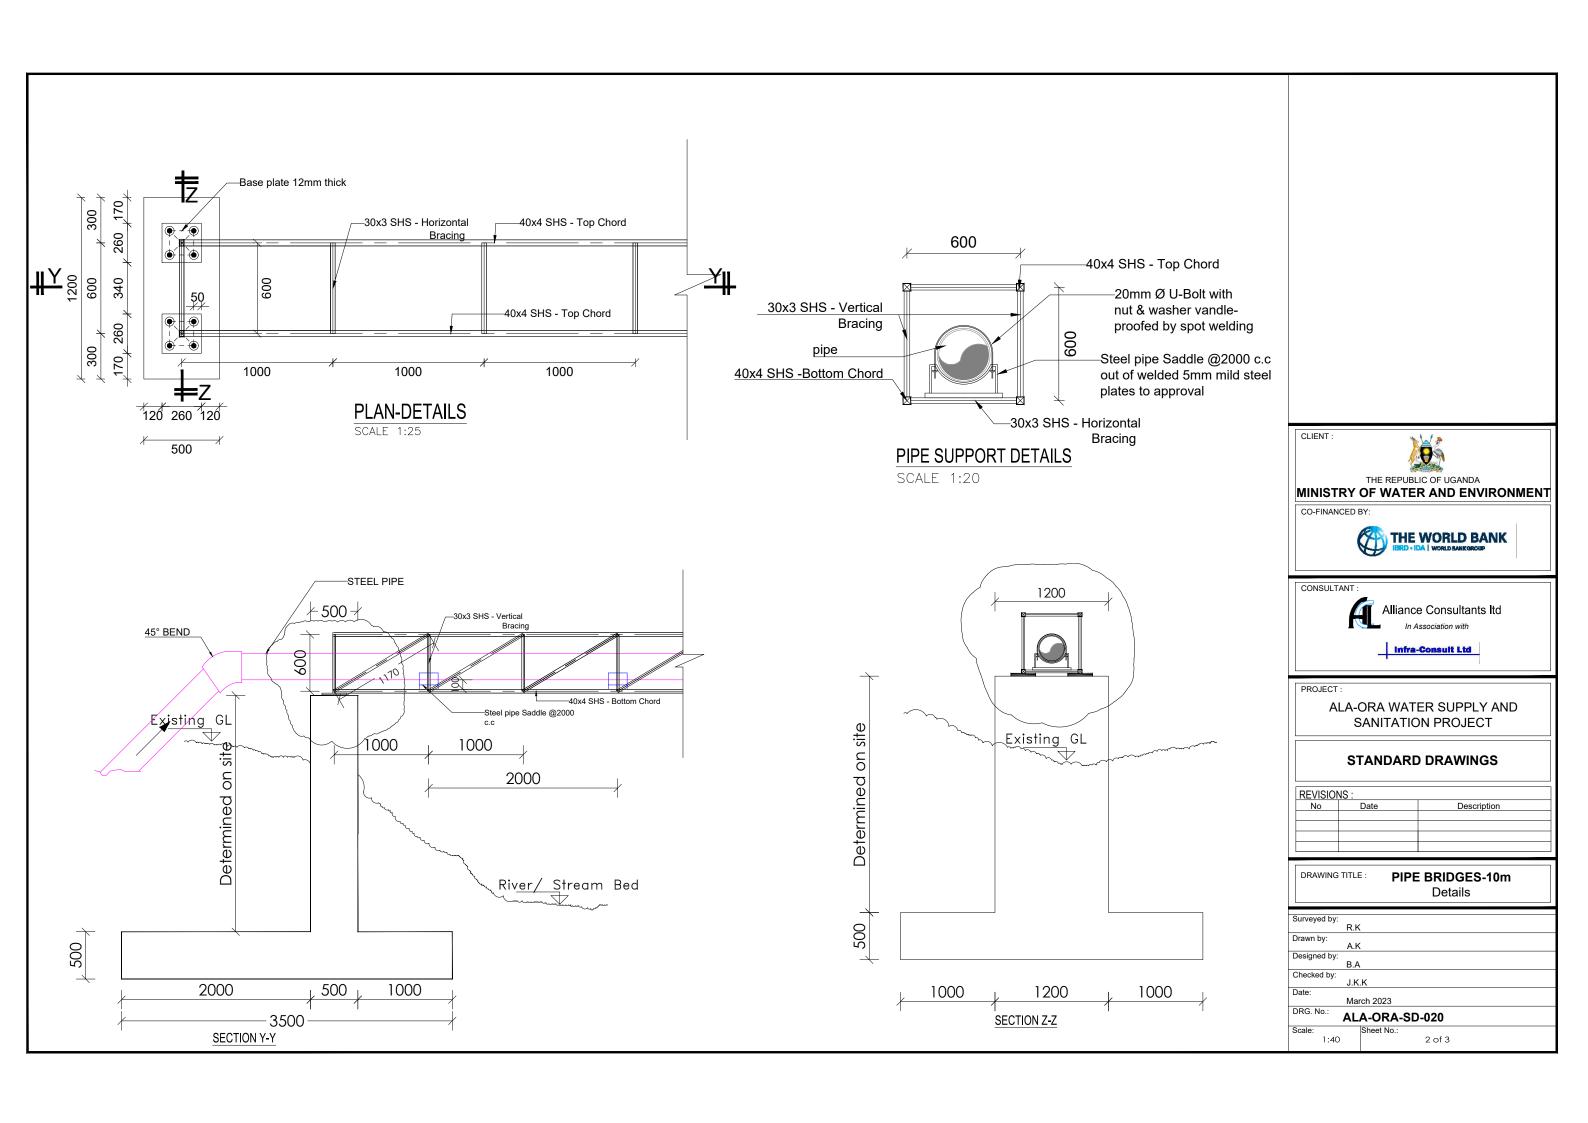


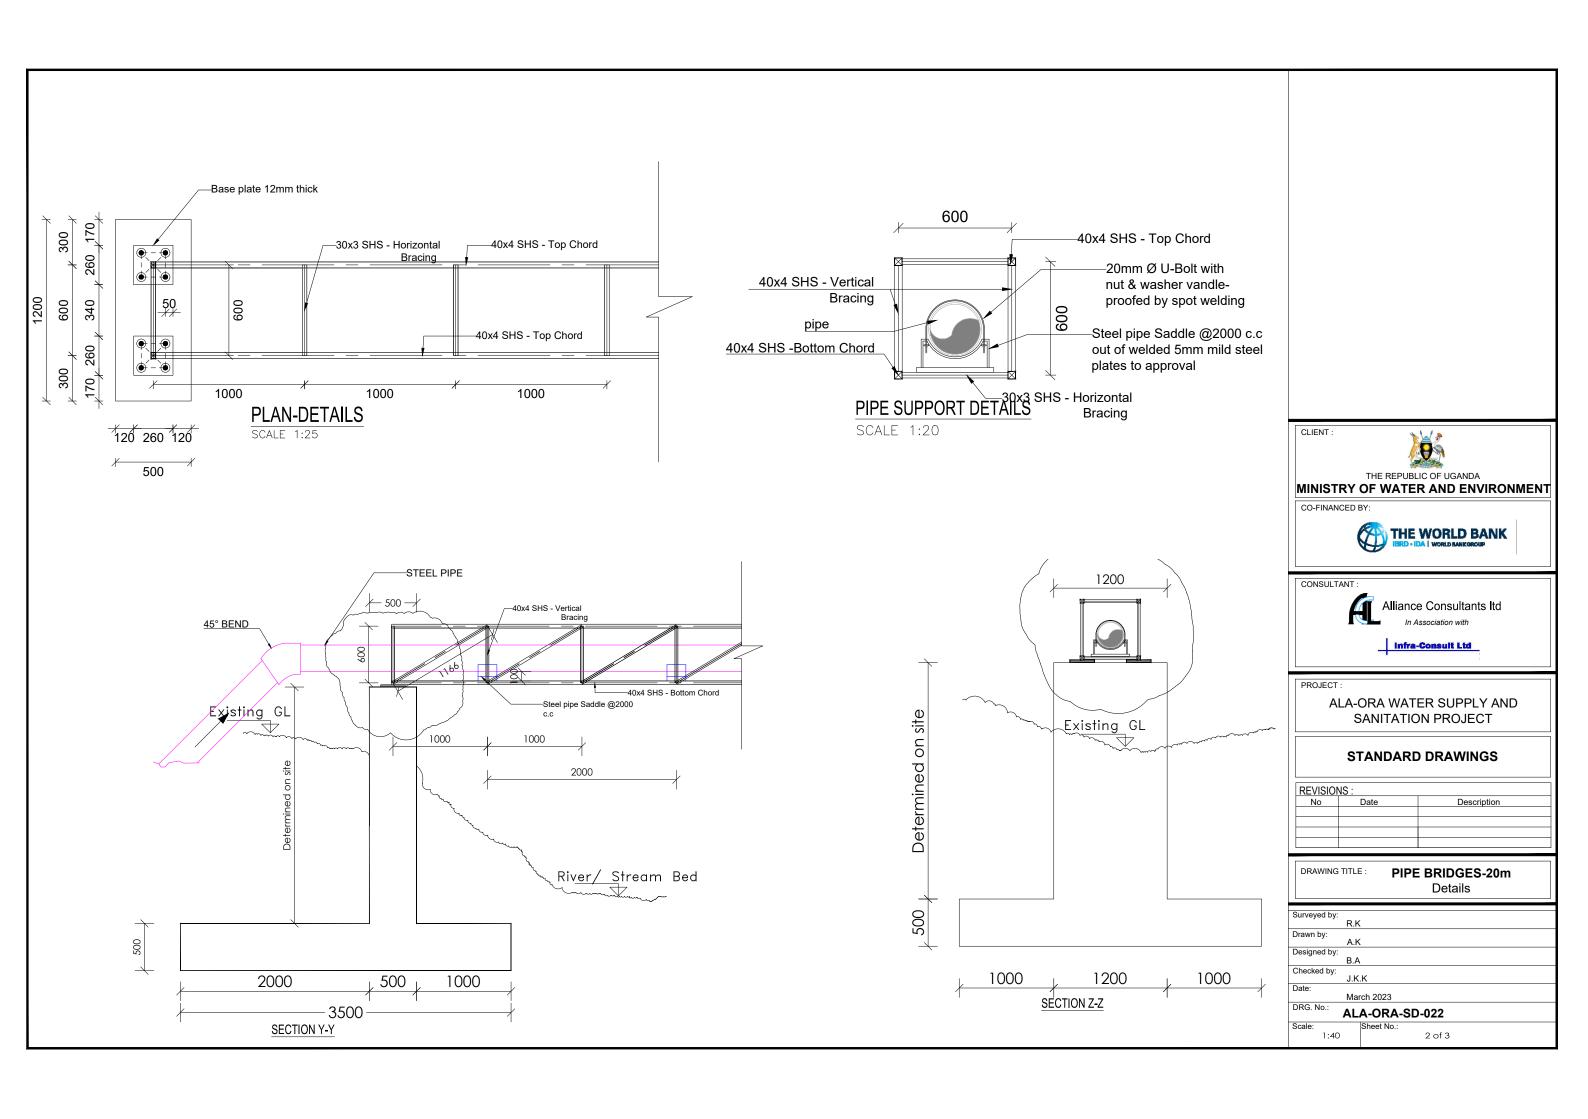

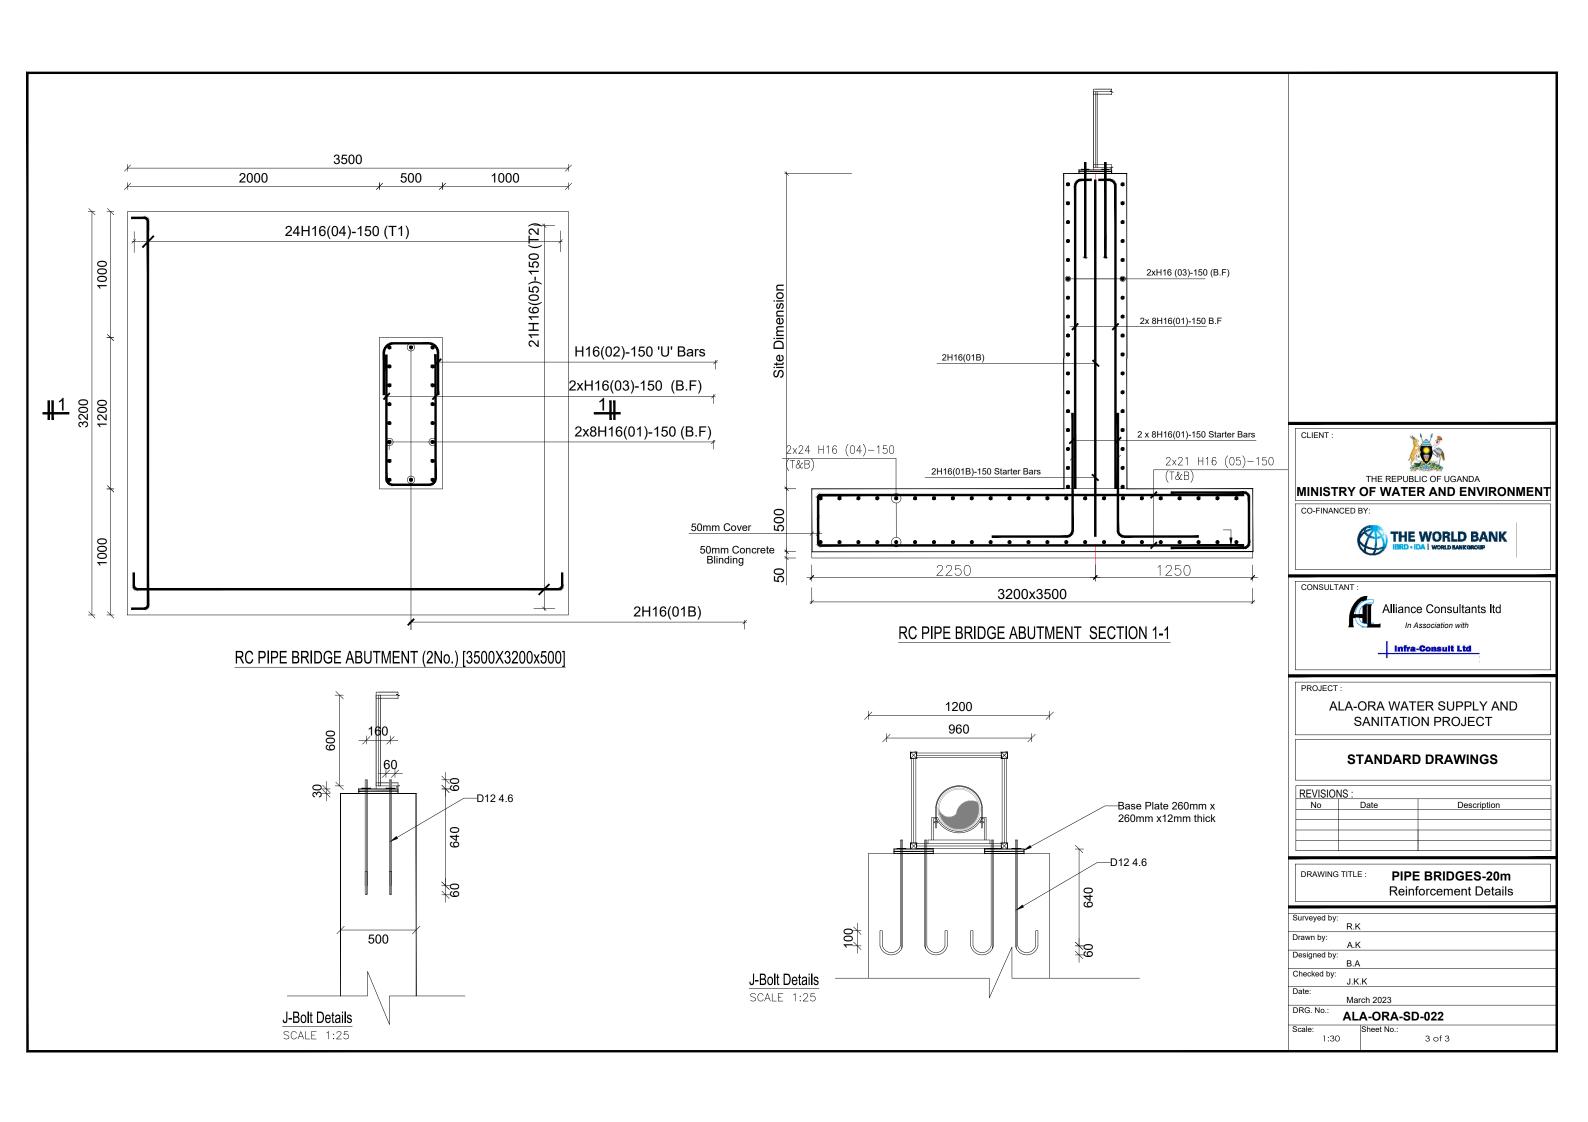

PIPE BRIDGE SPAN-35m

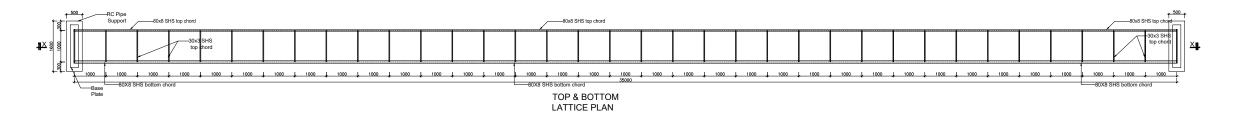

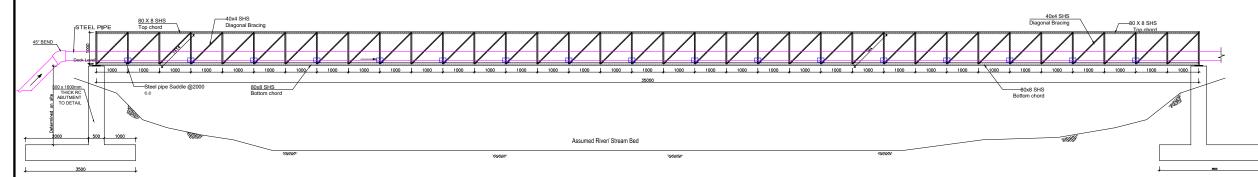

SECTIONAL X-X

CLIENT :



THE REPUBLIC OF UGANDA
MINISTRY OF WATER AND ENVIRONMENT

CO-FINANCED BY:



CONSULTANT:



Alliance Consultants Itd

Infra-Consult Ltd

ROJECT :

ALA-ORA WATER SUPPLY AND SANITATION PROJECT

STANDARD DRAWINGS

REVISIONS:			
No	Date	Description	
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DRAWING TITLE: PIPE BRIDGES-35m
Plan and Elevation

Surveyed by:
R.K

Drawn by:
A.K

Designed by:
B.A


Checked by:
J.K.K


Date:
March 2023

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ALA-ORA-SD-023


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Sheet No.:
1 of 3



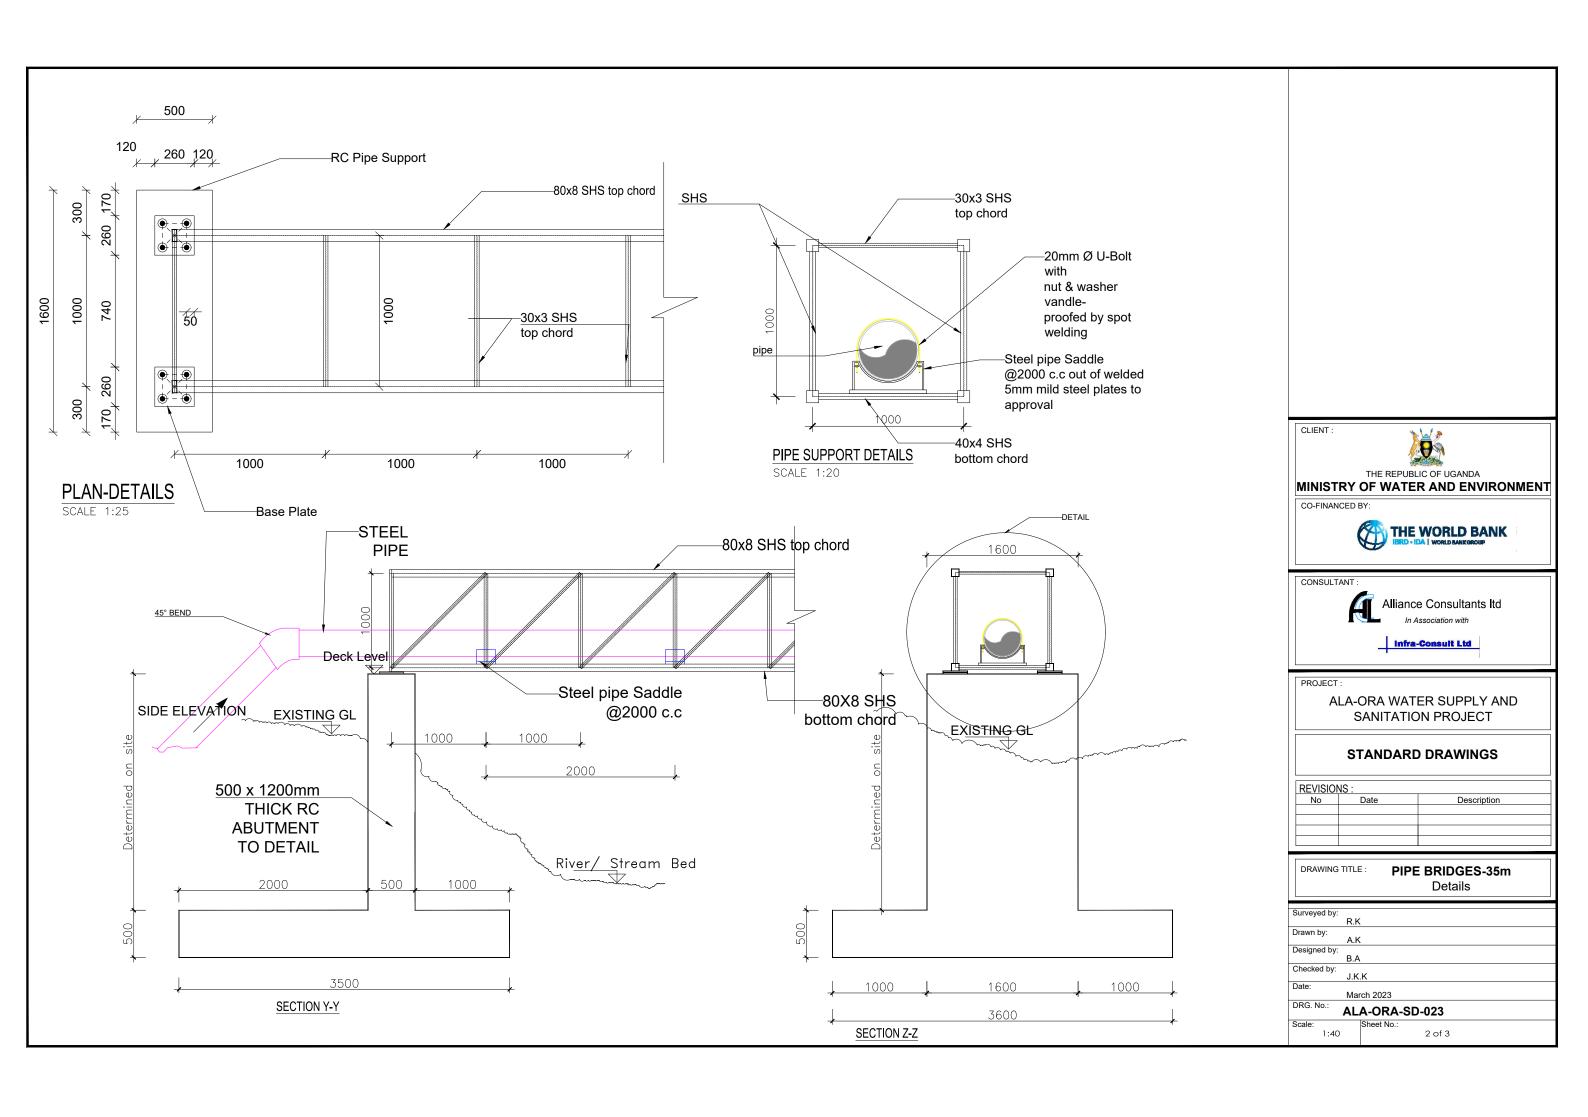

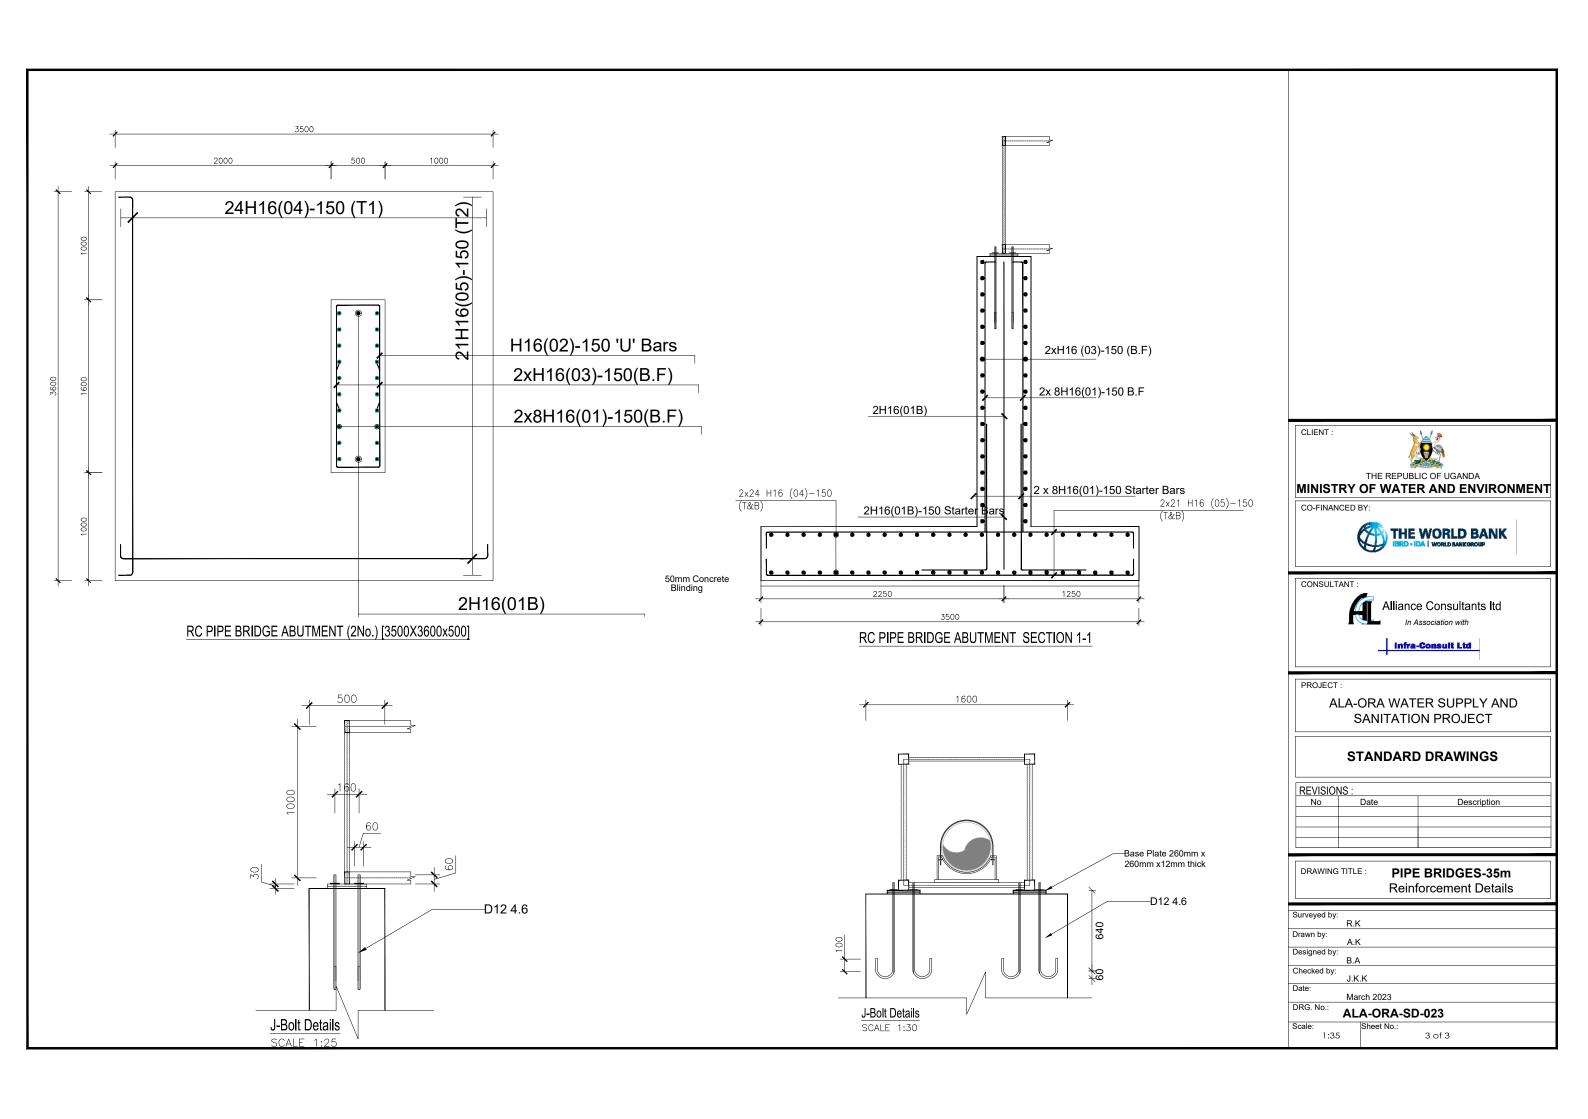EIGHT STANCE WITH DISABLED UNIT, STORE AND A BATHROOM WATERBORNE TOILET FULLY ROOFED

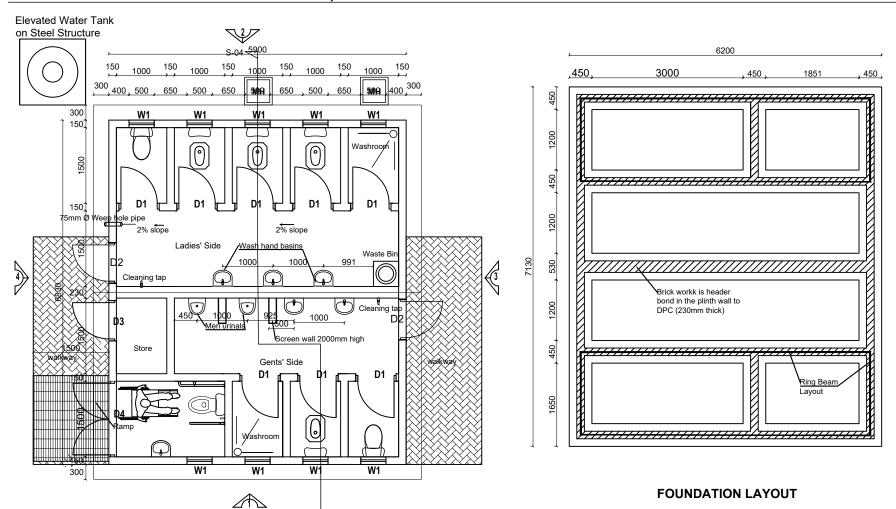

TOILET PLAN S-04

THE REPUBLIC OF UGANDA

MINISTRY OF WATER AND ENVIRONMENT

CO-FINANCED BY:

THE WORLD BANK

IBRD - IDA | WORLD BANK




ALA-ORA WATER SUPPLY AND
SANITATION PROJECT

ENYAU WATER SUPPLY AND SANITATION SYSTEM

	REVISIONS:		
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DRAWING TITLE : SANITATION FACILITIES
Public Toilets - Plan and Foundation Layout

Surveyed by:	R.K
	N.N
Drawn by:	M.K
Designed by:	
,	W.G.M
Checked by:	
	J.K.K
Date:	
	January 2023
DRG. No.:	
	ALA-ORA- SAN-001
Scale:	Sheet No.:
1:75	1 of 6

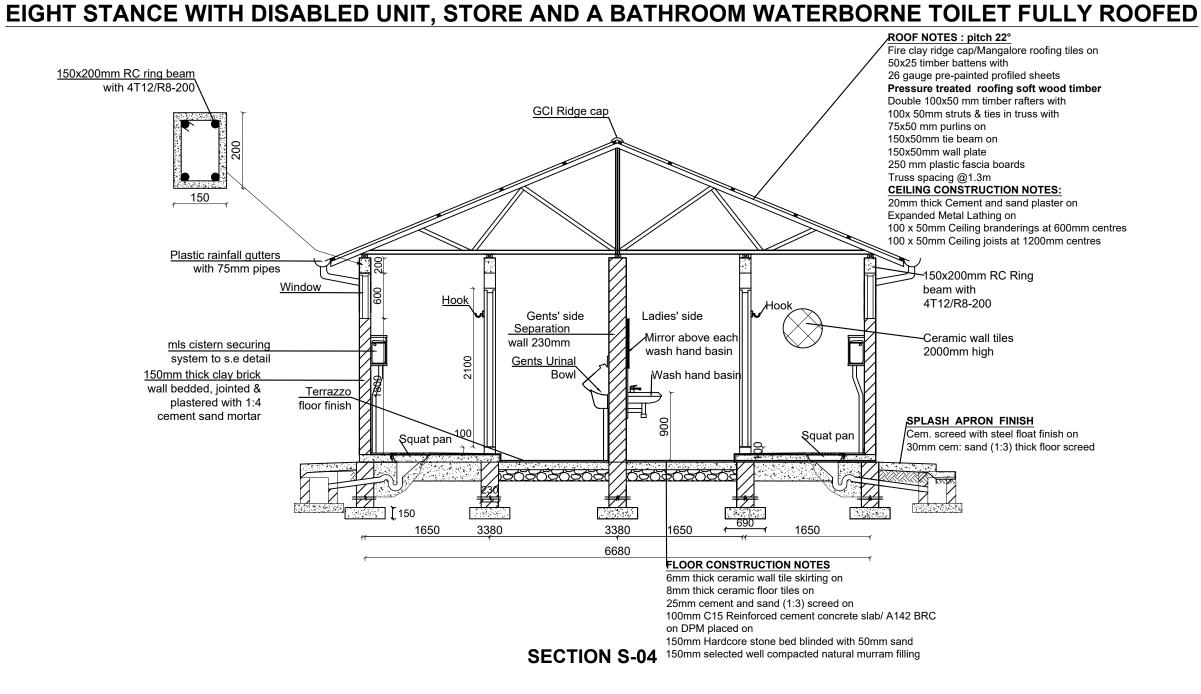

Notes:

200/230mm thick substructure and 150mm thick super structure walling



CONSULTANT:

Alliance Consultants Itd

In Association with

JECT : ALA-ORA W

CLIENT :

ALA-ORA WATER SUPPLY AND SANITATION PROJECT


ENYAU WATER SUPPLY AND SANITATION SYSTEM

REVISIO	NS:	
No	Date	Description

DRAWING TITLE : SANITATION FACILITIES
Public Toilets - Section

Surveyed by:	
, ,	R.K
Drawn by:	M.K
Designed by:	W.K
	W.G.M
Checked by:	
	J.K.K
Date:	
	January 2023
DRG. No.:	•
	ALA-ORA- SAN-001
Scale:	Sheet No.:
1:50	2 of 6

DOOR SCHEDULE

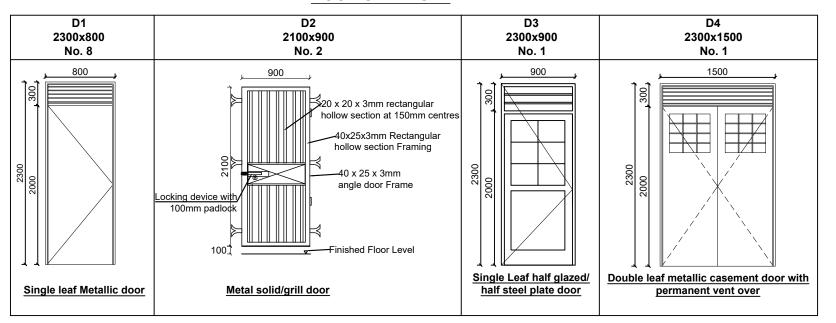

WINDOW SCHEDULE

PLAN-DISABLED UNIT

400x250x150mm thick concrete Grade 20

welded on handrail


25mm Dia. MS hand rails

150k150mm Thick MS plate

door frame.

Ceramic wall tiles where

provided for in the B.O.Q

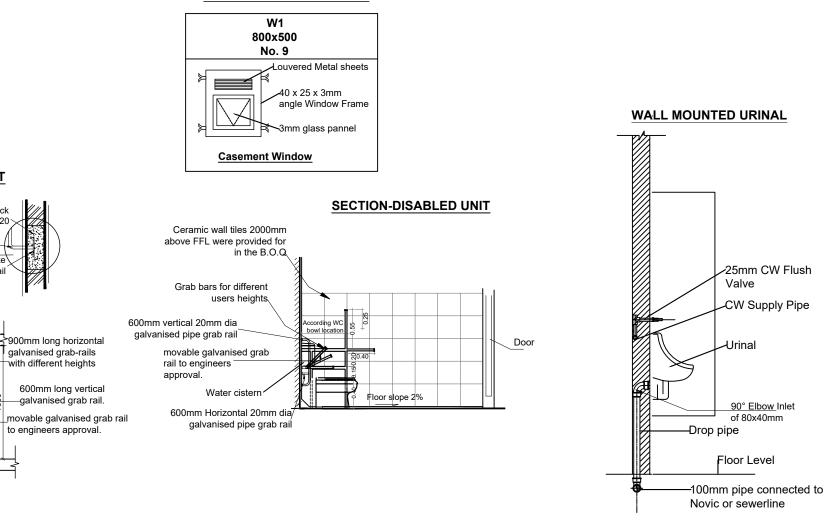

LEGEND





ALA-ORA WATER SUPPLY AND SANITATION PROJECT


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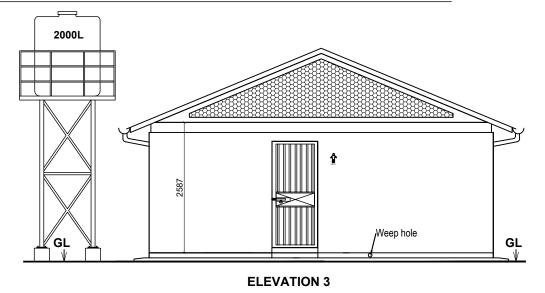
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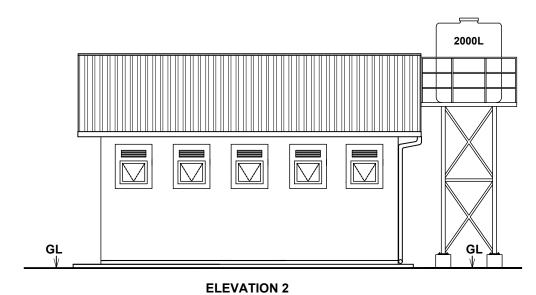
DRAWING TITLE: SANITATION FACIL	LITIES
Public Toilets - Door and Window Schedule, Disable	ed Unit Details & Urinal Detail


Surveyed by:	D.V.
	R.K
Drawn by:	M.K
Designed by:	
	W.G.M
Checked by:	
	J.K.K
Date:	
	January 2023
DRG. No.:	ALA ODA CAN 004
	ALA-ORA- SAN-001
Scale:	Sheet No.:
1:50	3 of 6

EIGHT STANCE WITH DISABLED UNIT, STORE AND A BATHROOM WATERBORNE TOILET FULLY ROOFED





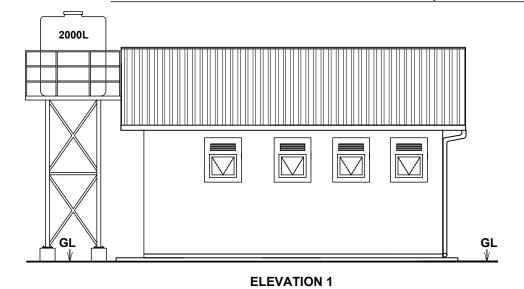

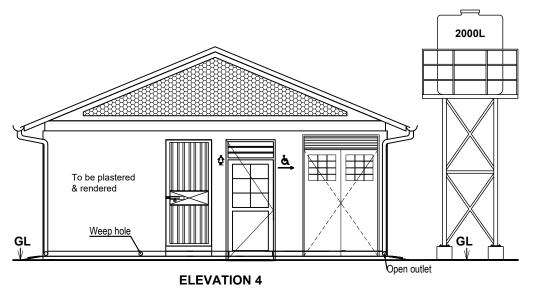





PROJECT:

ALA-ORA WATER SUPPLY AND

SANITATION PROJECT


ENYAU WATER SUPPLY AND SANITATION SYSTEM


REVISIONS:		
No	Date	Description

DRAWING TITLE: SANITATION FACILITIES
Public Toilets - Elevations

Surveyed by:	
	R.K
Drawn by:	
•	M.K
Designed by:	
	W.G.M
Checked by:	
•	J.K.K
Date:	
	January 2023
DRG. No.:	
	ALA-ORA- SAN-001
Scale:	Sheet No.:
1:75	4 of 6
	1

EIGHT STANCE WITH DISABLED UNIT, STORE AND A BATHROOM WATERBORNE TOILET FULLY ROOFED

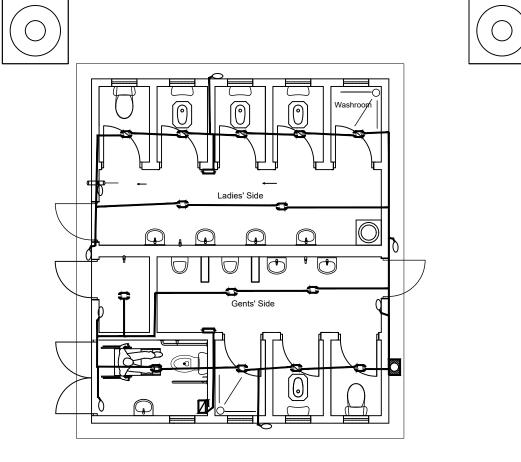

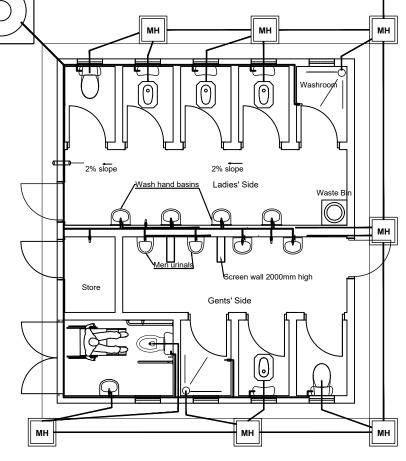

To Novic Tank

ELECTRICAL LAYOUT

NOTE :-Electrical installation limited to

- Conducting MK boxes and Blanks


Main Switch

One-gang / Three-ways fllush wall switch

Bulk head fitting (Security Lamp)
Ceiling out let lamp

Electric Conductor

PLUMBING LAYOUT

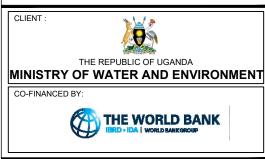



ALA-ORA WATER SUPPLY AND SANITATION PROJECT

ENYAU WATER SUPPLY AND SANITATION SYSTEM


REVISIONS:		
No	Date	Description

DRAWING TITLE SANITATION FACILITIES Public Toilets - Electrical & Plumbing Layouts

Surveyed by:	
	R.K
Drawn by:	
,	M.K
Designed by:	
	W.G.M
Checked by:	
•	J.K.K
Date:	
	January 2023
DRG. No.:	
	ALA-ORA- SAN-001
Scale:	Sheet No.:
1:75	6 of 6

FOUR STANCE VIP LATRINE INCLUDING A DISABLED UNIT AND URINAL **LEGEND** 1200 150 900 150 Access MH for emptying 1700 600x450mm internal dimensions GT 150 **Boys Urinal** 150 D2 **D1** CLIENT : THE REPUBLIC OF UGANDA MINISTRY OF WATER AND ENVIRONMENT D3 150 CO-FINANCED BY: THE WORLD BANK CONSULTANT Alliance Consultants Itd **GENTS VIP PLAN** 7280 ALA-ORA WATER SUPPLY AND SANITATION PROJECT Ring beam **ENYAU WATER SUPPLY AND SANITATION SYSTEM** PIT REVISIONS : 4350 Description DRAWING TITLE: SANITATION FACILITIES 5900 VIP Latrine Gents - Plan and Foundation Layout Designed by Checked by: Note: 690 5900 690 200/230mm thick sub-structure and 150mm January 2023 thick super structure walling **FOUNDATION LAYOUT** ALA-ORA- SAN-002

FOUR STANCE VIP LATRINE INCLUDING A DISABLED UNIT AND URINAL

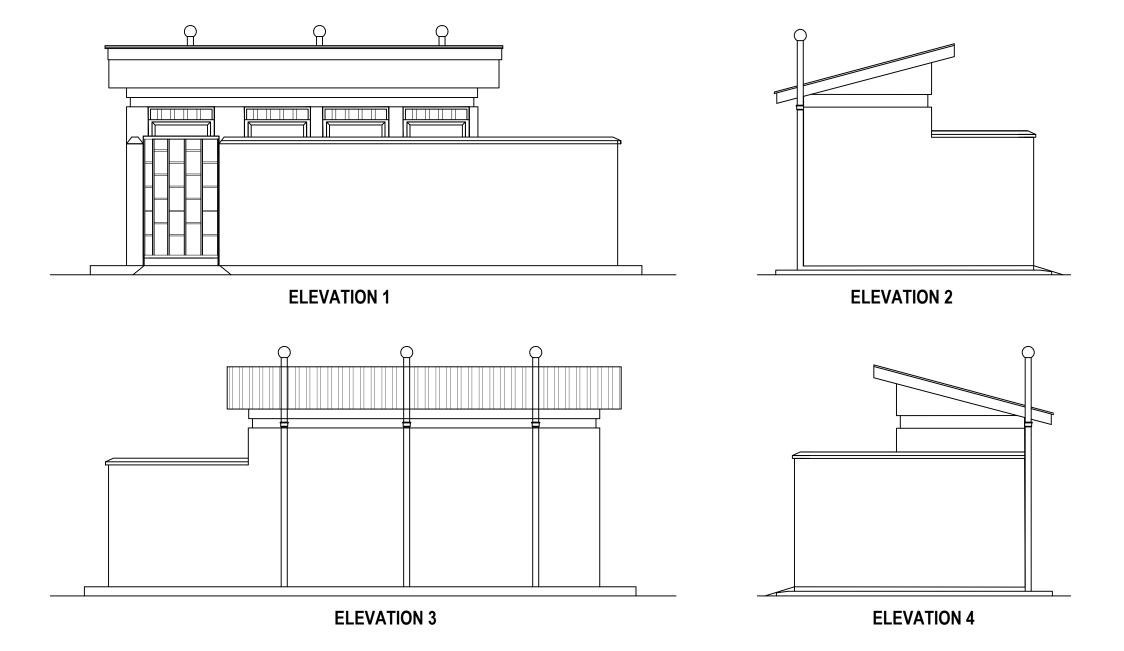





MINISTRY OF WATER AND ENVIRONMENT

CO-FINANCED BY:



CONSULTANT :



Alliance Consultants Itd

in Association w

Infra-Consult Ltd

PROJECT

ALA-ORA WATER SUPPLY AND SANITATION PROJECT

ENYAU WATER SUPPLY AND SANITATION SYSTEM

REVISIONS:			
Date	Description		

DRAWING TITLE:
SANITATION FACILITIES
VIP Latrine Gents - Elevations

R.K

Drawn by:

M.K

Designed by:

W.G.M

Checked by:


J.K.K

Date:

January 2023

DRG. No.:

ALA-ORA- SAN-002

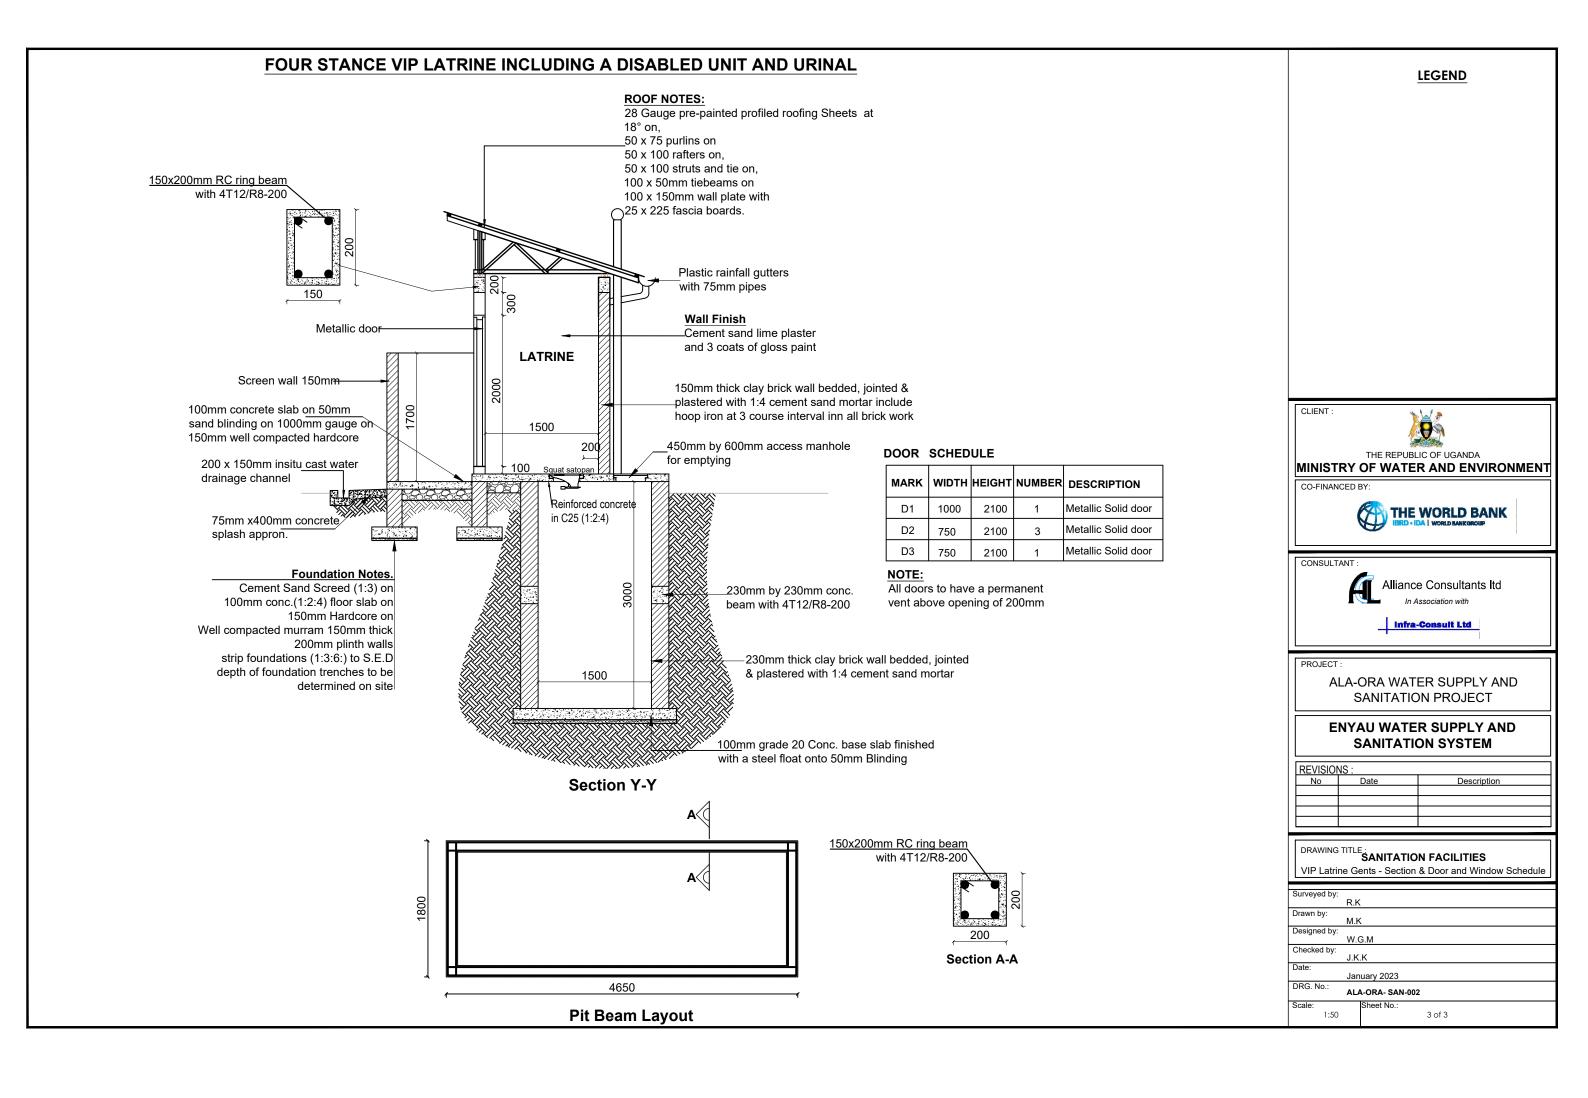

FIVE STANCE VIP LATRINE INCLUDING A DISABLED UNIT AND INCINERATOR 6850 150 900 150 900 150 900 150 1000 1200 Access MH for emptying 600x450mm internal GT 150] Wash Room Incinerator 3150 150 D2 D1 🚧 D1 🚧 D1 🚧 D1 D3 150 **LADIES VIP PLAN** 690 700 460 460 5400 Ring beam 1200 PIT 5400 069 **←** 230 6250 069 **FOUNDATION LAYOUT**

LEGEND

THE REPUBLIC OF UGANDA

MINISTRY OF WATER AND ENVIRONMENT

CO-FINANCED BY:

THE WORLD BANK

ISRD • IDA | WORLD BANK



ALA-ORA WATER SUPPLY AND SANITATION PROJECT

ENYAU WATER SUPPLY AND SANITATION SYSTEM


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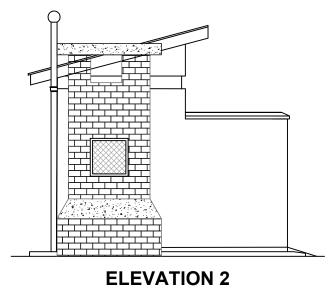
DRAWING TITLE: SANITATION FACILITIES


VIP Latrine Ladies - Plan and Foundation Layout


Surveyed by:	5.4
	R.K
Drawn by:	
D.a.m. by:	M.K
Designed by:	
,	W.G.M
Checked by:	
,	J.K.K
Date:	
	January 2023
DRG. No.:	
	ALA-ORA- SAN-003
Scale:	Sheet No.:
1:50	1 of 3

FIVE STANCE VIP LATRINE INCLUDING A DISABLED UNIT AND INCINERATOR



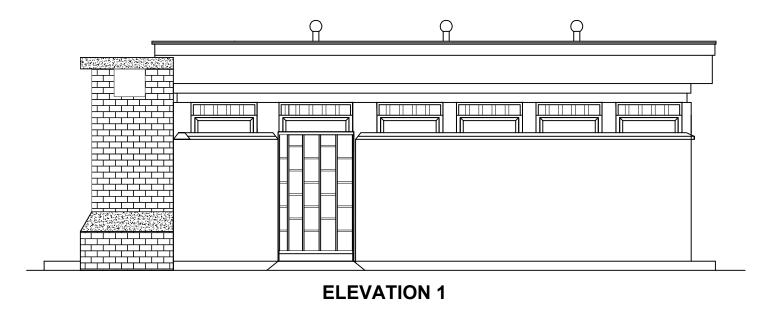

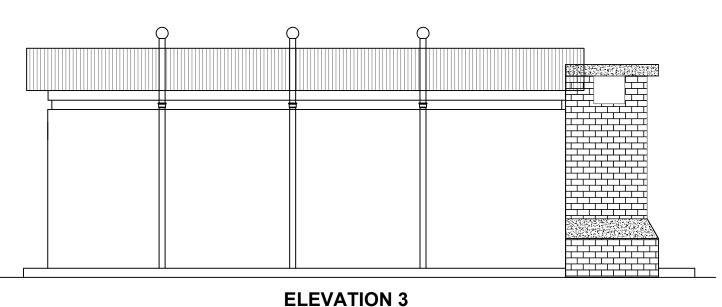

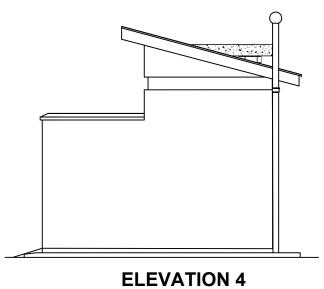

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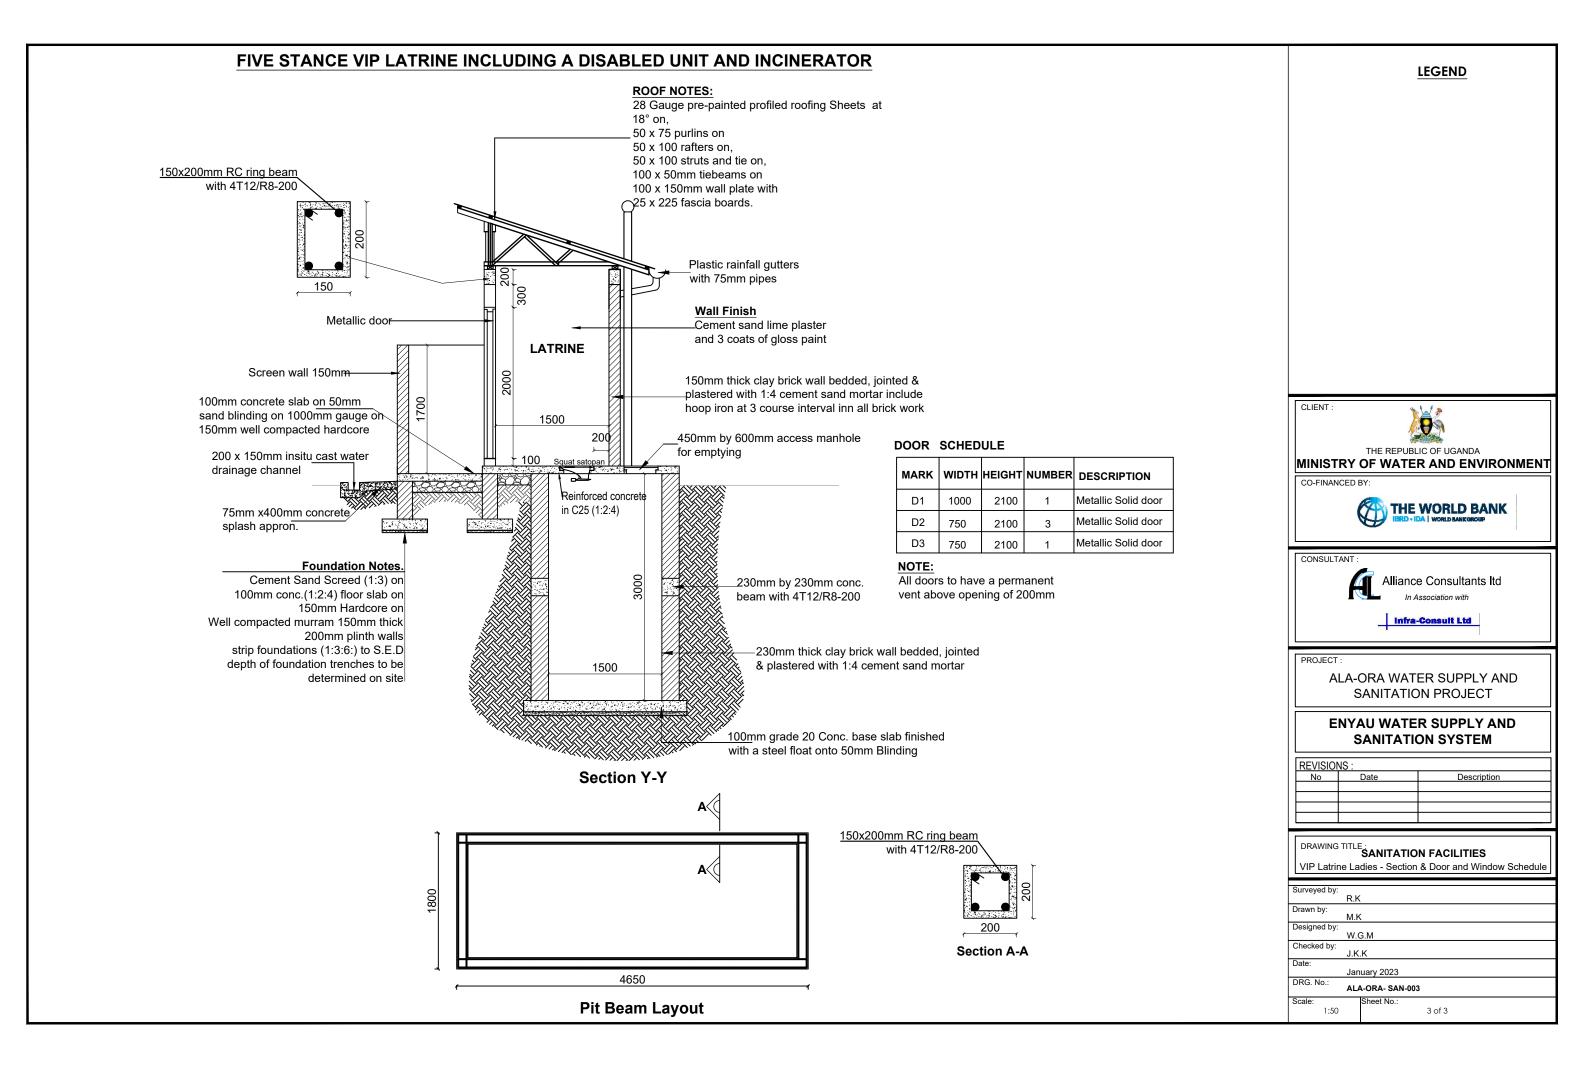
ALA-ORA WATER SUPPLY AND SANITATION PROJECT

ENYAU WATER SUPPLY AND SANITATION SYSTEM


REVISIONS:		
No	Date	Description

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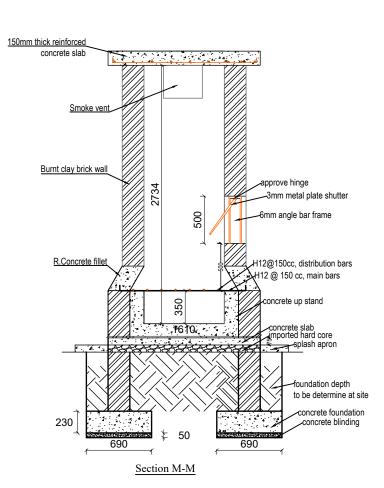
Designed by: January 2023 ALA-ORA- SAN-003





INCINERATOR DETAILS

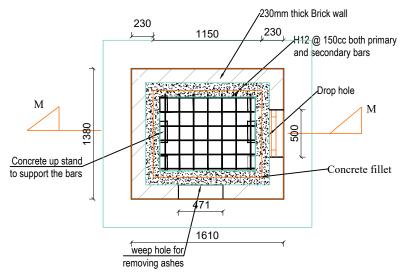


PLAN OF THE INCINERATOR



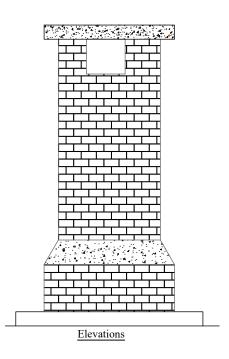

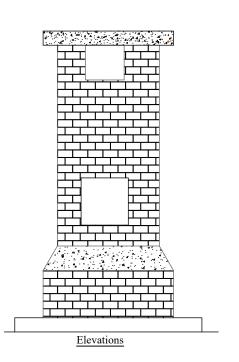

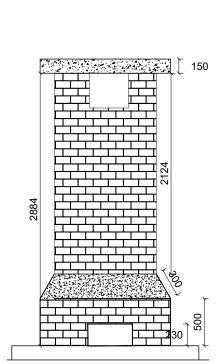

LEGEND

CLIENT :



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MINISTRY OF WATER AND ENVIRONMENT

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CONSULTANT:



Alliance Consultants Itd

Infra-Consult Ltd

PROJECT:

ALA-ORA WATER SUPPLY AND SANITATION PROJECT

ENYAU WATER SUPPLY AND SANITATION SYSTEM

REVISIONS:			
No	Date	Description	

DRAWING TITLE:
SANITATION FACILITIES
Incinerator

Surveyed by:

R.K

Drawn by:

M.K

Designed by:

W.G.M

Checked by:

J.K.K

Date:

January 2023

DRG. No.:

ALA-ORA- SAN-004


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1 of 1

WATER TANK SUPPORTING STRUCTURE



CLIENT :

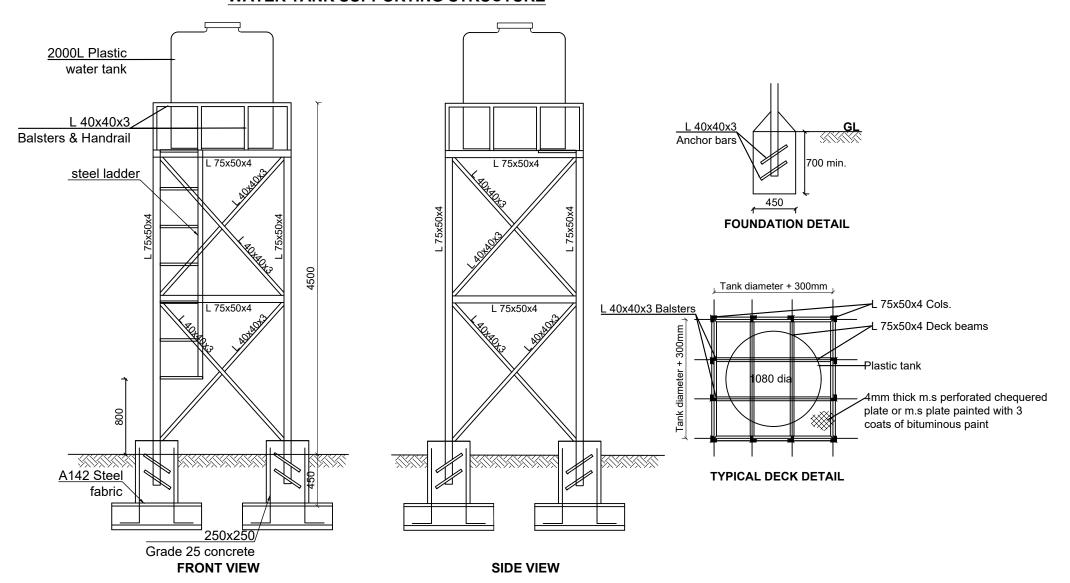

THE REPUBLIC OF UGANDA
MINISTRY OF WATER AND ENVIRONMENT

CO-FINANCED BY:



CONSULTANT :



Alliance Consultants Itd

Infra-Consult Ltd

PROJECT :

ALA-ORA WATER SUPPLY AND SANITATION PROJECT

ENYAU WATER SUPPLY AND SANITATION SYSTEM

REVISIO	REVISIONS:		
No	Date	Description	

DRAWING TITLE:
SANITATION FACILITIES
Public Toilets - Elevated Tank Details

Surveyed by:
R.K

Drawn by:
M.K


Designed by:
W.G.M

Checked by:
J.K.K


Date:
January 2023

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ALA-ORA- SAN-005

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Sheet No.:

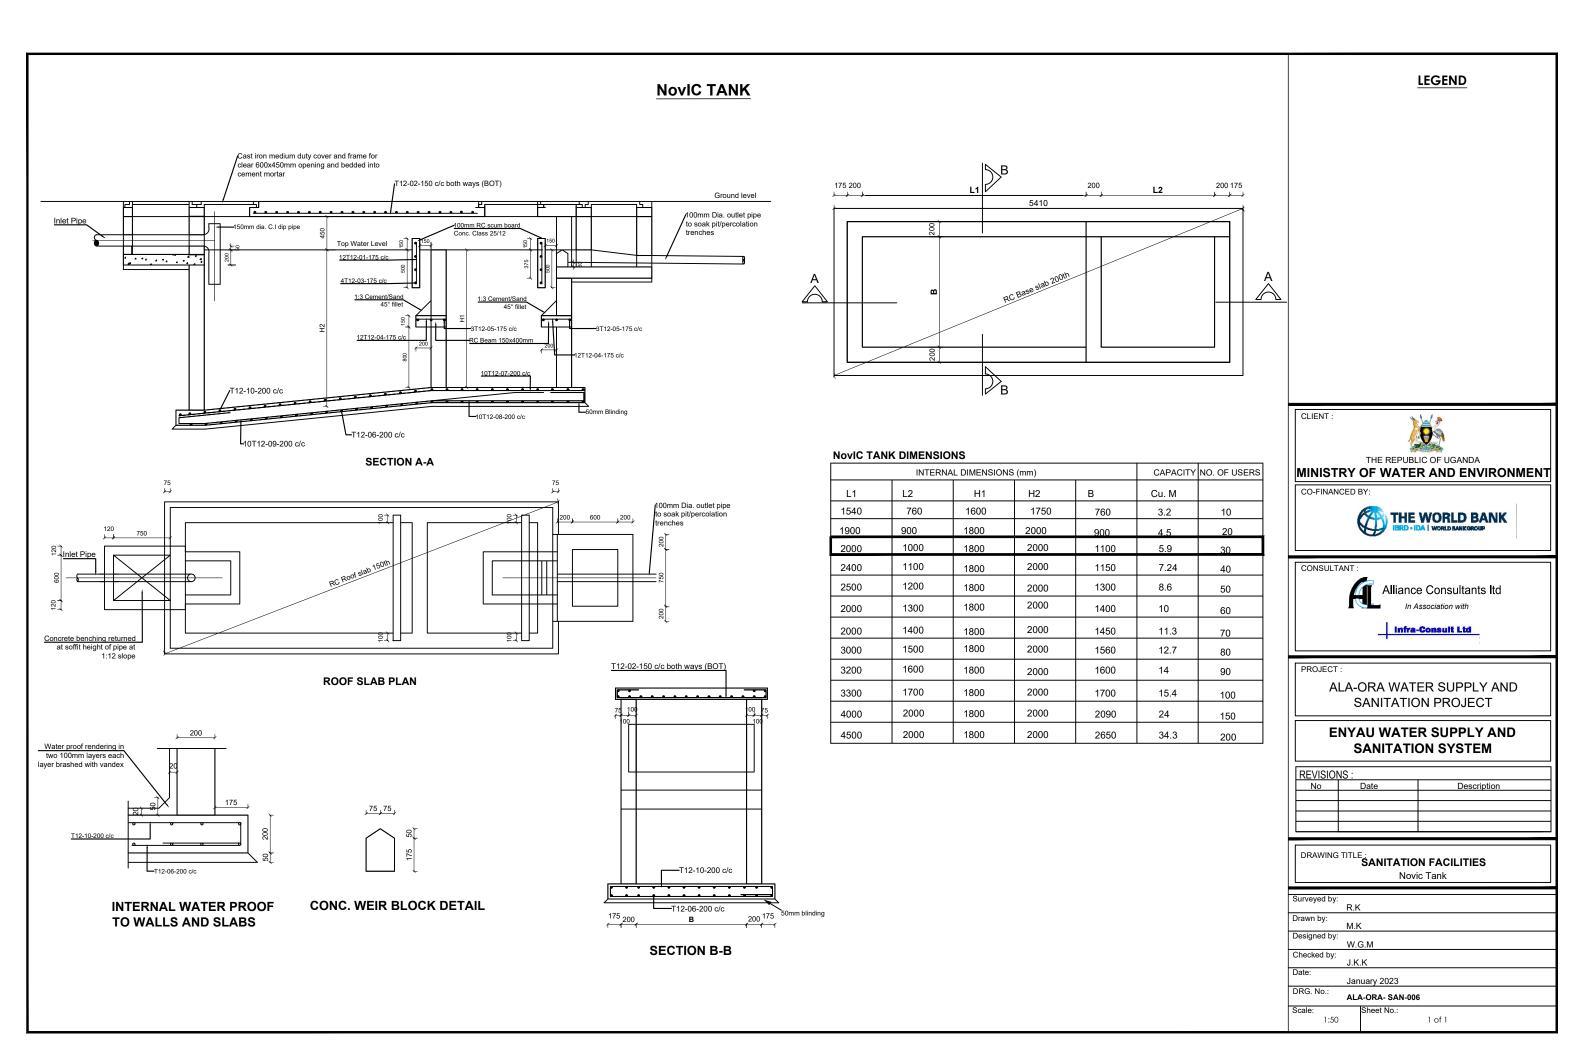

SOAK AWAY PIT AND MANHOLE DETAILS

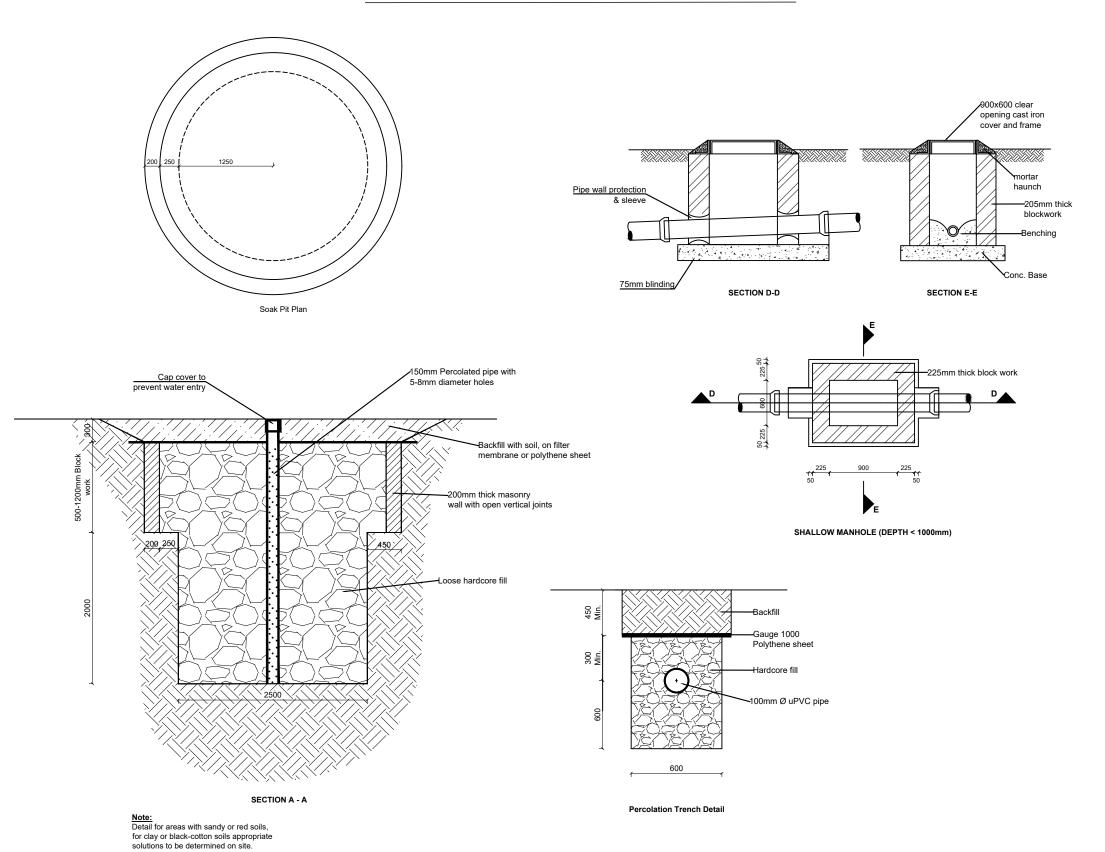

LEGEND

CLIENT :



MINISTRY OF WATER AND ENVIRONMENT

CO-FINANCED BY:



CONSULTANT :



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PROJEC

ALA-ORA WATER SUPPLY AND SANITATION PROJECT

ENYAU WATER SUPPLY AND SANITATION SYSTEM

REVISIONS:		
No	Date	Description

DRAWING TITLE: SANITATION FACILITIES Manhole and Soak away Pit

Surveyed by:
R.K

Drawn by:
M.K

Designed by:
W.G.M

Checked by:
J.K.K

Date:
January 2023

DRG. No.:
ALA-ORA- SAN-007

Scale:
1:50

Sheet No.:
1 of 1